



BISKUP CONSTRUCTION, INC.
16 DANIELLE DRIVE
WINDHAM, MAINE 04062
TEL. (201) 892-9800
FAX. (201) 892-9895

WWW.BISKUPCONSTRUCTION.COM

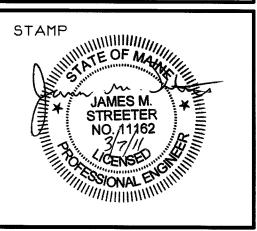

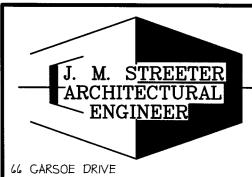

66 GARSOE DRIVE PORTLAND, MAINE 04103 (207) 797-3093

PROPOSED ADDITION
HALE TRAILER # BRAKE
PORTLAND, MAINE

Ш	
F	REVISIONS
DATE	DESCRIPTION

DATE: 3/4/20||

SCALE: 3/16" = 1'-0"

DESIGNER: JB

CHECKED BY: JB

© COPYRIGHT
BISKUP CONSTRUCTION, INC


SHEET TITLE

FLOOR PLAN


SHEET NUMBER

A-I

SHEET I OF 3

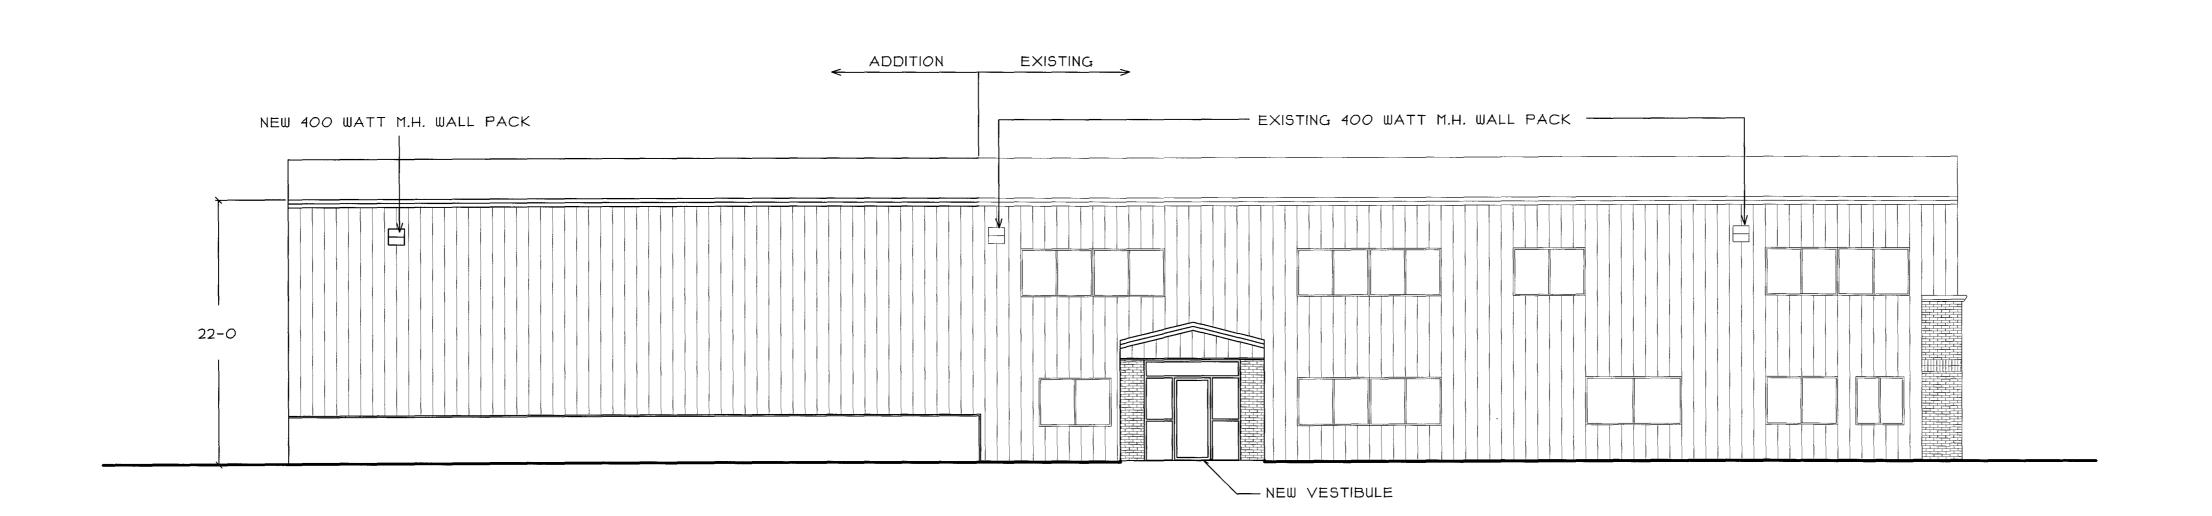


LEFT ELEVATION

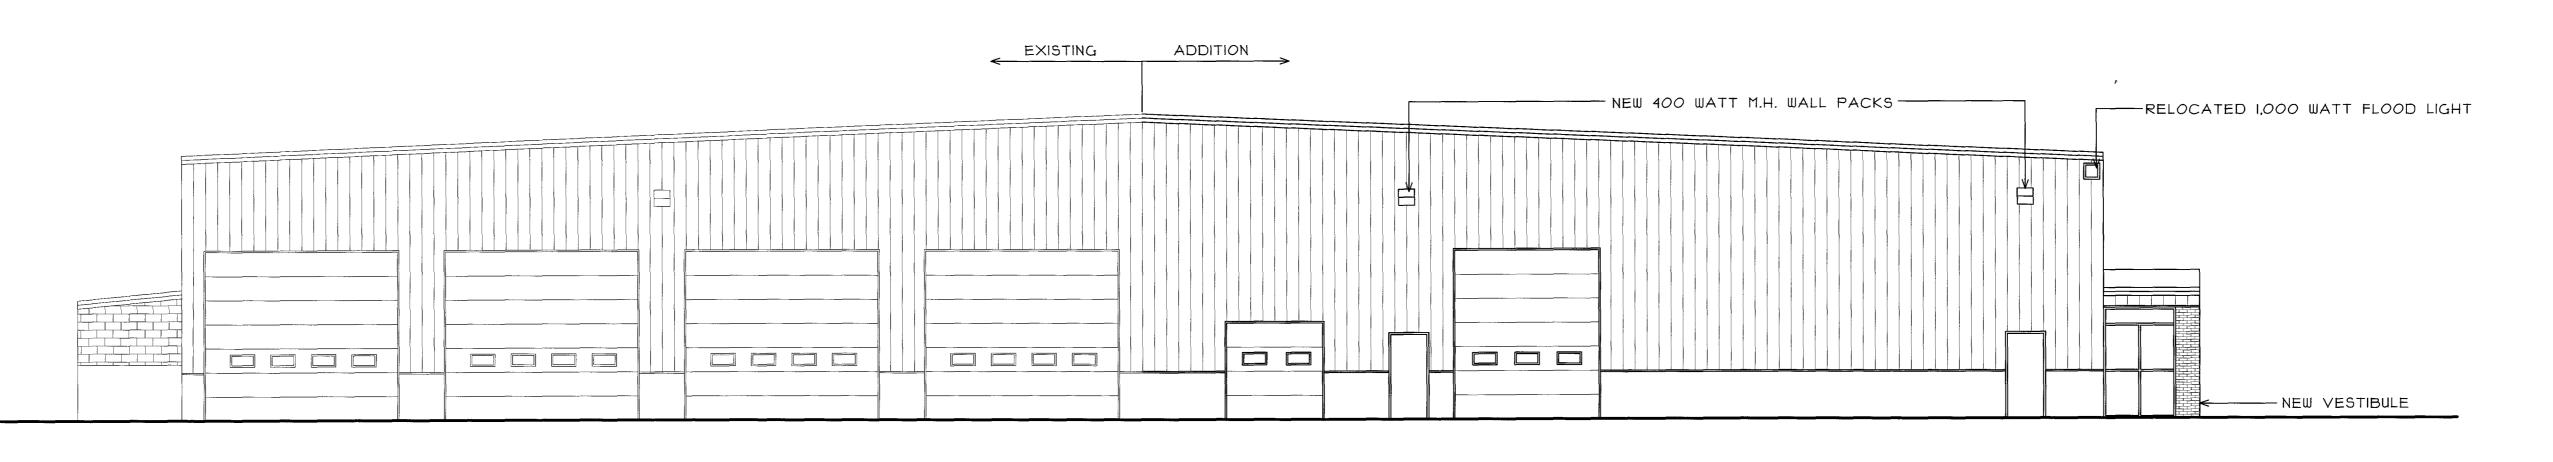


REAR ELEVATION



WWW.BISKUPCONSTRUCTION.COM

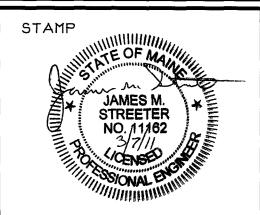

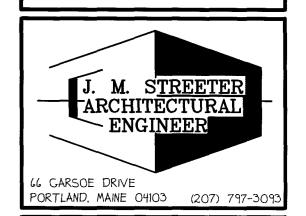

PROPOSED ADDITION HALE TRAILER & BRAKE PORTLAND, MAINE

R	EVISIONS
DATE	DESCRIPTION

DATE: 3/4/20||

SCALE: 3/16" = 1'-0"

DESIGNER: JB

CHECKED BY: JB

© COPYRIGHT
BISKUP CONSTRUCTION, INC.

SHEET TITLE

ELEVATIONS

SHEET NUMBER

A-2


SHEET 2 OF 3

IBC 2009: CODE DATA	
OCCUPANT LOAD - TABLE 1004.I.I	ITO
USE GROUP CLASSIFICATION - SECTION 304.1, 306.2, 311.2	B, F-I, S
TYPE OF CONSTRUCTION - TABLE 503	V B
ACTUAL BUILDING AREA	25,343 S.F.
BUILDING AREA LIMITATION - TABLE 503	8,500 S.F.
STREET FRONTAGE INCREASE - 506.2	NA
AUTOMATIC SPRINKLER SYS. INCREASE - 504.3	11,000 S.F
ALLOWABLE BUILDING AREA	25,500 S.F.
BUILDING HEIGHT	25'-4"
FIRE SUPPRESSION:	WET SYSTEM
FIRE WALLS & PARTY WALLS	NA
STAIR ENCLOSURES	NA
SHAFTS	NA
EXIT ACCESS CORRIDORS	NA
INTERIOR LOAD BEARING WALLS	NA
STRUCTURAL MEMBER SUPPORTING WALLS	NA
FLOOR CONSTRUCTION	NA
ROOF CONSTRUCTION	NA NA
INCIDENTAL SPACES	NA
ACCESSORY USE	NA
FIRE EXTINGUISHERS	SEE FLOOR PLAN
GENERAL NOTES:	
BUILDING HAS NONSEPARATED OCCUPANCIES, PER SECTION 50	8.3

NFPA IOI: CODE DATA - 2009 EDITIO	N
OCCUPANT LOAD - TABLE 1.3.1.2 USE GROUP CLASSIFICATION TYPE OF CONSTRUCTION ACTUAL BUILDING AREA BUILDING HEIGHT	148 BUS., IND. STORAGE V (000) 25,343 S.F. 25'-4"
FIRE SUPPRESSION: FIRE WALLS & PARTY WALLS STAIR ENCLOSURES SHAFTS	WET SYSTEM NA NA NA
EXIT ACCESS CORRIDORS INTERIOR LOAD BEARING WALLS STRUCTURAL MEMBER SUPPORTING WALLS FLOOR CONSTRUCTION	NA NA NA NA
ROOF CONSTRUCTION INCIDENTAL SPACES ACCESSORY USE FIRE EXTINGUISHERS	NA NA OFFICE (25% (6.1.14.3-3 SEE FLOOR PLAN
GENERAL NOTES: BUILDING HAS MIXED OCCUPANCIES, PER SECTION 6.1.14.3	

	REQUIRED	ACTUAL
CLAD ON CDADE (INUEATED) TO ON DELOUI EE	<u> </u>	D 10
SLAB ON GRADE (UNHEATED) TO 24" BELOW F.F.	R-10	R-IO
SLAB ON GRADE (HEATED) TO 24" BELOW F.F.	R-15 R-15 CI	NA NA
WALLS BELOW GRADE FLOORS (FRAMED STEEL OR WOOD)	R-30	NA NA
FLOORS (MASS)	R-12.5 CI	NA NA
WALLS ABOVE GRADE (MASS).	U-0.080	U-0.062
WALLS ABOVE GRADE (METAL BUILDING).	U-0.069	U-0.044
WALLS ABOVE GRADE (STEEL FRAMED).	U-0.064	NA NA
WALLS ABOVE GRADE (WOOD FRAMED).	U-0.051	NA
ROOF (INS. ENTIRELY ABOVE DECK)	U-0.048	NA
ROOF (METAL BUILDING)	U-0.049	U-0.049
ROOF (ATTIC & OTHER)	U-0.021	NA
DOORS (SWINGING)	U-0.70	u-0.50 1
DOORS (ROLL-UP)	U-0.50	U-0.06
WINDOWS (OTHER THAN METAL)	U-0.35	NA
WINDOWS (METAL FRAMED)	U-0.55	NA
STOREFRONT/CURTAIN WALL	U− <i>O.</i> 45	U-0.43
SHGC: PF (0.25	0.40	0.38

I ATJ ASHRAE STANDARD 90.1-2001

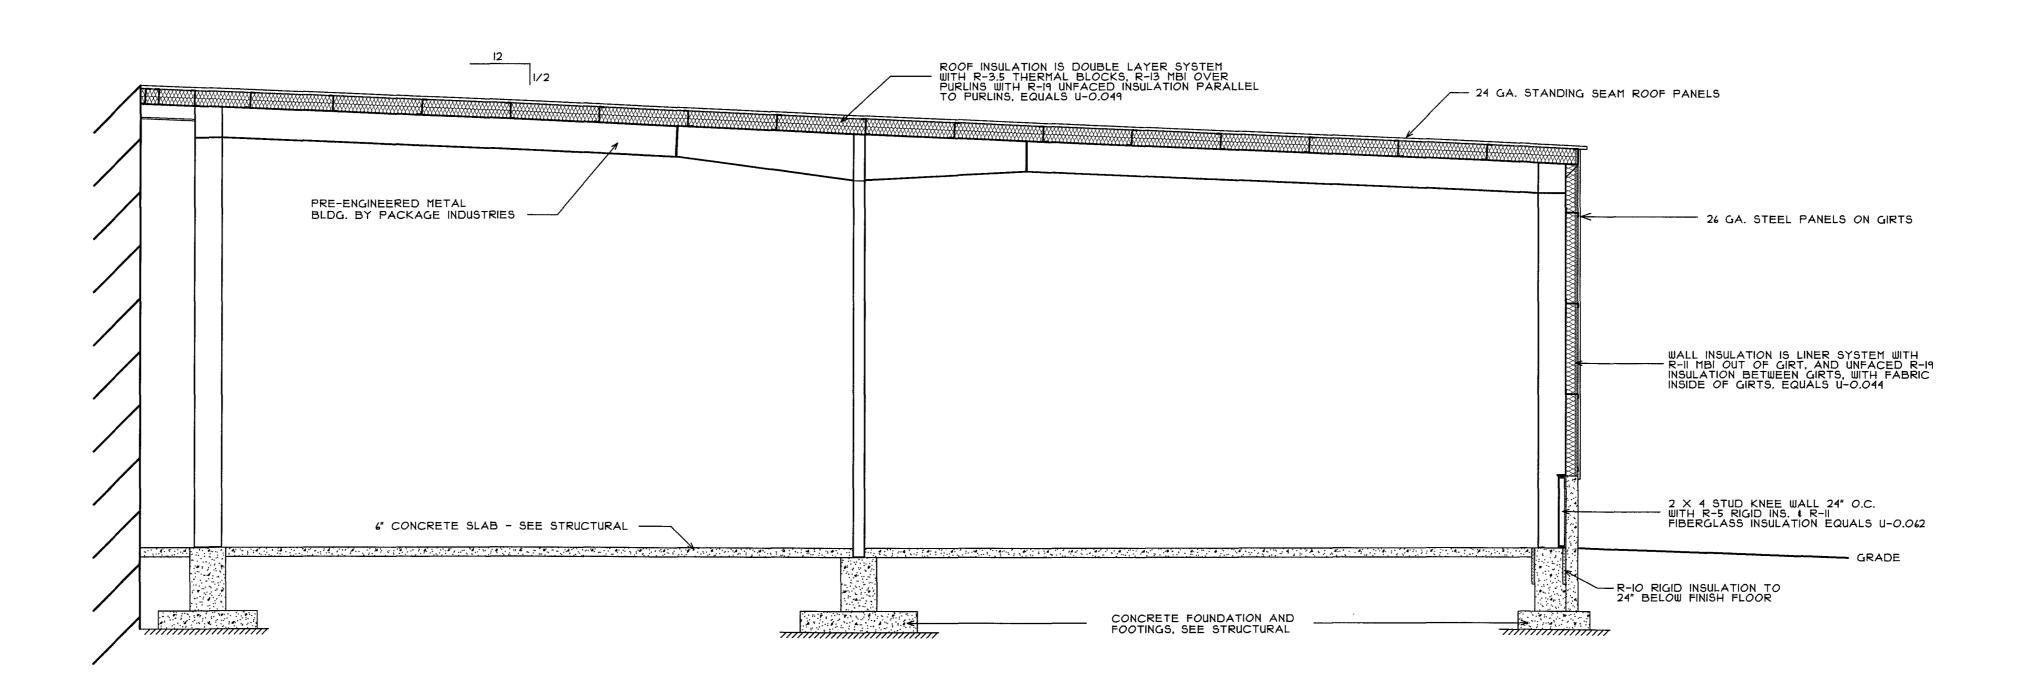

BUILDING SECTION SCALE: 3/16" = 1'-0"

DOOR SCHEDULE


TAG	DOOR SLAB	SIZE	THICKNESS	SWING	FIRE LABEL	FRAME	WALL THICKNESS	REMARKS	
1	ALUM.	3010	1 3/4	RH		ALUM.	4 7/8	FULL GLASS	HRDWR SET #I
2	ALUM.	3010	1 3/4	RH		ALUM.	4 1/8	FULL GLASS	HRDWR SET #I
3	НМ	3010	1 3/4	LH		HM	4 1/8		HRDWR SET #I
4	НМ	3010	1 3/4	RH		НМ	4 1/8		HRDWR SET #I
			The state of the s		HARI	DWARE	SCHEDUL	.E	
			SET #I	HING	GES, CL	OSER, L	OCKSET	, WEATHERSTRIP, THRES	HOLD


BISKUP CONSTRUCTION, INC.
16 DANIELLE DRIVE
WINDHAM, MAINE 04062

WWW.BISKUPCONSTRUCTION.COM

TEL. (201) 892-9800

FAX. (201) 892-9895

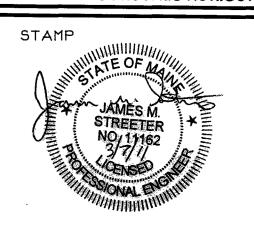

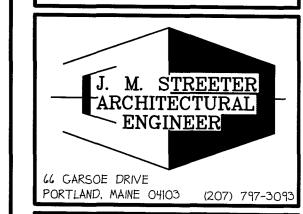

PROPOSED ADDITION HALE TRAILER & BRAKE PORTLAND, MAINE

REVISIONS

DATE DESCRIPTION

DATE: 3/4/20||

SCALE: 3/16" = |'-0"

DESIGNER: JB

CHECKED BY: JB

SHEET TITLE

SECTIONS DETAILS

BISKUP CONSTRUCTION, INC.

SHEET NUMBER

A-3

SHEET 3 OF 3