

PENDENT HEAD DETAIL

## SYSTEM RISER DETAIL LEGEND (9) 4" VANE FLOW SWITCH

\*ALL ELECTRICAL / SIGNALING

WORK IS TO BE DONE BY OTHERS.\*

(1) 8" x 4" FLANGED REDUCER (2) WATER PRESSURE GAUGE (SUPPLY) (3) 4" GATE VALVE W/ TAMPER SWITCH (4) 4" WILKINS 350 BACKFLOW PREVENTER (5) 4" CHECK VALVE (F.D.C.) (6) 4" BUTTERFLY VALVE (NORMALLY CLOSED) (14) I 20V EXTERIOR ELECTRIC BELL (7) BALL DRIP VALVE

(10) WATER PRESSURE GAUGE (SYSTEM) (11) 2" TEST N DRAIN W/ RELIEF VALVE (12) 4" FEED TO SYSTEM 13) 2" MAIN DRAIN DISCHARGE (15) SPARE SPRINKLER HEAD BOX

NOTE: F.D.C. CHECK VALVE BYPASS PROVIDES METHOD FOR TESTING

BACKFLOW PREVENTER AT SYSTEM DEMAND

SYSTEM RISER DETAIL

SCALE: N.T.S.

TOTAL HEADS ON SHEET: 197 SCALE:

SCALE 1/8"=1'-0"


CHECKED BY: E. POULIN (RMS# 515) NICET LEVEL IV CERT. # 108534 LOCATION:

PARK DRIVE PORTLAND, ME DRAWING TITLE:

OXFORD OFFICES (FIRST FLOOR PLAN)

DRAWING NO.:

FP-1.1

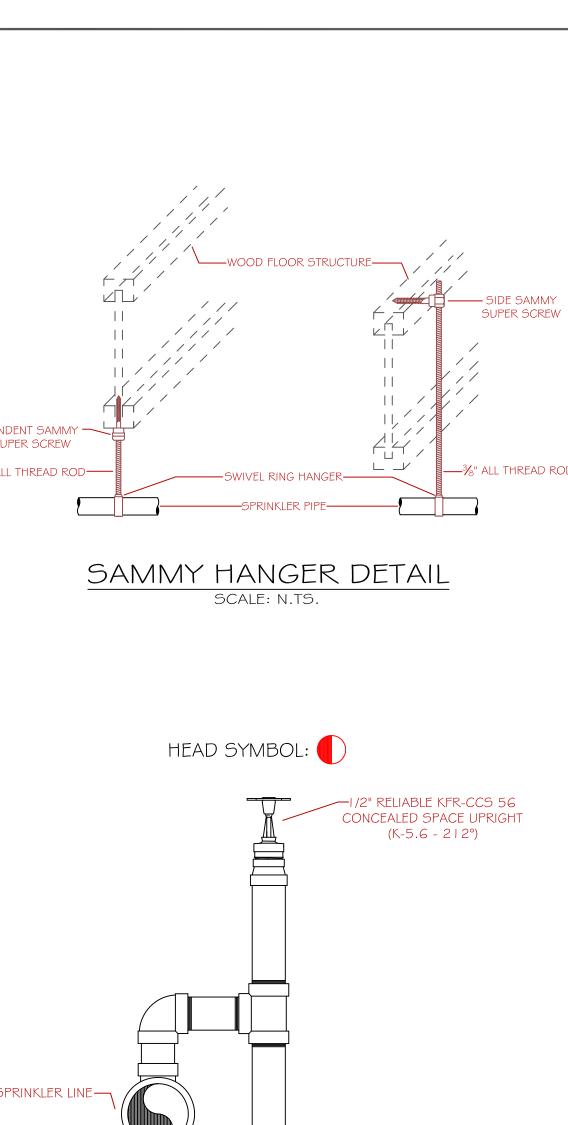

SCALE: N.T.S.

1/2" CONCEALED SPACE BRASS UPRIGHT (ABOVE) 1/2" SEMI RECESSÈD WHITE PENDENT (BELOW) (196 SQ. FT. SPACING - LIGHT) (130 SQ. FT. SPACING - ORD.) **RELIABLE\*** MODEL F1FR 56

> 1/2" BRASS UPRIGHT (196 SQ. FT. SPACING - LIGHT) (130 SQ. FT. SPACING - ORD.) RELIABLE\*

HIGH TECH

FIRE PROTECTION

MAINE LICENSE # 102

SCOTT SIMONS

PORTLAND, ME

ZACHAU

CONSTRUCTION

FREEPORT, ME

O RN PIPE RISER UP

**DESIGN NOTES:** 

GROOVED FITTING.

O DN PIPE RISER DOWN

STEEL PIPE (WET)

♠ WET SYSTEM RISER

[XX-X] PIPE ELEVATION A.F.F.

\*ALL PIPING 2 1/2" AND LARGER TO BE

\*ALL PIPING 2" AND SMALLER TO BE

SCHEDULE 10 STEEL W/ GROOVED FITTING.

SCHEDULE 40 STEEL WITH THREADED OR

\*POSITION, LOCATION, SPACING, AND USE OF

SPRINKLERS AND HANGERS SHALL BE IN

\*HYDRAULIC CALCULATION PROCEDURES

HAVE BEEN DONE IN ACCORDANCE WITH NFPA 13 2016 ed. (SEE PLANS FOR LOCATION OF REMOTE AREAS, HYDRAULIC REFERENCE

\*ALL ELECTRICAL WORK TO BE DONE BY

\*DIMENSIONS AND LOCATIONS GIVEN FOR

SPRINKLER HEADS AND PIPE MAY VARY TO ACCOMODATE ACTUAL FIELD CONDITIONS.

\*OWNER TO PROVIDE SUFFICIENT HEAT TO PREVENT FREEZING IN WATER FILLED SPRINKLER PIPE AND EQUIPMENT.

\*OTHER TRADES TO COORDINATE THEIR WORK WITH SPRINKLER CONTRACTOR. \*ALL NEWLY INSTALLED SPRINKLER HEADS ARE TO BE QUICK RESPONSE U.N.O.

\*OWNER IS RESPONSIBLE FOR MAINTAINING THE SPRINKLER SYSTEM/S IN ACCORDANCE WITH THE CURRENT EDITION OF NFPA 25, "INSPECTIONS TESTING AND MAINTENANCE OF WATER BASED FIRE PROTECTION

SYSTEMS" AND/OR ALL APPLICABLE FEDERAL. STATE, AND LOCAL LAWS, CODES AND

RELIABLE\*

MODEL KFR-CCS 56 - 212° ABOVE MODEL F1FR 56 - 155° BELOW

ORDINANCES.

**HEAD LEGEND:** 

ACCORDANCE WITH NFPA 13 2016 ed.

POINTS, AND SYSTEM DEMANDS)

A HYDRAULIC CALC. POINT

ARCHITECT:

CONTRACTOR:

LEGEND:

P.O. BOX 156 MINOT, ME. 04258-0258 TEL:(207) 998-2551 FAX:(207) 998-4187

MODEL F1FR 56 1/2" BRASS HORIZONTAL SIDEWALL (100 SQ. FT. ORD. HAZARD)

> RELIABLE\* MODEL F3QR

" SEMI-RECESSED DRY BARREL WHITE HORIZONTAL SIDEWALL (196 SQ. FT. LIGHT HAZARD)

\* OR APPROVED EQUAL

DATE: OCTOBER 31, 2016

DESIGNER: JEREMY A. FOSS MAINE RMS #808 NICET LEVEL III CERT. #126801

97 TECHNOLOGY

**PATRONS** FIRE PROTECTION PLAN (NFPA 13 2016 ed.)