


COPYRIGHT 2016 © B3 ELECTRICAL ENGINEERING LLC. ALL RIGHTS RESERVED. NO REPRODUCTION WITHOUT PRIOR WRITTEN PERMISSION

Jun 01, 2016 - 9:57am  
 C:\Users\pbadger\Documents\B3 Electrical\Dirigo AE\ecomaine\CAD\ProjectSheets\Drawing Set\Electrical\E3.2.dwg

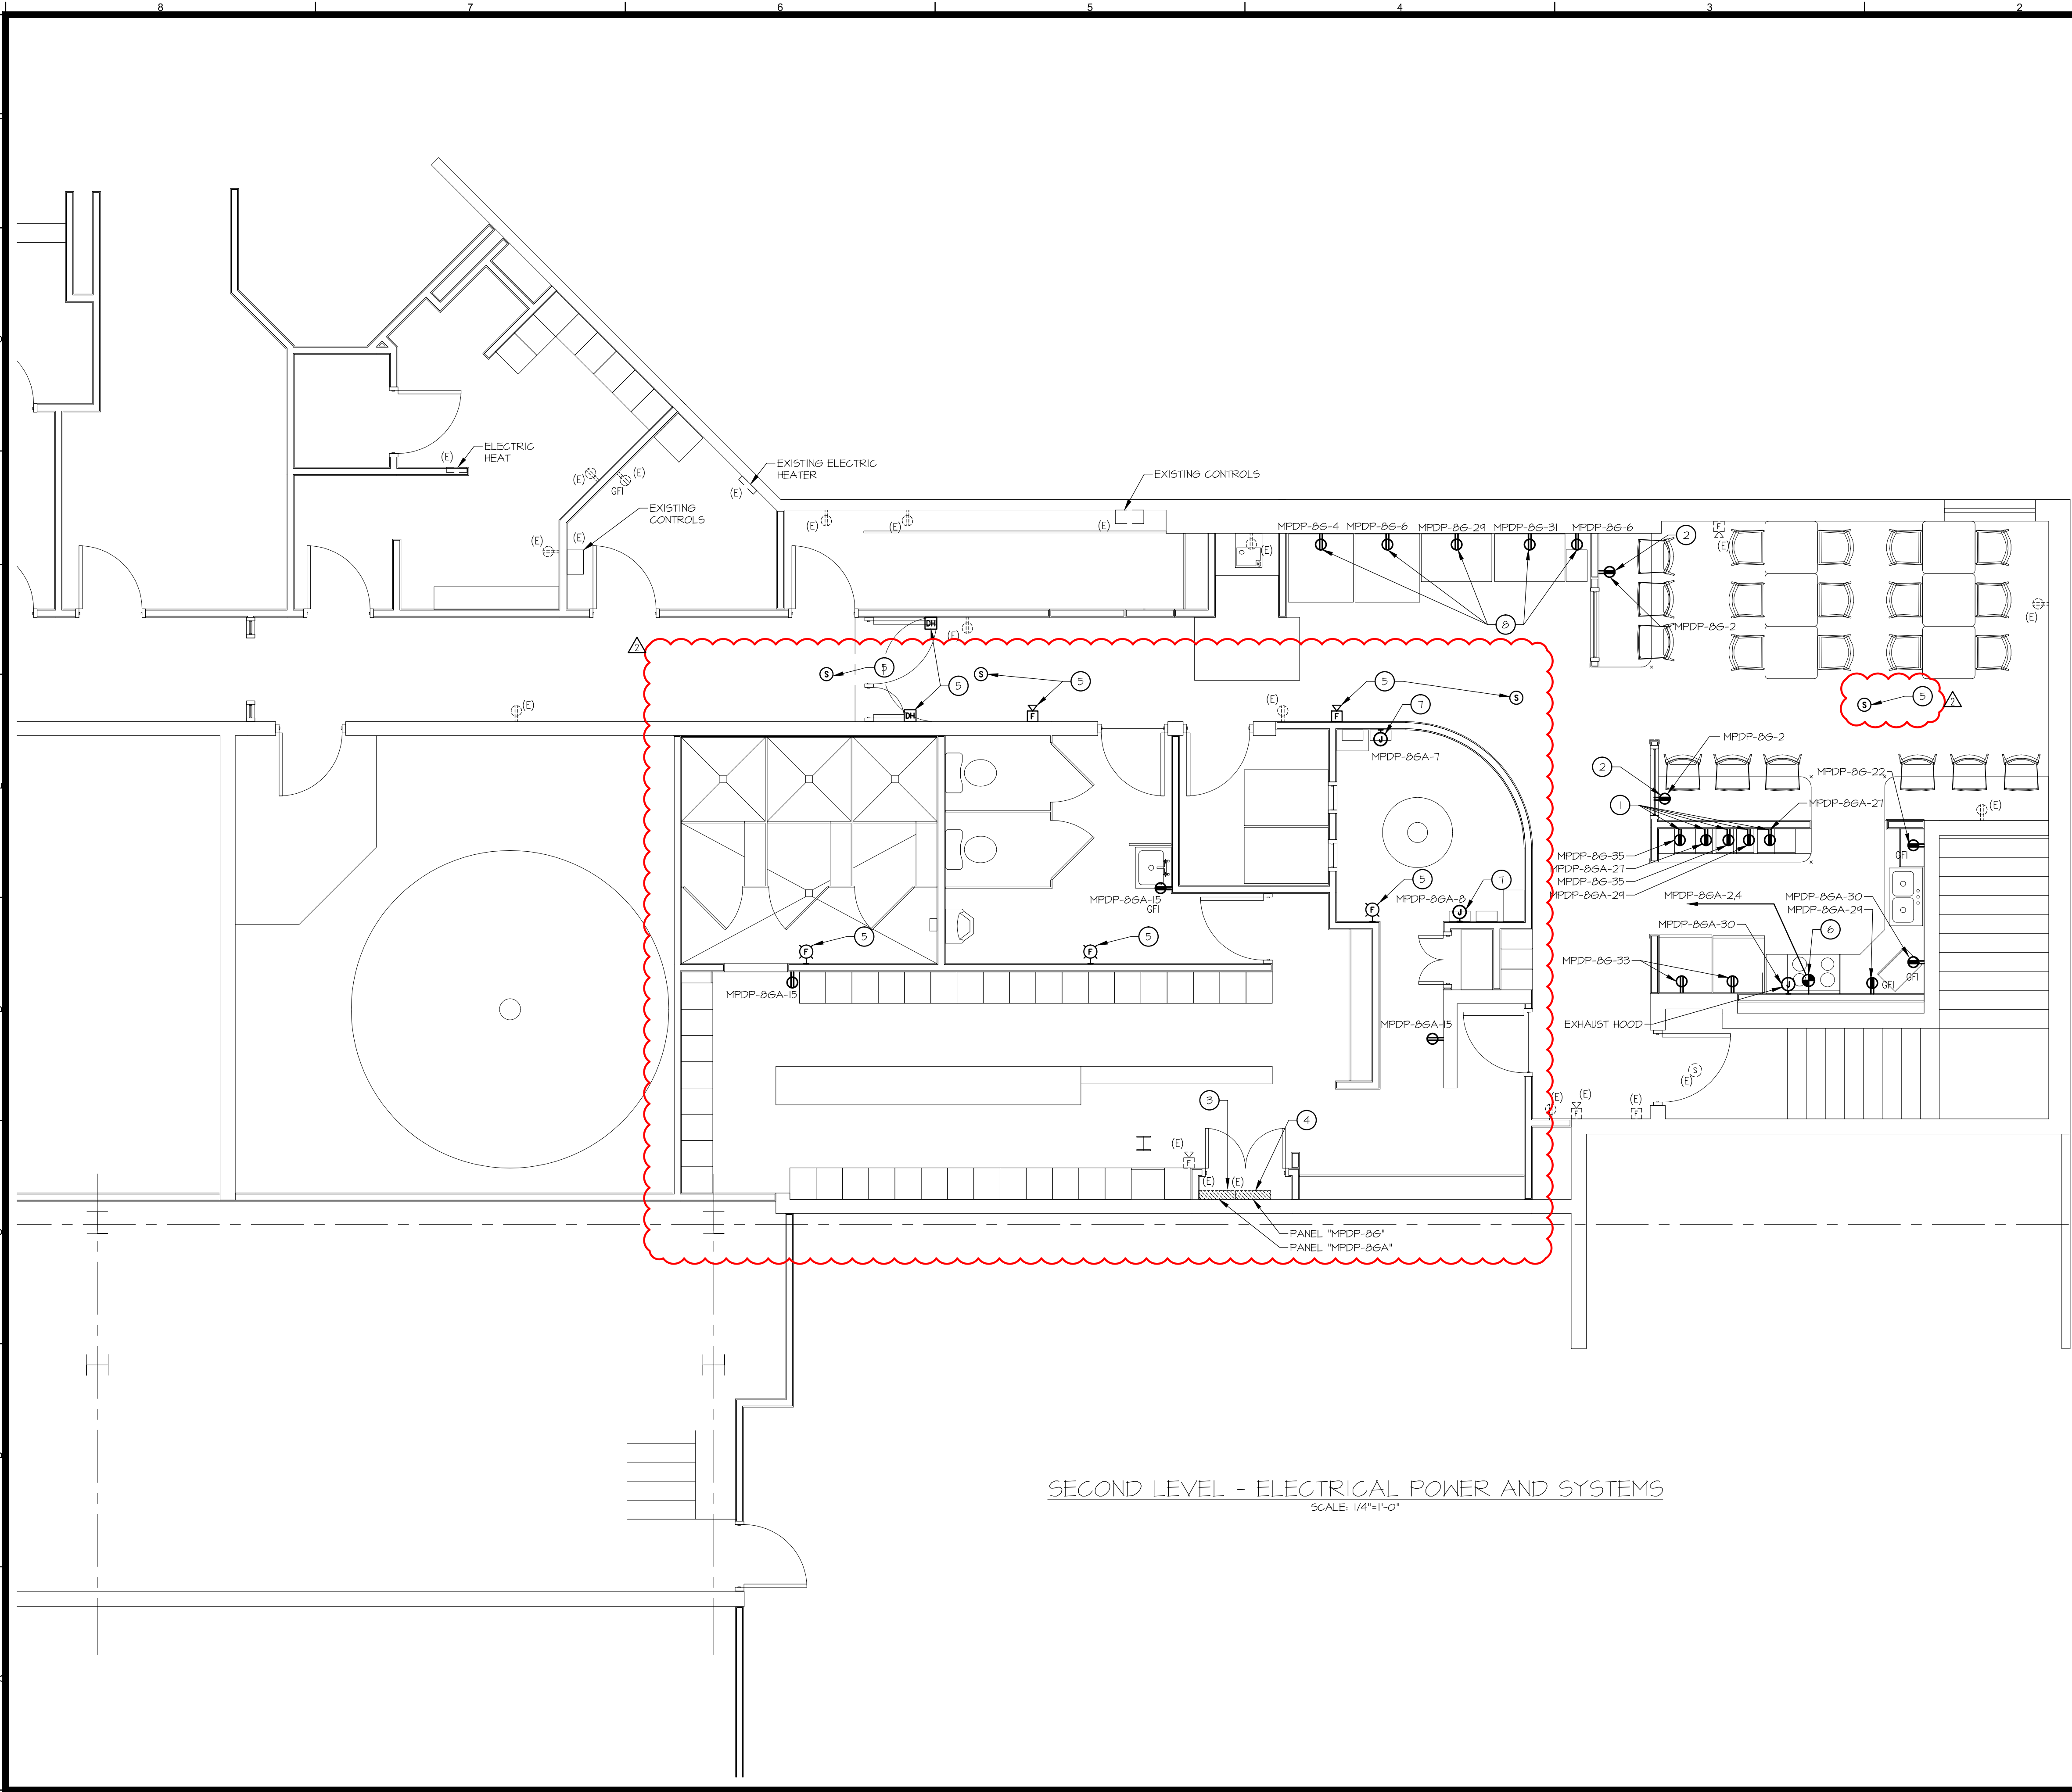


SECOND LEVEL - ELECTRICAL POWER AND SYSTEMS  
 SCALE: 1/4"=1'-0"

- DRAWING E3.2  
 NUMBERED NOTES**
- 1 PROVIDE RECEPTACLE FOR COUNTERTOP MICROWAVE, COORDINATE THE MOUNTING HEIGHT WITH THE ARCHITECTURAL ELEVATIONS.
  - 2 CONNECT TO THE EXISTING LOUNGE RECEPTACLE CIRCUIT.
  - 3 PROVIDE A NEW 3/4" LB COVER ON THE LB BELOW THE PANEL.
  - 4 CONTRACTOR SHALL REMOVE THE 4" SQUARE COVER FROM THE SIEMENS ITE PANELBOARD PANEL COVER AND PROVIDE A NEW SURFACE STYLE PANEL COVER.
  - 5 CONTRACTOR SHALL EXTEND THE EXISTING FIRE ALARM SYSTEM FOR NEW DEVICES.
  - 6 RE-USE THE EXISTING BREAKER IN THE PANEL AND PROVIDE NEW 6/4 MG CABLE TO STOVE RECEPTACLE.
  - 7 PROVIDE POWER FOR ELECTRIC HAND DRYER, COORDINATE THE LOCATION WITH THE ARCHITECTURAL DRAWINGS AND EQUIPMENT CUT SHEETS.
  - 8 REUSE THE EXISTING VENDING MACHINE CIRCUITS AND PROVIDE NEW 12/2 MG CABLE FROM THE PANEL TO THE NEW LOCATIONS OF THE VENDING MACHINES AS REQUIRED.

**B3** B3 Electrical  
 Engineering, Estimating, Construction  
 196 Washington St.  
 Brewer, Maine 04412  
 (863)255-0883

**ecomaine**  
**LOCKER ROOM RENOVATION**  
 PORTLAND  
 MAINE

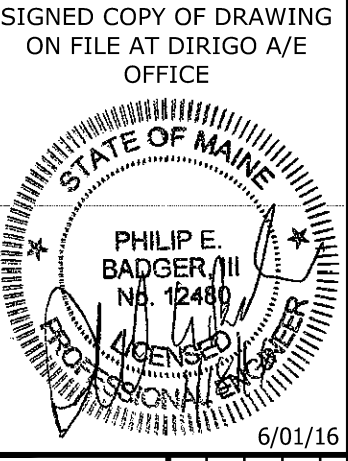

SIGNED COPY OF DRAWING ON FILE AT DIRIGO AVE OFFICE

**SECOND LEVEL POWER & SYSTEMS PLAN**

REV.	DATE	DESCRIPTION
1	01/18/16	ISSUED FOR CONSTRUCTION
2	6/01/16	ISSUED FOR S1 #1

DRAWN BY: PEB  
 CHECKED BY: PEB

PH: (207) 225 - 3040  
 1071 Auburn Road  
 Suite G  
 Turner, ME 04282

**DIRIGO**  
 ARCHITECTURAL  
 ENGINEERING • CONSTRUCTION MANAGEMENT  
 EN: tperkins@dirigoae.com W: www.dirigoae.com

DATE: 6/01/16  
 PROJECT NO. 15-015  
 SHEET NO.  
**E3.2**