
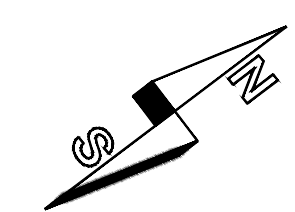


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Feb 03, 2016 - 10:37am  
C:\Users\David\Documents\Projects\DAE 15-015 ecomaine Locker Room\CAD Files\15-015 Arch.dwg

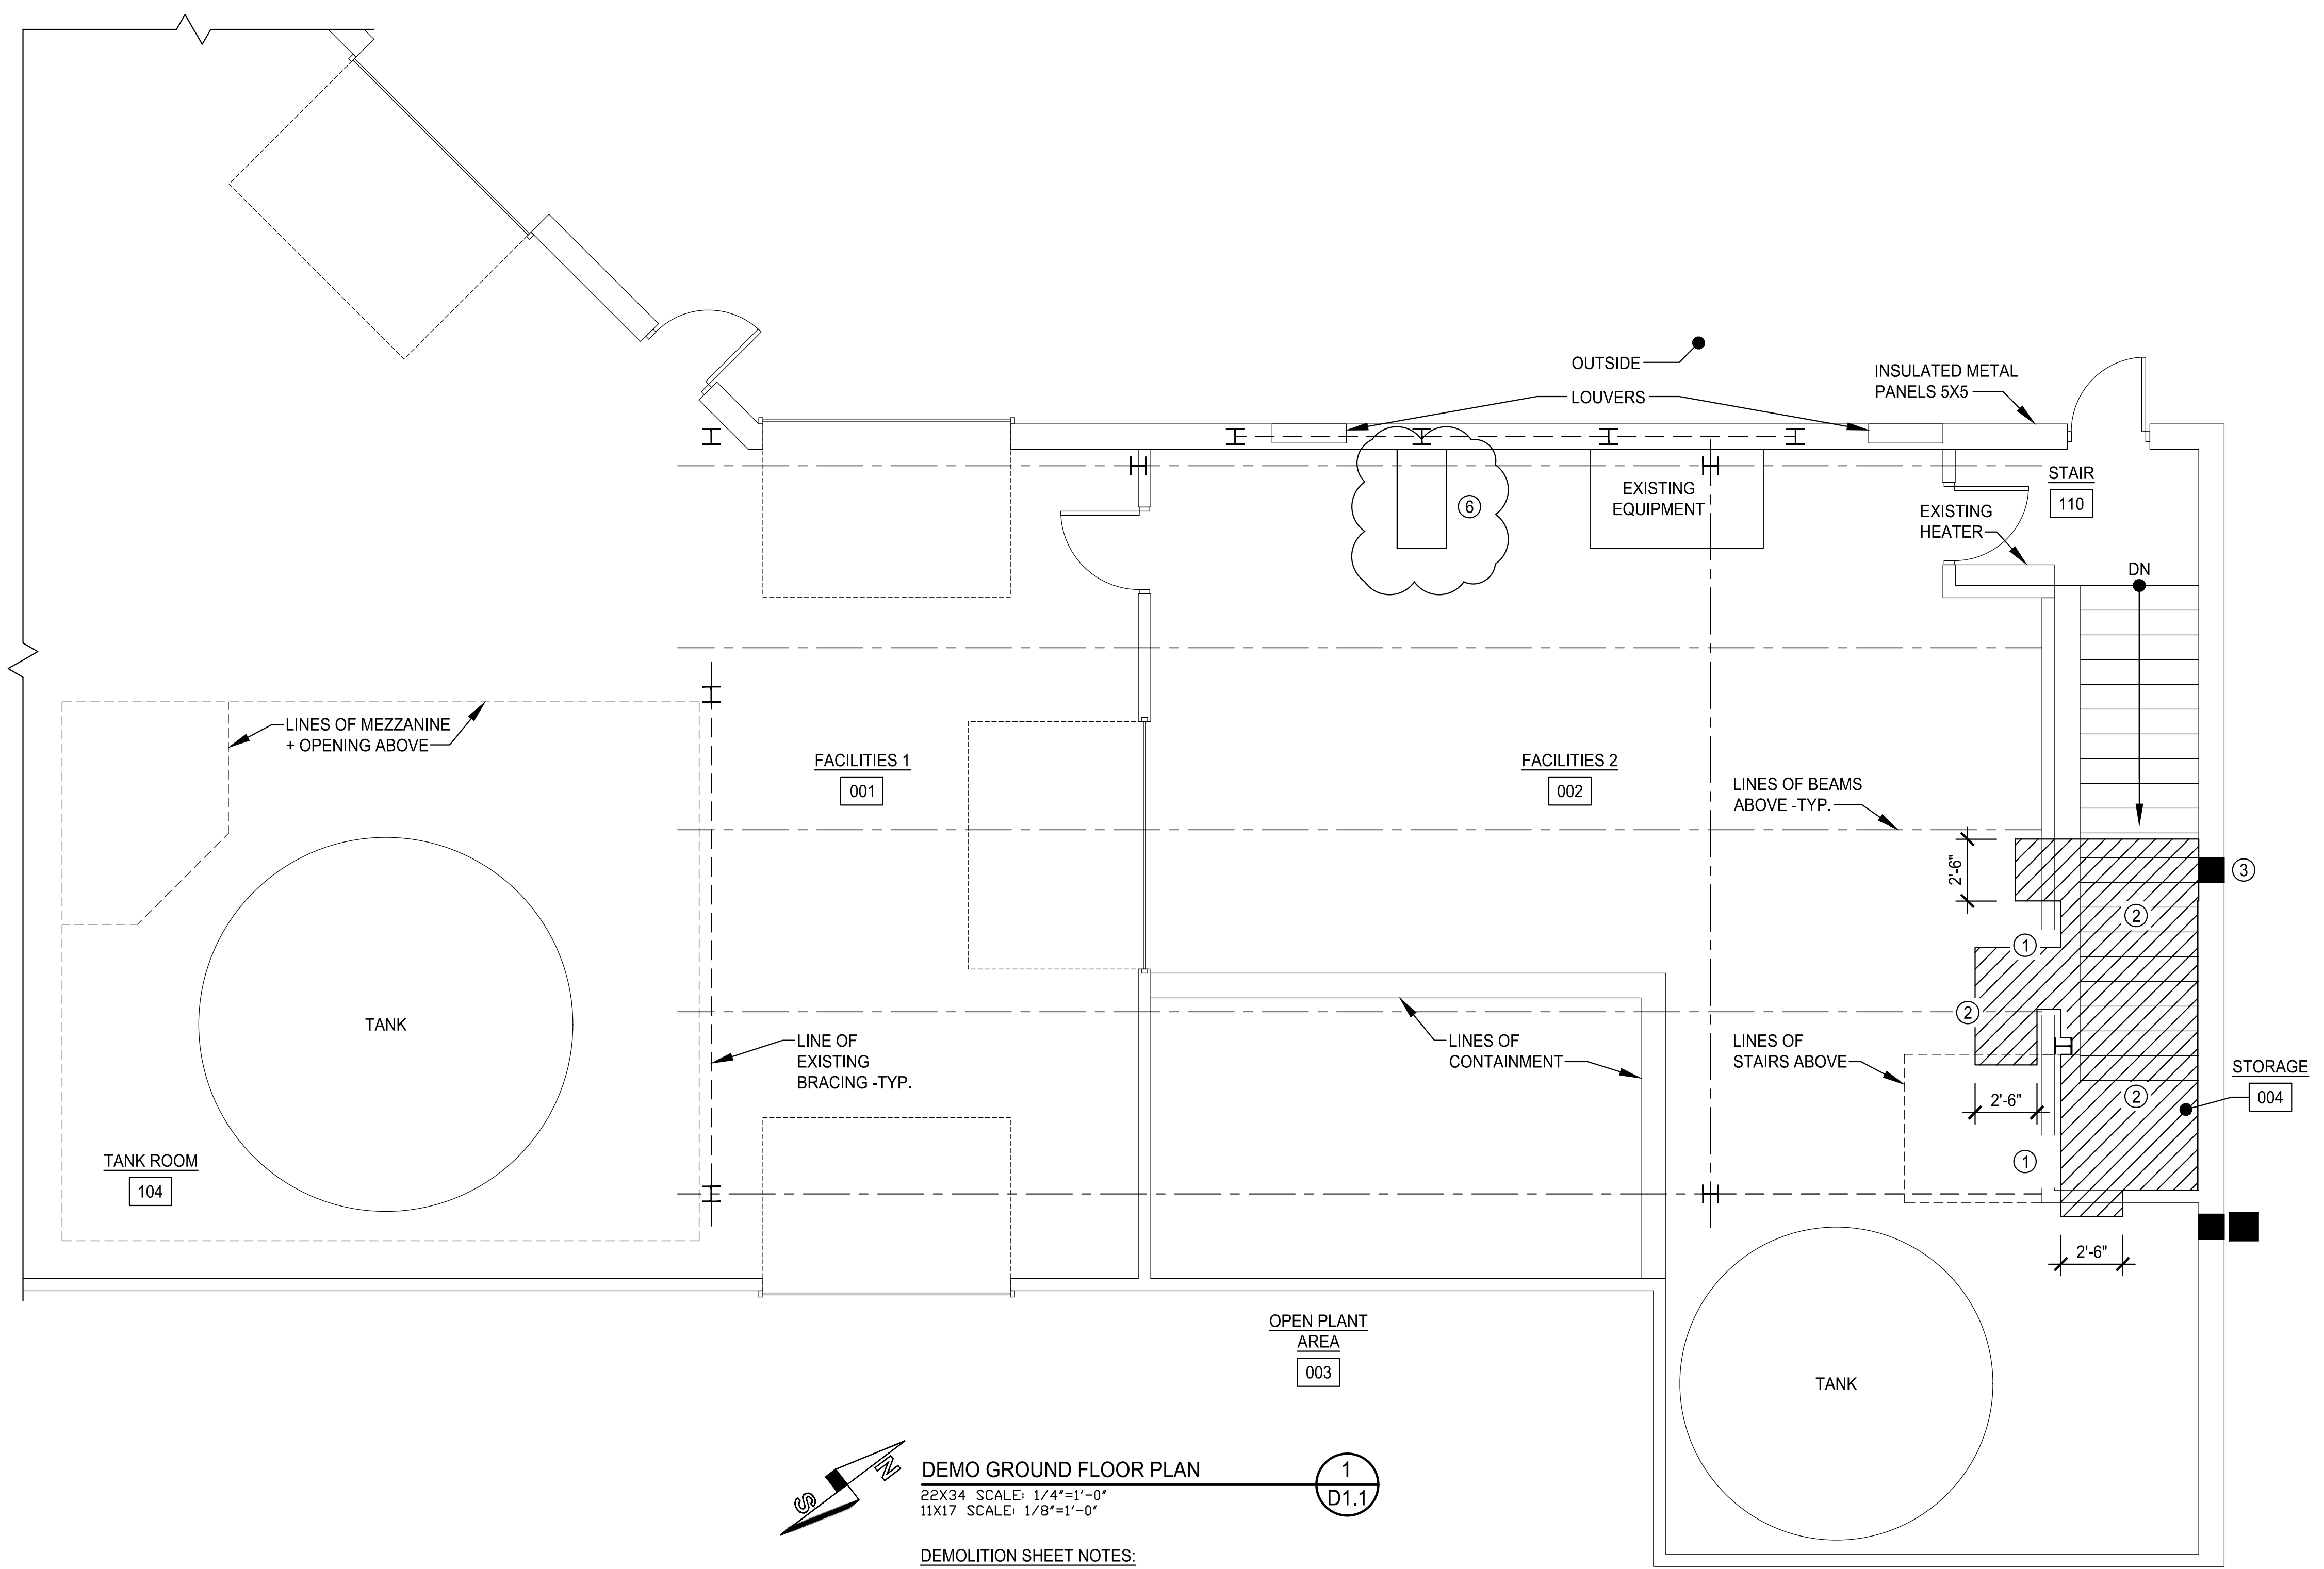


**DEMO GROUND FLOOR PLAN**  
 22X34 SCALE: 1/4"=1'-0"  
 11X17 SCALE: 1/8"=1'-0"  
 1  
 D1.1

- DEMOLITION SHEET NOTES:**
1. REMOVE WALL FOR PROPOSED OPENING - SUPPORT AS REQUIRED
  2. SAWCUT + REMOVE CONCRETE SLAB. COORDINATE WIDTH + LOCATION W/ PLUMBING CONTRACTOR. TRENCH WIDTH IS 2'-6" TYPICAL
  3. CORE-DRILL CONCRETE FOUNDATION WALL FOR PIPE PENETRATIONS
  4. OWNER ADVISES THAT STRUCTURAL TIE BEAMS MAY BE LOCATED BENEATH FLOOR SLAB. CONTRACTOR IS TO NOTIFY ENGINEER IF TIE BEAMS INTERFERE WITH INTENDED PIPE RUN. PENETRATIONS WILL NOT BE MADE THROUGH TIE BEAMS IF ENCOUNTERED. LOCATE ANY UNDERSLAB OBSTRUCTIONS PRIOR TO PENETRATING FOOTING AND CONTRACTOR IS TO COORDINATE FIELD-VERIFIED PIPE ELEVATION WITH MANHOLE FABRICATION
  5. TEST CUT TO DETERMINE SLAB DEPTH PRIOR TO SLAB CUTTING. DO NOT CUT DEEPER THAN THE SLAB DEPTH TO AVOID DAMAGING TIE BEAMS THAT MAY BE CAST INTEGRALLY WITH THE SLAB

6. REMOVE CONCRETE HOUSEKEEPING PAD

SIGNED COPY OF DRAWING  
 ON FILE AT DIRIGO A/E  
 OFFICE

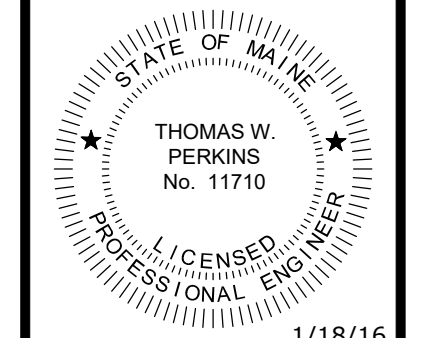

1/18/16

| REV. | DATE    | DESCRIPTION             |
|------|---------|-------------------------|
| 1    | 1/18/16 | ISSUED FOR CONSTRUCTION |
| 2    | 2/3/16  | ADDENDUM 1              |

DRAWN BY: CGB  
 CHECKED BY: TWP

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DATE: 2/3/16  
 PROJECT NO. 15-015  
 SHEET NO.

**D1.1**