


NOTE:

1. SEE SHEET E001 EOR LEGEND AND ABBREVIATIONS.

KEYED NOTE:

- ① NOT USED
- ② FURNISH AND INSTALL PILOT LIGHT SWITCH AND LABELING FOR ROOF LIGHTING AS INDICATED ON ROOF POWER PLAN EP104.
- ③ FURNISH AND INSTALL EXTERIOR FACADE LIGHT FIXTURE TO TOP OF CANOPY. COORDINATE INSTALLATION W/ ARCHITECT AND ROOFING CONTRACTOR.
- ④ EMERGENCY POWER CONTROL MODULE FOR SINGLE LEVEL SWITCHED LIFE SAFETY LIGHTING VIA LIGHTING CONTROL PANEL AS INDICATED. SEE SHEET EL651 DETAIL J8 FOR ADDITIONAL INFORMATION.
- ⑤ EMERGENCY POWER CONTROL MODULE FOR DUAL LEVEL SWITCHED LIFE SAFETY LIGHTING THROUGH A LIGHTING CONTROL PANEL AS INDICATED. SEE SHEET EL651 DETAIL E8 FOR ADDITIONAL INFORMATION.
- ⑥ EMERGENCY POWER CONTROL MODULE FOR INTERIOR SWITCHED STANDBY LIGHTING AS INDICATED. SEE SHEET EL651 DETAIL A8 FOR ADDITIONAL INFORMATION.
- ⑦ DUAL LEVEL SWITCHED EMERGENCY FIXTURE VIA LIGHTING CONTROL PANEL. CONNECT OUTBOARD LAMPS TO SWITCHED LIFE SAFETY CIRCUIT AND CENTER LAMP TO SWITCHED NORMAL CIRCUIT AS INDICATED. SEE SHEET EL651 DETAIL E8 FOR ADDITIONAL INFORMATION.
- ⑧ PROVIDE FIXTURE W/ BODINE #B50ST FLUORESCENT EMERGENCY BATTERY BALLAST FOR INSTANT FULL ON OPERATION OF DIMMED FIXTURE DURING POWER INTERRUPTION.
- ⑨ EMERGENCY POWER CONTROL MODULE FOR DUAL LEVEL SWITCHED LIFE SAFETY LIGHTING VIA LOCAL OCCUPANCY SENSOR AS INDICATED. SEE SHEET EL651 DETAIL E8 FOR ADDITIONAL INFORMATION.
- ⑩ DUAL LEVEL SWITCHED EMERGENCY FIXTURE VIA OCCUPANCY SENSOR. CONNECT OUTBOARD LAMPS TO SWITCHED LIFE SAFETY CIRCUIT AND CENTER LAMP TO SWITCHED NORMAL CIRCUIT AS INDICATED. SEE SHEET EL651 DETAIL E12 FOR ADDITIONAL INFORMATION.
- ⑪ EMERGENCY POWER CONTROL MODULE FOR SINGLE LEVEL SWITCHED LIFE SAFETY LIGHTING VIA OCCUPANCY SENSOR AS INDICATED. SEE SHEET EL651 DETAIL J12 FOR ADDITIONAL INFORMATION.
- ⑫ EMERGENCY POWER CONTROL MODULE FOR SINGLE LEVEL SWITCHED LIFE SAFETY LIGHTING ONLY AREAS VIA OCCUPANCY SENSOR AS INDICATED. SEE SHEET EL651 DETAIL A5 FOR ADDITIONAL INFORMATION.
- ⑬ EMERGENCY POWER CONTROL MODULE FOR SINGLE LEVEL SWITCHED LIFE SAFETY LIGHTING ONLY AREAS VIA LIGHTING CONTROL PANEL AS INDICATED. SEE SHEET EL651 DETAIL A1 FOR ADDITIONAL INFORMATION.

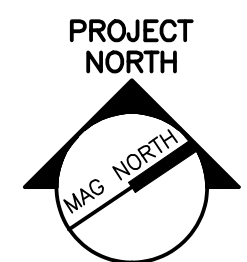

PROJECT TITLE:
**MAINE TURNPIKE AUTHORITY
ADMINISTRATION BUILDING**
PORTLAND, MAINE


CURRENT ISSUE STATUS:
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7-9-07

REV	DESCRIPTION	DATE
0	BIDDING/CONSTRUCTION	7-9-07

GRAPHIC SCALE:
0" = 1"

SCALE: 1/8" = 1'-0"

PROJECT MANAGER: SLB
JC/DRAWN BY: TCM/CDS
A/E OF RECORD: JPP
CAD FILE: EL103-06016
PROJECT NO: 06016
DATE: 7-9-07
SHEET TITLE:
**THIRD FLOOR
LIGHTING PLAN**
SHEET No.
EL103
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A1 FLOOR PLAN

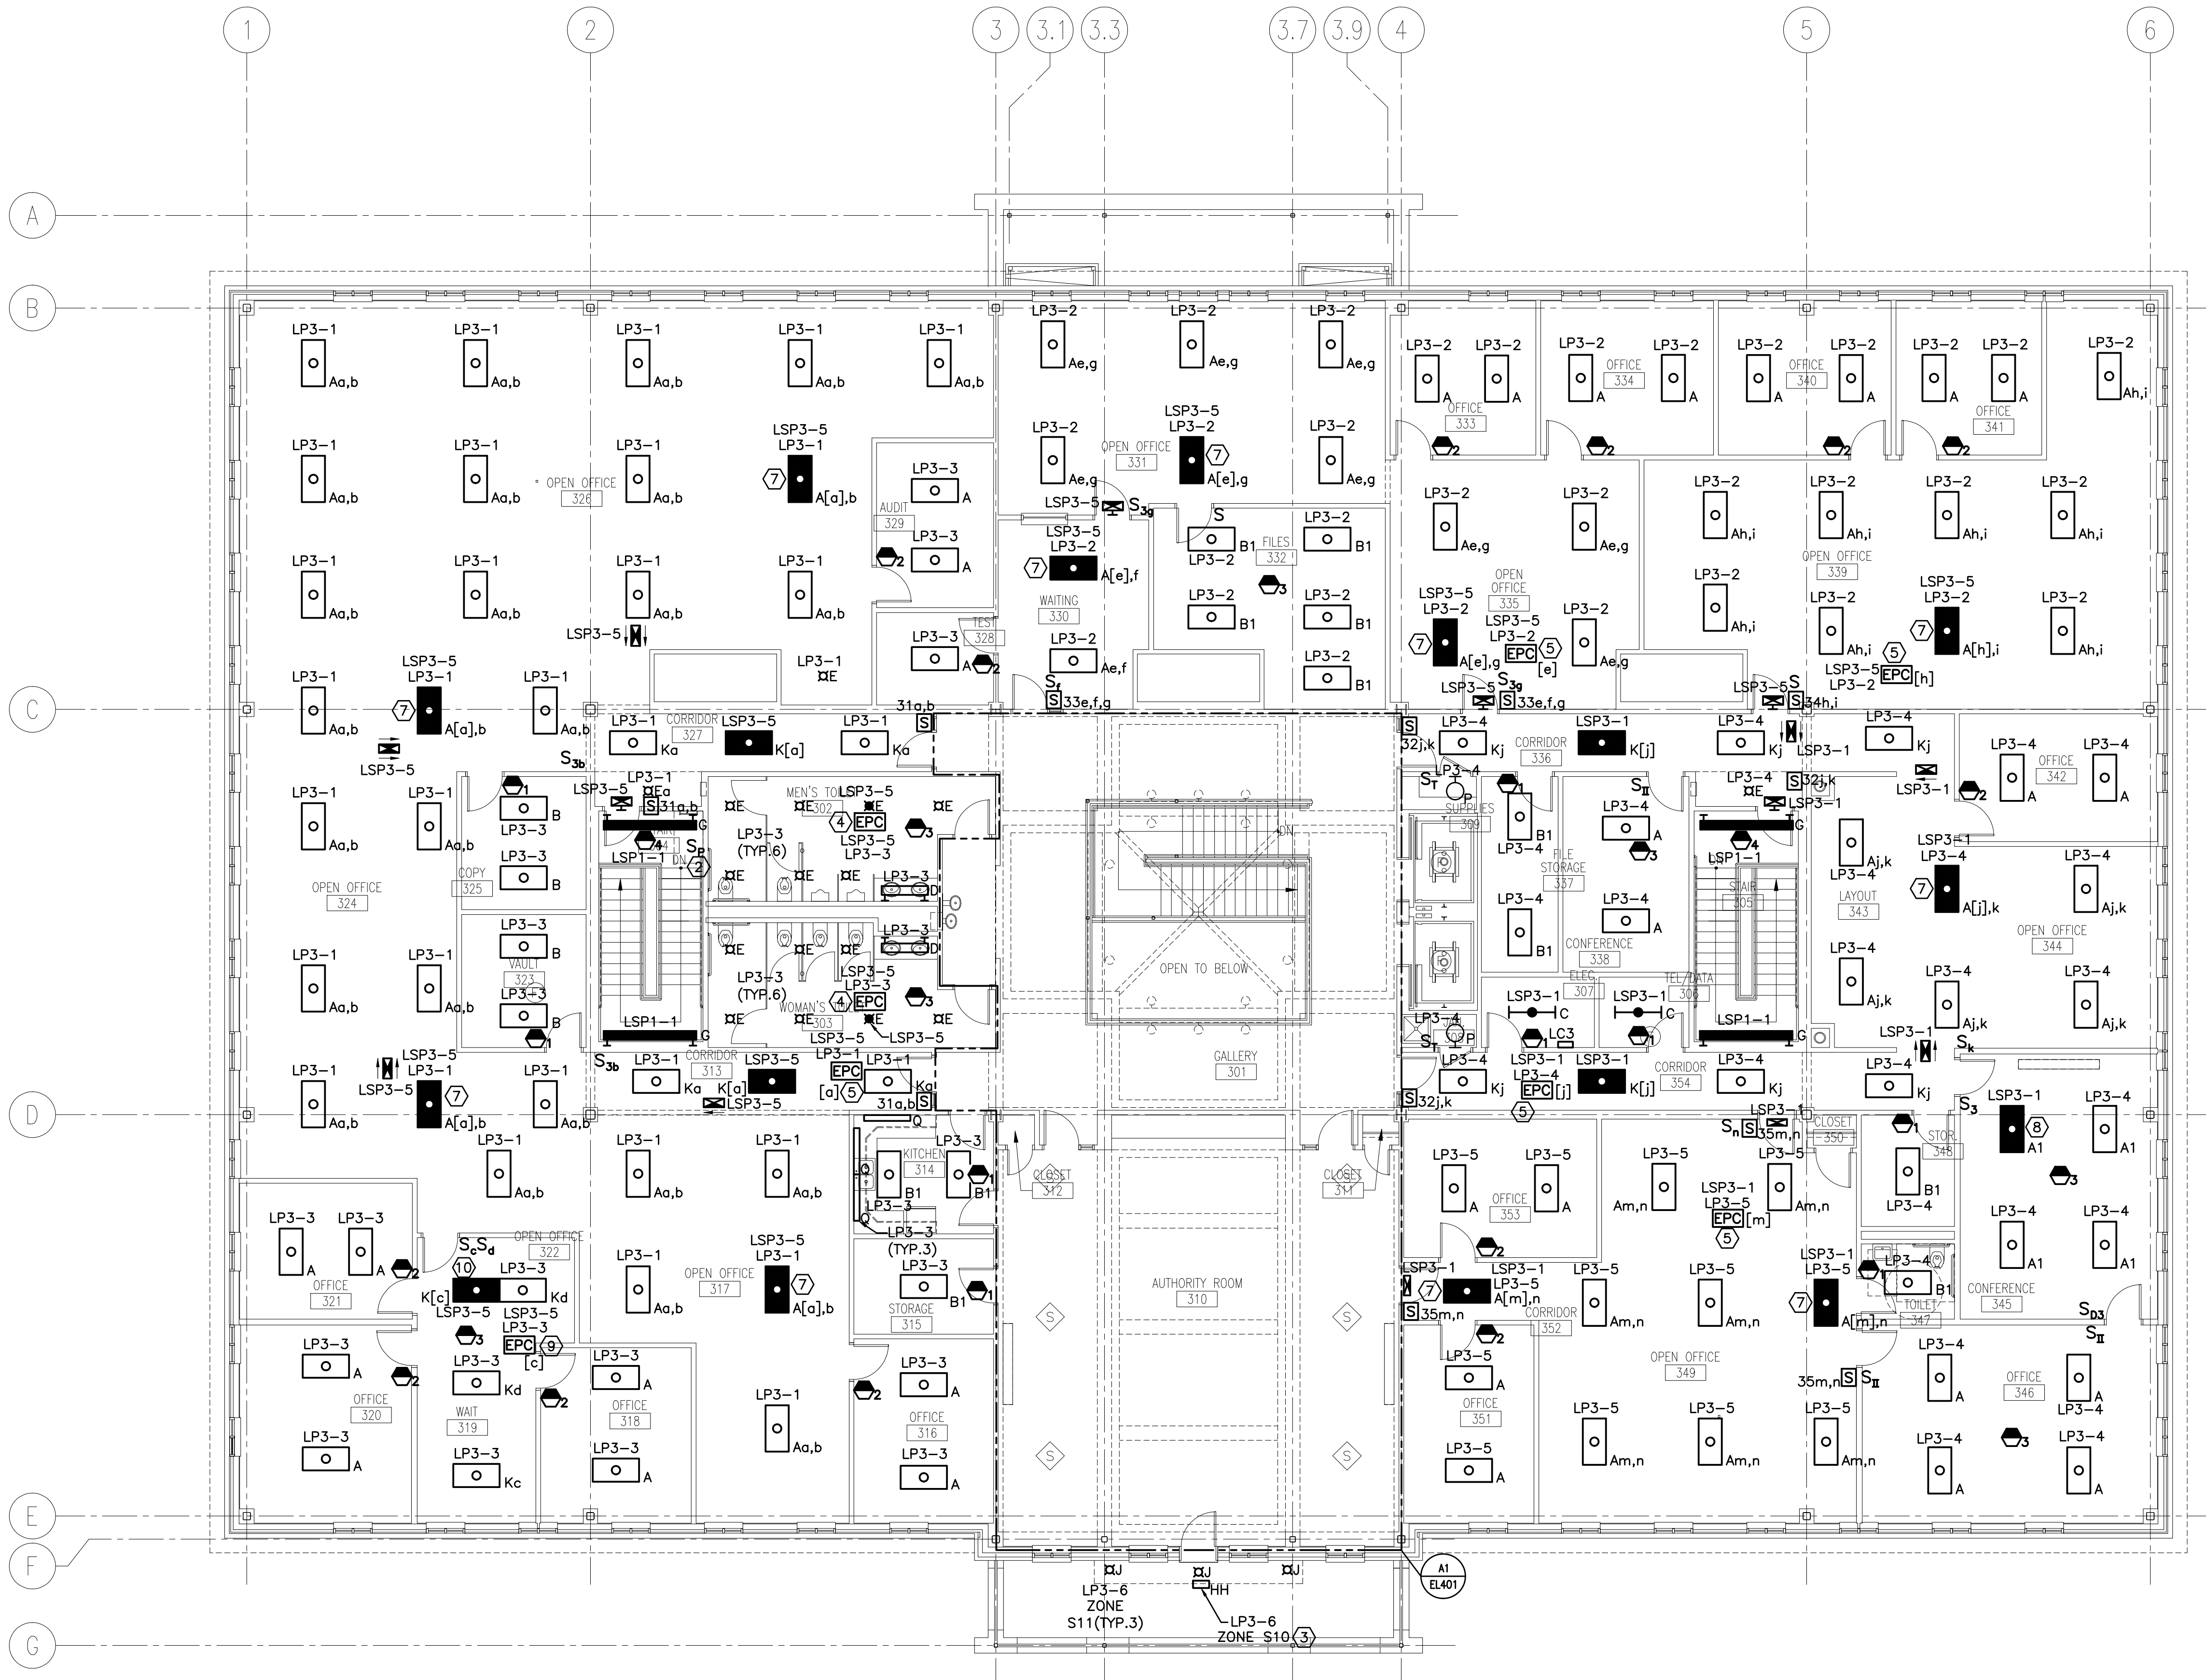1/8" = 1'-0"