




FRONT ELEVATION
1/8" = 1'-0"

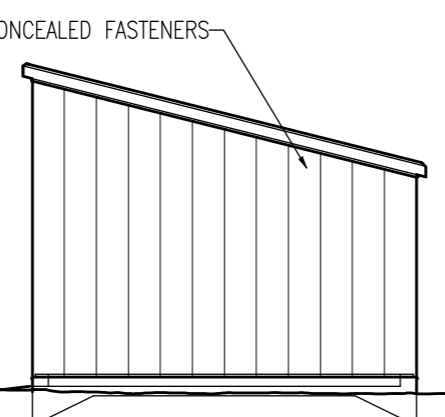


SIDES ELEVATION
1/8" = 1'-0"

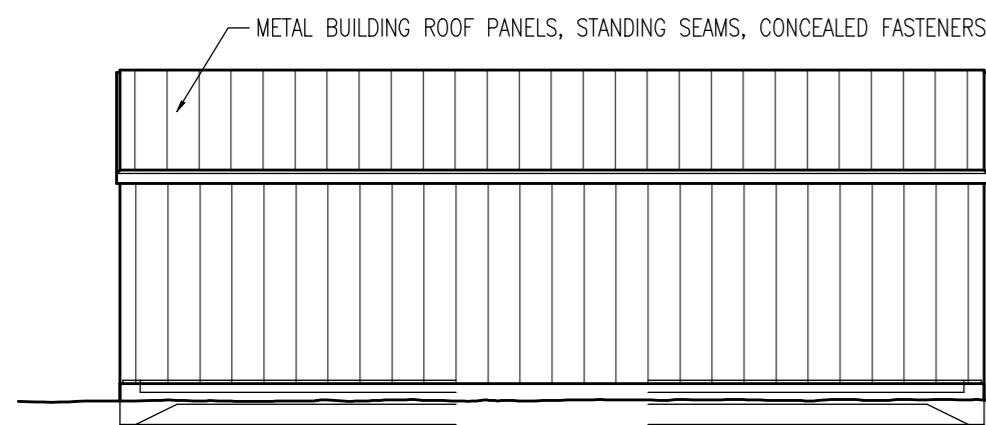


REAR ELEVATION
1/8" = 1'-0"

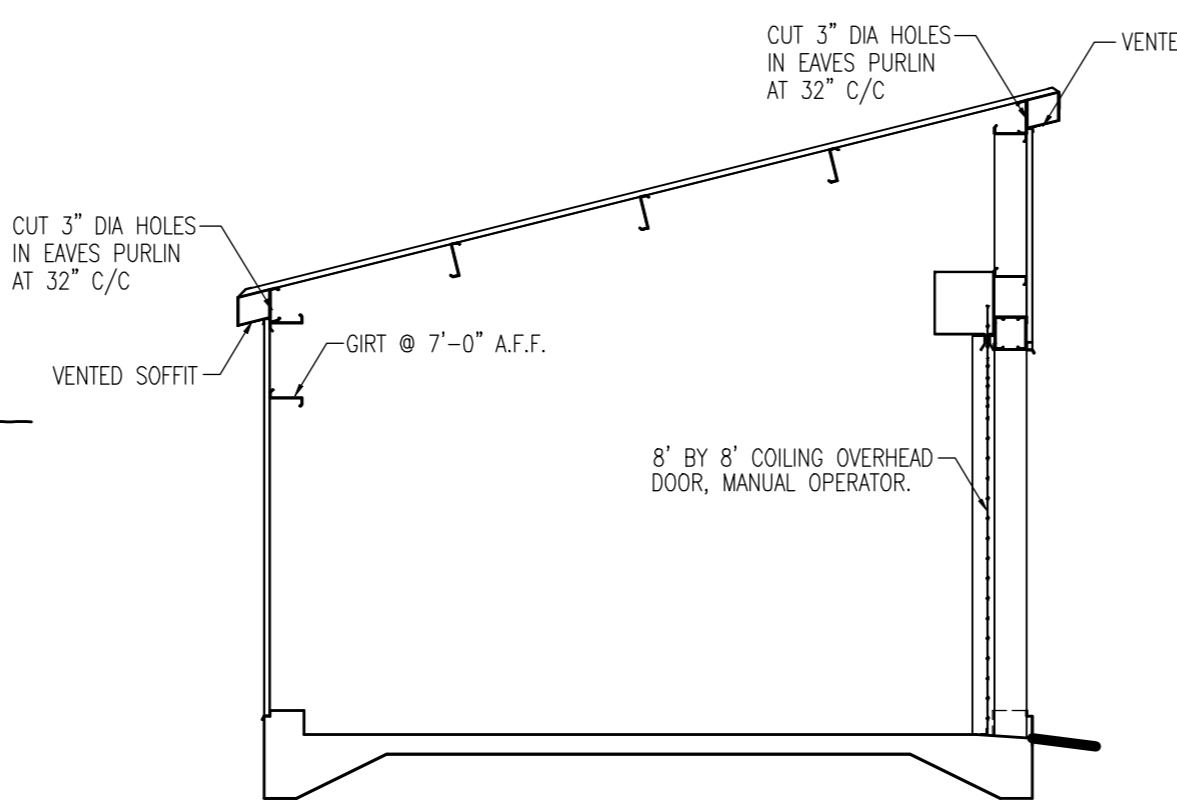


COILING DOOR SECTION
1/4" = 1'-0"

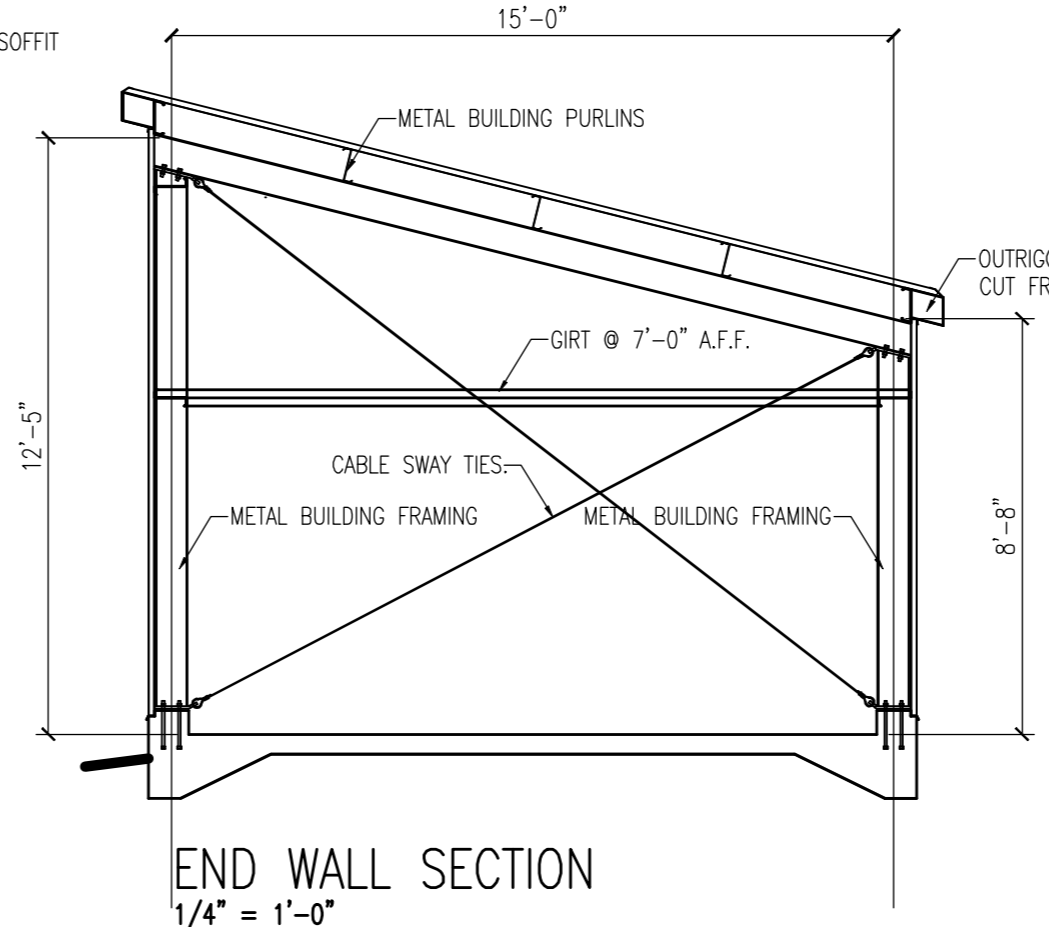


END WALL SECTION
1/4" = 1'-0"

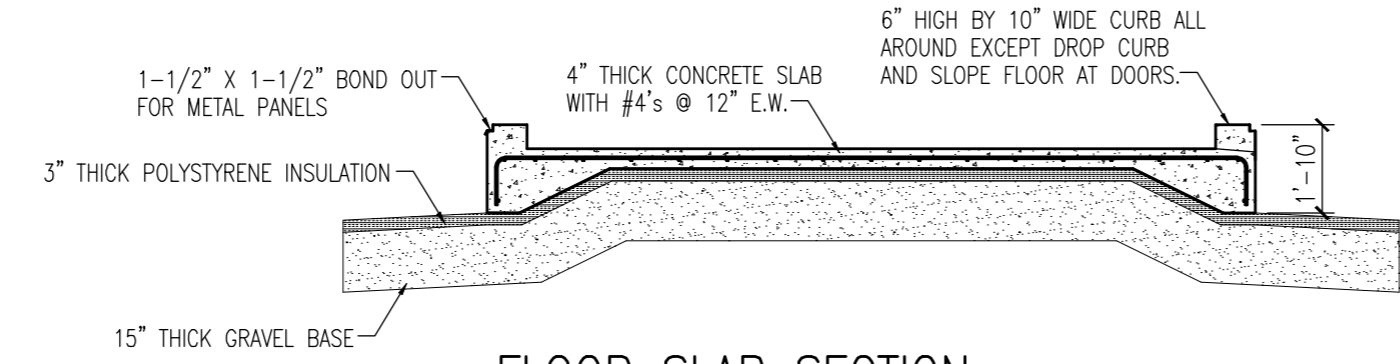


FLOOR SLAB SECTION
1/4" = 1'-0"

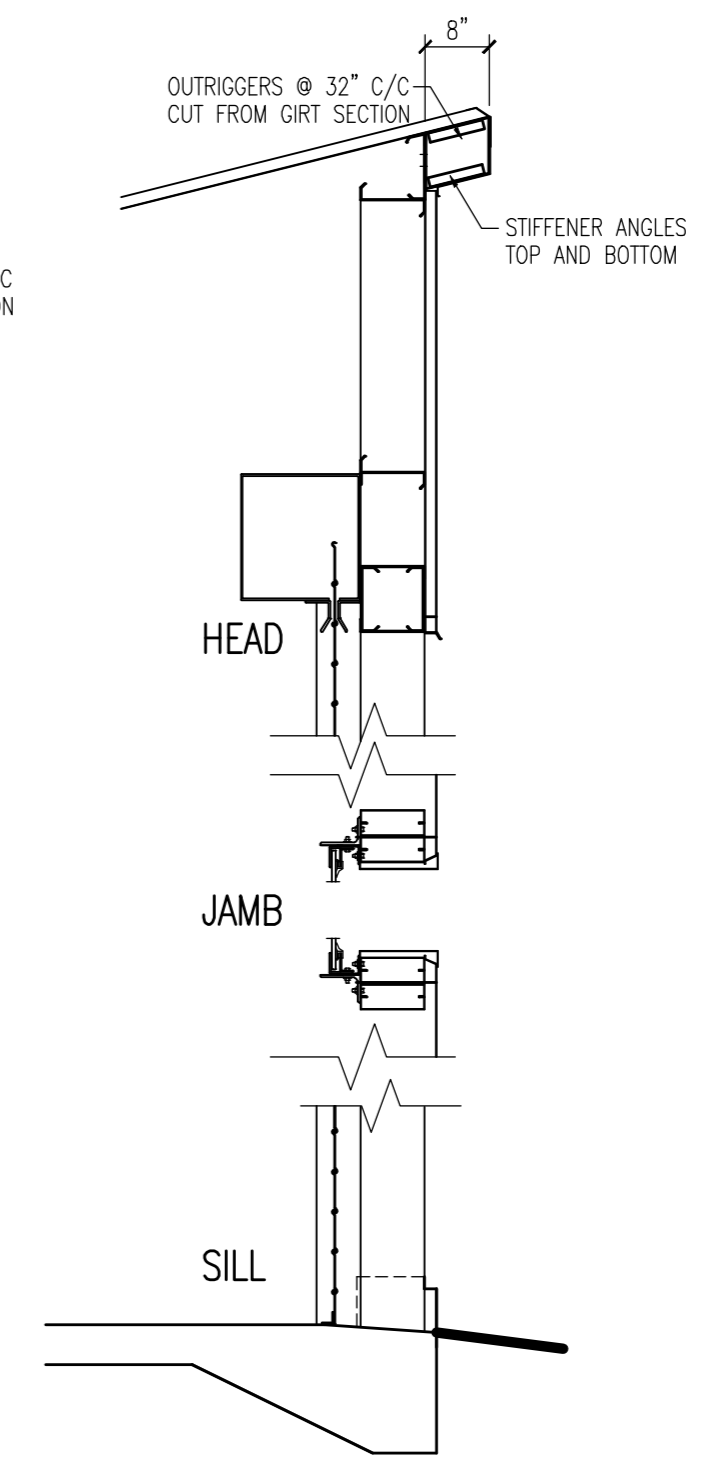


O.H. DOOR SECTION
1/2" = 1'-0"

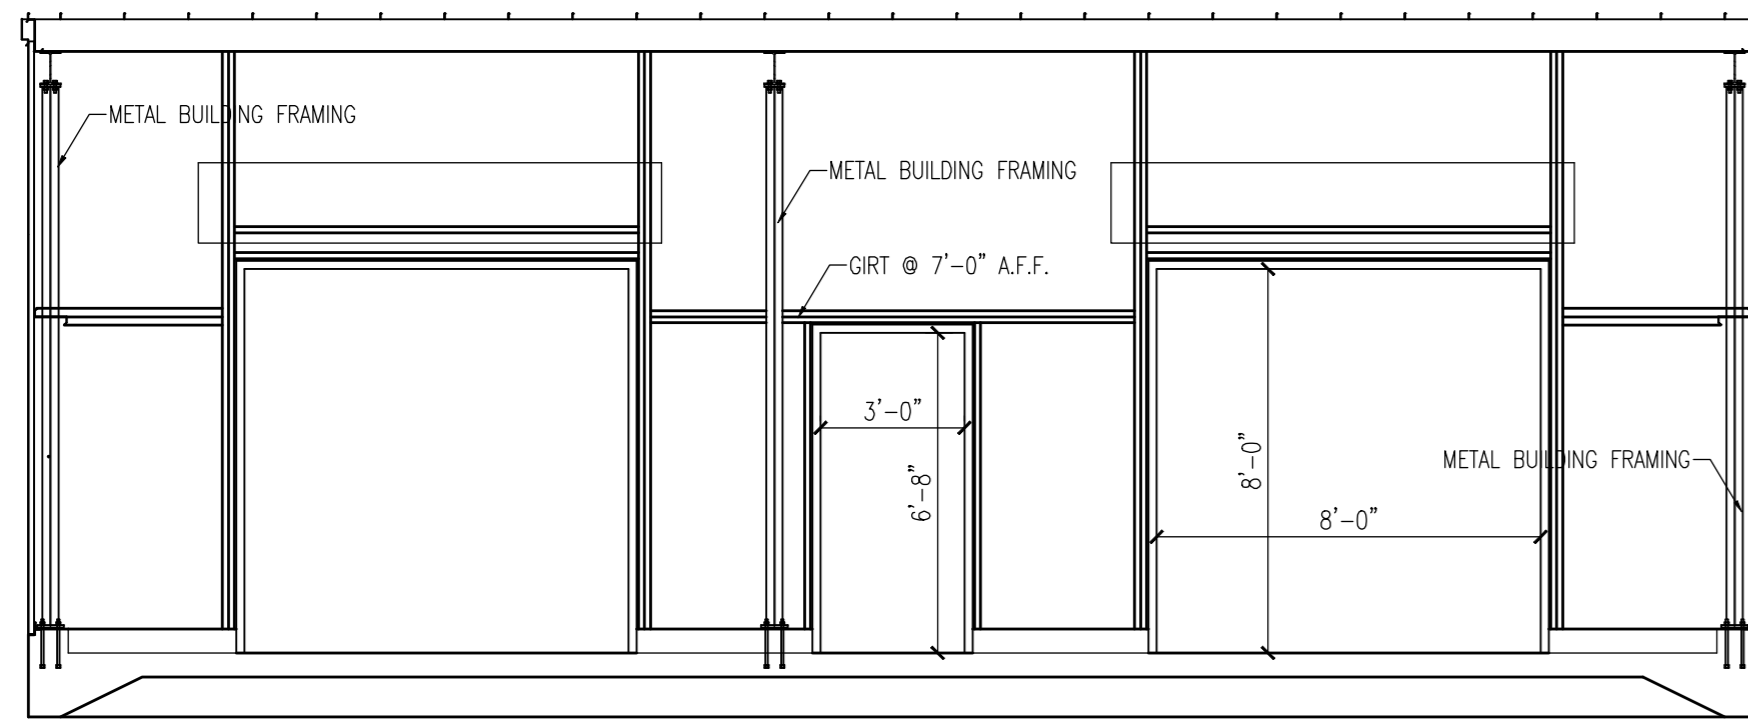


FRONT WALL FRAMING ELEVATION
1/4" = 1'-0"

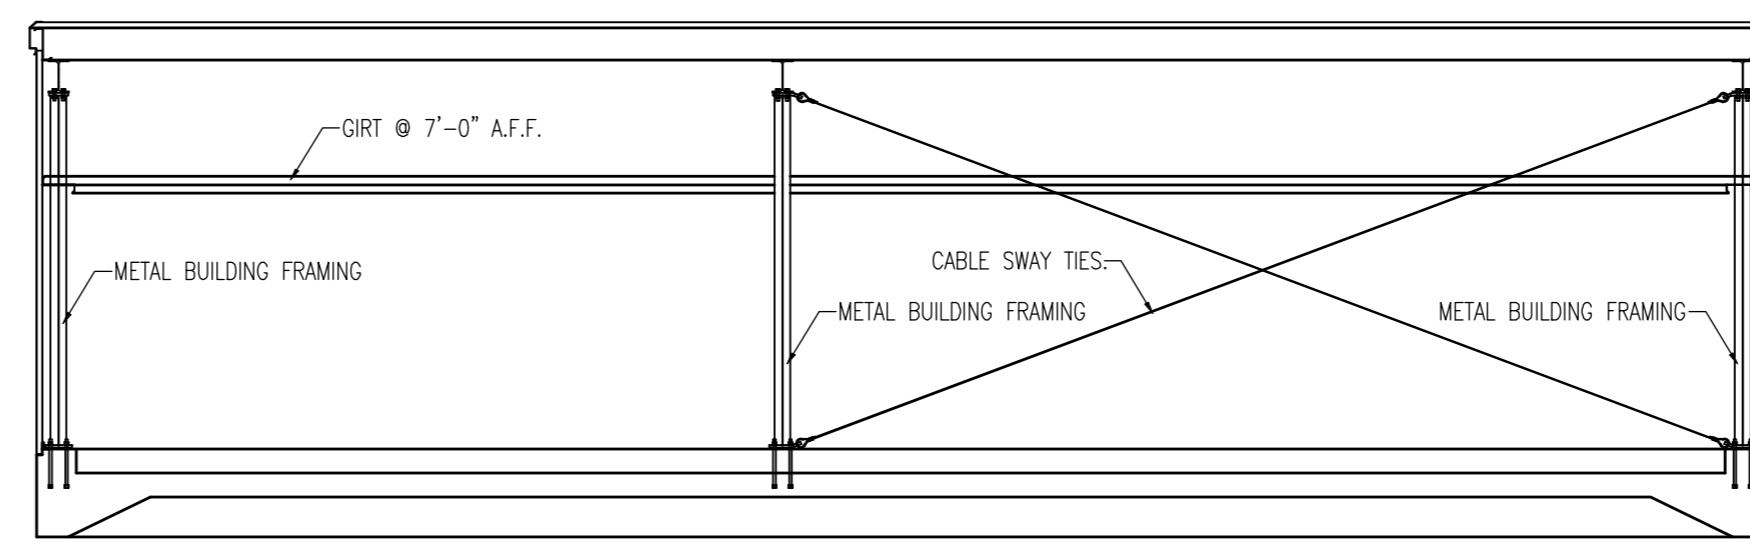

REAR WALL FRAMING SECTION
1/4" = 1'-0"

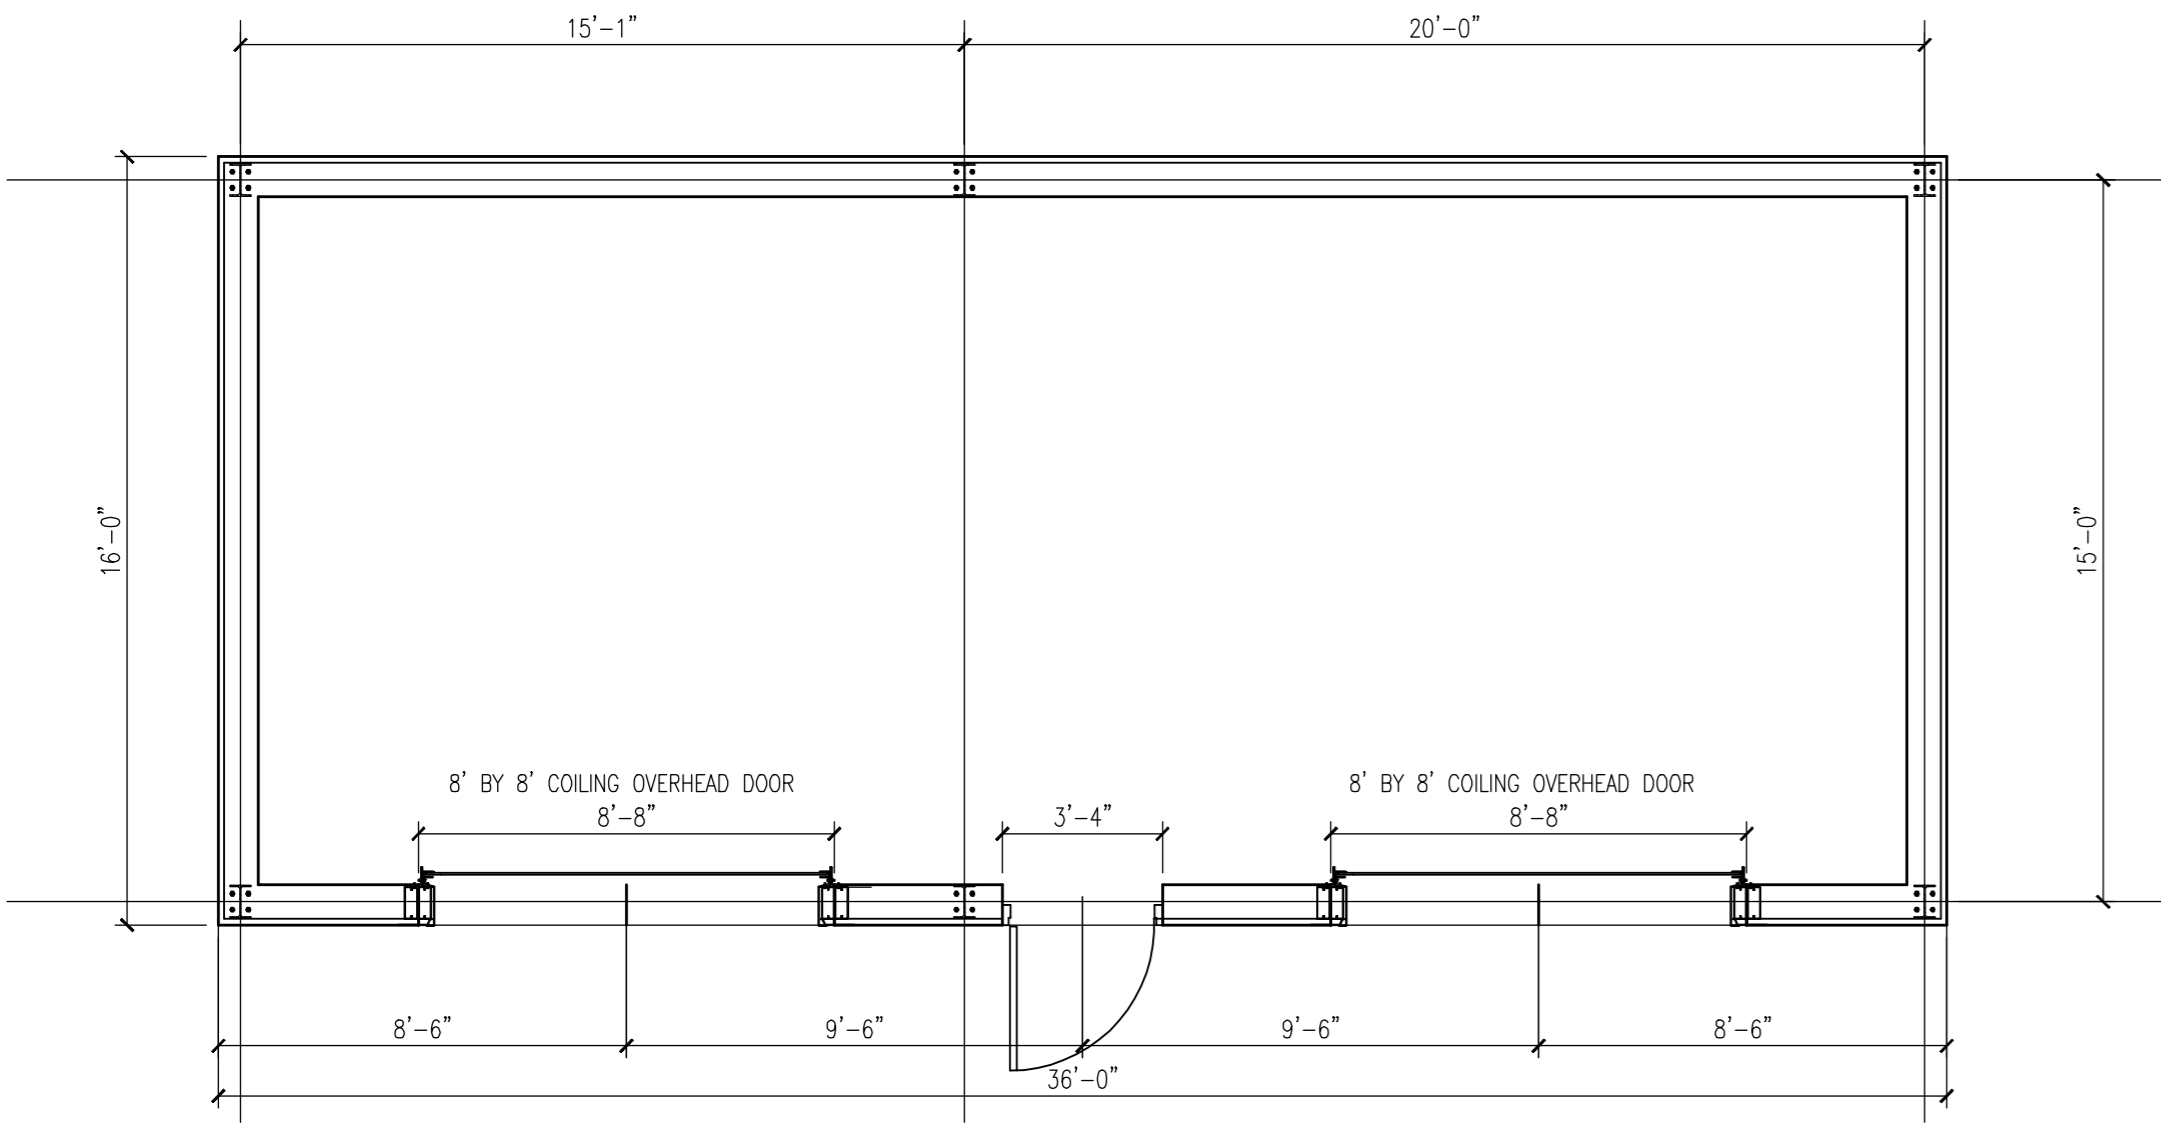

FLOOR PLAN
1/4" = 1'-0"

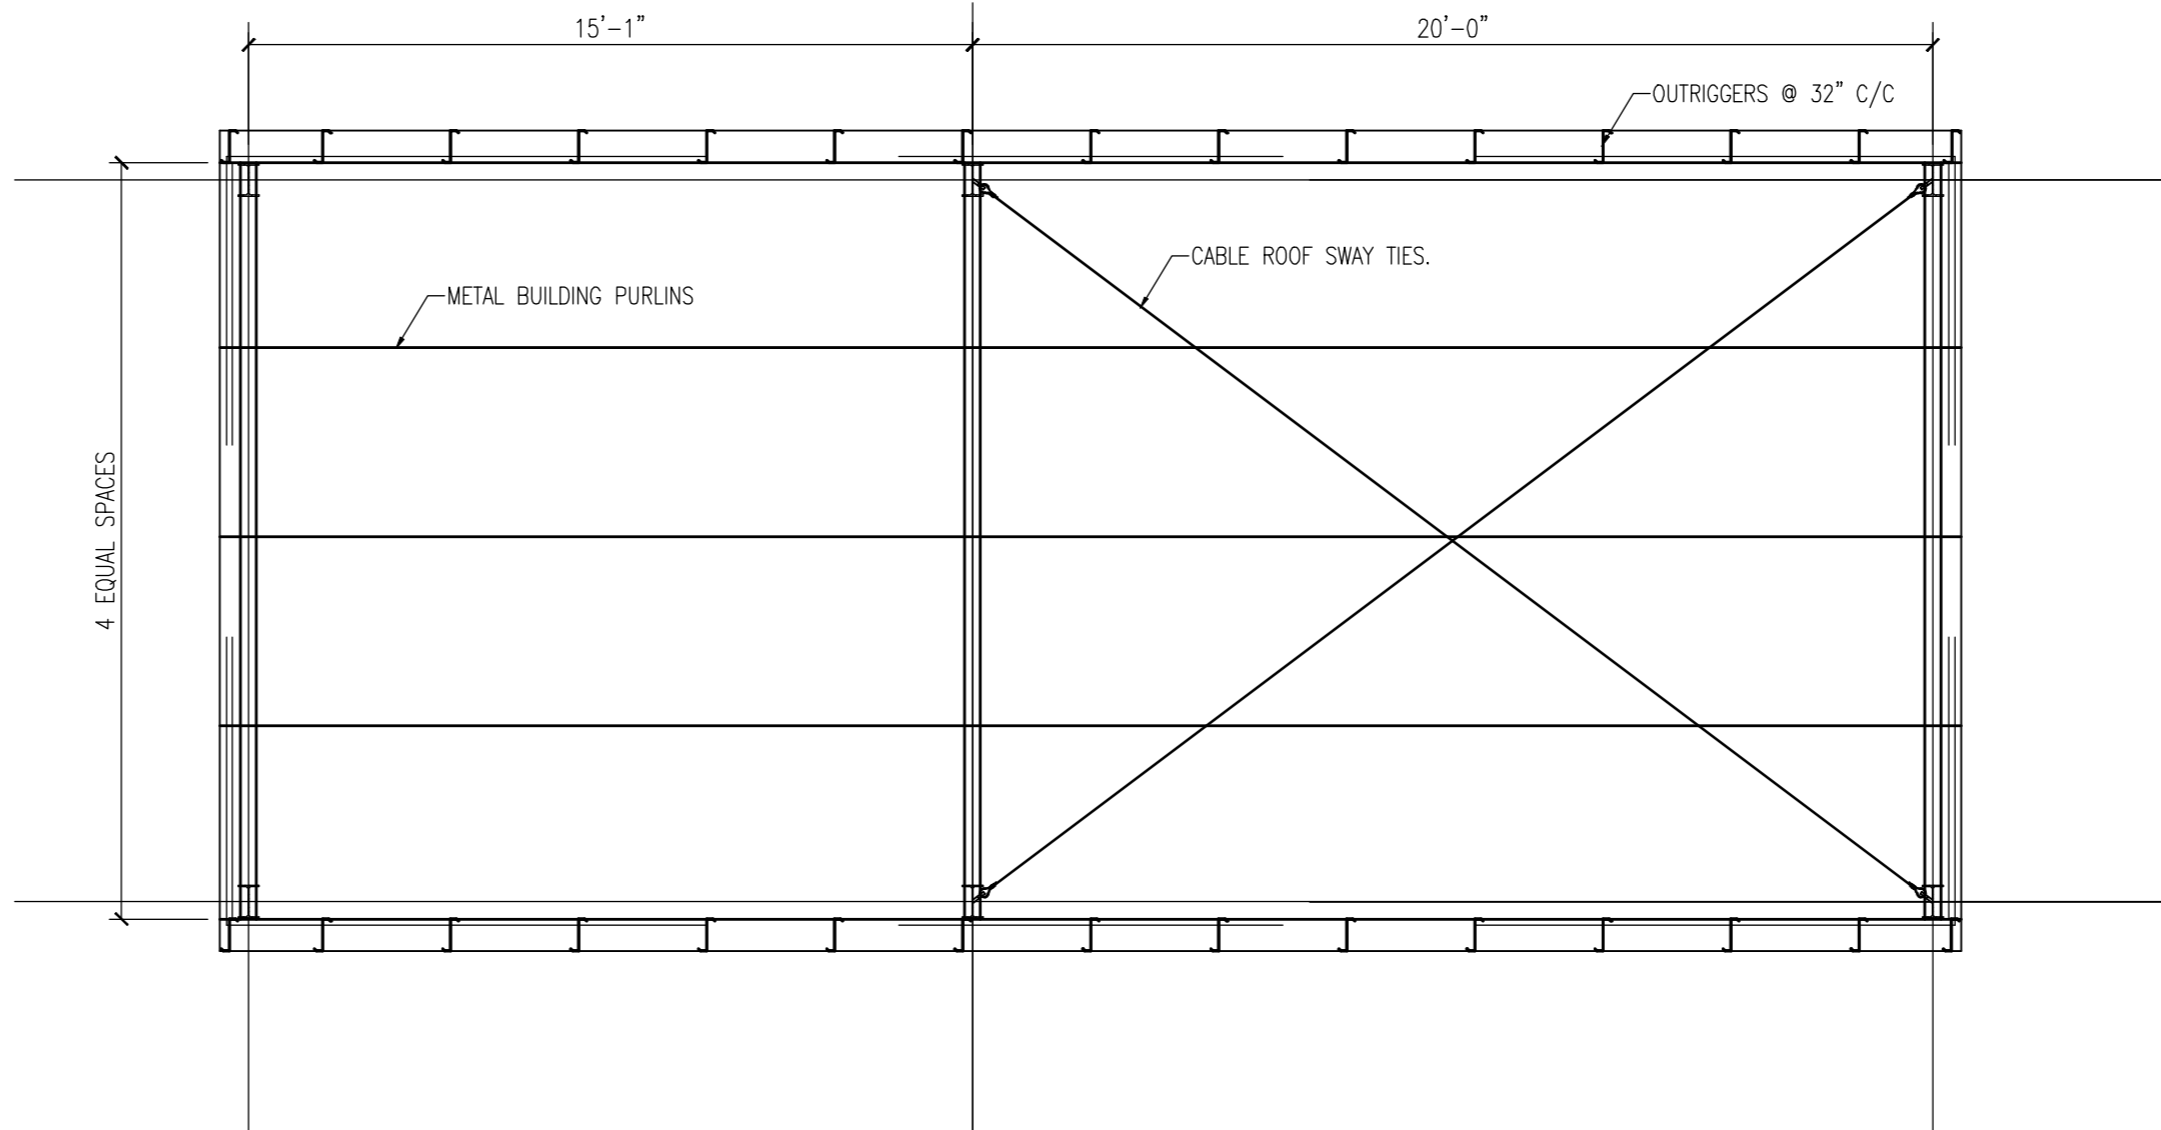

ROOF FRAMING PLAN
1/4" = 1'-0"

GENERAL NOTES:

- SEE G001 FOR PROJECT NOTES.
- FOUNDATION: CLEAN GRAVEL COMPACTED TO 95% MIN DENSITY, EXTEND BEYOND FLOOR SLAB 36".
- UNDER SLAB INSULATION: 3" THICK EXTRUDED POLYSTYRENE INSULATION, EXTEND 36" BEYOND FLOOR SLAB.
- FLOOR SLAB: 3000 PSI 28 DAY COMPRESSIVE STRENGTH CONCRETE, 0.45 WATER CEMENT RATIO, STEEL TROWEL FINISH, CURE WITH CURING COMPOUND.
- STRUCTURAL STEEL: PRE-ENGINEERED METAL BUILDING PACKAGE INCLUDING STRUCTURAL MEMBERS, COLD ROLLED GIRTS AND PURLINS, CABLE TIES, ANCHOR BOLTS, THREE COAT FLUOROPOLYMER FINISH ON METAL WALL PANELS, GALVALUME FINISH ON ROOF PANELS, CONCEALED FASTENERS, WALL AND ROOF TRIM AND ALL ACCESSORIES NECESSARY FOR A COMPLETE BUILDING ENCLOSURE. COLOR OF PANELS TO BE SELECTED FROM MANUFACTURER'S STANDARD COLORS.
- SWINGING DOOR, 3'0" X 6'8" X 1-3/4" GALVANIZED INSULATED METAL DOOR AND FRAME, 18 GA. WITH (3) F88 191 NRP STANLEY HINGES SARGENT 8204 X LNL LOCKSET PEMCO 171A THRESHOLD WITH 184AT SET ON STOP, SET THRESHOLD IN SEALANT, SECURE WITH TAPCONS. PEMCO 316AV WEATHERSTRIPPING. PEMCO 315CV DOOR BOTTOM. CO-ORDINATE DOOR CYLINDER AND KEYING WITH OWNER.
- COILING OVERHEAD DOOR: OVERHEAD DOOR COMPANY MODEL 616, 8'0" X 8'0", INSIDE FACE OF WALL MOUNTING, GALVANIZED SLATS, GALVANIZED FRAME AND EXPOSED METAL TRACKS, MANUAL OPERATING.
- ELECTRICAL WORK:



ARCHITECTURE ENGINEERING PLANNING
SMRT
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Portland, Maine 04104
tel. (207) 772-3846
fax. (207) 772-1070

PROJECT TITLE: MAINE TURNPIKE AUTHORITY ADMINISTRATION BUILDING PORTLAND, MAINE
CURRENT ISSUE STATUS: FINAL COST ESTIMATE 5-14-07

REV	DESCRIPTION	DATE

GRAPHIC SCALE: 0" = 1"
SCALE: AS NOTED
PROJECT MANAGER: SLB
JC/DRAWN BY: TCM/WW
A/E OF RECORD: WEW
CAD FILE: AE203-06016
PROJECT NO: 06016
DATE: 06016
SHEET TITLE: EXTERIOR ELEVATIONS
SHEET No. AE203