



REV	DESCRIPTION	DATE
0	BIDDING/CONSTRUCTION	7-9-07

GRAPHIC SCALE:

 SCALE: AS NOTED
 PROJECT MANAGER: SLB
 JC/DRAWN BY: TCM/TCM
 A/E OF RECORD: SLB
 CAD FILE: AE123-06016
 PROJECT NO: 06016
 DATE: 7-9-07

GENERAL NOTES:

- SEE G1001 FOR PROJECT GENERAL NOTES.

REFLECTED CEILING PLAN NOTES:



- REFERENCE ROOM FINISH SCHEDULE FOR CEILING HEIGHTS AND TYPES
- FIRE SPRINKLERS SHALL BE LOCATED IN ALIGNMENT WITH OTHER CEILING ITEMS, TYPICALLY
- FIRE SPRINKLERS SHALL BE CENTERED IN CEILING TILE
- FIRE SPRINKLERS SHALL BE PLACED TO COORDINATE WITH LIGHT FIXTURE POSITIONS INDICATED.
- ALIGN CEILING ITEMS AS SHOWN, WITH COMMON CENTERLINES, TYPICALLY. CENTER ITEMS IN CEILINGS, OR IN AREA U.N.O
- PROVIDE ACCESS PANELS AS REQUIRED IN GWB CEILINGS FOR ACCESS TO MECHANICAL VALVES/ CONTROLS. RE: MECHANICAL DRAWINGS

SOFFIT HEIGHT SCHEDULE

- ▲ 7'-0" A.F.F.
- ▲ 7'-6" A.F.F.
- ▲ 8'-0" A.F.F.
- ▲ 8'-6" A.F.F.
- ▲ 11'-6" A.F.F.
- ▲ 6'-10" A.F.F.

SYMBOL LEGEND

- AREA INDICATING 2 LAYERS GWB SUSPENDED FROM STRUCTURE ABOVE SUPPORTING ACOUSTIC PANEL CEILING
- AREA INDICATING LIMITS OF HORIZONTAL SHAFT ASSEMBLY ABOVE CEILING
- HANGING BRICK SOFFIT
- ALUMINUM SOFFIT/ CEILING SYSTEM
- 2x4 SUSPENDED CEILING PANEL AND GRID ASSEMBLY
- 2x2 SUSPENDED CEILING PANEL AND GRID ASSEMBLY
- GWB CEILING
- 2x4 LAY-IN LIGHT FIXTURE
- 1x4 PENDANT LIGHT FIXTURE
- DOWN LIGHT
- CEILING MOUNTED EXIT LIGHT
- RETURN AIR GRILLE
- SUPPLY AIR GRILLE
- EXHAUST AIR GRILLE
- SPRINKLER HEAD
- CEILING MOUNTED SPEAKER
- CEILING MOUNTED SMOKE DETECTOR
- SLOT DIFFUSER
- CEILING MOUNTED CAMERA (N.I.C.)
- CEILING MOUNTED HEAT DETECTOR
- CEILING MOUNTED OCCUPANCY SENSOR

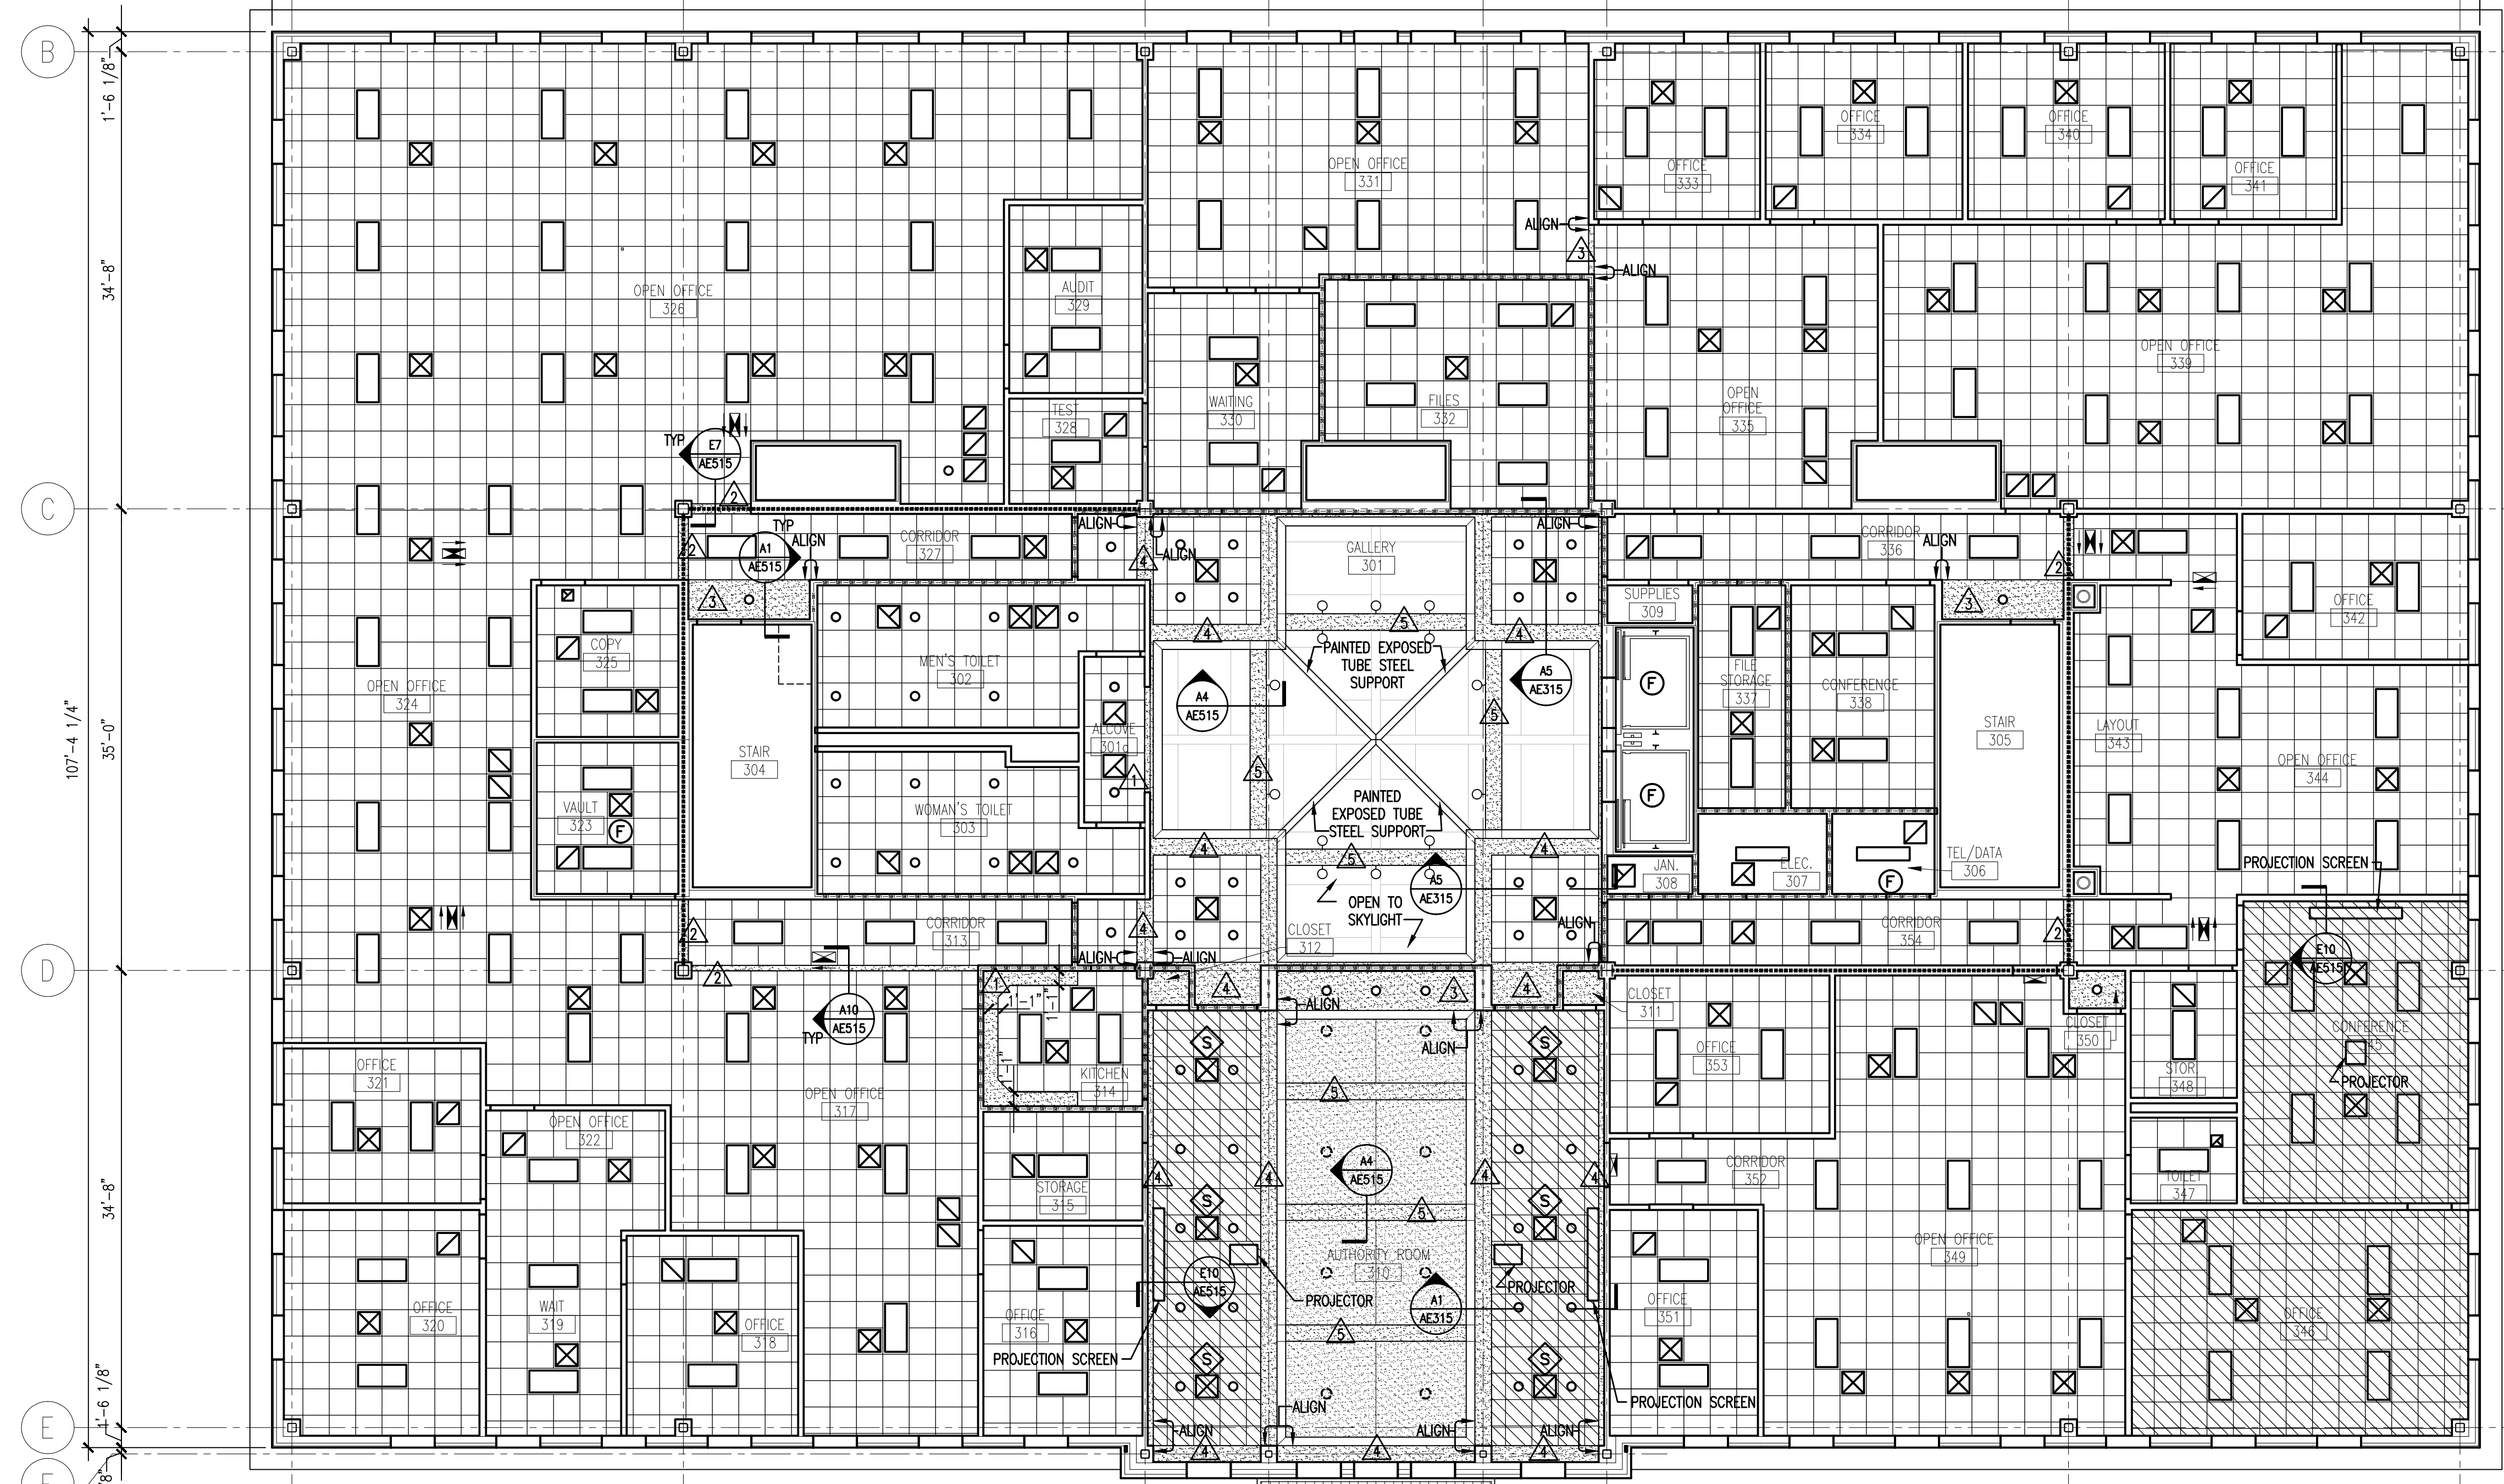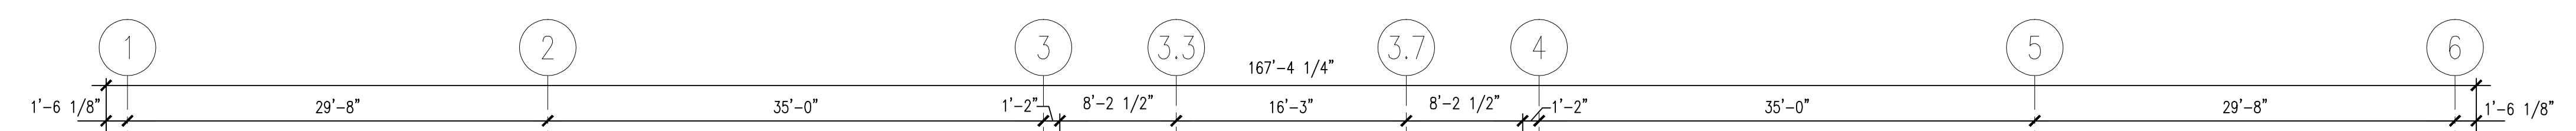

A1 THIRD FLOOR REFLECTED CEILING PLAN

1/8" = 1'-0"