PLUMBING SPECIFICATIONS													
		PLEASE NOTE: ALL REQUIREMENTS TO BE VERIFIED BY MANUFACTURER'S SPEC	UTILITIES										
YIIIY	NUMBE	SHEETS PROVIDED BY HENRY SCHEIN DENTAL EQUIPMENT SPECIALIST. MANUFACTURER'S SPECS SUPERSEDE ANY AND ALL INFORMATION CONTAINED HEREIN.	WATER	HOT WATER	7		RAL GAS	MUM		NEN.		MECH. DETAIL	. DETAIL
QUANTITY	SPEC.	DESCRIPTION	COLD	HOT V	DRAIN	AIR	NATURAL	VACUUM	N20	OXYG	VENT	MECH	CONS. I
6	7	N2O, O2 AND VACUUM OUTLET STATION - CONTRACTOR (MED GAS CERTIFIED WHERE REQUIRED BY CODE) TO PROVIDE REQ'D UTILITES. OUTLET STATION PROVIDED BY HENRY SCHEIN DENTAL, INSTALLED BY CONTRACTOR (WHEN REQUIRED). SILVER SOLDERED TO TYPE K OR L COPPER LINES, 3/8" OD NITROUS AND 1/2" OD OXYGEN COMING FROM THE SYSTEM MANIFOLD. 1/2" O.D. VACUUM BRANCH FROM MAIN VACUUM TRUNK LINE. SEE HENRY SCHEIN DENTAL EQUIPMENT SPECIALIST FOR EXACT LOCATIONS. FOLLOW NFPA CODES.						•	•	•		7	
4	7A	OXYGEN OUTLET - CONTRACTOR (MED GAS CERTIFIED WHERE REQUIRED BY CODE) TO PROVIDE REQ'D UTILITIES. OUTLET SUPPLIED BY HENRY SCHEIN DENTAL, INSTALLED BY CONTRACTOR. SILVER SOLDERED TO 1/2" O.D. TYPE K OR L COPPER LINES COMING FROM THE SYSTEM MANIFOLD. SEE HENRY SCHEIN DENTAL EQUIPMENT SPECIALIST FOR EXACT LOCATIONS. FOLLOW NFPA CODES.								•		7A	
6	7B	NITROGEN OUTLET - CONTRACTOR TO PROVIDE REQ'D UTILITES. OUTLET SUPPLIED BY HENRY SCHEIN DENTAL, INSTALLED BY CONTRACTOR. SILVER SOLDERED TO 3/8" O.D. TYPE K OR L COPPER LINES COMING FROM THE SYSTEM MANIFOLD. SEE HENRY SCHEIN DENTAL EQUIPMENT SPECIALIST FOR EXACT LOCATIONS. FOLLOW NFPA CODES.										7B	
12	11	MODULAR SINKS & FAUCETS - CONTRACTOR TO PROVIDE REQ'D UTILITES. SINK AND FAUCET SUPPLIED BY HENRY SCHEIN DENTAL, INSTALLED BY CONTRACTOR. FINAL CONNECTIONS BY CONTRACTOR.	•	•	•								
12	12B	TAP MASTER FAUCET CONTROL - FROM (12B) TO (11) OR (11A). SUPPLIED BY HENRY SCHEIN DENTAL, INSTALLED BY CONTRACTOR.										12B	
2	13	COMPRESSED AIR LINE AND VALVE - CONTRACTOR TO PROVIDE REQ'D UTILITES. TERMINATE WITH A 3/8" COMPRESSION STOP.				•						13	
2	15A	INSTRUMENT WASHER (HYDRIM) - CONTRACTOR TO PROVIDE REQ'D UTILITIES. WASHER SUPPLIED AND INSTALLED BY HENRY SCHEIN DENTAL.	•	•	•							15A	
1	16	MODEL TRIMMER - CONTRACTOR TO PROVIDE REQ'D UTILITIES. MODEL TRIMMER SUPPLIED AND INSTALLED BY HENRY SCHEIN DENTAL. BACK FLOW PREVENTION REQUIRED PER CODE.	•		•							16	

PLUMBING SPECIFICATIONS												
QUANTITY	SPEC. NUMBER	DESCRIPTION	COLD WATER	HOT WATER	DRAIN		NATURAL GAS	VACUUM	NZU CXXO	OX GEN VENT	MECH. DETAIL	CONS. DETAIL
1	17	PLASTER TRAP - SUPPLIED BY HENRY SCHEIN DENTAL, INSTALLED BY CONTRACTOR ON SINK DRAIN LINE.			•						16	
10		VACUUM INLET - CONTRACTOR TO PROVIDE A 1/2" PVC BRANCH WITH TERMINATION FITTING FROM MAIN TRUNK LINE. VERIFY HEIGHT AND LOCATION WITH HENRY SCHEIN DENTAL EQUIPMENT SPECIALIST.						•			28	
1	30G	ULTRA PURE WATER SYSTEM (P&C VISTAPURE @ STERILIZATION) - SUPPLIED AND INSTALLED BY HENRY SCHEIN DENTAL.	•		•						30G	
1	33	N2O-O2 SYSTEM MANIFOLD - CONTRACTOR TO PROVIDE REQ'D UTILITIES. MANIFOLD SUPPLIED BY HENRY SCHEIN DENTAL, INSTALLED BY CONTRACTOR. SILVER SOLDERED K OR L COPPER TRUNK LINES RUNNING TO EACH TREATMENT ROOM. CONTRACTOR TO PRESSURE TEST LINES SEPARATELY WITH DRY NITROGEN AT 150 PSI FOR 24 HOURS. FOLLOW NFPA CODES.						,	•	•	33	
1	33A	NITROGEN MANIFOLD SYSTEM - CONTRACTOR TO PROVIDE REQ'D UTILITIES. RUN K OR L COPPER LINES TO ALL TREATMENT ROOM LOCATIONS REQUIRING AIR. MANIFOLD SUPPLIED BY HENRY SCHEIN DENTAL, INSTALLED BY CONTRACTOR.									33A	
1	34A	N2O-O2 ZONE SHUT-OFF VALVES - SUPPLIED BY HENRY SCHEIN DENTAL, INSTALLED BY CONTRACTOR. SILVER SOLDERED K OR L COPPER INSTALLED ON TRUNK LINES BETWEEN MANIFOLD AND TREATMENT ROOMS. CONTRACTOR TO PRESSURE TEST LINES SEPARATELY WITH DRY NITROGEN AT 150 PSI FOR 24 HOURS. FOLLOW NFPA CODES.									34A	

PLUMBING NOTES

1. THIS SPECIFICATION SHEET IS INTENDED AS A GUIDE FOR TRADESMEN. THE FLOOR PLANS ENCLOSED HEREIN ARE SUGGESTIONS FOR THE PLACEMENT OF DENTAL EQUIPMENT. THEY ARE NOT INTENDED FOR CONSTRUCTION.

2. EXACT EQUIPMENT LOCATIONS MUST BE JOB SITE VERIFIED BY THE HENRY SCHEIN DENTAL EQUIPMENT SPECIALIST.

3. FOLLOW MANUFACTURER'S DRAWINGS FOR EXACT REQUIREMENTS FOR ANY EQUIPMENT SUPPLIED BY HENRY SCHEIN DENTAL. CONSULT WITH HENRY SCHEIN DENTAL REP FOR ADDITIONAL INFORMATION.

4. ANY REFERENCE TO "AIR", "COMPRESSED AIR" OR "AIR COMPRESSOR" REFER TO THE UNIT AND ALL COMPONENTS WHICH ARE CONSIDERED A LEVEL 3 "GAS-DRIVEN DEVICE" SUPPLY SYSTEM. REFER TO NFPA 99, 2005, 5.3.3.5 FOR REGULATIONS & REQUIREMENTS. THIS SHOULD NOT BE CONFUSED WITH "AIR" AS IT IS DEFINED IN LEVEL 1 OR LEVEL 2 MEDICAL FACILITIES.

5. WATER PRESSURE MUST NOT EXCEED 50 PS1 AT ALL DENTAL UNITS.

6. BACK-FLOW PREVENTION IS REQUIRED ON ALL LINES AS PER LOCAL CODE.

VACUUM NOTES

THE VACUUM PIPING LAYOUT HAS A LARGE EFFECT ON THE EFFICIENCY AND RELIABILITY OF THE DENTAL VACUUM SYSTEM. REFER TO MANUFACTURER'S PRE-INSTALLATION GUIDE PROVIDED BY HENRY SCHEIN EQUIPMENT SPECIALIST (FOR SPECIFIC SIZING OF STUB-UP, TRUNK, AND BRANCH LINES.


IT IS HIGHLY RECOMMENDED THAT VACUUM LINES RUN UNDERNEATH DENTAL EQUIPMENT BY MEANS OF TRENCHING/ CORING (CONCRETE SLAB) OR IN SUB FLOOR (BASEMENT/ CRAWL SPACE). ALL LINES ARE TO BE DESIGNED WITH PVC PIPING UNLESS DICTATED BY LOCAL CODES TO USE COPPER OR CAST IRON.

TO ENSURE OPTIMUM VACUUM PERFORMANCE, INSTALL MAIN LINE DIRECTLY BELOW THE DENTAL CHAIR, CABINET OR WALL JUNCTION BOX TO REDUCE OR ELIMINATE BRANCH LINE RUNS WHEREVER POSSIBLE.

TERMINATE VACUUM TRUNK LINE IN MECHANICAL ROOM W/ VERTICAL STUB-UP 3' A.F.F. PLUMBING CONTRACTOR TO PROVIDE FPT ADAPTOR ON END OF STUB-UP. SIZE OF ADAPTOR TO BE DETERMINED BY TRUNK AND PUMP INTAKE PIPE SIZES. IN THE CASE OF DUAL TRUNK LINE SYSTEM, PROVIDE ENOUGH SPACE BETWEEN STUB-UPS TO INSTALL TEES ON BOTH LINES.

VACUUM TRUNK LINES(S) TO BE SUPPORTED EVERY 6'-0" TO PREVENT SAG AND SLOPED A MINIMUM OF 1/4" PER 10'-0" TOWARD THE VACUUM PUMP.

BRANCH LINES ARE TO BE "SWEEPING" 90 DEGREE TURNS TO AVOID VACUUM LOSS. A "Y" TEE FITTING SHOULD BE USED WHEN AVAILABLE TO BRANCH TWO LINES TOGETHER.

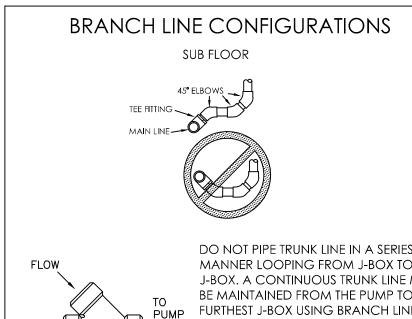

(USE FOR ALL SUB FLOOR INTERSECTIONS)

IF VACUUM LINES ENCROACH ON EITHER A WALL OR COLUMN FOOTING, USE 45 DEGREE ELBOWS TO PIPE AROUND FOOTING SO PIPE REACHES PROPER LOCATION.

SEE SHEETS SPE.1 & SPE.2 FOR ILLUSTRATIONS & DETAILS

ERN MAIR SURGER ORA DO NOT PIPE TRUNK LINE IN A SERIES MANNER LOOPING FROM J-BOX TO J-BOX. A CONTINUOUS TRUNK LINE MUST BE MAINTAINED FROM THE PUMP TO THE FURTHEST J-BOX USING BRANCH LINES OFF OF THE TRUNK LINE TO PICK UP EACH J-BOX OUTLET. TRUNK LINE MAY FOLLOW DRAIN LINE TRENCHES WITHIN REASON. USE ONLY 45° DEGREE EL'S. DO NOT USE ANY 90° EL'S. ALL SUB FLOOR SCH 40 PVC CONNECTIONS ARE TO BE PLUMBED WITH 45° EL'S USING DETAIL A FOR TEEING BRANCH LINE CONNECTIONS INTO TRUNK JESSE LEVEILLE


HENRY SCHEIN REP: CENTER: BOSTON, MA PHONE #: (207) 233-4978

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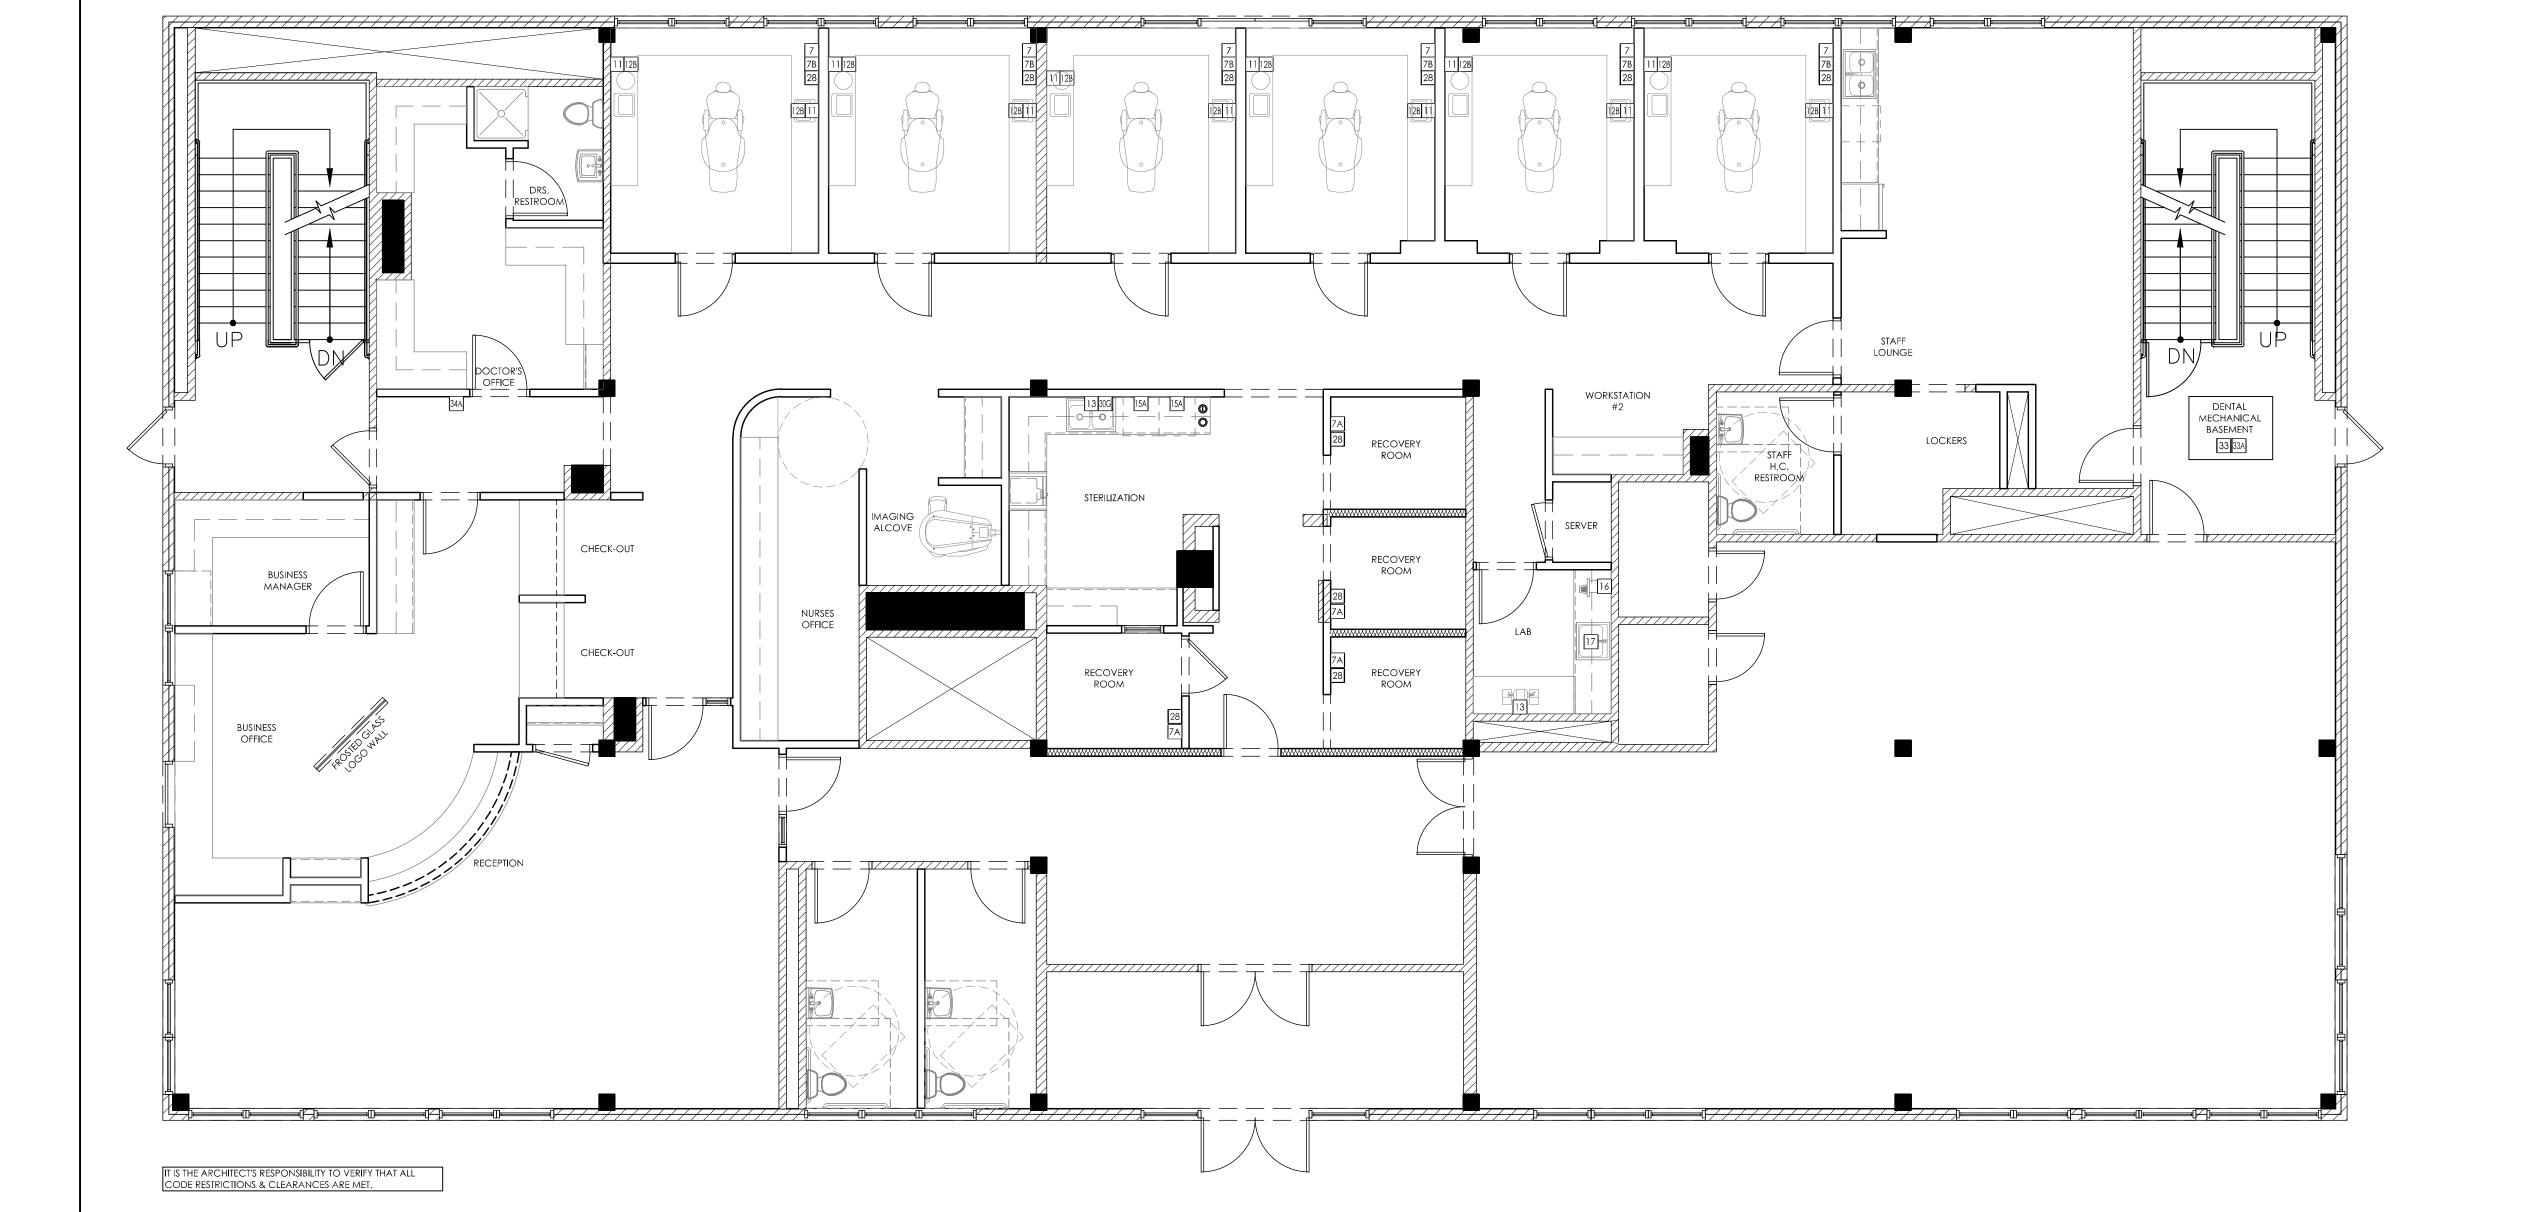
DRAWING NAME: SMOS-1c-F PROJECT START DATE: 08/11/2014 FINALS START DATE: 08/20/2014 FINALS BY:



CHECKED BY:

SCALE: SHT. SIZE: 3/16"=1'-0" PLUMBING

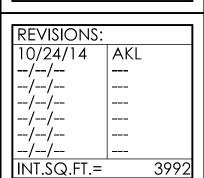SP.



PROPOSED DENTAL PLUMBING SPECIFICATIONS