# Site Review Pre-Application Multi-Family/Attached Single Family Dwellings/Two-Family Dwelling or Commercial Structures and Additions Thereto

In the interest of processing your application in the quickest possible manner, please complete the Information below for Site Plan Review

NOTE\*\*If you or the property owner owes real estate or personal property taxes or user charges on ANY PROPERTY within the City, payment arrangements must be made before permits of any kind are accepted.

, , , , , , , , , , , , , , , , , , ,	
Brown Development Corporation	_10-10-01
Applicant	Application Date
P.O. Box 7022	
Scarborough, ME 04070-7022	Starbir <u>d Road Condominiu</u> ms
Applicant's Mailing Address Shawn M. Frank, P.E.	Project Name/Description
c/o Sebago Technics, Inc.	Starbird Road
Consultant/Agent	Address Of Proposed Site
(207) 856-0277 / (207) 856-2206	224/A/1
Applicant/Agent Daytime telephone and FAX	Assessor's Reference, Chart#, Block. Lot#
Proposed Development (Check all that apply) X New Building Building	Addition Change of Use X Residential Office Retail
Manufacturing Warehouse/Distribution Parking Lot	Other(Specify)
12 condominiums in 4 buildings 1.40	ac <u>Contract Zone</u>
Proposed Building Square Footage and /or # of Units Acreage of	of Site Zoning
Major Site Plan X Minor Site Plan	n
You must Include the following with you application:	
1) A Copy of Your Deed or Purchase and Sale Agreem	aomé
	•
2) 9 sets of Site Plan packages containing the informat	ion found in the attached sample plans and
checklist.	
(Section 14-522 of the Zoning Ordinance outlines the p	process, copies are available for review at the
counter, photocopies are \$ 0.25 per page)	
I hereby certify that I am the Owner of record of the named property,	
and that I have been authorized by the owner to make this application	as his/her authorized agent. I agree to conform to all applicable
laws of this jurisdiction. In addition, if an approval for the proposed p	project or use described in this application is issued, I certify that
the Code Official's authorized representative shall have the authority to enforce the provisions of the codes applicable to this approval.	to enter all areas covered by this approval at any reasonable nour
o enforce the provisions of the codes applicable to this approval.	
Signature of applicant:	Date: 10/24/01
Site Review Fee: Major	\$500.00 Minor 400.00
This application is for site review ONLY, a Building Pe	
prior to cons	
prior to cons	ou ucuon.

# CITY OF PORTLAND, MAINE SITE PLAN CHECKLIST

Starbird Road Condominiums
Project Name, Address of Project

I.d. Number

Submitted () & Date	Item	Required Information Section	ion 14-525 (b,c)
	(1)	Standard boundary survey (stamped by a registered surveyor, at a	1
		scale of not less than 1 inch to 100 feet and including:	
<del></del>	(2)	Name and address of applicant and name of proposed development	a
	(3)	Scale and north points	b
	.(4)	Boundaries of the site	C
	(5)	Total land area of site	ď
	(6)	Topography - existing and proposed (2 feet intervals or less)	e
	(7)	Plans based on the boundary survey including:	2 .
	(8)	Existing soil conditions	a
	(9)	Location of water courses, marshes, rock outcroppings and wooded areas	Ъ
	(10)	Location, ground floor area and grade elevations of building and other structures existing and proposed, elevation drawings of exterior facades, and materials to be used	¢
·	(11)	Approximate location of buildings or other structures on parcels abutting the s	ite d
	(12)	Location of on-site waste receptacles	e
	(13)	Public utilities	e
	(14)	Water and sewer mains	e
	(15)	Culverts, drains, existing and proposed, showing size and directions of flows	e
	(16)	Location and dimensions, and ownership of easements, public or private rights-of-way, both existing and proposed	f
	(17)	Location and dimensions of on-site pedestrian and vehicular accessways	g
	(18)	Parking areas	g
···	(19)	Loading facilities	g
	(20)	Design of ingress and egress of vehicles to and from the site onto public streets	
	(21)	Curb and sidewalks	g
	(22)	Landscape plan showing:	h
	(23)	Location of existing proposed vegetation	h
	(24)	Type of vegetation	h
	(25)	Quantity of plantings	h
	(26)	Size of proposed landscaping	h
	(27)	Existing areas to be preserved	h .
	(28)	Preservation measures to be employed	h
	(29)	Details of planting and preservation specifications	h
	(30)	Location and dimensions of all fencing and screening	i
	(31)	Location and intensity of outdoor lighting system	i
	(32)	Location of fire hydrants, existing and proposed	k
	(33)	Written statement	*.
	(34)	Description of proposed uses to be located on site	i
	(35)	Quantity and type of residential, if any	1
	(36)	Total land area of the site	b2
		Total floor area and ground coverage of each proposed building and structure	
	(37)		b2
	(38)	General summery of existing and proposed easements or other burdens	c3
	.(39)	Method of handling solid waste disposal	4

	(	(40) A	pplicant's eva ad streets	luation of	availability	of off-site p	ublic facil	ities, includir	ig sewer, water	5	
_		41) D		any proble	ems of drain	age or topo	graphy, or	a representa	tion that there	6	
			n estimate of	the time p	eriod requir	ed for com	oletion of	he developm	ent	7	
		43) A	list of all state bject							8	
	(		e status of ar	ny pending	g application	15				8	
			nticipated tim	eframe fo	r obtaining s	uch permit	s			h8	
		46) A	letter of non j	jurisdictio	n					h8	
	(4	inc		r from a r	esponsible f	inancial ins	titution st	iting that is h	e the development as reviewed the oproved.	nt.	
	te: Depending on the size and uding (but not limited to):	i scope of th	ne proposed d	ievelopme	nt, the Plan	ning Board	or Planni	ng Authority	may request add	itional information,	
•	drainage patterns and facilit erosion and sedimentation of a parking and/or traffic stud	ontrols to b	e used during	g construc	tion;	-	a sun si a study	ronmental in nadow study; of particulate	es and any other	noxious emissions; ar	nd
-	a noise study;					•	a wind	impact analy	sis.		
Oth	er comments:					·					_
									• • •		
											_
	<del></del>										
		·				<del></del>	<del></del>				_
	-	<u> </u>							<del></del>		_
			····	· · · · · · · · ·		<del></del>			·	<del></del>	_
					<u> </u>			······································		<del></del>	
							····	w			
	•				•			• • • • • • • • • • • • • • • • • • •			
											_

DUPLICATE

# CITY OF PORTLAND, MAINE

O1	i i di i dili Eili	,	-
DEPAR	IMENT	DATE	he la
RECEIV	ED FROM		107-1-1
ADDRE	y and Javes	<u>coo</u>	Way C
AUUNE	Mario de		
UNIT	ITEM	REVENUE CODE	DOLLAR AMOUNT
	Main Sto		50000
			-
			-
	150	4	
	CR1 234	AD	
<del></del>	1		
□с	ASH CHECK COTHER	TOTAL	5000
	o Qual		
RECE	ORE INFORMATION SYSTEMS BOX 878, POPULAND, ME 04 104	(207) 774-1482	200747-BP

# GENERAL NOTES

COMPLY WITH ALL APPLICABLE CODES, ORDINANCES, LAWS, SAFETY ORDERS, AND DIRECTIVES OF THE STATE, COUNTY AND CITY.

EACH CONTRACTOR SHALL BE RESPONSIBLE FOR ALL PERMITS, FEES, CERTIFICATES OF INSPECTION AND APPROVAL, ETC, UNLESS OTHERWISE NOTED BY OWNER.

PRIOR TO CONSTRUCTION EACH CONTRACTOR SHALL VISIT THE SITE, AND VERIFY ALL DIMENSIONS. ANY DISCREPENCIES SHALL BE REPORTED TO THE ARCHITECT PRIOR TO BEGINNING CONSTRUCTION.

IN THE CASE OF DISCREPENCIES OR INCONSISTENCIES APPEARING IN THE CONSTRUCTION DOCUMENTS, OR FIELD CONDITIONS, THE ARCHITECT SHALL BE NOTIFIED. IN NO CASE SHALL WORK PROCEED IN UNCERTAINTY OR WITH INSUFFICIENT DATA.

ALL WORK, FIXTURES AND THE STRUCTURE SHALL BE PROTECTED IN ALL RESPECTS FROM WEATHER, CONST. HAZARDS, FIRE, UNNECESSARY INTELISIONS DIST. DIET OR DEBUS

EACH CONTRACTOR SHALL PROVIDE, INSTALL AND MAINTAIN, FOR THE DURATION OF CONSTRUCTION, ALL REQUIRED SCAFFOLDS, TARRAULINS, WARNING SIGNS, FENCES, AND OTHER TEMPORARY CONSTRUCTION ITEMS FOR THE PROPER AND SAFE COMPLETION OF THE WORK AND FOR COMPLIANCE WITH ALL APPLICABLE REGULATIONS, INCLUDING OSHA.

THE CONTRACTOR SHALL DETERMINE CONSTRUCTION PROCEDURES AND SEQUENCES, AND ENSURE THE SAFETY OF THE STRUCTURE AND ITS COMPONENTS DURING CONSTRUCTION. SAFETY MEASURES SHALL INCLUDE, BUT NOT BE LIMITED TO BRACING, SHORING FOR LOADS DUE TO CONSTRUCTION EQUIPMENT, ETC.

ALL CONSTRUCTION MATERIALS, IF PLACED ON ROOF ROOF SHALL BE SPREAD OUT TO ADEQUATELY DISTRIBUTE THE LOAD ON THE STRUCTURE. EACH CONTRACTOR SHALL PROVIDE ADEQUATE SHORING AND/OR BRACING WHERE THE STRUCTURE DOES NOT PROVIDE ADEQUATE STRENGTH.

ALL MATERIALS, FABRICATION, AND/OR INSTALLATION SHALL COMPLY WITH ALL TECHNICAL AND INDUSTRY STDS. AND SPECIFICATIONS FOR EACH DIVISION OF WORK

ALL WORK SHALL BE CHECKED AND ACCEPTED BY THE ARCHITECT AND OWNER BEFORE CONSIDERED COMPLETE.

EACH CONTRACTOR TO FULLY REVIEW CONSTRUCTION DOCUMENTS FOR HIS SCOPE OF WORK AND CONDINATE SEQUENCE OF HIS WORK WITH OWNER AND ALL COUNTRACTORS

MECHANICAL CONTRACTOR SHALL DESIGN, PROVIDE AND INSTALL HVAC AND PLUMBING SYSTEM COMPLETE AND OPERATIONAL AND BALANCED.

ELECTRICAL CONTRACTOR SHALL DESIGN, PROVIDE AND INSTALL ELECTRICAL SYSTEM COMPLETE AND OPERATIONAL.

FIRE SUPPRESSION CONTRACTOR SHALL DESIGN, PROVIDE AND INSTALL FIRE SUPPRESSION SYSTEM COMPLETE AND OPERATIONAL.

ALL WOOD IN CONTACT WITH CONCRETE SHALL BE PRESSURE PRESERVATIVE TREATED.

CONTRACTOR SHALL WORK FROM GIVEN DIMENSIONS AND LARGE SCALE DETAILS ONLY. DO NOT SCALE THE DRAWINGS.

ALL FLOORS SHALL BE LEVELED TO A TOLERANCE OF 1/8" IN 10"-0" WHEN CHECKED AT ANY AREA WITH A 10"-0" STRAIGHT EDGE.

INSTALL BLOCKING FOR FUTURE SURFACE APPLIED FIXTURES, TRIM, CABINETS, COUNTER TOPS, AND GRAB BARS WHEN MOUNTED ON STUD WALLS. INCLUDING FUTURE WORK.

INSTALL MOISTURE RESISTANT GYPSUM BOARD IN BATHROOMS, LAUNDRY AND ALL OTHER HIGH HUMIDITY AREAS.

ALL SEALANT AROUND WINDOWS SHALL BE NON-HARDENING TYPE

EXTEND BITUMINUS WATERPROOF UNDERLAYMENT FROM EAVE UP ROOF TO MINIMUM 6-0", 3"-0" AT ALL RAKES, HIPS, VALLEYS, AND WALL/ROOF

KITCHEN AND BATHROOM LAYOUTS - SHOP DRAWINGS BY KITCHEN SUPPLIER.

GC/DEVELOPER TO COORDINATE TRUSS LAYOUT INFO WITH MANUFACTURER

UNDERLAYMENT AND SUBFLOORING SHALL BE 3/4" PLYWOOD TONGUE AND GROOVE - GLUED AND SCREWED TO SUPPORTING MEMBERS PER MANUFACTURERS REQUIREMENTS

# STARBIRD CONDOMINIUMS BROWN DEVELOPMENT CORPORATON





ISSUED FOR OWNER REVIEW 02/05/02


# PORTLAND, MAINE



DRAWING LEGEND	PROJECT DIRECTORY	DRAWING INDEX	DRAWING ABBREVIATIONS
ROOM NUMBER DOOR NUMBER WINDOW TYPE BUILDING SECTION BUILDING SECTION CASEWORK ELEVATION CASEWORK ELEVATION INTERIOR ELEVATION VERTICAL ELEVATION PARTITION TYPE COLUMN CENTER LINE CONCRETE SOIL STEEL VOOD FRAMING VOOD BLOCKING PLYWOOD TO GYPSUM BOARD SAT WAYN BATT INSULATION RIGID INSULATION RIGID INSULATION FINISH WOOD ONE HOUR RATED PTN. CHOWN MOULDING CHAIR RAIL CHAIR	ARCHITECT:  29 BLACK POINT BOAD RELABORAUGH, MERGET4-STOR RELABORAUGH, MERGET4-STOR RELABORAUGH, MERGET4-STOR RECHANICAL ENGINEER: DESIGN / BUILD PILIMBING ENGINEER: DESIGN / BUILD PIRE SUPRESSION: DESIGN / BUILD  PROJECT LOCATION	CIVIL DRAWINGS  ISSUED SEPARATELY  ARCHITECTURAL DRAWINGS  G-101 TITLE SHEET, DRAWING INDEX & GENERAL NOTES G-102 CODE REVIEW PLANS A-100 FERST FLOOR PLAN A-101 SECOND FLOOR PLAN A-200 EXTERIOR ELEVATIONS A-201 EXTERIOR ELEVATIONS A-301 BUILDING SECTIONS A-301 BUILDING SECTIONS A-301 DOOR & WINDOW SCHEDULE & DETAILS  STRUCTURAL DRAWINGS  S-101 FOUNDATION PLAN S-102 SECOND PLOOR FRAMING PLAN S-103 ROOF FRAMING PLAN MECHANICAL DRAWINGS  DESIGN BUILD - CONTRACTOR TO COORDINATE WORK WITH ALL TRADES ELECTRICAL DRAWINGS  DESIGN BUILD - CONTRACTOR TO COORDINATE WORK WITH TRADES PLUMBING DRAWINGS  DESIGN BUILD - CONTRACTOR TO COORDINATE WORK WITH ALL TRADES FIRE PROTECTION DRAWINGS  DESIGN BUILD - CONTRACTOR TO COORDINATE WORK WITH ALL TRADES FIRE PROTECTION DRAWINGS	AB ANCIDE BOLT AND ANCIDE STATE AND ANCIDE STATE AND ANCIDES STATE AND ANCIDES CALL STATE A

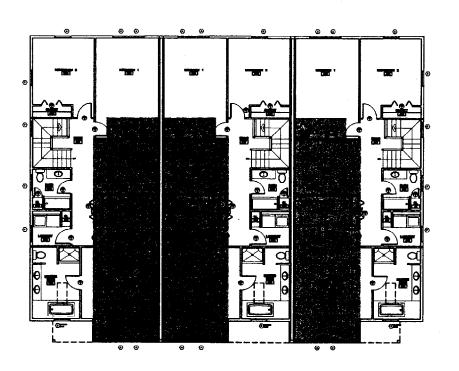

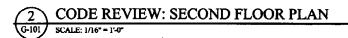

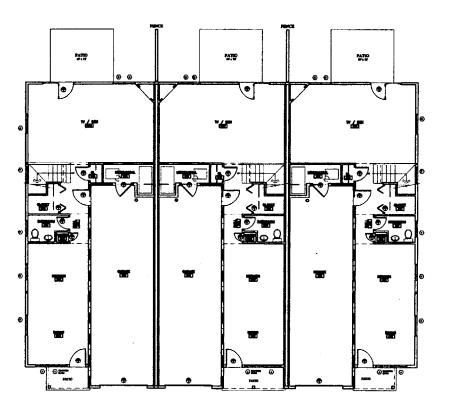

BOCA: CODE DAT	Ά.
USE GROUP CLASSIFICATION	R-2 RESIDENTIAL
TYPE OF CONSTRUCTION	5B - UNPROTECTED
ACTUAL BUILDING AREA	6870 SQ. F.T
TABLE 503 BUILDING AREA LIMITATION - SQ. FT.	4,170
506.2 STREET FRONTAGE INCREASE (150%) - SQ. FT.	7.200
506.3 AUTOMATIC SPRINKLER SYSTEM (LIKERASE 200%) - SQ. PT.	9,600
ALLOWABLE DUILDING AREA - SO, FT.	16,800
BUILDING HEIGHT	30'-0"
FIRE SUPPRESSION:	TOTAL BUILDING AUTOMATIC
	WATER SPRINKLER SYSTEM
FIRE WALLS AND PARTY WALLS	1 HOUR
STAIR ENCLOSURES	NONE USED
SHAFTS	NONE USED
EXIST ACCESS CORREDORS	0 HOURS - FIRE SUPPRESSION
INTERIOR LOAD BEARING WALLS	0 HOURS - FIRE SUPPRESSION
STRUCTURAL MEMBER SUPPORTING WALL	0 HOURS - FIRE SUPPRESSION
PLOOR CONSTRUCTION	0 HOURS - FIRE SUPPRESSION
ROOF CONSTRUCTION	0 HOURS - FIRE SUPPRESSION
FIRE EXTINGUISHERS	LOCATIONS TO BE FIELD VERIFIED
	BY FIRE CHIEF PRIOR TO LOCATION
FLAME SPREAD RATINGS.	
INTERIOR FINISH REQUIREMENTS	
REQUIRED VERTICAL EXISTS	1
CORRIDORS PROVIDING EXIT ACCESS	u
ROOMS OR ENCLOSED SPACES	lan
INTERIOR FLOOR FINISH REQUIREMENTS	
REQUIRED VERTICAL EXISTS	_li
CORRIDORS PROVIDING EXIT ACCESS	Tu .
ROOMS OR ENCLOSED SPACES	DOC FF-I
GENERAL NOTES	1. ALL PENETRATIONS OF FIRE
	RATED WALLS AND FLOORS SHALL
	BE SEALED WITH PROPER
	APPROVED MATERIALS
	2 ALL WORK SHALL CONFORM TO
	LOCAL AND STATE CODES.
	ORDINANCES, AND REQUIREMENTS.
	ACCESSIBILITY PER A.D.A.A.G.

2000 NFPA: CODE DA	TA
FIRST FLOOR AREA ( PER UNIT 900 SQ. F.T - 3 UNITS) (GARAGE 310	
SQ FT PER UNIT)	4170 SQ. FT.
SECOND FLOOR AREA (PER UNIT 1390 SQ. FT - 3 UNITS.)	4170 SQ. FT.
BUILDING TOTAL AREA	8340 SQ. FT.
OCCUPANT LOAD (1 PERSON 200 SQ. FT.)	42
USE GROUP CLASSIFICATION	APARTMENT / CONDOMINIUM
TYPE OF CONSTRUCTION	V (000)
ACTUAL BUILDING AREA	6870 SQ. FT
BUILDING HEIGHT	30-0
FIRE SUPPRESSION:	TOTAL BUILDING AUTOMATIC
	WATER SPRINKLER SYSTEM
FIRE WALLS AND PARTY WALLS	I HOUR
STAIR ENCLOSURES	NONE USED
SHAFTS	NONE USED
EXIST ACCESS CORRIDORS	0 HOURS - FIRE SUPPRESSION
INTERIOR LOAD BEARING WALLS	0 HOURS - FIRE SUPPRESSION
STRUCTURAL MEMBER SUPPORTING WALL	0 HOURS - FIRE SUPPRESSION
FLOOR CONSTRUCTION	U HOURS - FIRE SUPPRESSION
ROOF CONSTRUCTION	O HOURS - FIRE SUPPRESSION
FIRE EXTINGUISHERS	LOCATIONS TO BE FELLD VERUFIED
	BY FIRE CHIEF PRIOR TO LOCATION
FLAME SPREAD RATINGS:	<del> </del>
INTERIOR FINISH REQUIREMENTS	<del></del>
REQUIRED VERTICAL EXISTS	CLASS A OR CLASS B
CORRIDORS PROVIDING EXIT ACCESS	CLASS A OR CLASS B
ROOMS OR ENCLOSED SPACES	CLASS A OR CLASS B
INTERIOR FLOOR FINISH REQUIREMENTS	CEPAGE A OR CEPAGE D
REQUIRED VERTICAL EXISTS	CLASS A OR CLASS B
CORRIDORS PROVIDING EXIT ACCESS	CLASS A OR CLASS B
NOOMS OR ENCLOSED SPACES	CLASS A OR CLASS B
	CLIPAD A GREENING
GENERAL NOTES	1. ALL PENETRATIONS OF FIRE
	RATED WALLS AND FLOORS SHALL
	BE SEALED WITH PROPER
	APPROVED MATERIALS
	2. ALL WORK SHALL CONFORM TO
	LOCAL AND STATE CODES.
	ORDINANCES, AND REQUIREMENTS
	ACCESSIBILITY PER A.D.A.A.G.
	l

## CODE DATA LEGEND

I HOUR FIRE CEILING ABOVE GARAGE & MECHANICAL ROOM





GAWRON
ARCHITECTS
29 Black Point Road
Scarborough, ME 04074
www.gawron.com

Tel. 207 . 883 . 6307 Fax. 207 . 883 . 0361

STARBIRD ROAD CONDOMINIUMS
BROWN DEVELOPMENT CORPORATION
PORTLAND, MAINE


I			<del>-</del>
1		RE	VISIONS
ı	•	DATE	PERCHETION
			ISSUED FOR CONSTRUCTION #2/85/02


DATE:	<b>62/85/0</b> 2
PROJECT #	631169
DRAWN BY:	DMCR
CHECKED BY:	\$G
DRAWING SCALE	AS NOTED

SHEET TITLE CODE REVIEW PALNS

G-102

© COPYRIGHT 1985-2001 REPRODUCTION OF PROPER OF THE PROPERTY SERVICE OF WATER PROPERTY OF PROPERTY OF

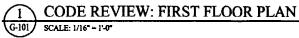


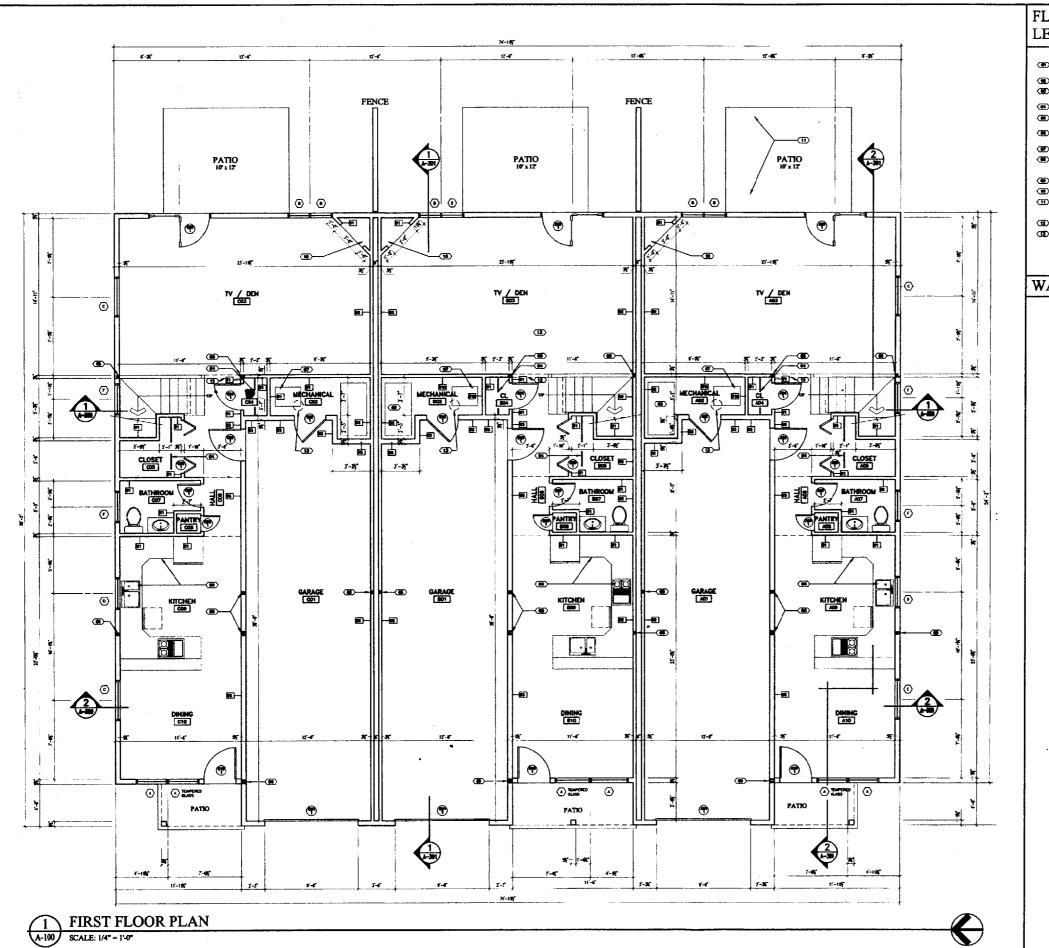



# FLOOR PLAN LEGEND

- MOT USED
- STEEL FUEL OIL TANK FILL PIPE IN WALL BETWEEN UNITS PAINTED
- 3" PLYWOOD PAINTED SHELVES w/ 1 %" WOOD NOSING o/ 4 ADJUSTABLE SHELF SUPPORTS (3) SHELVES PER CLOSET
- CLOTHES ROD AND SHELF
- WOOD POST PROVIDE SOLID CONTINUOUS BEARING DOWN THROUGH TO TOP OF FOUNDATION REFER TO STRUCTURAL DRAWINGS
- (III) KITCHEN CABINETS LAYOUT BY KITCHEN CABINET SUPPLIER CONTRACTOR SHALL INSTALL AND COORDINATE WITH ALL TRADES AND SERVICES
- BOILER FUEL OIL FIRED
- (M) ALL BATHROOM CABINETRY AND LAYOUT BY CABINET SUPPLIER CONTRACTOR SHALL INSTALL AND COORDINATE WITH ALL TRADES AND
  SERVICE.
- (III) ROOF WINDOW (ABOVE)
- PRE-FABRICATED GAS FIREPLACE DETAILS PER SHOP DRAWINGS
- THE PATTO C.M.U. PATTO BRICK & 4" COMPACTED SAND & 1" COMPACTED GRANULAR FILL & UNDSTURBED EARTHOR ENGINEERED FILL & STELL EDGIS SLOPE AWAY PROM BUILDING 11" PER POOL
- SOFFIT 6" DEEP GWB o/ 3 1/2" WOOD FRAMING ACROSS STAIR & TV/DEN
- (E) STEEL FLUE SYSTEM COORDINATE SIZE, LOCATION, AND CLEARANCES AS REQUIRED BY CODE WITH ALL TRADES

# WALL TYPES & CEILING ASSEMBLIES

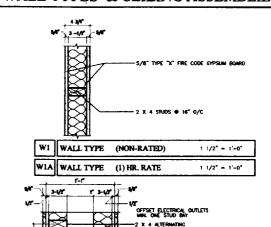

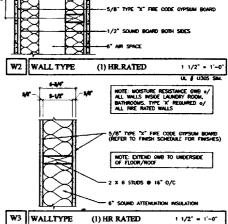

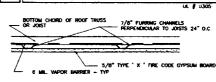

C1 ROOF / CEILING ASSEMBLY 1 1/2" = 1'-0"

(1) HOUR RATED 10" FEMELAS BUT BOOL 17" FREMANS BUT BOOL 10" FREMANS FREMA

C3 ROOF / CEILING ASSEMBLY 1/2" = 1'-0"

(1) HOUR RATED 8" FRENCIASS BUT HISIL.

(1) HOUR RATED






# STARBIRD ROAD CONDOMINIUMS BROWN DEVELOPMENT CORPORATION PORTLAND, MAINE

		ED POR STRUCTION 502
TE		82/05/02
DARCT #		631161
AWN BY:		DMR
BCXED BY:		<b>9</b> 6

SHEET TITLE

FIRST FLOOR
PLAN




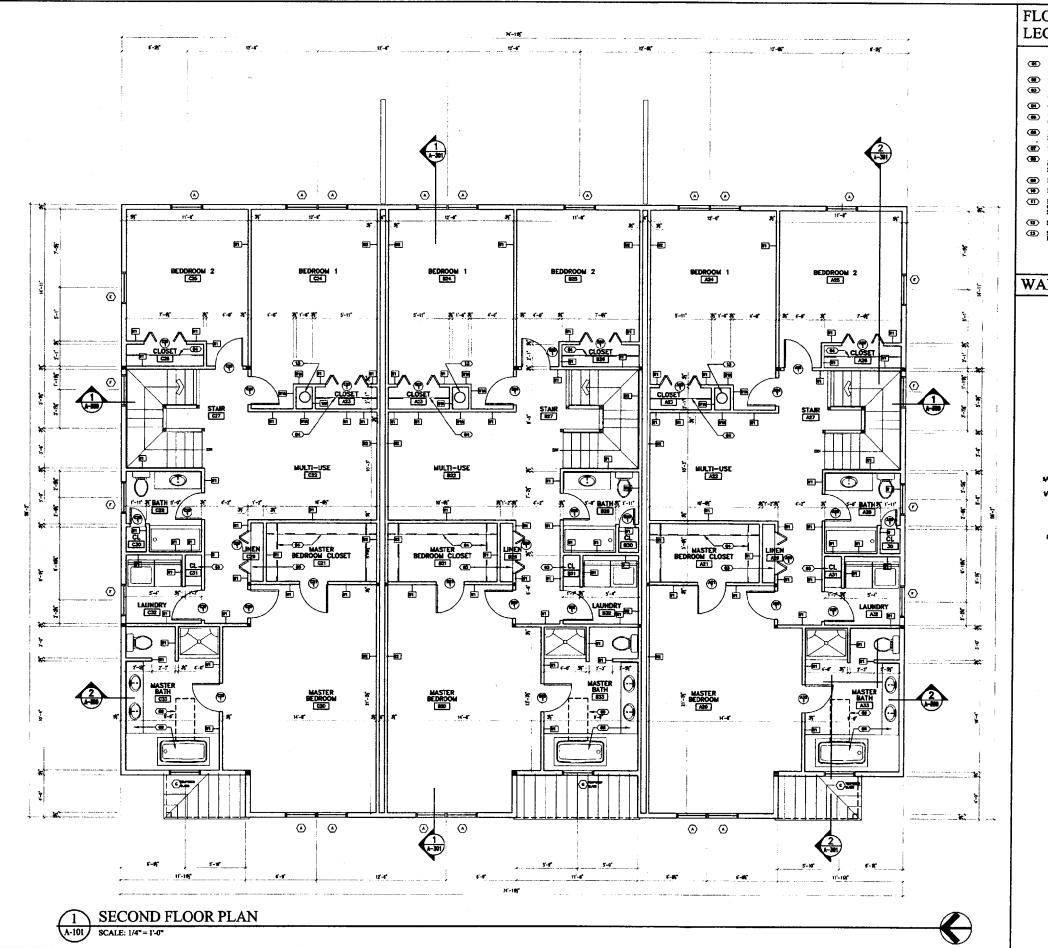


# FLOOR PLAN **LEGEND**

- STEEL FUEL OIL TANK FILL PIPE IN WALL BETWEEN UNITS PAINTED
- (8) %" PLYWOOD PAINTED SHELVES w/ 1 %" WOOD NOSING o/ 4 ADJUSTABLE SHELF SUPPORTS (5) SHELVES PER CLOSET
- CLOTHES ROD AND SHELF
- WOOD POST PROVIDE SOLID CONTINUOUS BEARING DOWN THROUGH TO TOP OF FOUNDATION REFER TO STRUCTURAL DRAWINGS
- (III) KITCHEN CABINETS LAYOUT BY KITCHEN CABINET SUPPLIER CONTRACTOR SHALL INSTALL AND COORDINATE WITH ALL TRADES AND SERVICES
- BOILER FUEL OIL PIRED
- ALL BATHROOM CABINETRY AND LAYOUT BY CABINET SUPPLIER -CONTRACTOR SHALL INSTALL AND COORDINATE WITH ALL TRADES AND SERVICE
- (III) ROOF WINDOW (ABOVE)
- PRE-FABRICATED GAS FIREPLACE DETAILS PER SHOP DRAWINGS
- 50FFTT 6" DEEP GWB o/ 3 L/2" WOOD FRAMING ACROSS STAIR & TV / DEN
- (IS) STEEL FLUE SYSTEM COORDINATE SIZE, LOCATION, AND CLEARANCES AS REQUIRED BY CODE WITH ALL TRADES

# WALL TYPES & CEILING ASSEMBLIES

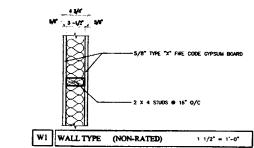


WI	WALL TYPE	(NON-RATED)	1 1/2" = 1'-0"
WIA	WALL TYPE	(1) HR. RATE	1 1/2" = 1'-0"
w-it	r-r		

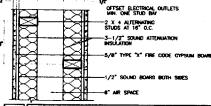

W2 WALL TYPE (1) HR.RATED 1 1/2" = 1'-0"

W3 WALLTYPE (1) HR RATED

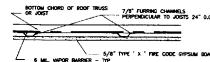

C1 ROOF/CEILING ASSEMBLY 1 1/2" = 1'-0" (1) HOUR RATED 10" FREIRINGS BATT INSUL 12" FREIRINGS BATT INSUL 12" FREIRINGS BATT INSUL 12" FREIRINGS FRANKS FRA

C2 ROOF / CEILING ASSEMBLY 1 1/2" - 1'-0" (1) HOUR RATED # FRENCIASS BUT INSUL. 6 ML VS. TOP SIDE & CRACE

C3 ROOF/CEILING ASSEMBLY 1 1/2" = 1"-0" (1) HOUR RATED





GAWRON ARCHITECTS 29 Black Point Road Scarborough, ME 04074 www.gawron.com

Tel. 207 . 883 . 6307 Fax. 207 . 883 . 0361

CORPORATION M AINE CONDOMINIUMS BROWN DEVELOPMENT PORTLAND, ROAD STARBIRD


	REVISIONS					
۰	DATE	DESCRIPTION				
		ISSUED FOR CONSTRUCTI 02/85/02 92/25/02				
- 1						

ATE:	80,705/02
OUNCT#	<b>6</b> 31101
RAWN BY:	DMR
BOCKED BY:	SG
RAWING SCALE	AS NOTED


SHEET TITLE


SECOND FLOOR



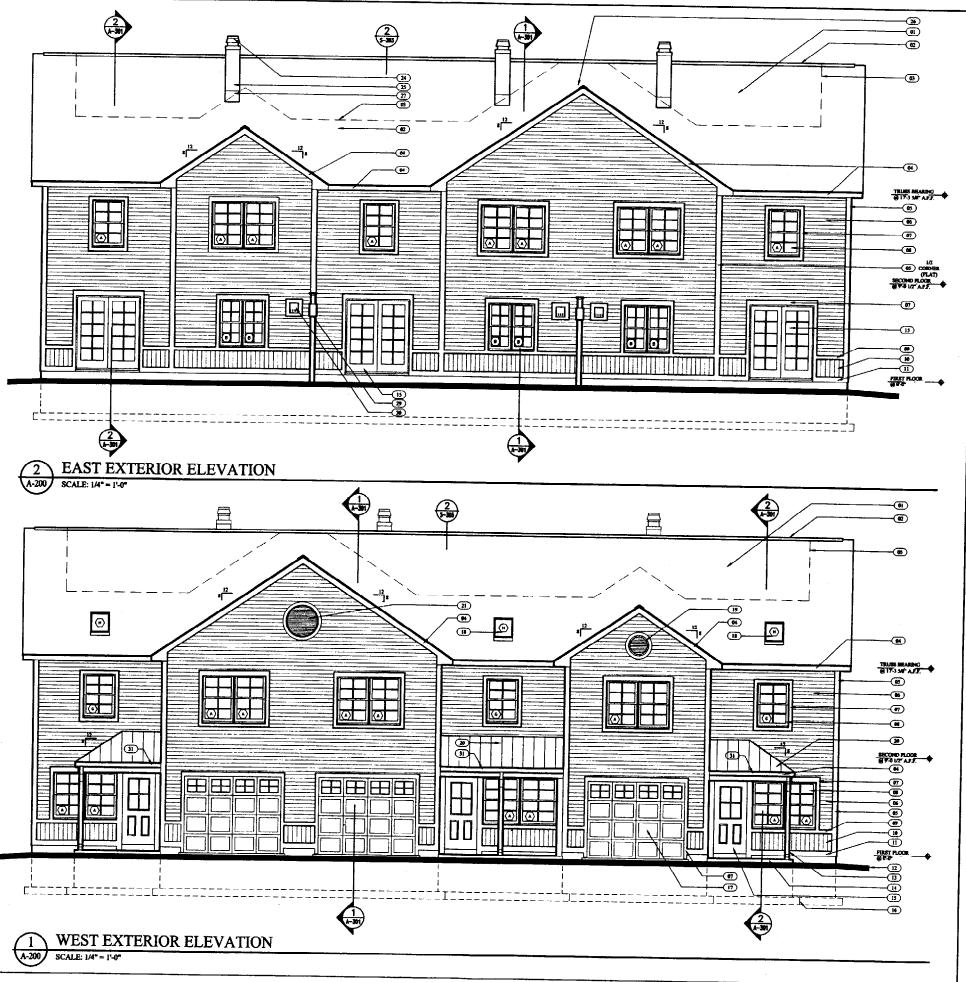

# **ELEVATION LEGEND**

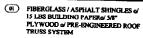

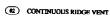

03 BITUMINUS ROOF UNDERLAYMENT

(#) 8" FASCIA - PRE-FINISHED ALUMINUM COIL STOCK of WOOD TRIM

CORNER BOARD - VINYL w/ RIGID BACK-LIP

WINYL SIDING - 4" EXPOSURE

TRIM - PRE-PINISHED ALUMINUM COIL STOCK of WOOD TRIM

VINYL CLAD WINDOW SYSTEM REFER TO WINDOW TYPES

99 VINYL WAIST TRIM BOARD

VINYL SIDING - VERTICALLY ATTACHED

11 WATER TABLE

12 FINISH GRADE

(13) COLUMN - CLAD IN COIL STOCK

PATIO - CONRETE BRICK of 2"
COMPACTED SAND of 8" COMPAGRANULAR FILL

DOOR - REFER TO DOOR SCHEDULE

FOOTENG

VINYL CLAD ROOF WINDOW SYSTEM - REFER TO WINDOW SCHEDULE

19 FYPON I - AFFLIED FAUX VENT

METAL ROOFING & BITUMENOUS ROOF UNDERLAYMENT & SME PLYWOOD

22 POUNDATION WALL - PARGED

23 PRE-FINISHED ALUMINUM CAP-COLOR TO MATCH TRIM

25 METAL CHIMNEY SYSTEM

26 NOTE USED

30 FIREPLACE VENT' - LOCATION AND FLASHING PER MANUFACTURERS REQUIREMENTS

PRE-PINISHED ALUMINUM GUTTER
DOWNSPOUTS

32 BITUMINUS ROOFING
UNDERLAYMENT - WRAP AROUND
ALL SIDES OF OPENING TO \$\*
(TYPICAL FOR ALL OPENINGS)





**GAWRON ARCHITECT** 29 Black Point Road Scarborough, ME 040 www.gawron.com

Tel. 207 . 883 . 6307 Fax. 207 . 883 . 0361

STARBIRD ROAD CONDOMINIUMS
BROWN DEVELOPMENT CORPORATION
PORTLAND, MAINE

17 STEEL OVERHEAD DOOR -INSULATED W/REMOTE CONTROLLED AUTOMATIC O

21 FYPON 2 - APPLIED FAUX VENT

24 CHIMNEY CAP

77 CHIMNEY PLASHING - LEAD COATED COPPER

DOGS EAR - COIL STOCK of WOOD -COLOR TO MATCH TRIM

PRIVACY SCREEN - REFER TO 2/A-301


DATE:	02/05/02	]
ROJECT #	031 101	1
	+	

REVISIONS

SG DRAWING SCALE AS NOTED SHEET TITLE

CHECKED BY:

EXTERIOR ELEVATIONS

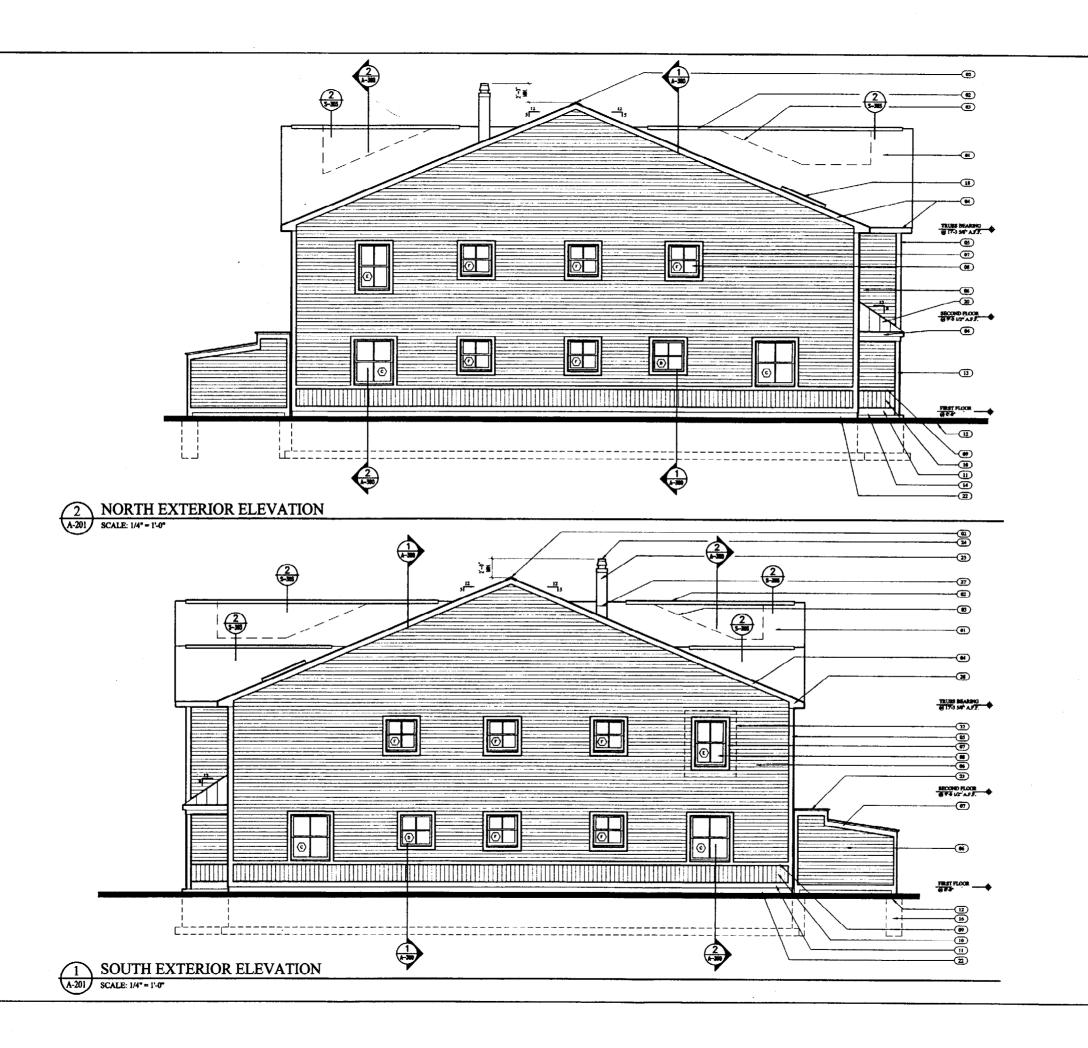

# ELEVATION LEGEND

- (4) FIBERGLASS / ASPHALT SHINGLES of 15 LBS BUILDING PAPER of 5/8" PLYWOOD of PRE-ENGINEERED ROOF TRUSS SYSTEM
- @ CONTINUOUS RIDGE VENT
- BITUMENUS ROOF UNDERLAYMENT
- 8" FASCIA PRE-FINISHED
   ALLIMINUM COIL STOCK o/ WOOD
  TRIM
- 05 CORNER BOARD VINYL w/ RKIED BACK-UP
- WINYL SIDING 4" EXPOSURE
- 67 TRIM PRE-PINISHED ALUMINUM COIL STOCK of WOOD TRIM
- WINYL CLAD WINDOW SYSTEM REFER TO WINDOW TYPES
- VINYL WAIST TRIM BOARD
- 10 VINYL SIDING VERTICALLY ATTACHED
- (I) WATER TABLE
- 12 FINISH GRADE
- (1) COLUMN CLAD IN COIL STOCK
- PATIO CONRETE BRICK o/ 2"
  COMPACTED SAND o/ 8" COMPACTED
  GRANULAR PILL
- DOOR REPER TO DOOR SCHEDULE
- 16 FOOTING
- 17) STEEL OVERHEAD DOOR INSULATED W/REMOTE
  CONTROLLED AUTOMATIC OPENER
- VINYL CLAD ROOF WINDOW SYSTEM REPER TO WINDOW SCHEDULE
- FYPON 1 APPLIED FAUX VIENT
- METAL ROOPING of BITUMINOUS ROOF UNDERLAYMENT of 5/8" PLYWOOD
- 21 FYPON 2 APPLIED FAUX VENT
- 2 FOUNDATION WALL PARGED
- 23 PRE-FINISHED ALLMINUM CAP-COLOR TO MATCH TRUM
- 24 CHEMONEY CAP
- 25 METAL CHIMNEY SYSTEM
- NOTE USED
- CHIMNEY FLASHING LEAD CO COPPER
- DOGS EAR COEL STOCK of WOOD-COLOR TO MATCH TRIM
- 29 PRIVACY SCREEN REFER TO 2/A-301
- (30) FIREPLACE VENT LOCATION AND FLASHING PER MANUFACTURERS REQUIREMENTS
- 91 PRE-FINISHED ALUMINUM GUTTER & DOWNSPOUTS
- 22 BITUMINUS ROOFING
  UNDERLAYMENT WRAP AROUND
  ALL SIDES OF OPENING TO 8\*
  (TYPICAL FOR ALL OPENINGS)





ARCHITECT
29 Black Point Road
Scarborough, ME 04074
www.gawron.com

Tel. 207 , 883 , 6307 Fax. 207 , 883 , 0361

STARBIRD ROAD CONDOMINIUMS
BROWN DEVELOPMENT CORPORATION
PORTLAND, MAINE


REVISIONS
DATE DESCRIPTION
DES

ATE:	62/05/02
ROJECT #	631161
RAWN BY:	DNR
HIBOKED BY:	\$G
RAWING SCALE	AS NOTED

SHEET TITLE

EXTERIOR ELEVATIONS



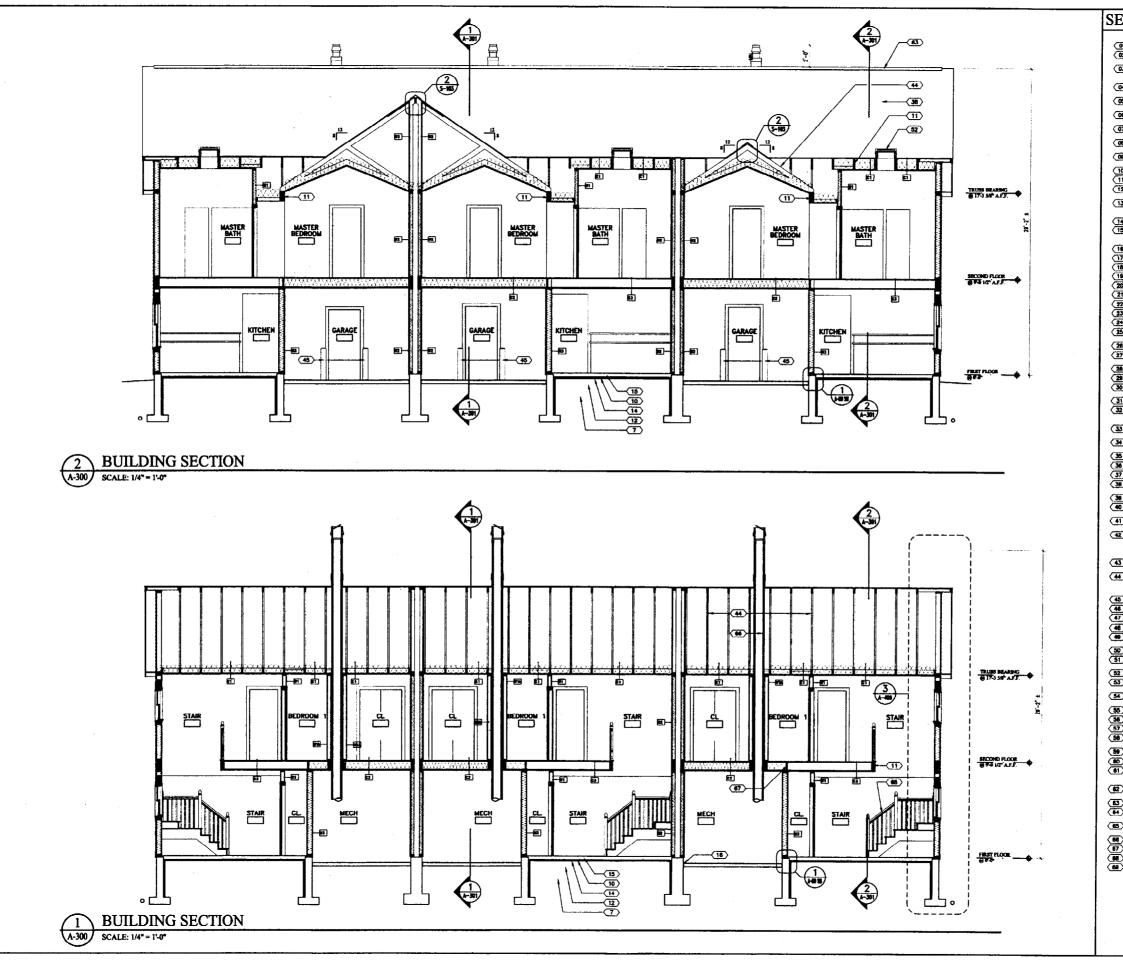

# SECTION LEGEND

- 01 POUTING POURED-IN-PLACE CONC 02 STEEL REINFURCING BARS (3) #5 BOREZONTAL
- GBOTECHRICAL FABRIC WASF-EXIST @
- 04 POUR JOINT ROUGHEN CONCRETE
- 05 STREEL REINFORCING BARS (2) AN TOP & BOTTOM HORIZONTAL
- 06 STEEL REDPORCING BARS-(I) M VERTICAL W 6" BOOK 16" a.c.
- 07 SINGENEERED BACKFILL COMPACTED TO 98
  % REFER TO GROTHS SINGEL REPORT
- 08 STEEL REINFORCING BARS-(1) # MED HERGET WALL HORIZONTAL
- 600 6" LOAM TOPSOR FILL @ ALL AREAS BACKFILLED OR DESTURBED BY GRADES
- 10 2" RIGID INSULATION
  11 REPER TO STRUCTURAL DRAWINGS
- 12 COMPACTED ACCREGATE FELL-REFER TO CROTECHINGAL REPORT
- 13 X\* FLYWOOD SIB-FLOOR GLIE & SCREW TO JOINT FER MANUFACTURES
- 14 6 MEL VAFOR RETARDER
  15 4" THE POURED-IN-PLACE CONCRETE
  PLOOR ELAB VIA 1 A 4" A" W.W.F. OR
  FEDERALESE
- (16) W EXPANSION N 17 WOOD BASE
  18 SETTYPE TO GWB
- 20 C STRENGT AND BATT DIST
- (21) 256 W000 STUDE @ H\* ac
- 23 SIT PLYWOOD MEATERN
- 25 VINYL SIDING WART BOA
- 28 VINYL SIDING 5" KB VINTICAL
- BOOK ANCHORS M\* LONG @ 8\*4\* o.e. w/(2)
- 28 TREATED WOOD FLATE
  30 WATER TABLE COIL STC
  COLOR TO MATCH TRIM
- 31 DOUBLE TOP PLATE
  32 K' 1 1 K' WOOD FIRRING @ 24" ALTYPFOLD (I WINDSPRINC OF ALL DOOF
  TELEBRES, CERLING DAPTERS & ACRESTS

- 33 YINYL VENTED SOPPIT SYS 34 COH. 970CX of WOOD - COLO

- 37 VENT BAFFLE
  38 FREEGLASS/ASPHALT:
  ARCHITECTURAL: TAB

- THEO DOWNS HER PASS AND STATE OF THE PASS AN

- 45 STORE BALLARD REPERT
  46 WOOD TREM
  47 WOOD WINDOW STOOL
- VDITTL CLAD WOOD WINDOW!
- 50 GALV. TIB-DOWN (1) FER FUET

  51 COUNTER FLABRING AS BOX. ROOF WINDOW SUFFLER.
- 53 WINDOW TRIM COIL STOCK & WOOD -
- 54 SEALANT & BACKER BOD AS PERSMETER
- 55) 2"se" WOOD RAFTERS @ 16" 44.
- 56 GALV. WOOD POST BASE PLATE ANCHOR TO CONCRETE # 4° D EXPANSION BOLT
- (82) X" POURED-IN-FLACE C

- BS NOT URED

  57 CONTINUOUS WOOD PIRE BLOCKING

  68 STAIR DESIGN PEX SEOP DRAVENCE

  69 CHIDDREY CAP





GAWRON ARCHITECTS 29 Black Point Road Scarborough, ME 04074


www.gawron.com Tel. 207 . 883 . 6307 Fax. 207 . 883 . 0361


STARBIRD ROAD CONDOMINIUMS
BROWN DEVELOPMENT CORPORATION
PORTLAND, MAINE

Ĺ		•
Ī	RE	VISIONS
ł	DATE	DECEMBER 1
		ISSUED FOR CONSTRUCTION 92/45/42 42/26/42
İ		

DATE:	62/05/02	
PROJECT #	631101	
DRAWN BY:	DMR	
CHECKED BY:	SG	
DRAWING SCALE	AS NOTED	

SHEET TITLE BUILDING SECTIONS

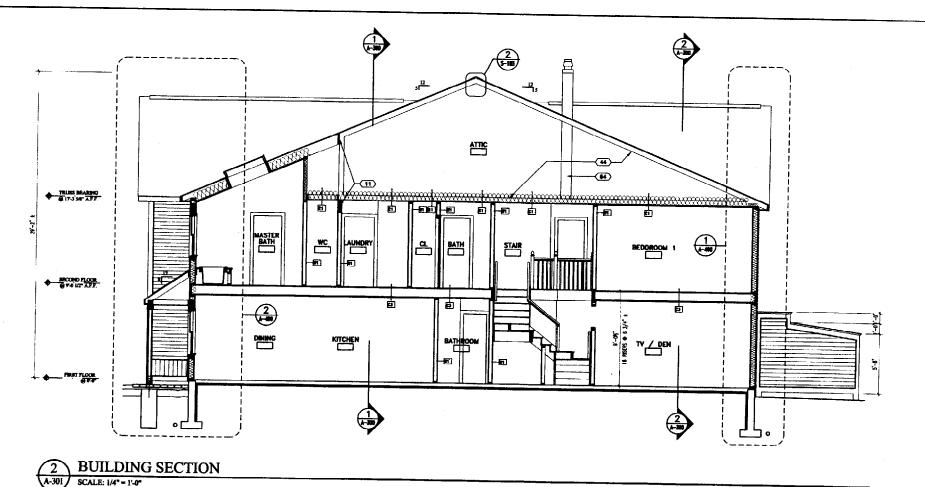

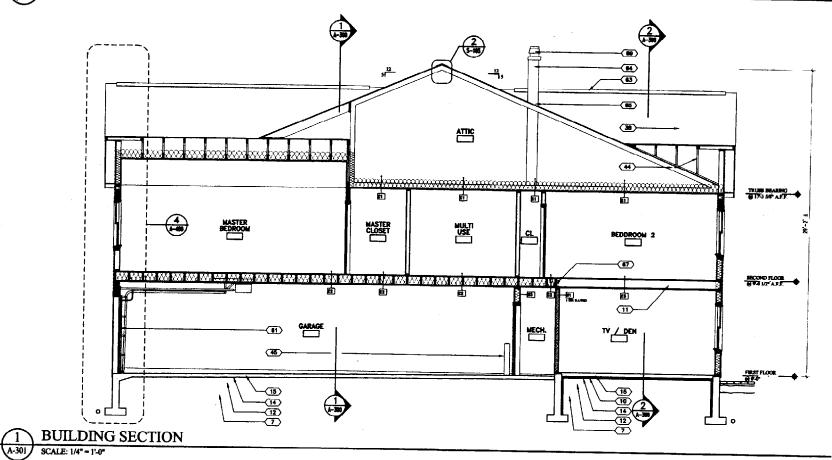

# SECTION LEGEND

- 01 POOTING NOURED-IN-PLACE CONCRETE
  02 STEEL RESPONDENCING BARS (1) #5
  HORIZONIAL
- 03 4" DRAIN TILE IN WASSED AGGREGATE W GROTECHINGAL PARKE WRAP EXIST @ GRADE
- 04 POUR JOINT ROUGHEN CONCILETE
- 05 STEEL REINFURCING BARS (2) 64 TOP & BOTTOM HORIZONTAL
- 06 STEEL REDURCING BARS-(1) 64 VERTICAL W 6" HOOK 16" a.c.
- 07 ENGINEERED BACKFILL COMPACTED TO 9
  % REFER TO GROTECHRICAL REPORT
- OS STEEL REINFORCING BARS (1) 84 MED HERCHT WALL HORIZONTAL
- 00 F LOAM TOPSOIL FELL @ ALL AREAS BACKFELLED OR DISTURBED BY CRADENC
- 10 2" RIGHD INSULATION
  11 REPER TO STRUCTURAL DRAWINGS
- 12 COMPACTED AGGREGATE FILL REFER TO GROTECHNICAL REPORT
- 13 %\* PLYWOOD SIN-FLOOR GLUR & SCREW TO JOIST FER MANUFACTURES REQUIREMENTS
- 14 6 MILL VAFOR RETARDER

  15 4" THE POWERD IN FLACE CONCRETE
  PLOCE SLAS = 1.4 × 1.4 € 56" W.W.F. OR
  PROPRIESE.
- 16 W EXPANSION MA

- 19 VAFOR RETARDER
  20 6" PIBERGLASS BATT INSULATION
  21 2"56" WOOD STUDIS @ 16" e.g.
- 22 15 LRS BURLDING PAPER
  23 SPF PLYWOOD SHEATHING
- 24 VINYL SIDING F EXPOSURE
  25 VINYL SIDING WART BOARD
  NATCH TRIM
- 28 VINYL SEDING FRIB VERTICAL
  27 BOOK ANGEORS 16" LONG @ 5-6" e.c. w'(2)
  MIN. FER WALL
- 28 VHYL TRIM / TERMINATION STEP
  28 TREATED WOOD HATE
  30 WATER TABLE CORL STOCK # WOOD-COLOR TO MARCH TIEM
- 31 DOUBLE TOP PLATE

  32 X° 3 L N° WOOD PURRING @ 30° a.c.
  TYPICAL @ URITERING OF ALL ROOF
  TRUBBES, CRILING RAFTERS 2 200673
- 33 VENTL VENTED SOFFET SYSTEM COLOR TO MATCH TREM
- COIL STOCK & WOOD COLOR TO MATCH
- THEM

  35 WOOD BLOCKING

  36 SAT PLYWOOD BOOF SHEATHENG

  37 VENT BAPTLE

  38 PRESIDE AST ASTRALT SHENCE ARCHITECTURALS TAB

- 30 M\* PRINTIGLAM BATT INSULATION
  40 POLINDATION WALL PARCE W
  TROBOBEAL
- 41 RM JOST PER MANUFACTE

- 43 THE DOWNS HER FILE-ENC SUPPLEMS AUGUSTIMENT
- 45 STEEL BALLARD REPER TO PE 46 WOOD TRIM 47 WOOD WINDOW STOOL
- 48 REALANT & PERMITTER

  48 VINTL CLAD WOOD WHEN
  COLOR TO MATCH TRIM
- SO GALV. TIS-DOWN (I) FIRE JOINT

  S1 COUNTER FLASHING AS INQUI
- 52 VENYL CLAD BOOF WENDOW SYSTEM

  53 WENDOW TRIM COR. STOCK & WOODCOLOR TO MATCH TRIM
- 54 SALANT & BACKER ROD AS 55 PAR WOOD RAPTERS @ NO W.C.
  56 METAL STARDING SEAM ROOFING
- 55 METAL STANDING SEAM WAS NOT STANDING TO CONCRETE WE DECAMERATE ANCHOR TO CONCRETE WE DECAMERATE SOLT
- 60 2"14" PLYING RAFTISKS @ 24" a.c.
  61 PRE-FINISHED INSULATED OVERHIND
  DOOR =/ AUTOMATIC REMOTE
  CONTROLLED OPENER.
- 62 Nº POURED-IN-PLACE CONCR
- 65 CHERONEY FLASHING LEAD COATED COPPER





GAWRON ARCHITECTS 29 Black Point Road Scarborough, ME 04074 www.gawron.com


Tel. 207 . 883 . 6307 Fax. 207 . 883 . 0361

STARBIRD ROAD CONDOMINIUMS
BROWN DEVELOPMENT CORPORATION
PORTLAND, MAINE

-	DE	VISIONS
4	BATE	PERCHAPTION
		ISSUED FOR CONSTRUCTION 02/05/02 62/20/02

DATE:	02/05/02
PROJECT #	<b>631101</b>
TRAWN BY:	DMER
MIRCKED BY:	<b>s</b> G
DRAWING SCALE	AS NOTED

SHEET TITLE BUILDING SECTIONS

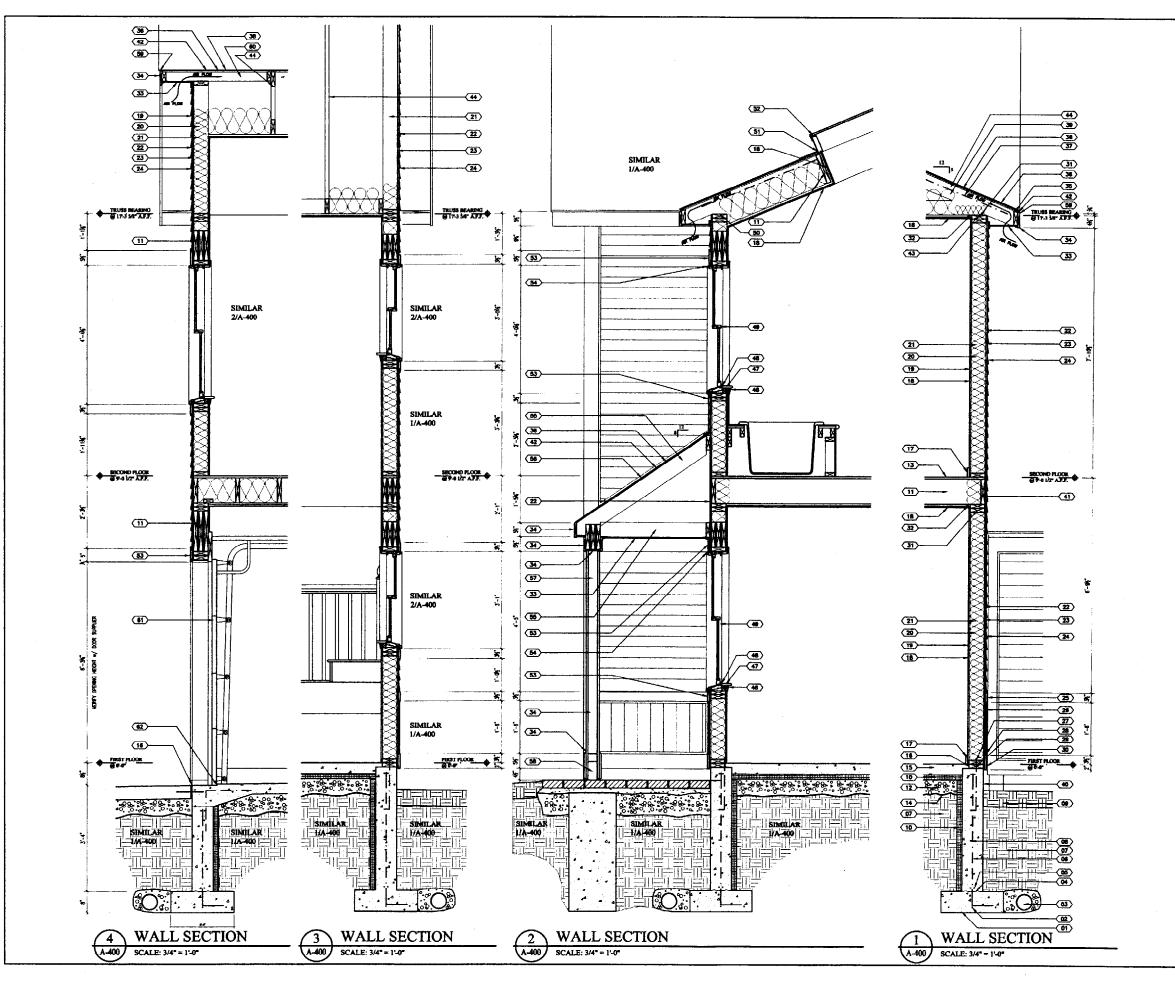

# SECTION LEGEND

- D1 POOTING NOURED-IN-PLACE.COM

  O2 STEEL BEINFORCING BARS (3) #5
  HORIZONTAL
- 4° DRAIN TILE IN WASSED AGGREGATE &
  GRADE
  GRADE
- 04 POUR JOINT ROUGHEN CONCRETE
- 05 STEEL REINFORCING BARS-(2) M TOF & BOTTOM BORIZONTAL
- (1) M VERTICAL WP HOOK 16" 44. 67 ENGINEERED BACKFILL COMPACTED TO 9
  % - REPER TO GROTECHNICAL REPORT
- 08 STEEL REPRODUCTING BARS (1) 64 MED HEIGHT WALL HURIZONTAL
- 00 6" LOAM TOPSOIL FILL @ ALL AREAS BACKFILLED ON DISTURBED BY GRADING
- 10 2" RIGID INSULATION
- (12) COMPACTED AGGREGATE FILL REFER TO
- 13 Xº PLYWOOD BUS-PLOOR GLUE & SCHEW TO JOST HER NANWACTURES
- 14 6 MEL VAPOR RETARDER

  15 4" THE NORSED-SH-FLACE CONCRETE FLOOR SLAD W 1.4 x 1.4 ft w w w.w.r. OR FRESCHEIN
- 16 % EXPANSION MA
  . 17 WOOD BASK
  . 18 SA\* TYPE 3' OWB
- 19 VAPOR RETARDER

  20 6º PRESIONASE SATT INSTRACTS
- 21 2"54" WOOD STUDS @ 16" 7"s#" WOOD STUDS @ 16" ec.
- 23 SET PLYWOOD SHEATHE
- VINYL BIDING F EXPOSURE

  VINYL SIDING WAST BOARD COLOR TO
  MATCH TRIM
- 26 VENTAL SIDENG 5° REB VENTICAL

  27 BOOK ARCEORS 16° LONG @ 8-4° 64. w(2)
  HITL FER WALL

- 280 VDT/LTXIM/TERMENATION STREP
  280 TREATED WOOD PLATE
  300 WATER TABLE COEL STOCK o/ WOOD-COLOR TO MATCH TON
- 31 DOUBLE TOP PLATE

  32 N° 1.1 N° WOOD PURBING @ 20° 0.C.
  TYPECAL @ UNDERSIDE OF ALL BOOF
  TRUBBER, CERLING RAFTERS & JOSETS
- 33 VINYL VENTED SOPPIT SYS
- 34 CORL STOCK & WOOD COLOR TO MATCH
- 35 WOOD BLOCKING
  36 SAT FLYWOOD BOOF SEEAT
- 38 REFEGLAN / ANNALT SHINGLE
- 36 H\* FREERGLAR BATT RELLATION
  40 FOUNDATION WALL PAINCE =/
- (41) RIM JOSET FER MANUFACTURES: REQUERIMENTS
- 42 BITURORIS WATERFROOMS: UNDERLATMENT FROM ROOF EDGE TO 6-6" ABOVE A 3-6" TO EACH EDGE OF VALLEYS, REDGES AND VERTICAL TRANSMITTERS
- 43 THEO DOWNS HER PRE-ENG SUPPLIES ABOURDS-40075
- 742-EHGENEZERD ROOF TRUER SYS FILE-BIGGREETED BY ROOF TRUES SUPPLIES: PROVIDE BRACING FIRE SUPPLIES: REQUIRES-65715
- 45 STEEL BALLARD REPER TO PLO 48 WOOD TREA 47 WOOD WINDOW STOOL
- 46 RALANT @ FERMETES
- VENTE CLAD WOOD WIND COLOR TO MATCH TRAM 50 GALV. TIS-DOWN (I) PER JOSET

  51 COUNTES PLANNING - AS REQUIRED ROOF WINDOW SUFFLESS
- 52 VINYL CLAD ROOF WINDOW SYSTEM
  53 WINDOW TRIM COIL STOCK & WOOD-COLOR TO MATCH TRIM
- 54 SEALANT A BACKER BOD AS REQUIRED @
- 55 2" WOOD RAFTERS @ 16" a.c.
- 67) 6"s6" TREAT WOOD PUB:

  56 GALV. WOOD POST BASE HATE- ANCHOR TO CONCRETE W W D EXPANSION BOLT
- 80 THE PLYING RAFTERS @ Nº MA. 61 PRE-PROBRED INSTANTED OVERHEAD DOOR W AUTOMATIC REMOTE CONTROLLED OPENER
- 82 Nº POLINED-BI-PLACE CONC STOP RECESS
- 65 CHIMNEY FLASHING LEAD COPPER
- 86 NOT USED
  67 CONTINUOUS WOUD PIRE BLOCKING 68 STAIR - DESKIN PER SHOP DRAWINGS





GAWRON **ARCHITECTS** 29 Black Point Road Scarborough, ME 04074 www.gawron.com

Tel. 207 . 883 . 6307 Fax. 207 . 883 . 0361


STARBIRD ROAD CONDOMINIUMS
BROWN DEVELOPMENT CORPORATION
PORTLAND, MAINE

L		•
Ē	RE	VISIONS
١.	BAR	V 1010110
	MATS	ISSUED FOR CONSTRUCTION 62/85/62 62/28/62

DATE:	<b>82/05/02</b>
PROJECT#	<b>0</b> 31] <b>9</b> ]
DRAWN BY:	DNR
CHECKED BY:	<b>3</b> G
DRAWING SCALE	AS NOTED

SHEET TITLE WALL SECTIONS



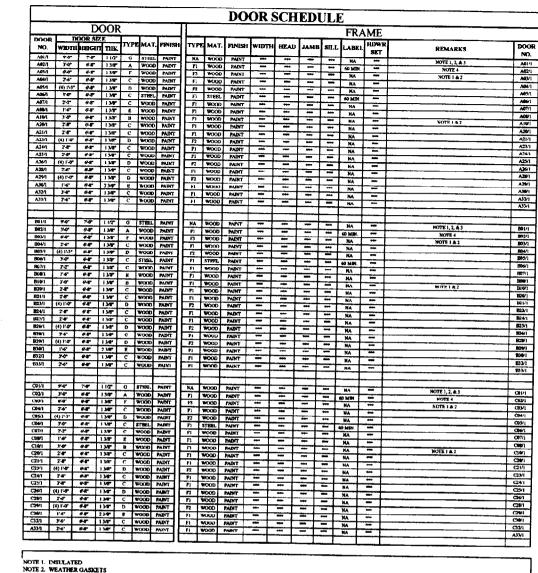

OTE 1. INSULATED	_
OTE 2. WEATHER GASKETS	
OTE 3. AUTOMATIC REMOTE CONTROLED OPENER	
OTE 4. PROVIDE LOUVER	

IIFE	MANUFACTURER	PRODUCT NO.	HEAD	JAME	SELL	REMARKS
		TW21842				EGRESS
В		TW2042	-			
c		TW3842	T	٠ ا		
D		CXW13				
E		TW21942				† <del></del>
F	<b>.</b>	TW210210				T
Ģ		TW21031				TEMPERED
1		RS2146				MULIF WINDOW - PLOSED
OTE 4	WINDOWS BASE ON AN PROVIDE SCREENS AT ALL WINDOWS SHALL I ALL HARDWARE SHALL ORBLES SHALL BE BET	ul operable wing de white. de white.	NARROW DOWS	1.8NF, 400	SVRES.	Marie All as and

|--|--|

A-500 SCALE: 1/4" = 1'-0"

•

•

€

 $\blacksquare$ 

00

•

**(A)** 

•

•



(72)

 $\bigcirc$ 

WINDOW TYPES

A-500 SCALE: 1/4" = 1'-0"





GAWRON ARCHITECTS 29 Black Point Road Scarborough, ME 04074 www.gawron.com Tel. 207 . 883 . 6307 Faz. 207 . 883 . 0361

STARBIRD ROAD CONDOMINIUMS
BROWN DEVELOPMENT CORPORATION
PORTLAND, MAINE

_					
Γ	REVISIONS				
•	DATE	PROCHEDOK			
		ISSUED FOR CONSTRUCTION 92/05/92 92/28/92			
_	i				


DATE:	82/05/02
PROJECT #	<b>6</b> 51161
DRAWN BY:	DMDR
CHERCIKED BY:	\$G
DRAWING SCALE	AS NOTED

SHEET TITLE

DOOR & WINDOW SCHEDULE & DETAILS

A-500

COPYRIGHT 1985-20 REPRODUCTION OR ABUSE OF HIS DOCUMENT WITHOUT WITHOUT PERSONS OF COMMON APPLICATION OF PROGRAMME

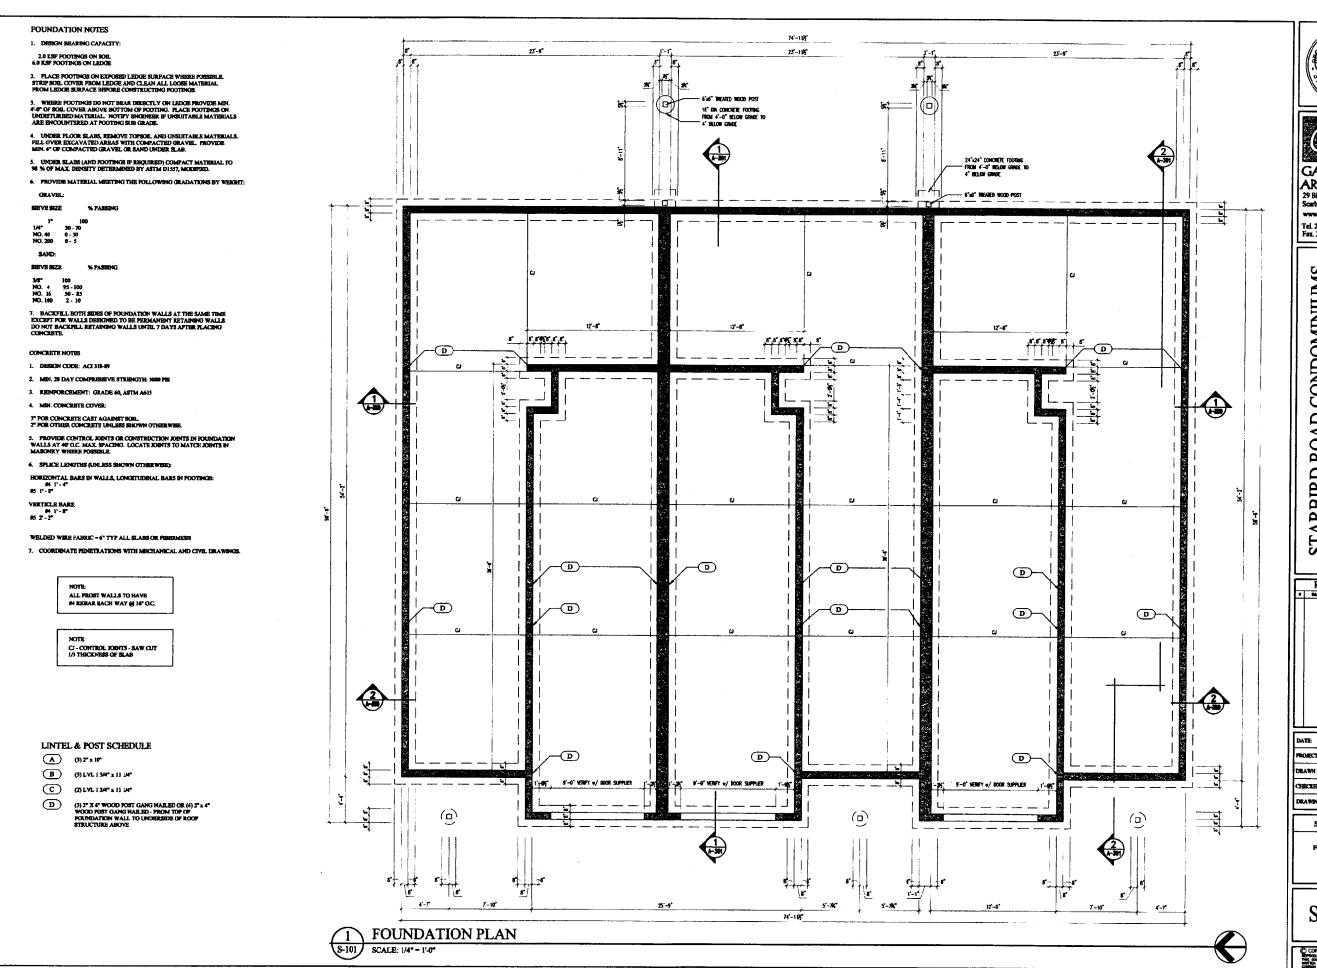





CORPORATION M AINE

ROAD CONDOMINIUMS STARBIRD ROAD CONI BROWN DEVELOPMENT C PORTLAND, N

	REVISIONS				
Ē					
•	MIE	PROCHETICH			
		BISURD FOR CONSTRUCTION 02/05/02 92/29/02			

DATE:	<b>42/05/0</b> 2
PROJECT #	<b>83</b> 3301
DRAWN BY:	DAIR
CHECKED BY:	\$G
DRAWING SCALE	AS NOTED

SHEET TITLE

FOUNDATION

S-101



### WOOD FRAMING NOTES:

- 1. STRUCTURAL LUMBER: NO. 2 SPRUCE-PINE-PIX OR BETTER
- 2. DESIGN CODE: NATIONAL DESIGN SPECIFICATIONS FOR WOOD CONSTRUCTION BY THE NATIONAL PURBST PRODUCTS ASSOCIATION
- 3. FASTENERS: COMPLY WITH RECOMMENDED FASTENING SCHEDULE OF THE BOCA NATIONAL BUILDING CODE/1999, UNLESS SHOWN OTHERWISE ON THE DRAWNOR
- NAILING REQUIREMENTS FOR PLYWOOD FLOOR DECKS, ROOF DECK, AND SHEATHING

PROVIDE ED NAILS AS POLLOWS UNLESS SHOWN OTHER WISE

- 6" O.C.: ALONG ALL PANEL EDGES
- 10" O.C.: ALONG INTERMISDIATE MEMBERS FOR FLOORS
- 5. SPIKE TOGETHER ALL FRAMING MEMBERS WHICH ARE BUILT-UP USING 2-ROWS OF 164 NAILS AT 12" O.C. STAGGERED.
- 6. PROVIDE GALVANIZED METAL JOIST HANGERS AT PLUSH PRAMED CONNECTIONS. IF SIZES ARE NOT SHOWN ON PLANS, PROVIDE HANGERS BOUAL TO SIMPSON 1/210 OR LUZIO.
- PROVIDE GALVANIZED METAL RAFTERS TIES BQUAL TO SINGSON H 2.5 BETWEEN GRI ROOF RAFTERS AND SUPPORTING WALLS OR MEMBERS, UNLESS SHOWN OTHERWISE.
- 8. PROVIDE 3 2 X 10 HEADERS OVER ALL OPENINGS IN BEARING WALLS UNLESS SHOWN OTHER WISE.
- 9. PROVIDE DOUBLE TOP PLATE IN ALL EXTERIOR WALLS AND ALL BEARING WALLS. STAGGER TOP PLATE SPLICES IN EXTERIOR WALLS 4'-4" AND PROVIDE AT LEAST 8-16D NAILS PER SPLICE.
- 10. PROVIDE PRESSURE TREATED LUMBER FOR ALL LUMBER IN CONTACT
  WITH MASONRY OR CONCRETE.
- 11. PROVIDE MIN. OF 2 2X STUDS AT ENDS OF ALL BUILT-UP 2X BEAMS UNLESS SHOWN OTHER WISE.
- 12. NAIL MULTIPLE MICROLAM, PARALAM OR LVL LUMBER TOGETTER USING 2 ROWS OF 160 NAILS 12°O.C. STAGGERED AS RECOMMENDED BY THE MANUFACTURER.
- 13. ROOF AND WALL SHEATHING
- APA RATED SHEATHING, EXPOSURE  ${\bf i}$  OR STRUCTURAL  ${\bf i}$  OR STRATED SHEATHING, EXPOSURE  ${\bf i}$  .
- ROOF: 5/8\*, SPAN RATING 32/16 PLYWOOD WALLS: 1/2\* PLYWOOD
- INSTALL SHEETS WITH FACE GRAIN DIRECTION PERPENDICULAR SUPPORTING MEMBERS.
- POSTS WHERE NOTED AND AT CORNERS OF EXT. WALLS: PROVIDE 6X6 OR 3-2X6 MIN. OR 4-2X4 CONTINUOUS TO ROOF FRAMING.
- PROVIDE FULL DEPTH BLOCKING AT ENDS AND INTERIOR SUPPORTS OF ALL DOISTS AND RAFTERS WHERE JOISTS AND RAFTERS FRAME OVER SUPPORTS.
- PROVIDE IX3 DEAGONAL BRIDGING OR FULL DEPTH BLOCKING PO EACH IF OF STAN FOR ALL JOISTS AND RAFTERS.

#### ERECTION NOTE

- 1. ALL WOOD MEMBERS MUST BE PROPERLY BRACED UNTIL THE COMPLETE STRUCTURAL SYSTEM HAS BEEN CONSTRUCTED.
- 2. IN THE EVENT OF ERROR, DEFECT IN MATERIALS, AND/OR WORLMANSHIP OF SHOP WORL WHECH PREVENTS PROPER ASSEMBLING AND PITTING UP OF PARTS, BARGEMATELY REPORT TO THE ENGINEER AND OBTAIN ENGINEER'S APPROVAL TO THE METHOD OR CORRECTION.
- 3, CONSIDERATION BY THE CONTRACTOR MUST BE MADE TO ACCOMMODATE DEPLECTIONS OF THE STRUCTURAL PRAMING SYSTEM. CONSIDERATION MIST ALSO BE MADE TO ACCOMMODATE DEMENSIONAL CHANGES IN WOOD MEMBERS DUE TO CYCLIC CHANGES BY HUMBITY CONDITIONS. SIP DOINTS MUST BE USED AT GLASS PRAMING AND MONI-LOAD BEARING PARTITIONS.

#### LOADING NOTES

- CODE: BOCA 1996, CABO 1992
   MAXIMUM FLOOR LIVE LOAD DEPLECTION L/960
- 2. PLOOR DL:
  2.X PRANING, BEAMS
  DECKING
  PLOORING
  12° GYP.BD. CEILING
  10'
  TOTAL = 10.1 PSP
- PLOOR LL:


# LINTEL & POST SCHEDULE

- A (3) 2" x 10"
- B (3) EVL 1 3M\* x 11 1/4\*
- C (2) LVL 1 34° x 11 14°
- D (3) 2" X 6" WOOD FOST GANG HAILED OR (4) 2" x 4" WOOD FOST GANG HAILED PROM TOP OF FOUNDATION WALL TO UNDERSIDE OF ROOF STRUCTURE ABOVE

# NOTE: REFER TO WOOD STRUCTURES TRUSS LAYOUT DRAWINGS FOR LOCATIONS, TYPES AND REQUIRED BRACING - TYPICAL

SECOND FLOOR FRAMING

S-102 SCALE: 1/4" = 1'-0"

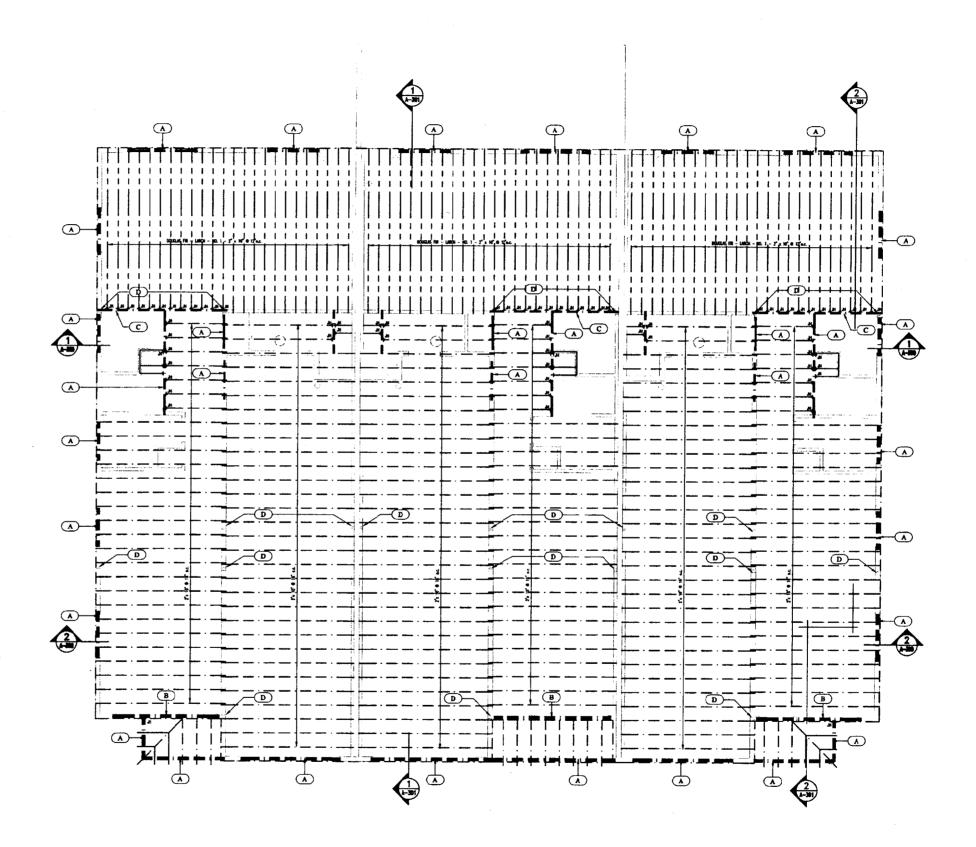





Scarborough, ME 04 www.gawron.com Tel. 207 . 883 . 6307 Fax. 207 . 883 . 0361

STARBIRD ROAD CONDOMINIUMS
BROWN DEVELOPMENT CORPORATION
PORTLAND, MAINE

REVISIONS

DAME DESCRIPTION

ESSURED FOR
CONSTRUCTION
22/4502
62/7802

DATE: 62/05/62
PROJECT # 60 H41

DRAWN BY: DAGE
CHECKED BY: SG


DRAWNG SCALE AS NOTED

SHEET TITLE

SECOND FLOOR FRAMING PLAN

S-102



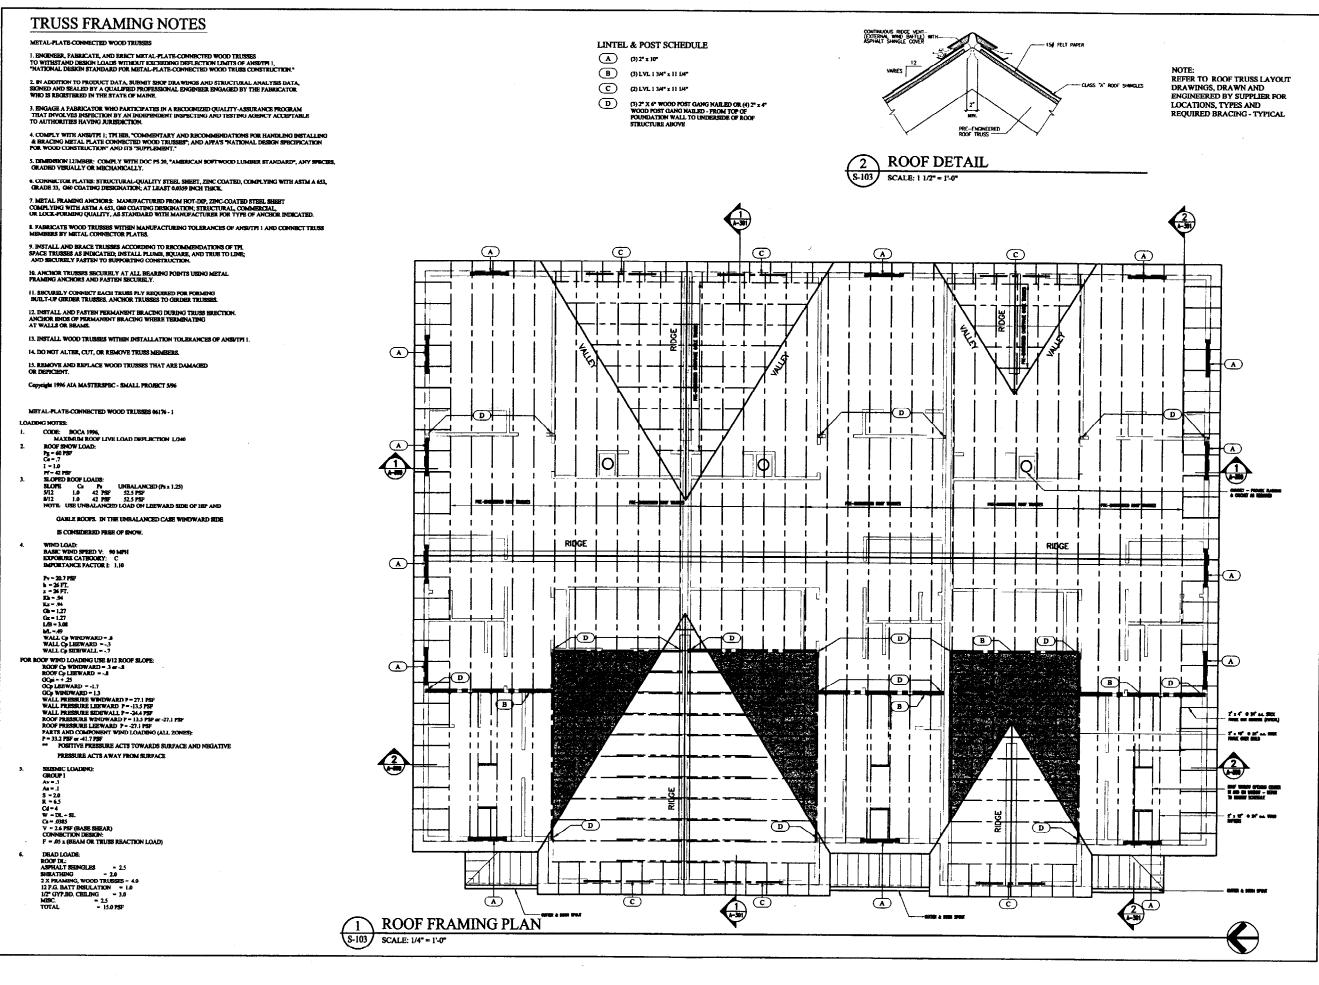





STARBIRD ROAD CONDOMINIUMS
BROWN DEVELOPMENT CORPORATION
PORTLAND, MAINE

L	_				
Г	REVISIONS				
ŀ	- N-W	PRODUTED			
	BATT	INSULED POR CONSTRUCTION 62/8542 92/28492			

62/05/82
.631101
DMR
<b>9</b> G
AS NOTED

SHEET TITLE

ROOF FRAMING PLAN

S-103



