389 Congress Street, 04101 Location of Construction:	Owner Name:	, , ,		r Address:	-		<del></del>	005  <sub>P</sub>	hohe		13001
304 Capisic St		in J & Corina Burt	1	Capisic S	1						
Business Name:	Contractor Name		C		Marin contraction and	ar n	. t 2.5 -x	- P	hone		
	New England	Build and Design	5 Fo	rest St Fr	eeport-	Uř r	UKI			3650	988
Lessee/Buyer's Name	Phone:		Permi	it Type:	,				The first a segment		Zone:
			Add	ditions - I	Dwellings						182
Past Use:	Proposed Use:	'	Perm	it Pee:	Cost o	f Work:		CEO	Disti	ict:	7
Single family		attatched garage w/		\$561.0	00 \$	60,000			3		
	second story 1	iving space	FIRE	E DEPT:	Appro	oved	NSPE	CTIO	N:		K.C.
					Denie	d	Use Gr	oup: 🗽	(2		Type.
foundation Jermit #	-05-0317						_	IR	( -	200	Type. <b>5</b> f 13 1/20/05
Proposed Project Dekcription:								Jo	A A .	a.	the list
Attatched garage w/ second s	tory living space		Signa		CELVERIE	S DIGTE	Signatu	ırg:	VVI	1	1/20/03
			PEDE	SI KIAN A	ACTIVITIES				)	/	′ /
			Actio	ا لحا	pproved	Appro	oved w/				Denied
	In	1	Signa					Date:			
Permit Taken By: dmartin	Date Applied For: 04/1212005			Zon	ing App	roval					
	•	Special Zone or Revi	ews	7	Zoning Appe	eal		Hi	stori	c Pres	servation
		Shoreland		Uan Van	riance			× N	ot in	Distri	ct or Landma
		Wetland	اد با	Mis Mis	scellaneous			☐ D	oes N	lot Re	quire Review
		☐ Flood Zone Found	ichon H	Con	nditional Use	;		R	equir	es Rev	/iew
		Subdivision vermi	5.07	[] Inte	erpretation			☐ A	pprov	ved	
		Site Plan		Ap <sub>l</sub>	proved			A	pprov	ved w/	Conditions
		Maj Minor MM		Dei	nied		,	D	enied		
		Date MA 4 20	105	Date:			); );	are.	$\overline{\mathcal{M}}$	K	2
		V	1					$\bigcup$			
		CERTIFICATI	ON								
I hereby certify that I am the of I have been authorized by the furisdiction. In addition, if a pshall have the authority to entersuch permit.	owner to make this appleermit for work describe	amed property, or that the ication as his authorized d in the application is i	he prop d agen ssued,	t and I ag I certify t	ree to cont that the co	form to de offic	all ap	pplica author	ıble ized	laws l repr	of this resentative
						DATE					
SIGNATURE OF APPLICANT		ADDRES									NE

Form # P 04

### DISPLAY THIS CARD ON PRINCIPAL FRONTAGE OF WORK

	TY OF PORTLAND	
Please Read Application And Notes, If Any, Attached	PERMIT PE	PERMIT ISSUED
This is to certifyht	- New E	APR 2 1 2005
AT 304 Capisic St	and s living the	CITY OF PORTLAND
provided that the person or person of the provisions of the Statutes the construction, maintenance are this department.	of the and of the ances of the	
Apply to Public Works for street line and grade if nature of work requires such information.	bare this ading or thereo pr	certificate of occupancy must be coured by owner before this build-g or part thereof is occupied.
OTHER REWIRED APPROVALS Fire Dept.		
Health Dept.		2/1/
Appeal Board	1 Jean	Dourke 4/20/05
Other DepartmentName	ENALTY FOR REMOVING THIS CARD	Director - Building & Inspection Services

City of Portland, Maine - Buil 389 Congress Street, 04101 Tel: (2	_		Permit No: 05-0404	Date Applied For: 0411212005	CBL: 224 A013001
Location of Construction:	Owner Name:	· · · · · · · · · · · · · · · · · · ·	wner Address:		Phone:
304 Capisic St	Spike Benjamin J & C	Corina Burt	304 Capisic St		
Business Name:	Contractor Name:	C	Contractor Address:		Phone
	New England Build ar	nd Design	5 Forest St Freepor	t	(207) 865-0988
Lessee/Buyer's Name	Phone:	P	ermit Type:		
		L	Additions - Dwell	ings	
Proposed Use:		Proposed	Project Description:		
Single farmly attatched garage w/ second	and story in ring space			nd story living space	

3) Separate permits are required for any electrical, plumbing, or heating.

DEP	T. OF BUILDING INSPECTION
	T, OF BUILDING INSPECTION CITY OF PORTLAND, ME
	1

APR 1 2 2005

#### All Purpose Building Permit Application

RECTO IN THE property owner owes real estate or personal property taxes or user charges on any property with the City, payment arrangements must be made before permits of any kind are accepted.

Total Square Footage of Proposed Struct	ure	Square Footage	of Lat	
Tax Assessor's Chart, Block & Lat Chart# Block# Lot# . スシリ ル 013	Owner:	rike		Telephone:
Lessee/Buyer's Name (If <b>Applicable)</b>	Applicant in telephone:	name, <b>address</b> &	<b>←</b> M	ost Of <u>60,000</u> ork: \$ <u>60,000</u> ee: \$
Current use:  If the location is currently vacant, what was Approximately how long has it been vacant Proposed use:  Attacked Approximately how long has it been vacant Project description:  Approximately how long has it been vacant Project description:  Approximately how long has it been vacant Project description:  Approximately how long has it been vacant Project description:  Approximately how long has it been vacant Project description:	nt:	ed / floord	ewy	_
Contractor's name, address & telephone:  Who should we contact when the permit Is Mailling address:  We will contact you by phone when the pereview the requirements before starting any and a \$100.00 fee If any work starts before the	errnit is reday y work, with a	ı Plan Revlewer. A	, stop work c	7.5-0988 $7.2-5823$ $9.4$ $9.5$
IF THE REQUIRED INFORMATION IS NOT INCLUIDENIED AT THE DISCRETION OF THE BUILDING/INFORMATION IN ORDER TO APROVE THIS PERIOD.	PLANNING DI			
I hereby certify that I am the Owner of record of the name have been authorized by the owner to make this application. In addition, if a permit for work described in the shall have the authority to enter all areas covered by this to this permit.  Signature of applicant:	ation as his/her a his application is	<b>ruthorized agent,</b> I <b>agr</b> Issued, I certify that the	ee to conform ( Code Official's	o all applicable laws of this authorized representative
This is NOT a permit, you may not if you are in a Historic District you may Planning Departm	be subjec	to additional p	ermitting	nit is issued. and fees with the



#### New England Build & Design, Inc. 5 Forest Street Freeport, Maine 04032

Office 207-865-0988

Fax 207-865-9119

DATE:

4/19/2004

TO:

Jeanie Bourke

FAX:

207-874-8716

RE:

New England Build & Design, Inc.

304 Capisic Permit


#### MESSAGE:


Information requested for permit. This should cover everything that we talked about yesterday. Please give me a call to let me know that the permit has been issued. Thank you again for all of your help.

#### Rebecca Green




5 pages inculding cover

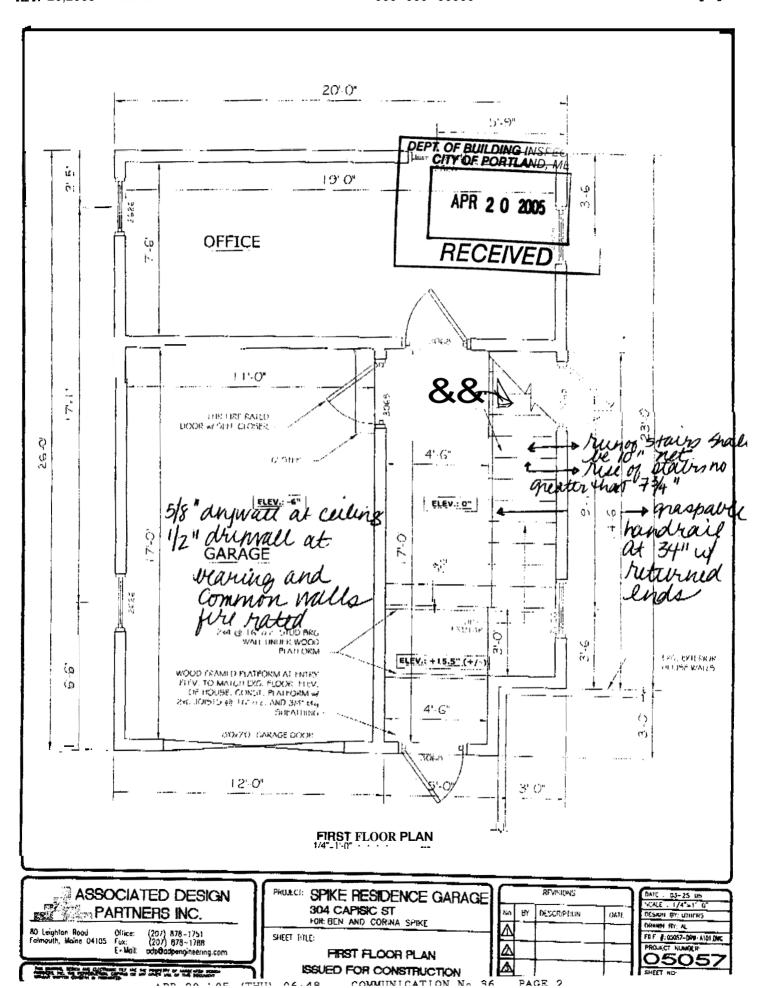


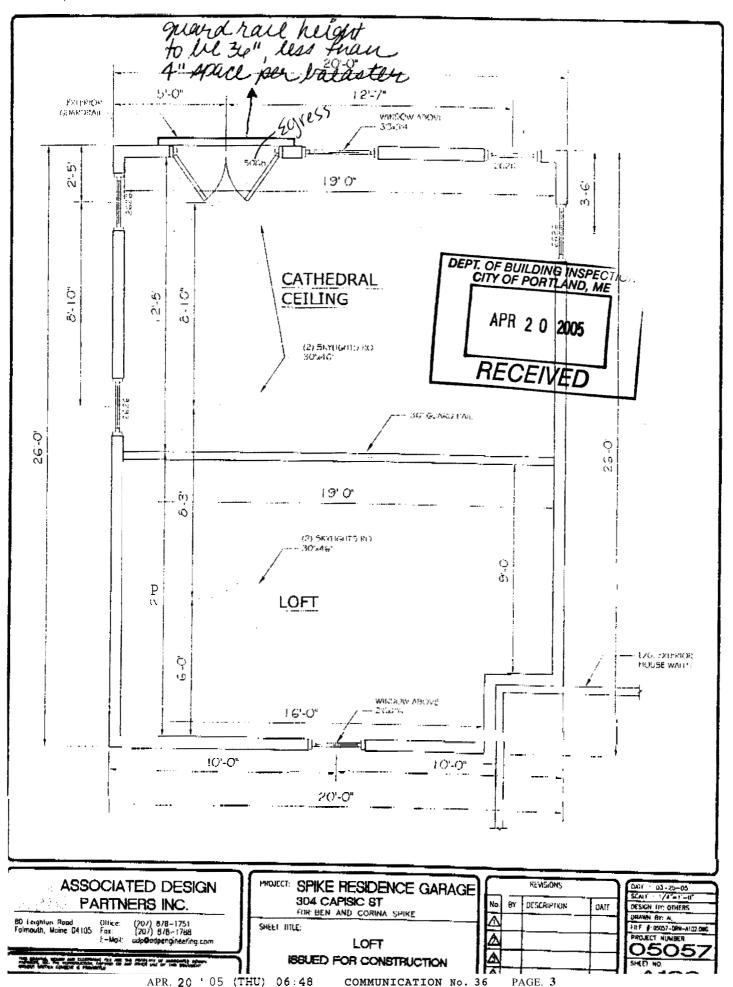


COMMUNICATION No. 36

PAGE. 3

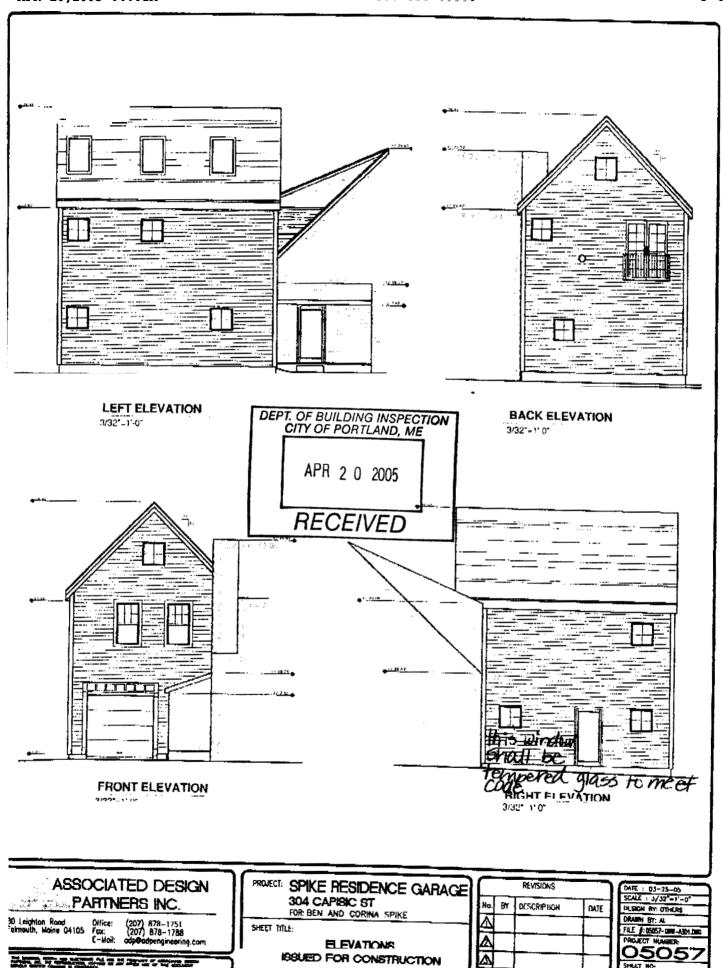

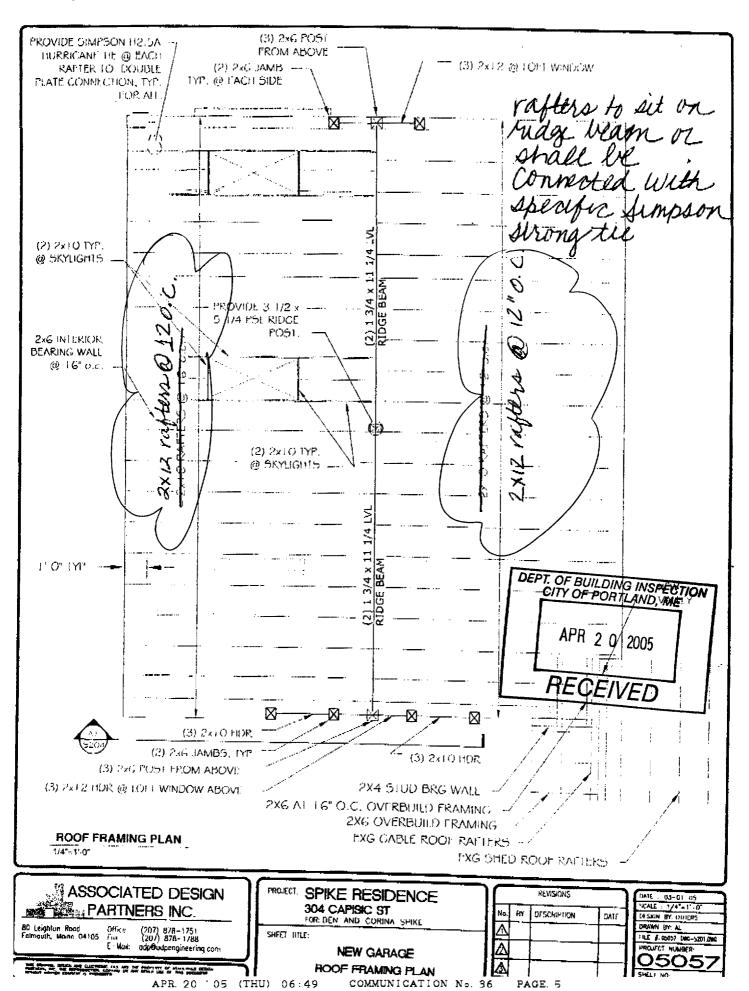

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80 Leighton Road Falmouth, Maine 04105

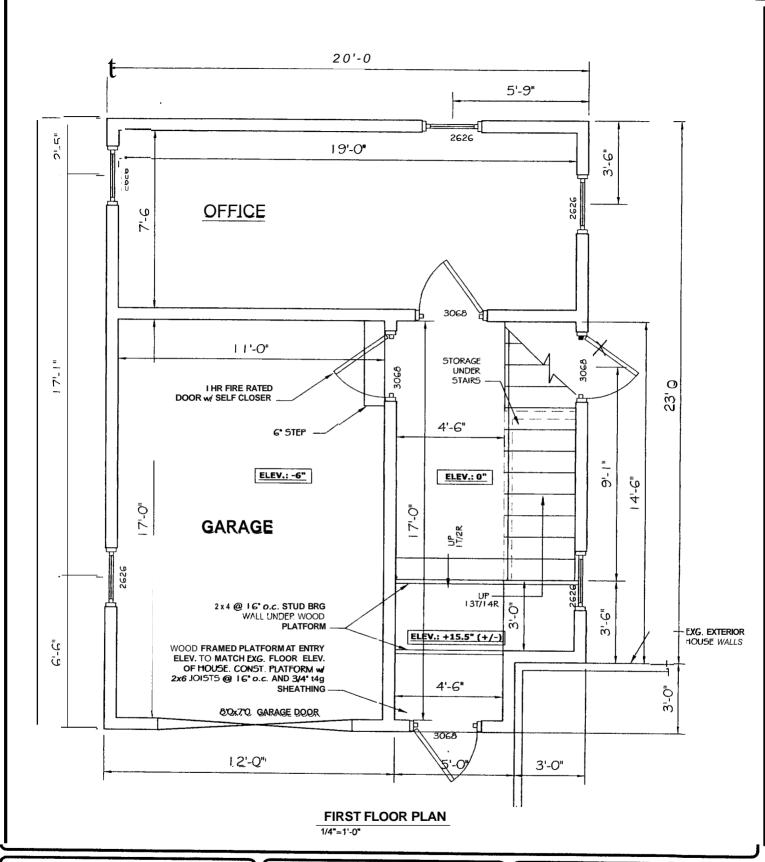Office: Fax: E—Mail:

(207) 878-1751 (207) 878-1788 adp@adpengineering.com

PROJECT:	SPIKE RESIDENCE GARAGE
	304 CAPISIC ST
	FOR DENI AND CODINA COINE


BEN AND CORINA SPIKE

SHEET TITLE:

FIRST FLOOR PLAN ISSUED FOR CONSTRUCTION

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DATE : 03-25-05
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DRAWN BY: AL.
FILE #: 05057-DRW-A1D1.DWG
PROJECT NUMBER:
05057
SHEET NO:



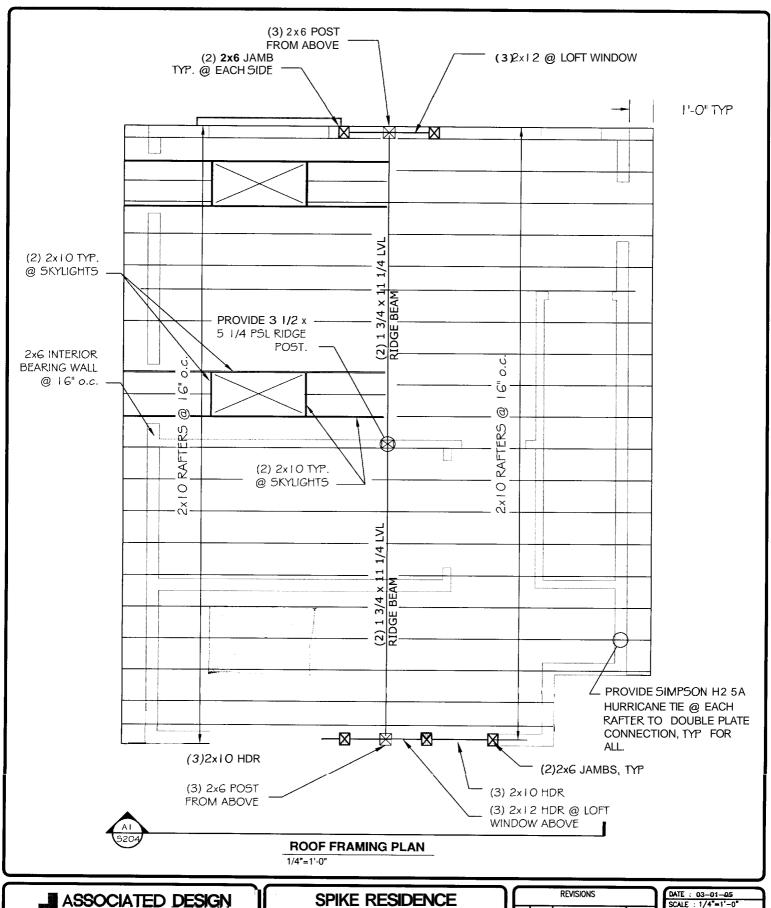

**80 Leight**on Road Falmouth, Maine 04105

(207) 878-1751 (207) 878-1788 odpOodpengimering.com

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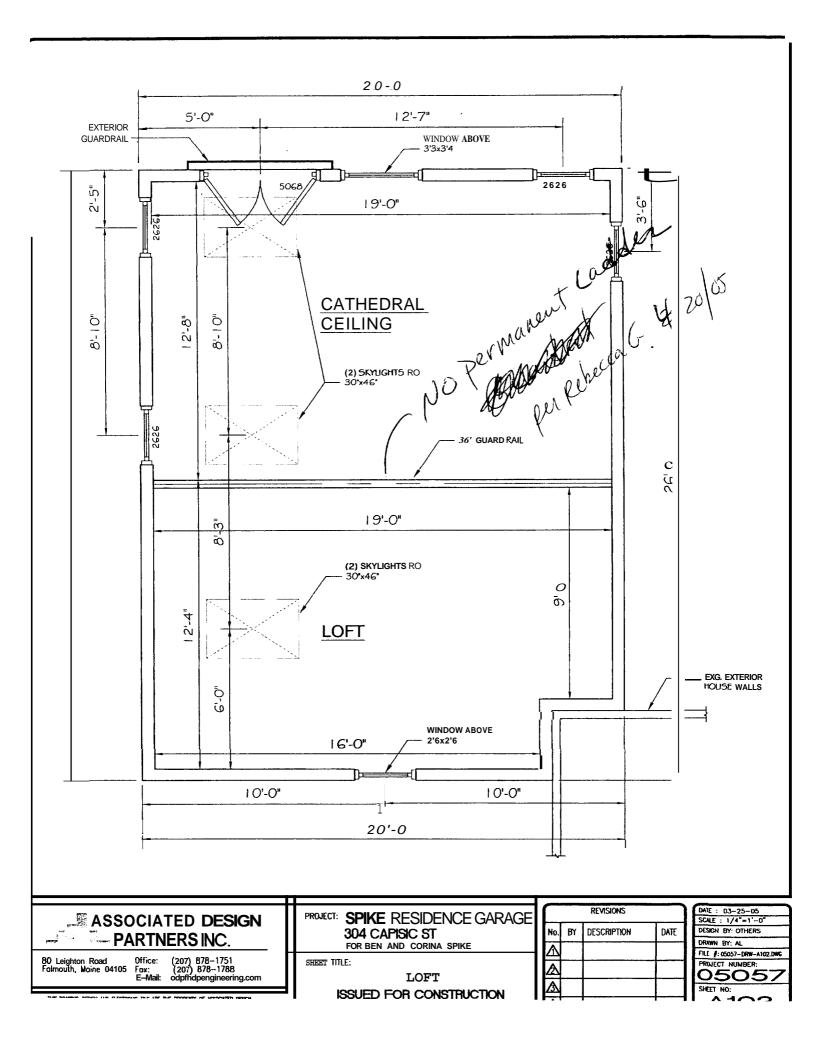
#### 304 CAPISIC ST

FOR BEN AND CORINA SPIKE


SHEET TITLE:

**NEW GARAGE ROOF FRAMING PLAN** 

	REVISIONS	
BY	DESCRIPTION	DATE
	BY	



\*NOTE:
-ALL WINDOWS/DOORS JAMBS TO
BE (2) 2x6'S U.N.O
-CONTRACTO TO PROVIDE (1) 2X6
(MIN) KING STUD @ EACH
WINDOW/DOOR OPENING, TYP.

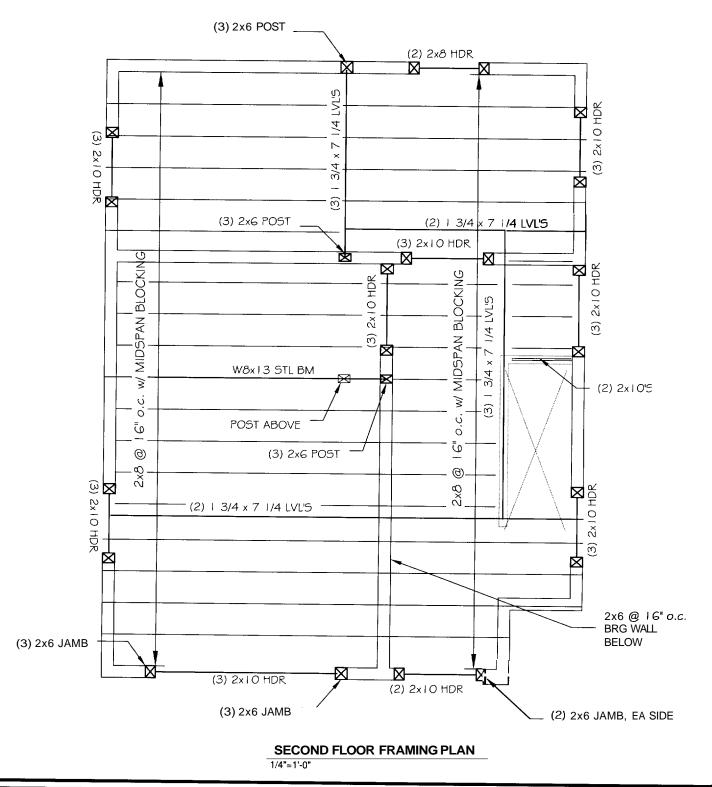

### ASSOCIATED DESIGN PARTNERS INC.

80 Leighton Road Falmouth, Maine 04105

Office: Fax: E-Mail:

(207) 878-1751 (207) 878-1788 adp@adpengineering.com

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PROJECT: SPIKE RESIDENCE GARAGE
304 CAPISK ST
FOR: BEN AND CORINA SPIKE


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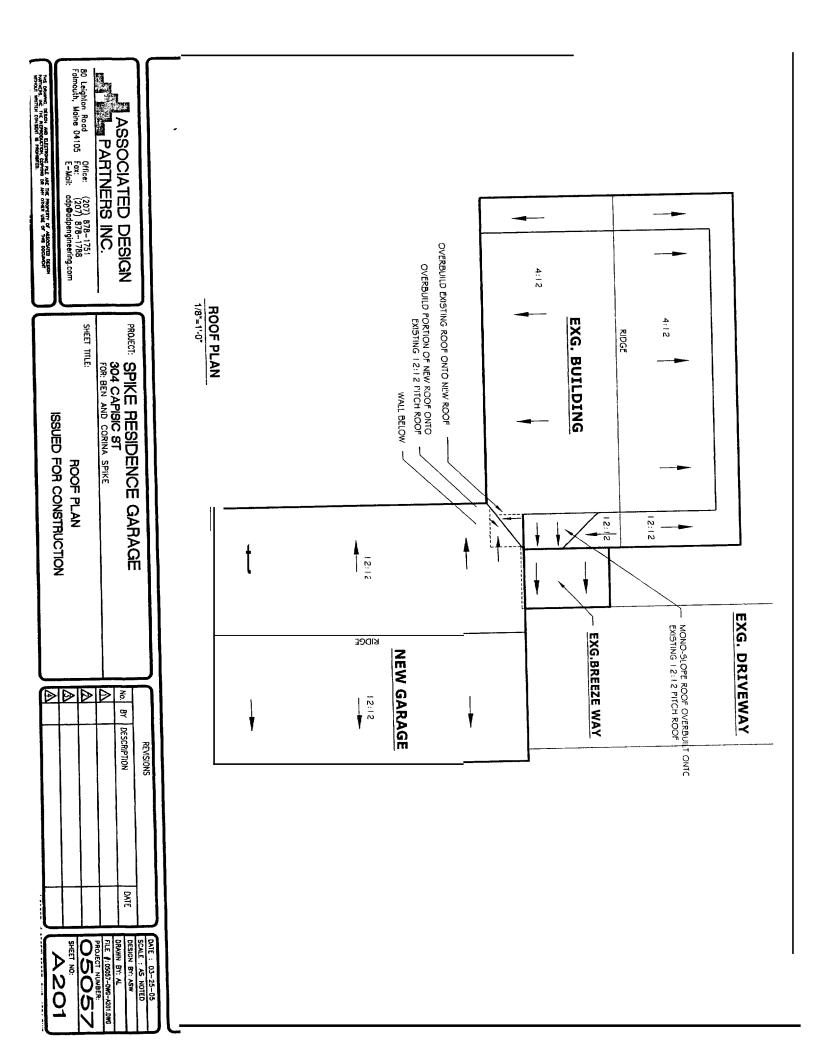
SECOND FLOOR FRAMING PLAN ISSUED FOR CONSTRUCTION


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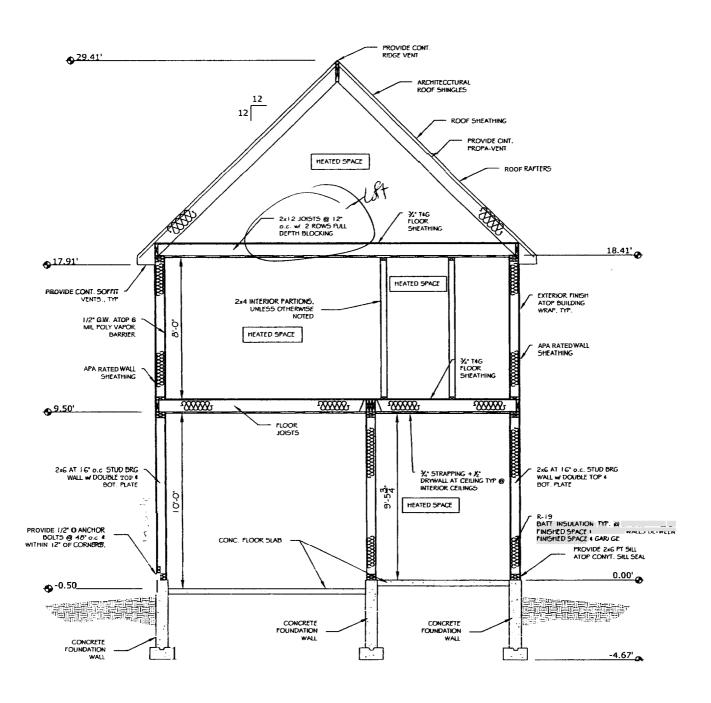
PROJECT: SPIKE RESIDENCE GARAGE 304 CAPISIC ST FOR: BEN AND CORINA SPIKE

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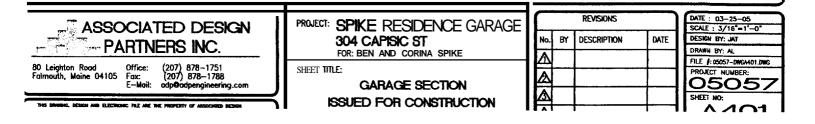
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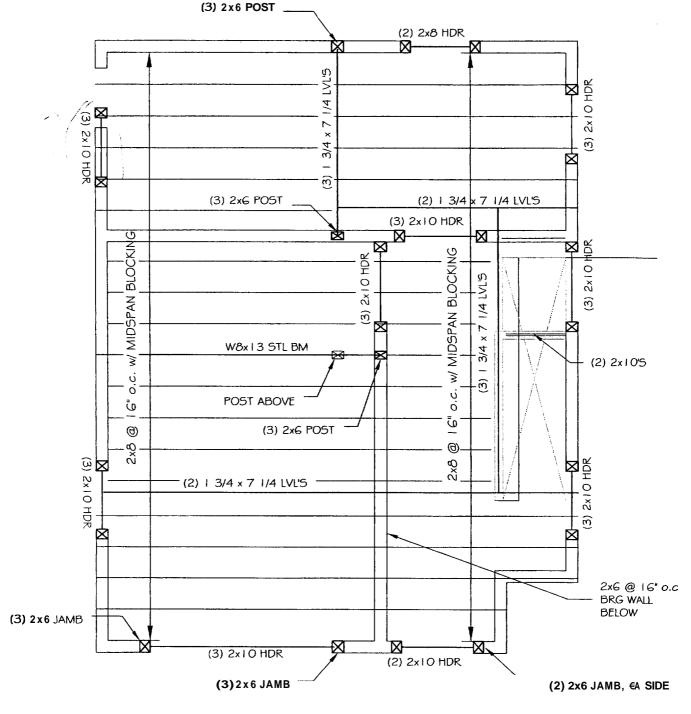
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FILE #: 05057-DRW-A301.DWG
PROJECT NUMBER:
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4004





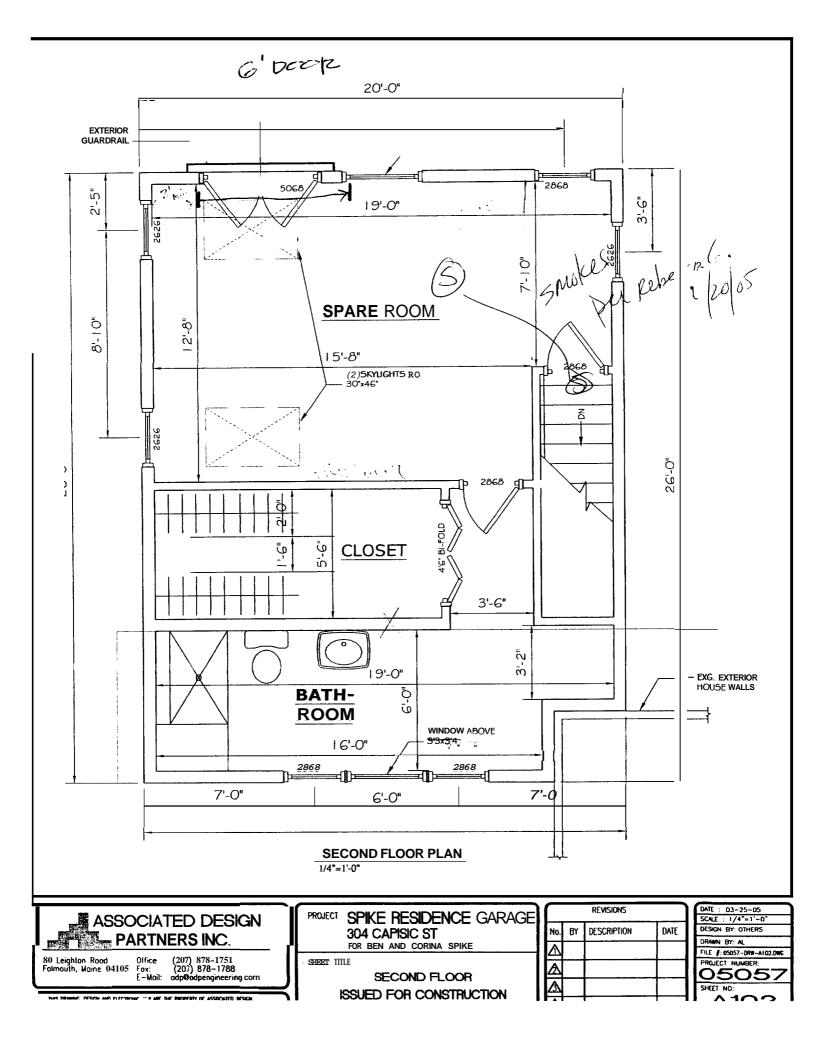

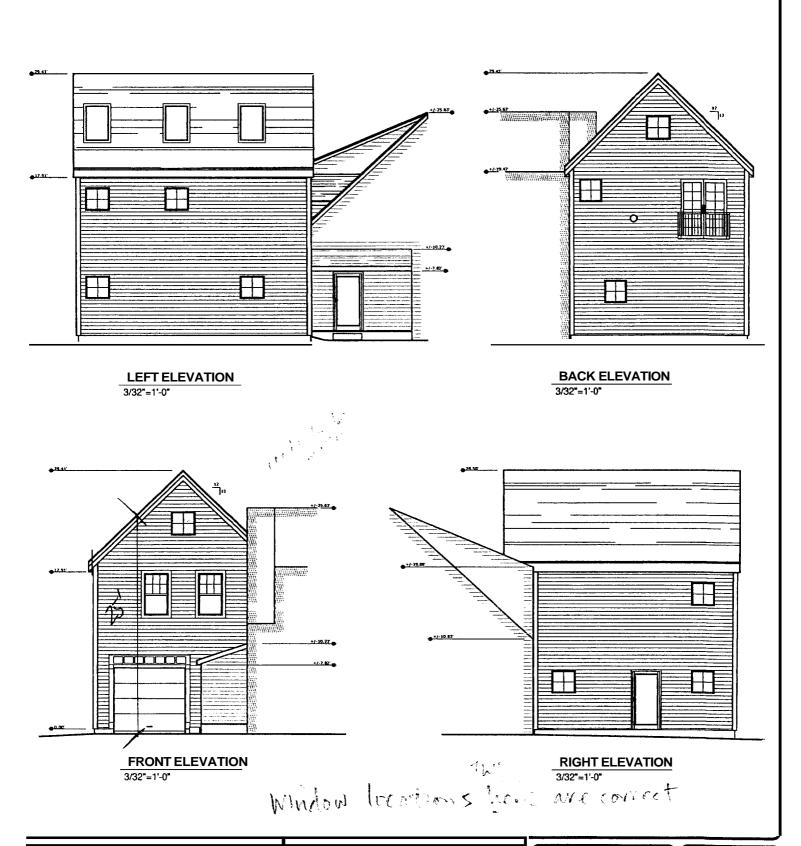\*NOTE:
-ALL WINDOWS/DOORS JAMBS TO BE (2) 2x6'S U.N.O
-CONTRACTO TO PROVIDE (1) 2X6 (MIN) KING STUD @ EACH WINDOW/DOOR OPENING, TYP.



#### SECOND FLOOR FRAMING PLAN 1/4"=1'-0"




PROJECT: SPIKE RESIDENCE GARAGE
304 CAPISIC ST
FOR: BEN AND CORINA SPIKE
SHEET TITLE:

SECOND FLOOR FRAMING PLAN
ISSUED FOR CONSTRUCTION

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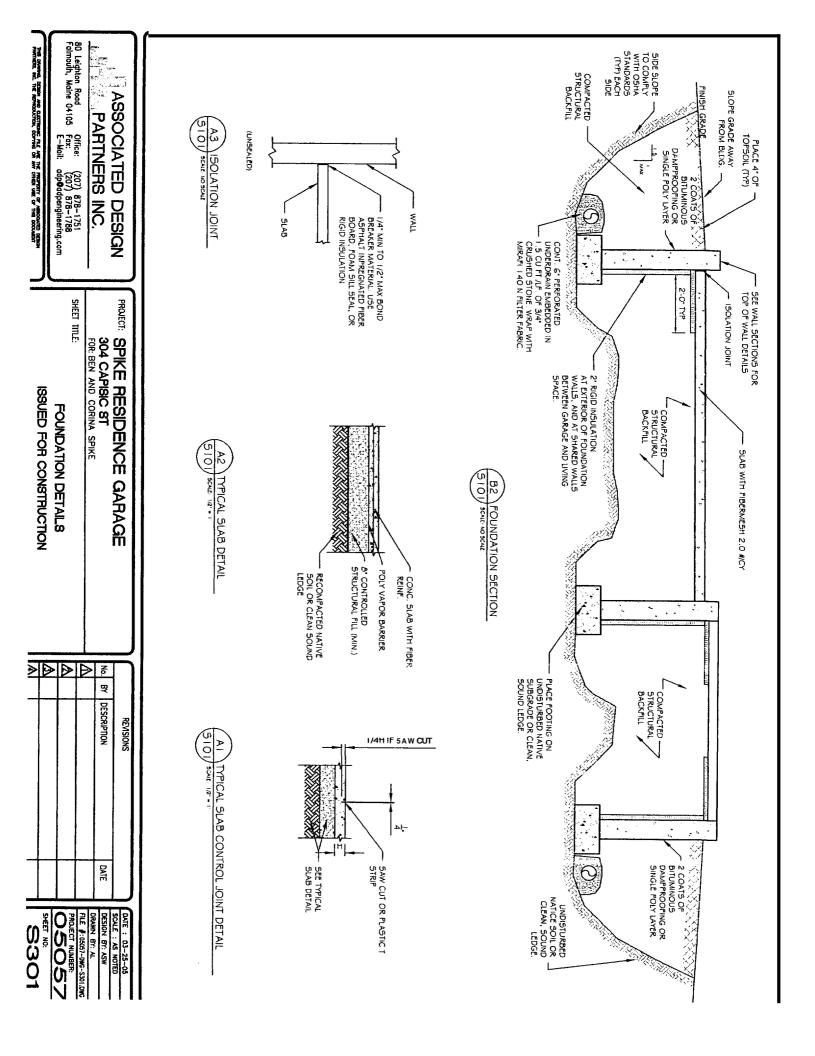


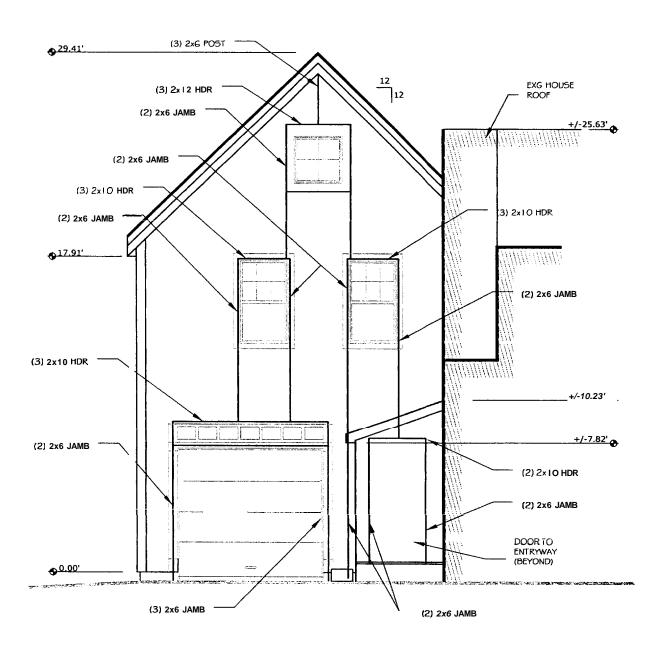


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	FOR: BEN AND CORINA SPIKE
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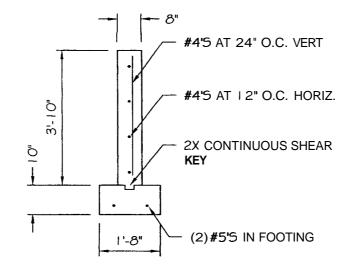
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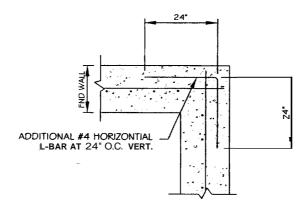
TYPICAL SLAB DETAIL @ DOOR OPENINGS



BI TYP. 8" CONC. FROST WALL

5101

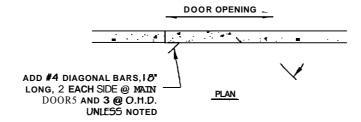5cale: 348' = 1'



S 1 O J SCALE: 3/0" = 1"




PROJECT: SPIKE RESIDENCE 304 CAPISIC ST FOR: BEN AND CORINA SPIKE

SHEET TITLE:

NEW GARAGE
FOUNDATION DETAILS

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PROJECT NUMBER:
05057
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80 Leighton Road Folmouth, Maine 04105

Office: Fax: E—Moil:

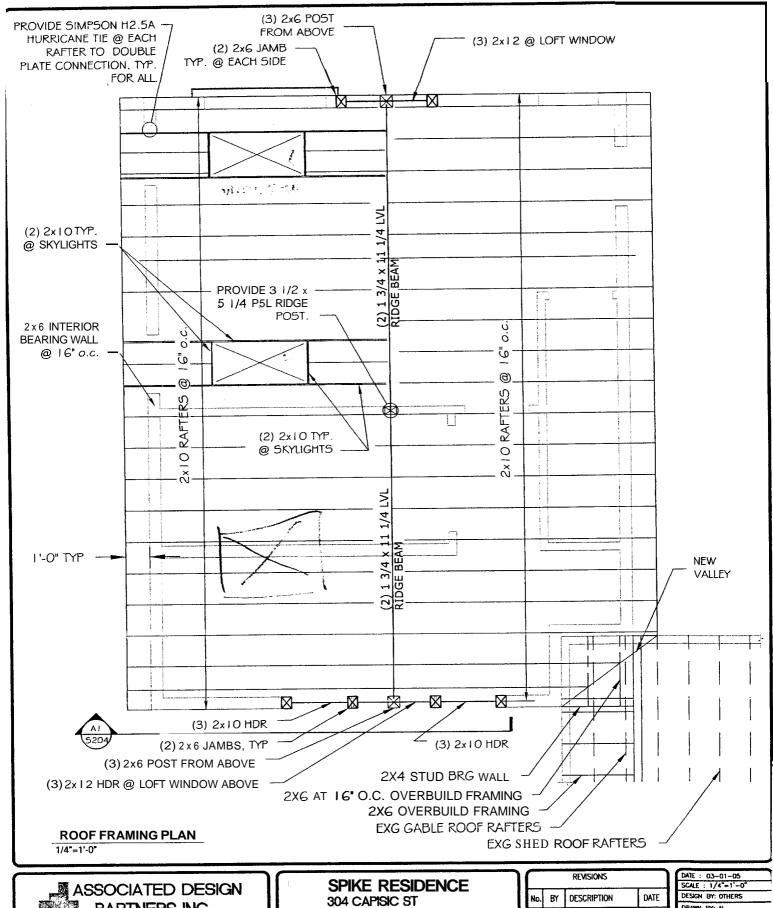(207) 878-1751 (207) 878-1788 adp⊕adpengineering.com


FOR BEN AND CORINA SPIKE

SHEET TITLE:

**NEW GARAGE** ROOF FRAMING PLAN

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FILE #: 05057-DWG-S201.DWG
PROJECT NUMBER:
05057
SHEET NO:

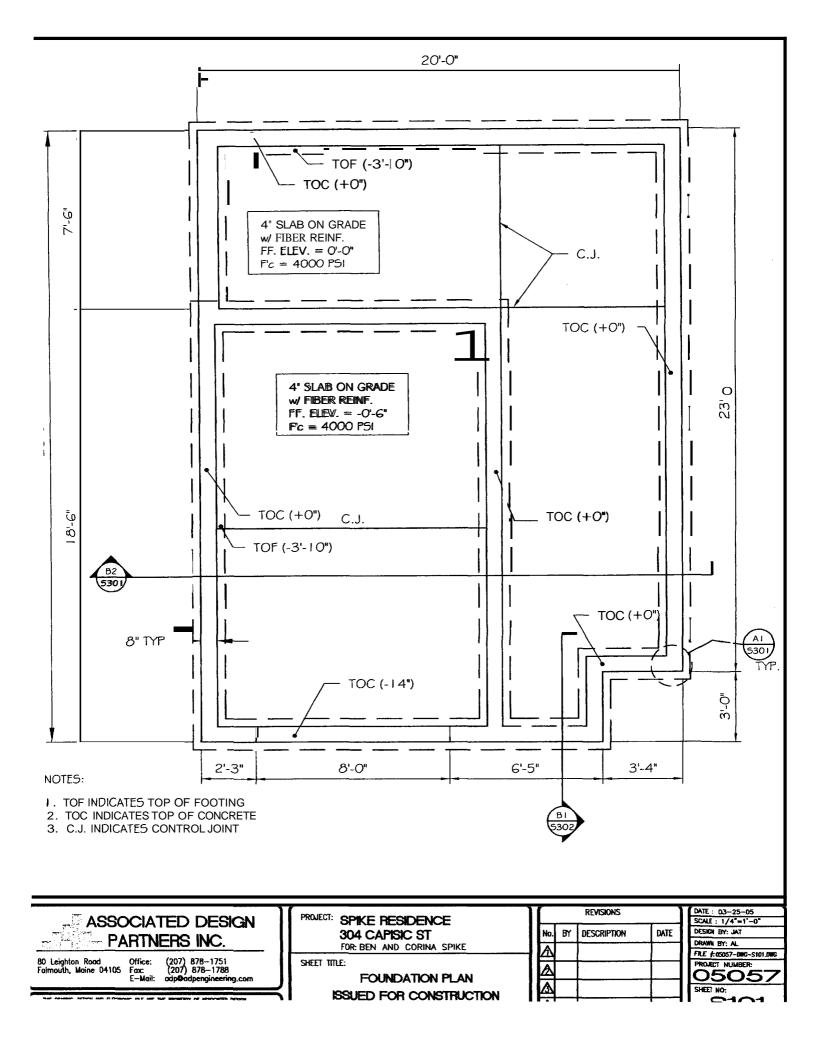

## CONCRETE NOTES

#### I. CODES

COMPLY WITH THE FOLLOWING LATEST EDITIONS AND CURRENT

- 1.1 ACI 301 "SPECIFICATIONS FOR STRUCTURAL CONCRETE
- FOR BUILDINGS"
  1.2 ACI 316 "BUILDING CODE REQUIREMENTS FOR
- OF STANDARD PRACTICE"
- 4. MATERIALS
- P I REINFORCING STEEL: GRADE GO, ASTM G 15, NEW DEFORMED BARS
- P.2 REINFORCING FOR SLABS: EQUAL TO FIBERMESH, 2.0 IDS/CY CONCRETE.
- P.3 MIXING WATER SHALL BE POTABLE, FREE OF ANY SUBSTANCES THAT MAY BE DELETRIOUS TO THE CONCRETE OR REINFORCING STEEL

### 5. CONCRETE:

5.1 5LABS:

- -MAX WATER-CEMENT RATIO: 0.45
  -AGGREGATE SHALL CONFORM TO ASTM C33 -MAX. AGG. SIZE: 3/4"
  -AIR CONTENT: 6 % + 1 % BY VOLUME -CEMENT SHALL BE ASTM 150, TYPE II PORTLAND CE- T-28 DAY COMPRESSIVE STRENGTH: 4000 PSI
- 5.2 WALLS AND FOOTINGS: -MAX. AGG. SIZE: 1 ½"
  -AIR CONTENT: 5 % + 1 % BY VOLUME
  -MAX WATER-CEMENT RATIO: 0.50 -26 DAY COMPRESSIVE STRENGTH: 3000 PSI AGGREGATE SHALL CONFORM TO ASTM C33 CEMENT SHALL BE ASTM 150, TYPE II PORTLAND CEMENT
- 5.6 PREFORMED EXPANSION JOINT FILLER:
- 5.8.1 A NON-EXTENDING AND RESILIENT BITUMINO B TYPE JOINT FILLER, 1/2" THICK.
- 5.11 VAPOR BARRIER:
- 5.11.1 UNDERSLAB MOISTURE VAPOR BARRIER BARRIER AS SHOWN IN DETAIL ON 5301 SHALL BE MADE OF A LAYER OF 6 MIL. POLYETHYLENE PLASTIC. PLACE VAPOR
- nestrua on Practas
- 6. I REINFORCEMENT:

COMPLY WITH REQUIREMENTS OF CRSI, LATEST EDITION

- 6.1.1 MINIMUM CONCRETE COVER: 3' FOR CONCRETE CASE AGAINST SOIL; 2' FOR OTHER CONCRETE, UNLESS OTHERWISE SHOWN.
- 6.8 ANCHOR BÓLTS: USE TYPE, SIZE, AND LENGTH AS INDICATED ON PLANS.

# STRUCTURAL STEEL NOTES

WOOD FRAMING NOTES

## PART I - GENERAL

## 1.00 STANDARD SPECIFICATIONS

PABRICATION, ERECTION, AND WELDING: IN ACCORDANCE WITH THE SPECIFICATIONS FOR STRUCTURAL STEEL BUILDINGS, ALLOWABLE STRESS DESIGN AND PLASTIC DESIGN ADOPTED JUNE 1989, INCLUDING ALL PUBLISHED SUPPLEMENTS. A.I.S.C.

ف

LU210.

PROVIDE GALVANIZED METAL JOIST HANGERS AT FLUSH FRAMED CONNECTIONS. IF SIZES ARE NOT SHOWN ON

PLANS, PROVIDE HANGERS EQUAL TO SIMPSON U210 OR

Ģ

SPIKE TOGETHER AND CONTINUOUS GLUE ALL FRAMING MEMBERS WHICH ARE BUILT-UP USING 2 ROWS OF 164

NAILS AT 10" O.C. STAGGERED.

PART 2 - PRODUCTS

## 2.01 MATERIALS

7. PROVIDE GALVANIZED METAL RAFTER TIES EQUAL TO SIMPSON HIO BETWEEN RAFTERS OR ROOF TRUSSES AND

SUPPORTING WALLS OR MEMBERS, UNLESS SHOWN

- LAMINATED VENEER LUMBER (LVL): EQUIVALENT TO 1.9E S.P. MICRO-LAM BY TRUSS JOIST MacMILLAN. PARALELL STRAND LUMBER (PSL): EQUIVALENT TO 2.0E PARALAM PSL BY TRUSS JOIST MacMILLAN, OR EQUAL
- 'n
- A550CIATION CONSTRUCTION BY THE AMERICAN FOREST AND PAPER
- DESIGN SPECIFICATION FOR LIGHT METAL PLATE CONNECTED WOOD TRUSSES (TPI-85).
- SCHEDULE OF THE INTERNATIONAL BUILDING CODE/2003. UNLESS SHOWN OTHERWISE ON THE DRAWINGS
- 4. OTHERWISE: SHANK NAILS FOR FLOORS, AS FOLLOWS, UNLESS SHOWN DECK, AND SHEATHING. PROVIDE ROSIN COATED &D RING

ROOFS / WALLS:

PANEL EDGES 6" O.C.

INTERIOR SUPPORT

# A. STRUCTURAL STEEL BEAMS, CHANNELS, AND T-SHAPES. ASTM A572 GR., 50 OR A992. B. STEEL ANGLES, BARS, AND PLATES. ASTM A-36. C. STRUCTURAL TUBES AND COLUMNS - ASTM A500, GRADE B. D. STRUCTURAL PIPE - ASTM A53, TYPE E, GRADE B.

- E. HIGH STRENGTH BOLTS 3/4 ASTM A-325, TYPE I OR 2. F. ANCHOR BOLTS ASTM A-307, GRADE A. G. WELDING TO BE PERFORMED WITH ETOXX 70 & ELECTR WELDING TO BE PERFORMED WITH E70XX 70 to ELECTRODES. SCHEDULE 40.
- WOOD FRAMING NOTES

છ

NAIL MULTIPLE LVL'S TOGETHER USING 2 ROWS OF 16d NAILS 12" O.C. STAGGERED AS RECOMMENDED BY THE

Ò

OTHERWISE

PROVIDE PRESSURE TREATED LUMBER FOR ALL LUMBER IN

CONTACT WITH MASONRY OR CONCRETE

STRUCTURAL LUMBER: No. 2 SPRUCE-PINE-FIR OR BETTER

ō

ROOF SHEATHING:

%" APA STRUCTURAL I RATED SHEATHING

1% SPAN RATING

MANUFACTURER

DESIGN CODES:

11. WALL SHEATHING: 7/6" APA RATED SHEATHING, 21/6 SPAN RATING

- ? NATIONAL DESIGN SPECIFICATIONS FOR WOOD
- ĺ FASTENERS: COMPLY WITH RECOMMENDED FASTENING
- NAILING REQUIREMENTS FOR PLYWOOD FLOOR DECKS, ROOF

## PROJECT: SPIKE RESIDENCE 304 CAPISIC ST FOR: BEN AND CORINA SPIKE GARAGE

9

ASSOCIATED DESIGN

PARTNERS INC.

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office: Woi: (207) 878—1751 (207) 878—1788 adp@adpengineering.com

80 Leighton Road Falmouth, Maine 04105

R DAMPRIA, OZISKA MO BEETINOME PLE AME THE PROPERTY OF ABSOCIATED OZISKA TRIVINE, BEET THE REPRODUCTIONAL, CORPTIBO OR ARY STRUTH UBE. OF THIS DOCUMENT YOUR REPREDA COMMENT IN PROPERTED.

ISSUED FOR CONSTRUCTION GENERAL NOTES

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DESCRIPTION REVISIONS ME 0505 DRAWN BY: AL DESIGN BY: ASW FILE #: 05057-0WG-5301.DW SHEET NO: 8303

DATE: 03-25-05 SCALE: AS NOTED

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05057\05057-DWG-S301.D

## EARTHWORK NOTES

- SITE WORK AND CONCRETE CONTRACTORS ARE REQUIRED TO REVIEW THE CHSITE SUBSURFACE SOIL CONDITIONS WITH THE SEA AT THE STAFF OF INTIAL CONSTRUCTION THE CONTRACTOR WILL NOTIFY SER AFTER EXCAVATION THIS STARTED AND PRIOR TO THE PLACEMENT OF ANY STRUCTURAL FOUNDATIONS.
- 2. REMOVE ALL TOPSOIL AND UNCONTROLLED FILL FOR THE AREAS RECEIVING BUILDING FOUNDATIONS
- 3. BACKFILL TO THE NECESSARY SUBGRADES REQUIRED ON THE STRUCTURAL FOUNDATION FLANS WITH CONTROLLED STRUCTURAL FILL MATERIAL MEETING THE FOLLOWING GRADATION:

PERCENT FASSING

SCREEN OR SIEVE SIZE

- PLACE CONTROLLED STRUCTURAL FILL IN UNIFORM UF15 AND COMPACT TO A MINIMUM OF 95% OF THE MAXIMUM DENSITY IN ACCORDANCE WITH ASTM 01557 "MODIFIED PROCTOR DRISH". 8 8 8 26 4 90:100 35:70 5:35
- PROVIDE SITE GRADING AROUND THE PERMETER OF THE BUILDING TO PROVIDE POSITIVE DRAINGE AWAY FROM THE FOUNDATION DURING AND AFTER CONSTRUCTION.
- COMPACT CONTROLLED STRUCTURAL FILE IN
  ACCOBDANCE WITH THE POLLOWING SCREDUL AND
  ASTM D 1.557. USE ONLY NAMEO OPERATED SCUIPHENT
  ADJACENT TO WALLS. FILL BOTH SIDES OF WALLS TO
  COUAL ELEVATIONS BEFORE COMPACTING. MANTAN THE INTEGRITY OF NATURAL SOILS AND CONTROLLED STRUCTURAL FILLS DURING CONSTRUCTION. PROTECT FOOTING AND STRUCTURE SUBGRADES ASSASS TREEZING AND EXCESSIVE WITTING. REMOVE AND EXCESSIVE WITTING. REMOVE AND EXCESSIVELY WIT SUBGRADE MATERIALS.

DEGREE OF COMPACTION: COMPACT TO THE FOLLOWING MINIMUM DENSITIES:

FIFE BEDDING
DESIDE STRUCTURE FOUNDATION WALLS.
TANK WALLS AND RETAINING WALLS
UNDER FIFES THROUGH STRUCTURAL FILLS
UNDER DRAIN FILTER SAND OP 2 FEET UNDER FAVEMENT SELOW TOT 2 FEET UNDER FAVEMENT RENCHES THROUGH UNPAVED AREAS FILL AND BACKFILL LOCATION

NOTE STRUCTURE FOUNDATIONS DENSITY \$ 50 \$ 06 \$ 06

MAXIMUM DENSITY: ASTMD I 557, MODIFIED.

(NUCLEAR METHODS). FIELD DENSITY TESTS: ASTMD 1556 (SAND CONE), ASTMD 2167 (RUBBER BALLOON), OR ASTMD 2922

CONTRACTOR IS REQUIRED TO CONFORM TO OSHA
(29 PART 1926 650-652) SUBPART P CONSTRUCTION
STANDARD FOR EXCAVATIONS:

# GENERAL STRUCTURAL NOTES

ALL WORK SHALL CONFORM TO THE REQUIREMENTS OF ALL APPLICABLE STATE AND LOCAL CODES, INCLUDING BUT NOT LIMITED TO.

INTERNATIONAL RESIDENTIAL CODE: 2003 ED.

ANSI-SECE 7-02.

ACI 31-99 "BUILDING CODE REQUIREMENTS FOR REINFORCED CONCRETE.

ACI 301-99 "ECIPICATIONS FOR STRUCTURAL CONCRETE FOR BUILDINGS."

BUILDINGS."

.AISC STEEL CONSTRUCTION MANUAL .AISI COLD FORMED STEEL DESIGN MANUAL .ANSI .AF4PA NDS-1997

ROOF DESIGN LOADS: SNOW LOAD 46 PSF
DEAD LOAD 15 PSF
TOTAL ROOF LOAD 61 PSF BALANCED

3. FLOOR DESIGN LOADS: LIVE LOAD 40PSF 10 PSF BALLANCED TOTAL FLOOR LOAD 50 PSF BALLANCED

ALL WORK SHALL BE FERFORMED BY PERSONS QUALIFIED IN THEIR TRADE AND LICENSED TO PRACTICE SUCH TRADE IN THE STATE IN WHICH THE PROJECT IS LOCATED. CONTRACTOR SHALL BRING TO THE ATTENTION OF THE ENGINEER AIN CONDITIONS DIFFERENT FROM THOSE SHOWN ON THE DRAWNIGS AND ALSO AIN CONDITIONS THAT RECINIT THE CONTRACTORS CONSTRUCTION OF THE WORK AS SHOWN ON THE CONSTRUCTION DRAWNIGS.

6. ALL DIMENSIONS, ELEVATIONS, AND CONDITIONS SHALL BE VERIFED IN THE FIELD BY GENERAL, CONTRACTOR (G.C.) AND ANY DISCREPANGES SHALL BE PROJECT TO THE ATTENTION OF THE ENGINEER FOR CLAREFICATION BEFORE PROCEEDING WITH THE AFFECTED PART OF THE WORK.

UNLESS OTHERWISE NOTED. DETAILS, SECTIONS, AND NOTES SHOWN ON ANY DRAWING SHALL BE CONSIDERED TYPICAL FOR

THESE DRAWINGS DO NOT SHOW SIZE, LOCATION OR THTE OF DETWING IN THE POUNDATION SYSTEM FOR ELECTRICAL, PLUMBING OR MECHANICAL EQUIPMENT THE GENERAL CONTRACTOR SHALL BE RESPONSIBLE FOR LOCATING THESE ITEMS ALL SIMILAR DETAILS.

USE PERIMETER DRAINS WHERE SHOWN, DRAIN TO APPROPRIATE OUTLET.

## PROJECT: SPIKE RESIDENCE GARAGE 304 CAPISIC ST FOR: BEN AND CORINA SPIKE

SHEET TITLE: ISSUED FOR CONSTRUCTION CENERAL NOTES

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Falmouth, Maine 04105 Fax: (207) 878-1788
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PARTNERS INC.

ASSOCIATED DESIGN

No. BY DESCRIPTION  DATE  DATE  COLE : AS NOTED  DESIGN BY: AS  PROJECT NUMBER:  OSOS7-DWG-\$301.DW  AN 200597-050577-DWG-\$301.DW
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