

LIGHTING CONTACTOR

OCCUPANCY SENSOR

1. NORMAL ANGLE 2. WIDE ANGLE


3. 360° COVERAGE

OCCUPANCY SENSOR RELAY

HOME RUN

PHOTOELECTRIC CONTROL


UNSWITCHED CONTINUATION OF BRANCH CIRCUIT

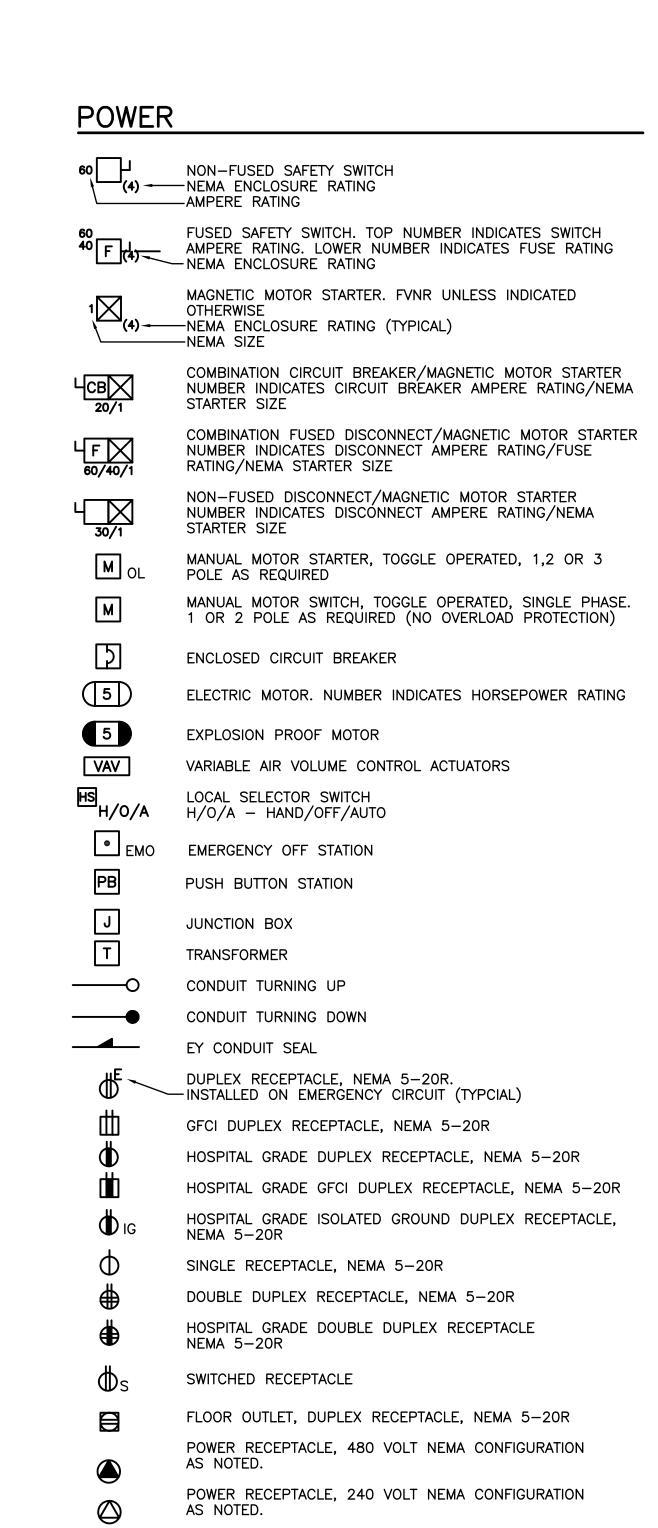

PANELBOARD, NORMAL POWER

PANELBOARD, EMERGENCY POWER

| T | TELEPHONE SYSTEM WALL JACK. MOUNT 18" AFF. W-INDICATES WALL MOUNTED AT 60" AFF. P-INDICATES PAYPHONE. | | | | | |
|-------------------------|---|--|--|--|--|--|
| ∇ | DATA SYSTEM OUTLET. MOUNT 18" AFF. | | | | | |
| $oldsymbol{\Lambda}$ | VOICE/DATA SYSTEM OUTLET | | | | | |
| TV | TELEVISION | | | | | |
| CATV | CATV TELEVISION SYSTEM OUTLET. MOUNT 84" AFF UNLESS OTHERWISE NOTED. | | | | | |
| PA | PAGING SYSTEM CONTROL PANEL AND PAGING AMPLIFIER | | | | | |
| \$ | PAGING SYSTEM SPEAKER. CEILING MOUNTED. | | | | | |
| ⊢\$ ₁ | PAGING SYSTEM SPEAKER. WALL MOUNT AT 7'-6" AFF. 1. FLUSH 2. SURFACE 3. HORN 4. DUAL HORN | | | | | |
| VC | VOLUME CONTROL | | | | | |
| CS | CLOCK SPEAKER | | | | | |
| © ₁ | WALL MOUNTED CLOCK | | | | | |
| 1 | UNDERFLOOR VOICE & DATA OUTLET | | | | | |
| -\$- | CEILING DATA OUTLET | | | | | |
| SFC | URITY SYSTEMS | | | | | |
| <u> </u> | | | | | | |
| <u>323</u> | DOOR CONTACT | | | | | |
| | DOOR CONTACT CARD READER | | | | | |
| CR | | | | | | |
| CR KP | CARD READER | | | | | |
| CR KP | CARD READER KEY PAD | | | | | |
| CR KP | CARD READER KEY PAD CLOSED CIRCUIT TELEVISION CAMERA | | | | | |

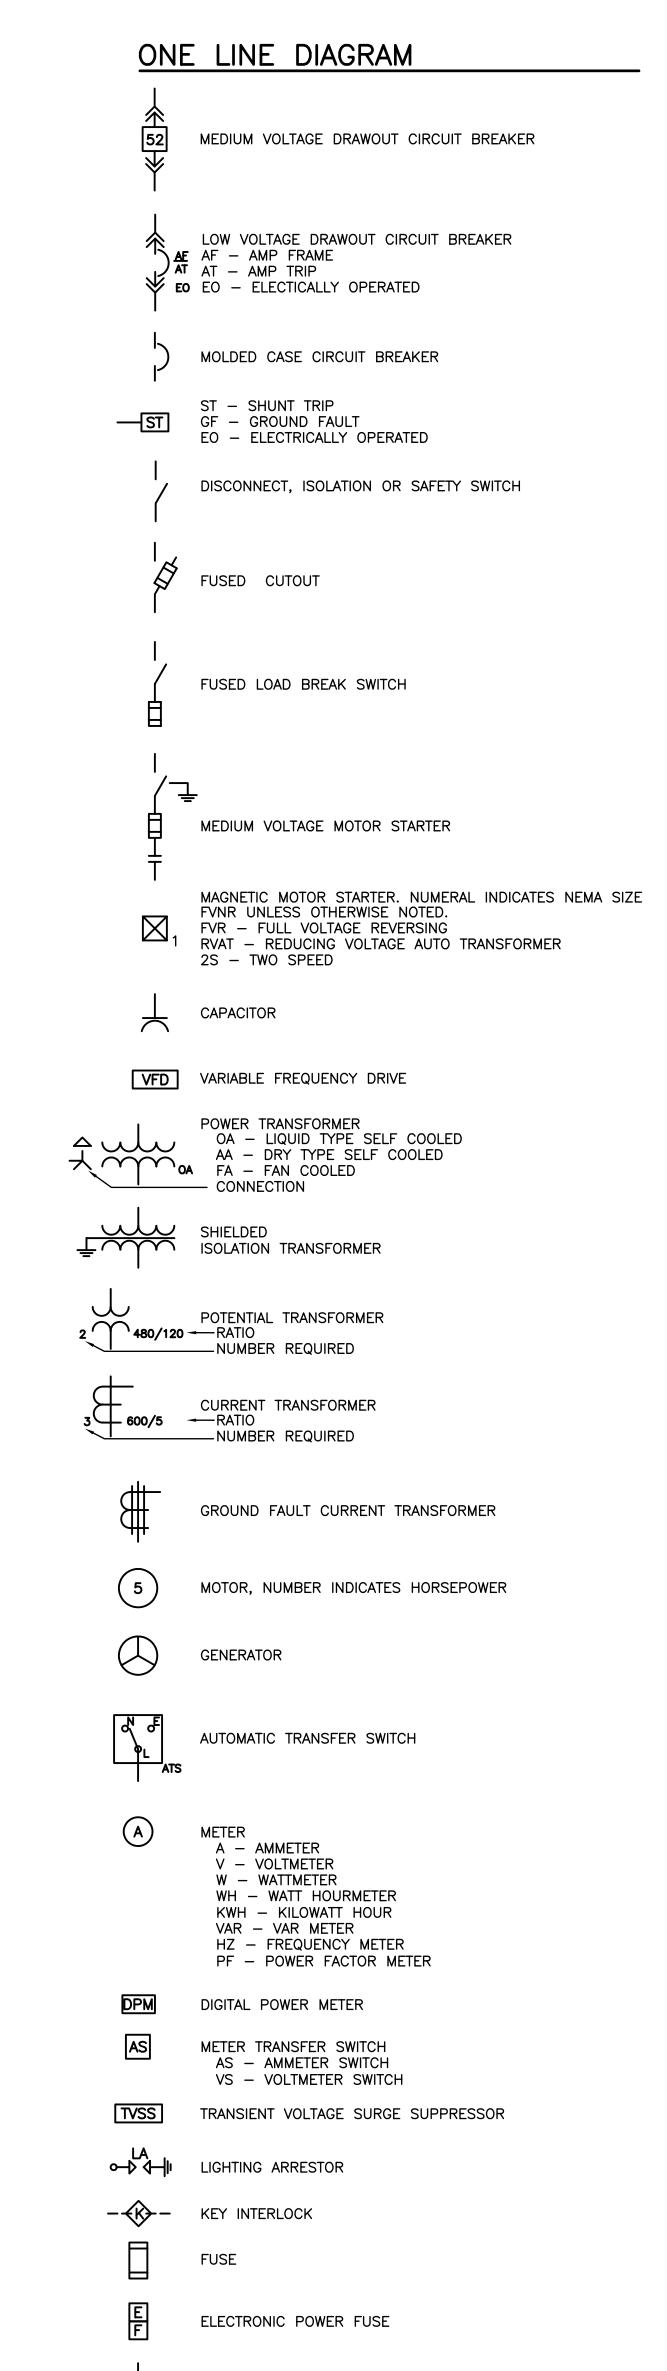

ABBREVIATIONS AMPERE ABOVE FINISHED FLOOR ABOVE FINISHED GRADE AUTHORITY HAVING JURISDICTION AMPERE INTERRUPTING CAPACITY AMERICAN WIRE GAUGE BELOW FINISHED GRADE BOTTOM OF STEEL CONDUIT, CONDUCTOR CABLE TELEVISION CIRCUIT BREAKER CLOSED CIRCUIT TELEVISION CONTROL POWER TRANSFORMER CURRENT TRANSFORMER DIGITAL ALARM COMMUNICATOR TRANSMITTER DIRECT BURRIED DISCONNECT ELECTRICAL METALLIC TUBING ELECTRIC WATER COOLER FIRE ALARM ANNUNCIATOR FIRE ALARM CONTROL PANEL FURNISHED BY OTHERS FURNISHED WITH EQUIPMENT GENERATOR GROUND FAULT CIRCUIT INTERRUPTER GROUND HORSE POWER HEATER ISOLATED GROUND INTERMEDIATE METAL CONDUIT KILOVOLT KILOVOLT-AMPERE KILOVOLT AMPERE REACTIVE KILOWATT KILOWATT-HOUR LIGHTNING ARRESTER LIGHTING METAL CLAD MAIN CIRCUIT BREAKER MANUFACTURER MINERAL INSULATED MAIN LUG ONLY MOUNTED MEDIUM VOLTAGE NORMALLY CLOSED NEGATIVE NEUTRAL NOT IN CONTRACT NORMALLY OPEN NOT TO SCALE POWER FACTOR POLYVINYL CHLORIDE RIGID STEEL CONDUIT RESISTANCE TEMPERATURE DETECTOR SOLID NEUTRAL SHIELDED TWISTED PAIR SHIELDED TWISTED TRIPLET SWITCHBOARD SWITCHGEAR TOP OF STEEL TRANSFORMER TRANSIENT VOLTAGE SURGE SUPPRESSER TVSS VOLT-AMPERE VOLT-AMPERE REACTIVE WATT METER WEATHER PROOF EXPLOSION PROOF

GENERAL NOTE

1. ALL GENERAL NOTES, SYMBOL LISTS, AND DETAILS ARE TO

FOR THIS PROJECT. SYMBOLS AND ABBREVIATIONS SHOWN

ON THIS SHEET ARE FOR REFERENCE ONLY AND DO NOT

INDICATE THEIR INCORPORATION IN THE DESIGN.

BE CONSIDERED AS APPLICABLE TO ALL ELECTRICAL DRAWINGS

GENERAL NOTES: ALL WORK SHALL BE PERFORMED IN ACCORDANCE WITH NFPA-70, NATIONAL ELECTRICAL CODE (NEC). 2. ALL MOTOR SAFETY SWITCHES, DISCONNECTS AND MOTOR STARTERS ARE PROVIDED BY DIVISION 16000 UNLESS NOTED AS FURNISHED WITH EQUIPMENT (FWE). . UNLESS OTHERWISE NOTED CONVENIENCE RECEPTACLES SHALL BE MOUNTED 18-INCHES AFF, LIGHTING TOGGLE SWITCHES 48-INCHES AFF, DATA SYSTEM OUTLETS 18-INCHES AFF, FIRE ALARM NOTIFICATION DEVICES 80-INCHES AFF OR 6-INCHES BELOW CEILING, WHICHEVER IS LOWER, AND FIRE ALARM MANUAL PULL STATIONS 48-INCHES AFF TO TOP OF DEVICE. 4. ALL PENETRATIONS THROUGH FLOORS, RATED WALLS AND PARTITIONS SHALL BE SEALED WITH UL APPROVED FIRE SEALANT MATERIAL TO MAINTAIN THE RATING OF THE SEPARATION. 5. ALL ENCLOSURES, CONDUIT BODIES AND THEIR COVERS CONTAINING FIRE ALARM SYSTEM CONDUCTORS SHALL BE PAINTED RED. 6. AN EQUIPMENT GROUNDING CONDUCTOR SHALL BE INSTALLED WITH EVERY FEEDER AND BRANCH CIRCUIT. '. UNLESS OTHERWISE NOTED WIRING SHALL BE 2 #12 AWG CONDUCTORS & #12 GND. HOME RUNS FED FROM 20A-1P CIRCUITS IN EXCESS OF 100 FEET SHALL BE #10 AWG. 8. FLEXIBLE CONNECTIONS TO MOTORS SHALL BE LIQUID TIGHT FLEXIBLE METAL CONDUIT IN A 360 DEGREE LOOP. 9. LIGHTING TOGGLE SWITCHES SHALL BE COMMERCIAL SPECIFICATION GRADE 120/277 VOLT, SIDE WIRED AND PROVIDED WITH GROUNDING SCREW. 20 OR 30 AMP AS REQUIRED. LEVITON, PASS AND SEYMOUR OR APPROVED EQUAL. COORDINATE COLOR WITH ARCHITECT. 10. CONVENIENCE RECEPTACLES SHALL BE COMMERCIAL SPECIFICATION GRADE GROUNDING TYPE NEMA 5-20R. SIDE WIRED. LEVITON, PASS AND SEYMOUR OR APPROVED EQUAL. COORDINATE COLOR WITH ARCHITECTS. 11. PROVIDE WALL PLATES FOR ALL WIRING DEVICES. COORDINATE COLOR WITH ARCHITECT. 12. UNLESS OTHERWISE NOTED ALL WIRING SHALL BE 600V, COPPER WITH THHN/THWN INSULATION. 13. PROVIDE UPDATED TYPED PANEL SCHEDULES FOR ALL PANELS BEING MODIFIED. BREAKERS BECOMING SPARE UPON REMOVAL OF EQUIPMENT OR DEVICES SHALL BE LABELLED AS "SPARE". ISSUED FOR CONSTRUCTION 6-2-03 DESCRIPTION ISSUED FOR CONSTRUCTION 6-2-03 CURRENT ISSUE STATUS

ARCHITECTURE ENGINEERING PLANNING 144 Fore Street/P.O. Box 618

PROJECT:

Portland, Maine 04104 tel. (207) 772-3846

fax. (207) 772-1070 UNUMPROVIDENT HO1

THE BEACON PORTLAND, ME.

LEGEND, GENERAL NOTES & LIGHT FIXTURE SCHEDULE

SHEET TITLE: SCALE: NO SCALE PROJECT MANAGER: GRAPHIC SCALE: JOB CAP/DRAWN: RJL/JAC A/E OF RECORD: DJT SHEET No. E - 001SMRT CAD FILE: E-001-02140 PROJECT No. 02140

| LIGHT FIXTURE SCHEDULE | | | | | | | |
|------------------------|---|---------------------------|--------------------|----------|-------|--|--|
| TYPE | DESCRIPTION | MFR. | LAMPS | MOUNTING | NOTES | | |
| А | 2x4 PARABOLIC TROFFER W/ SEMI-SPECULAR REFLECTOR, 24 CELL, 3" DEEP LOUVER. 277V | COLUMBIA P424 SERIES | 3-F32T8 3500K | RECESSED | | | |
| В | 8" ROUND APERTURE DOWNLIGHT W/ CLEAR ALZAK REFLECTOR. 277V | PRESCOLITE CFR8 SERIES | 2-26W QUAD TUBE | RECESSED | | | |

DEMOLITION PLAN

1/8"=1'-0"

GROUND

DRAWOUT DEVICE