



1/16"=1'-0" 5 0 10 20 30 40ft 1/8"=1'-0" 5 0 5 10 15 20ft 1/4"=1'-0" 2 0 2 4 6 8 10ft 1/2"=1'-0" 0 1 2 3 4 5ft 3/4"=1'-0" 0 1 2 3ft 1"=1'-0" 0 1 2ft 1 1/2"=1'-0" 0 1 2ft 3"=1'-0" 0 1ft

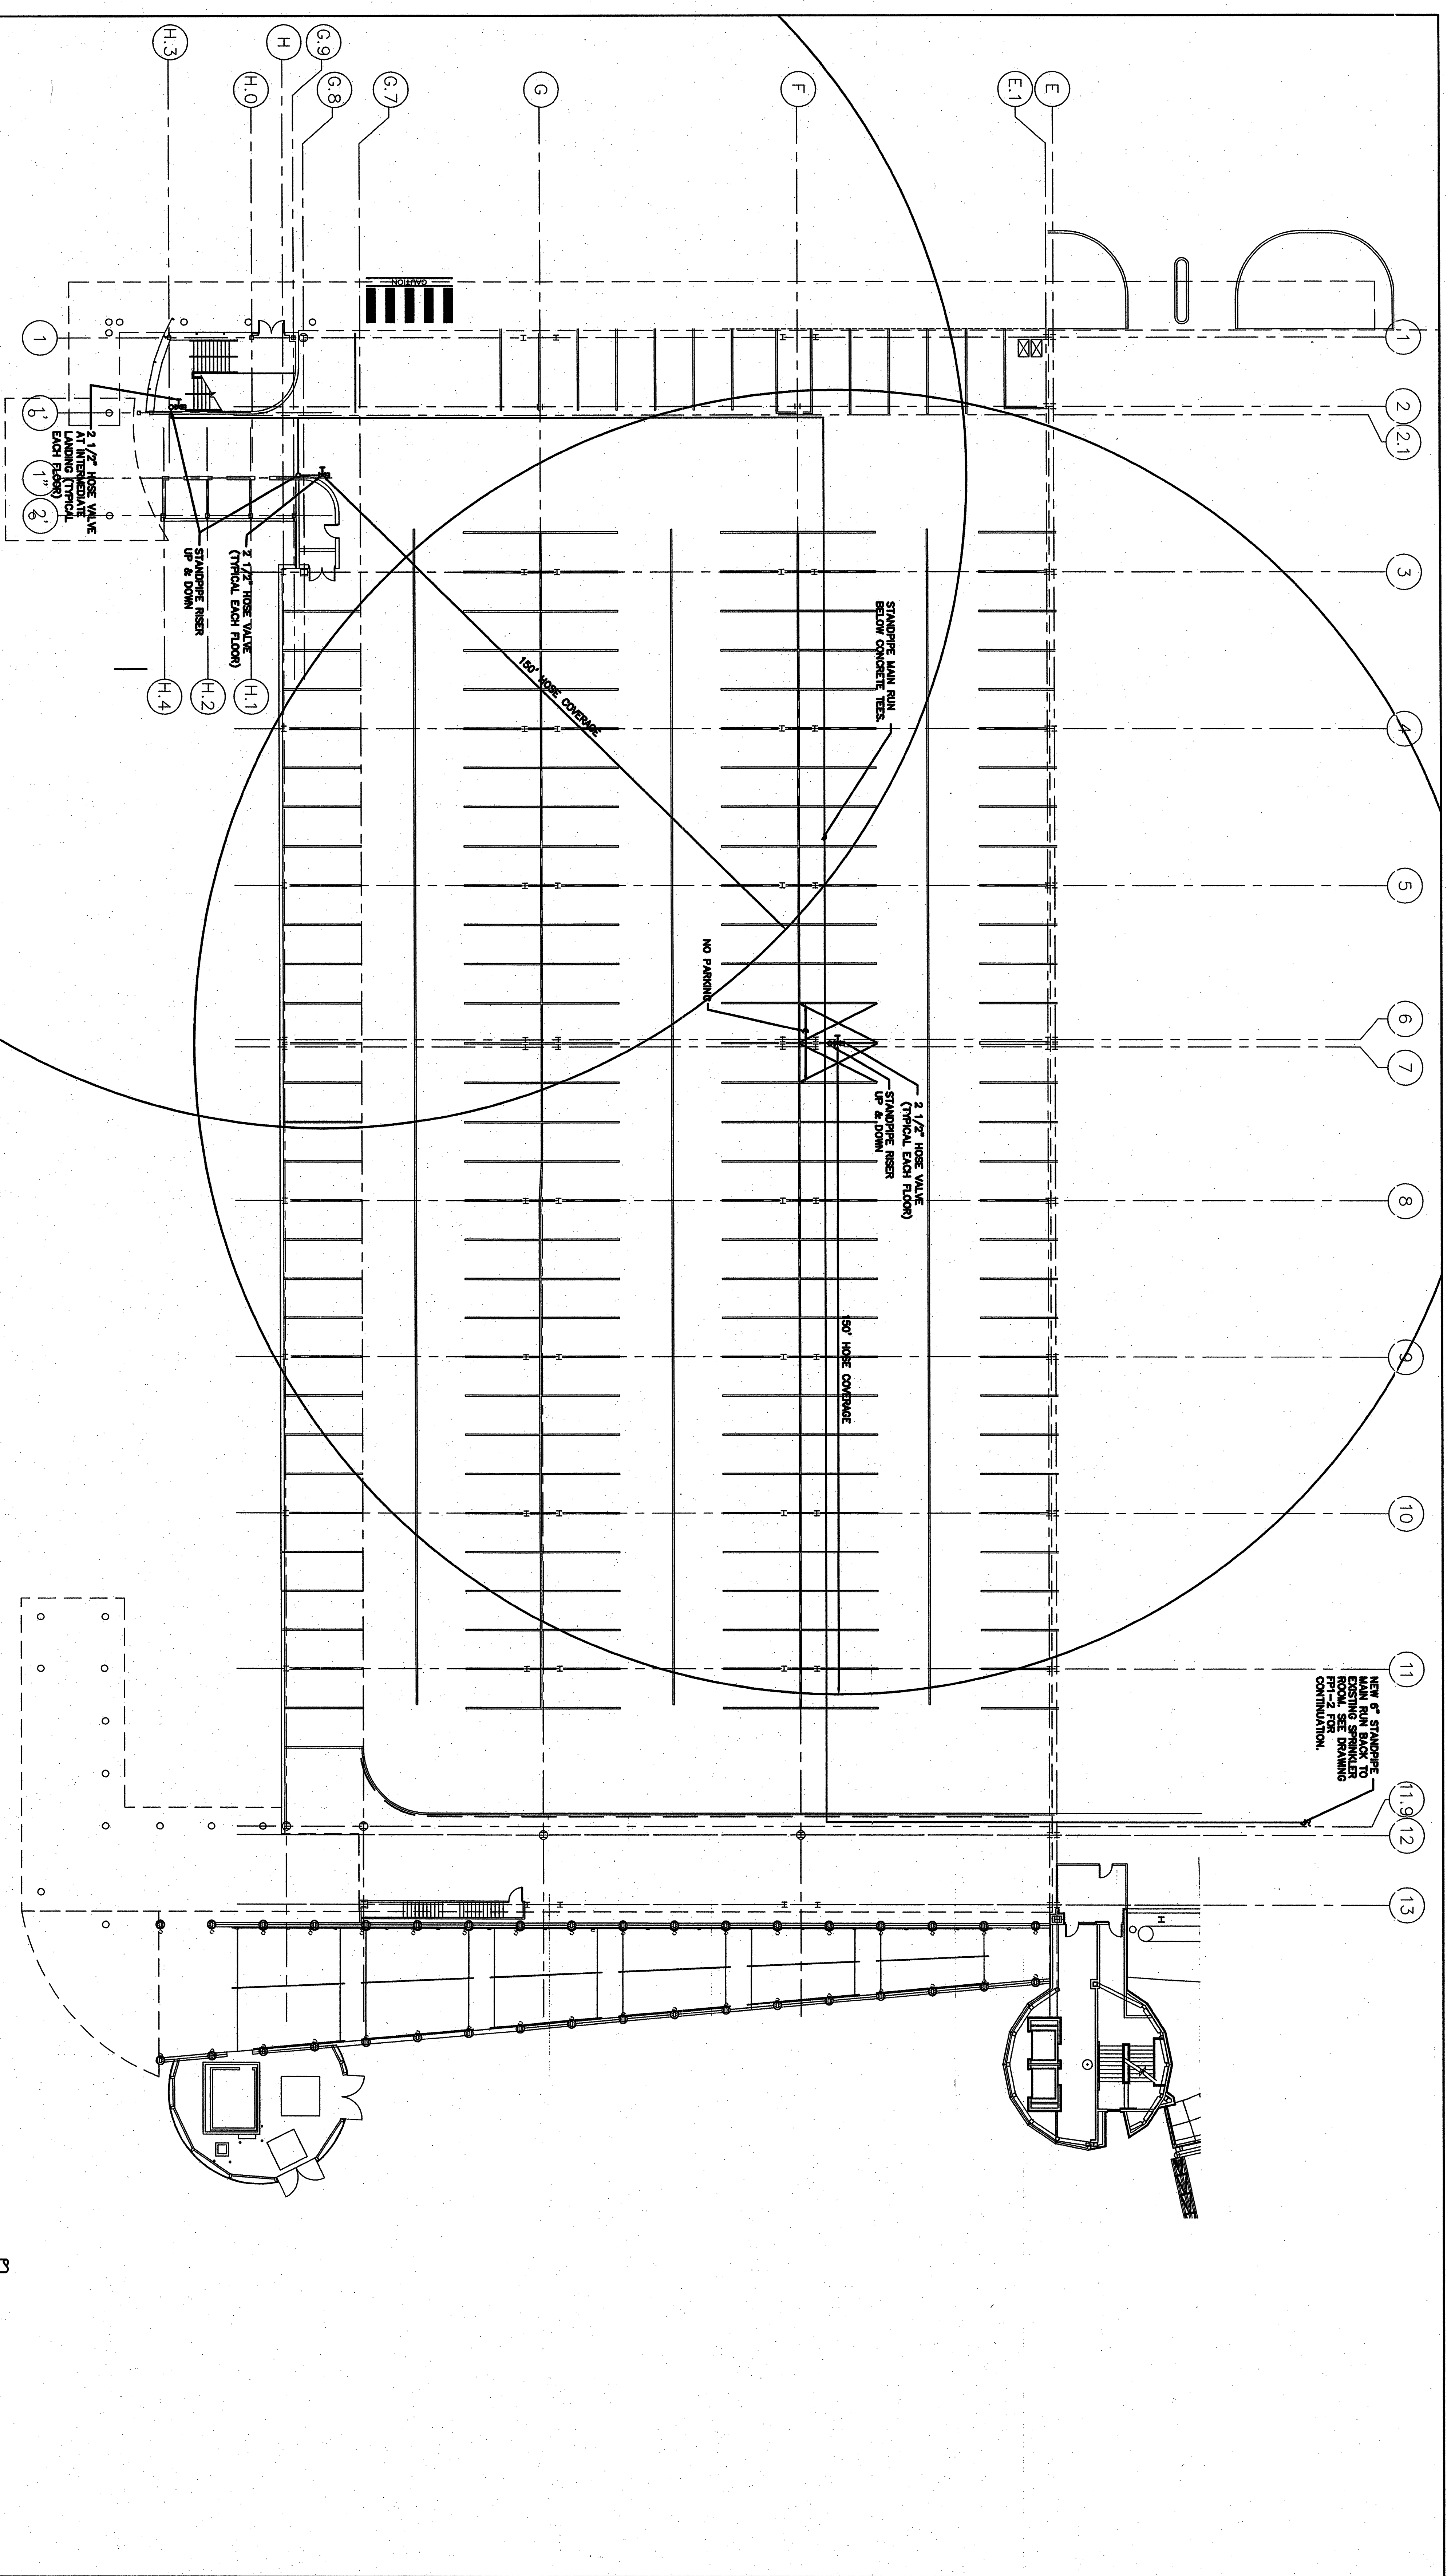


FIRE PROTECTION PLAN - LEVEL 1
SCALE: 1/16"=1'-0"

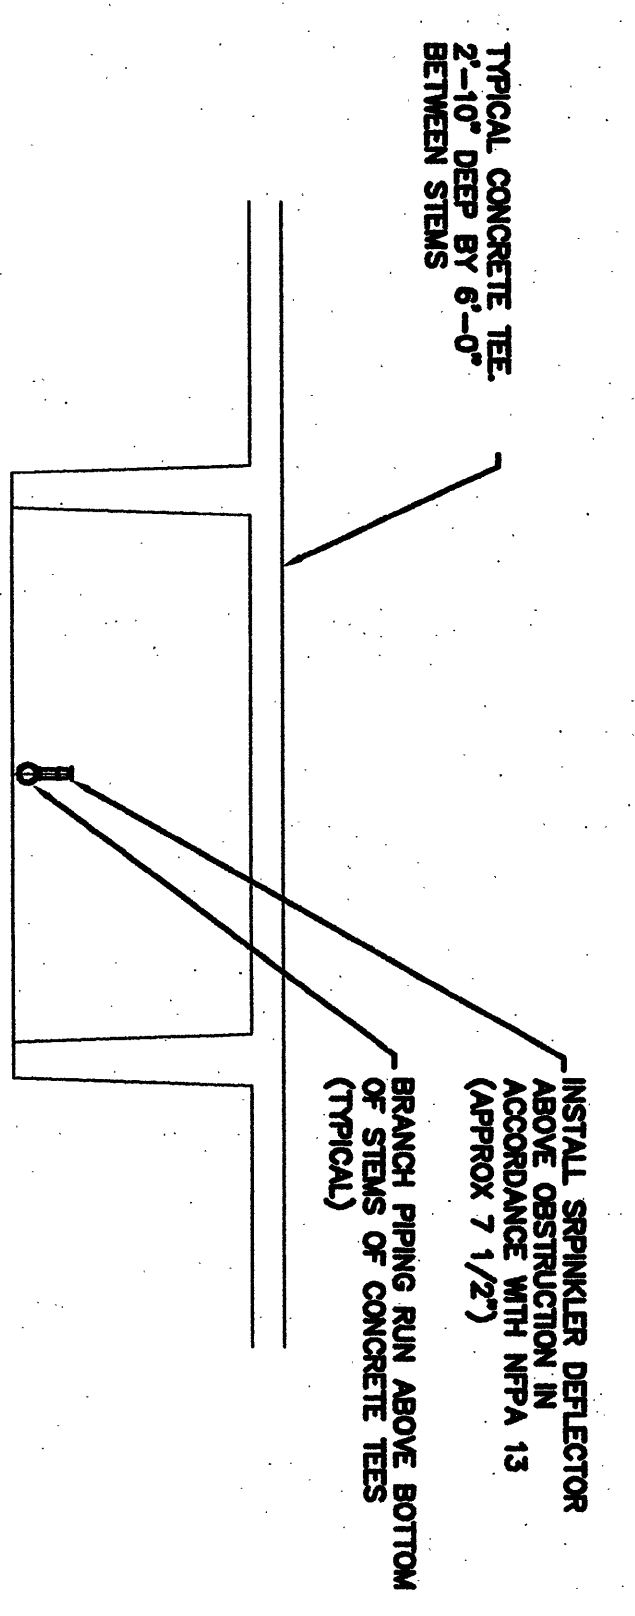


SPRINKLER BRANCH PIPING CONCRETE TEES (TYPICAL)
SCALE: 1/2"=1'-0"

NEW STANDPIPE MAIN SHALL BE ADDED TO EXISTING SPRINKLER PLAN. SEE DRAWING FOR SPRINKLER CONTRIBUTION.

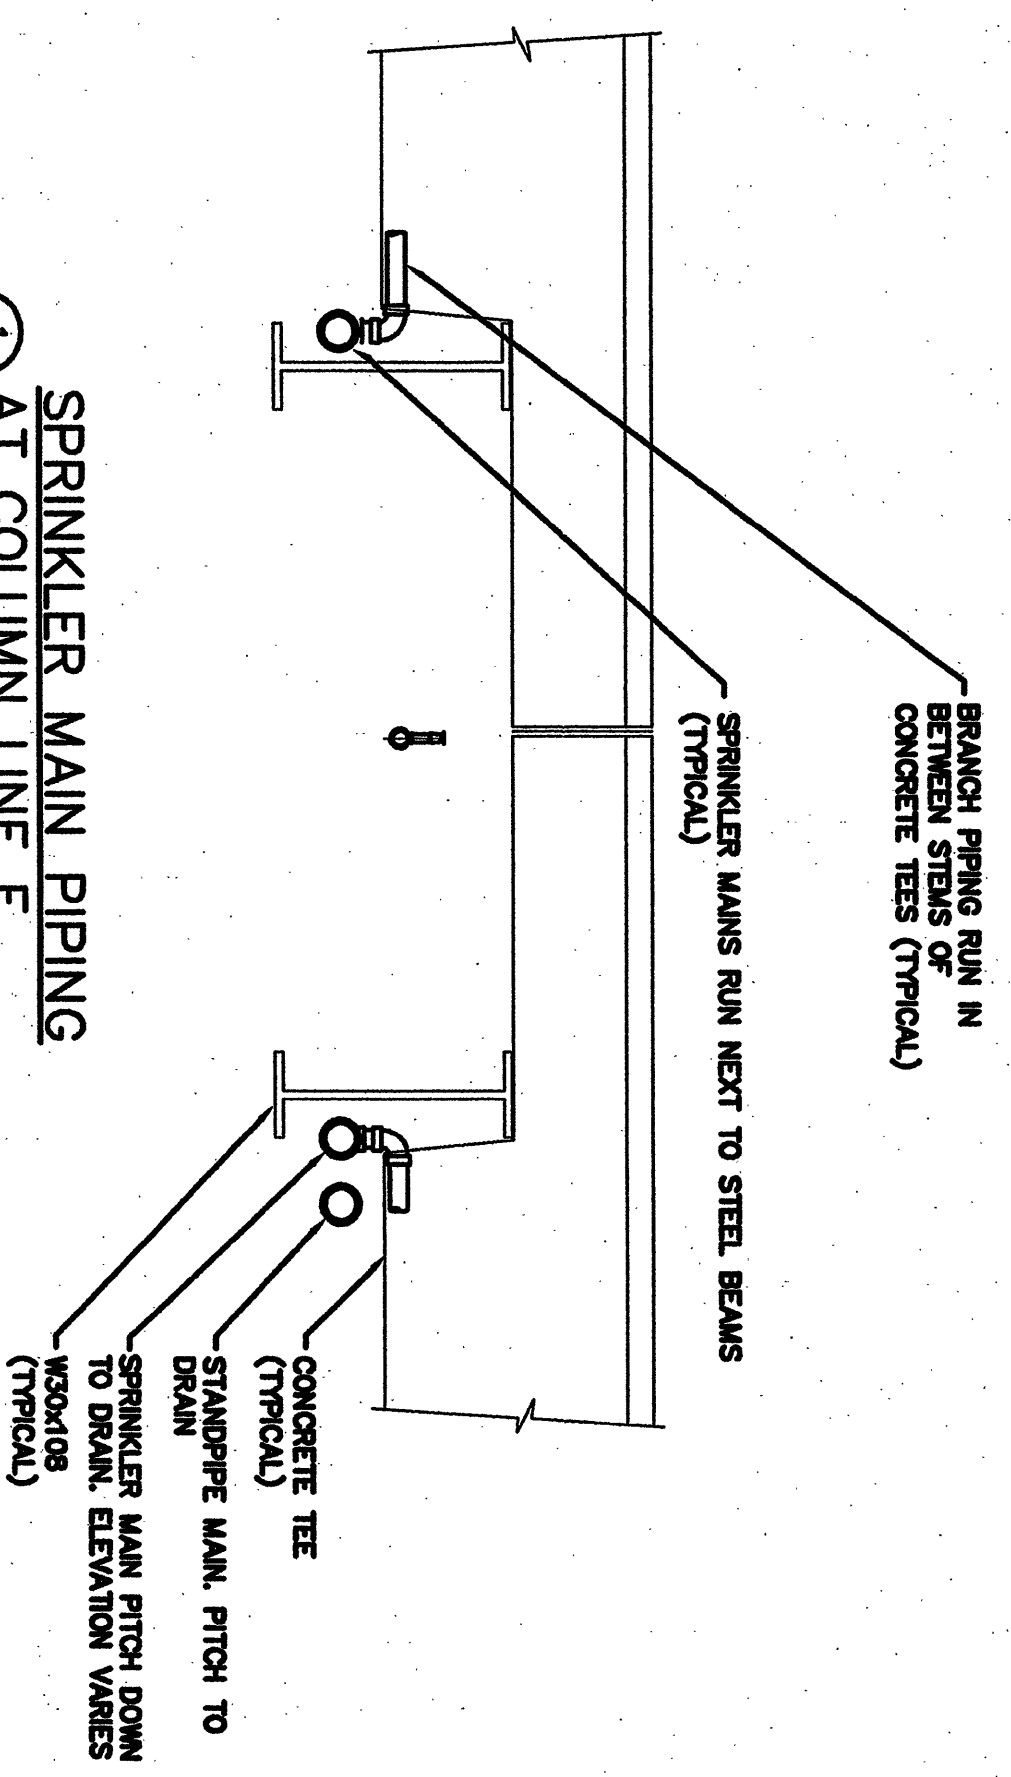

SPRINKLER MAIN PIPING AT COLUMN LINE E
SCALE: 1/2"=1'-0"

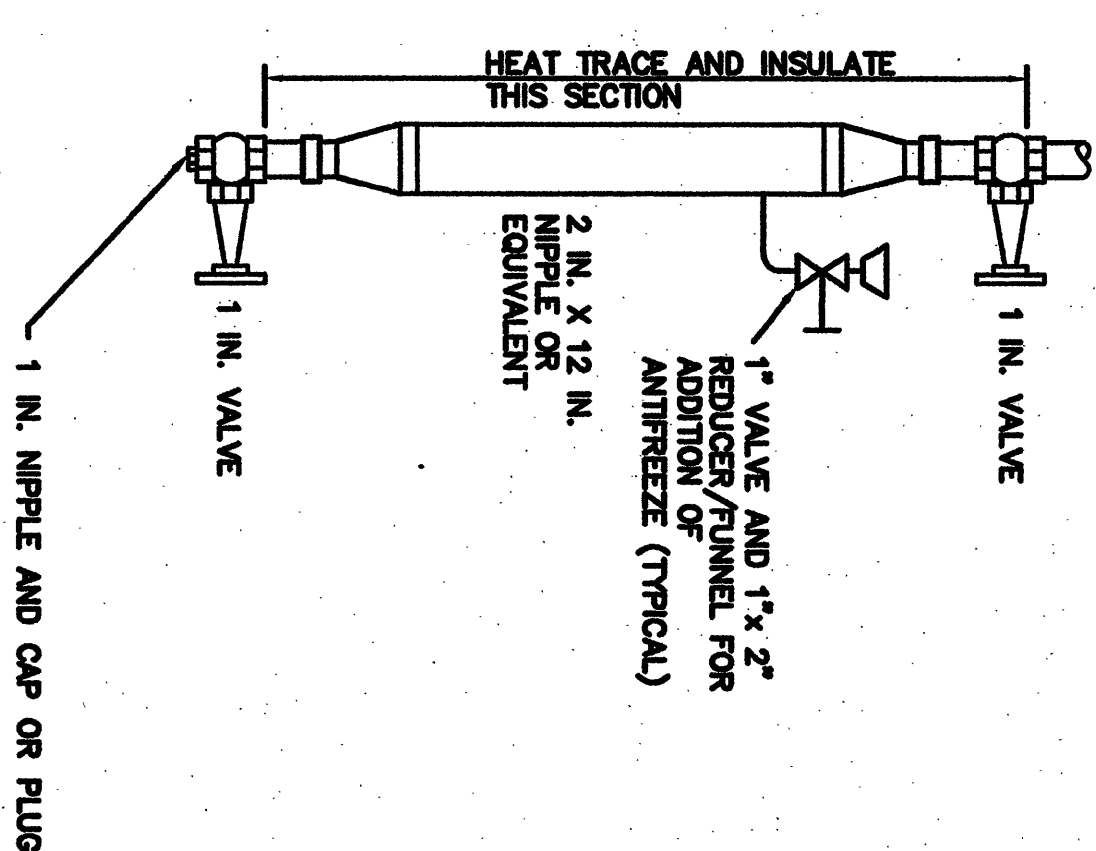

TYPICAL AUXILIARY DRAIN DETAIL
SCALE: NOT TO SCALE


If this sheet is less than 30"x42" in size, it has been reduced. Graphic scales must be adjusted accordingly.

DOMENECH HICKS & KROCKWALNIC ARCHITECTS
155 Massachusetts Ave.
Boston, MA 02115
617-267-6408
Fax: 617-267-1990

Stantec
Stantec Consulting Services Inc.
22 Free Street, Suite 205
Portland, ME USA
04101-3900
Tel: 207-775-9311
Fax: 207-775-9434
www.stantec.com

CONFORMED SET FOR FIELD USE

CITY OF PORTLAND
PORTLAND, MAINE
DEPARTMENT OF WATERFRONT AND TRANSPORTATION

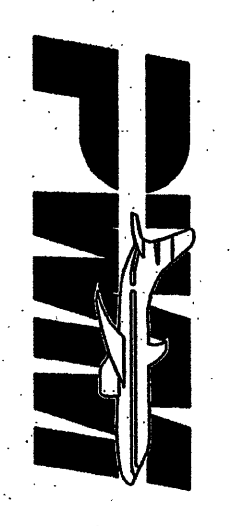

PORTLAND INTERNATIONAL JETPORT

PHASE II
PARKING GARAGE
1001 WESTBROOK ST.,
PORTLAND, MAINE

LEVEL 1
SPRINKLER/STANDPIPE PLAN

Scale: AS SHOWN	Drawn By: E.D.	Checked By: E.D.	Date: 02/26/08
Project No. 0251028	Sheet No. FP-1-1	Revision:	