


If this sheet is less than 30"x42" in size, it has been reduced. Graphic scales must be adjusted accordingly.

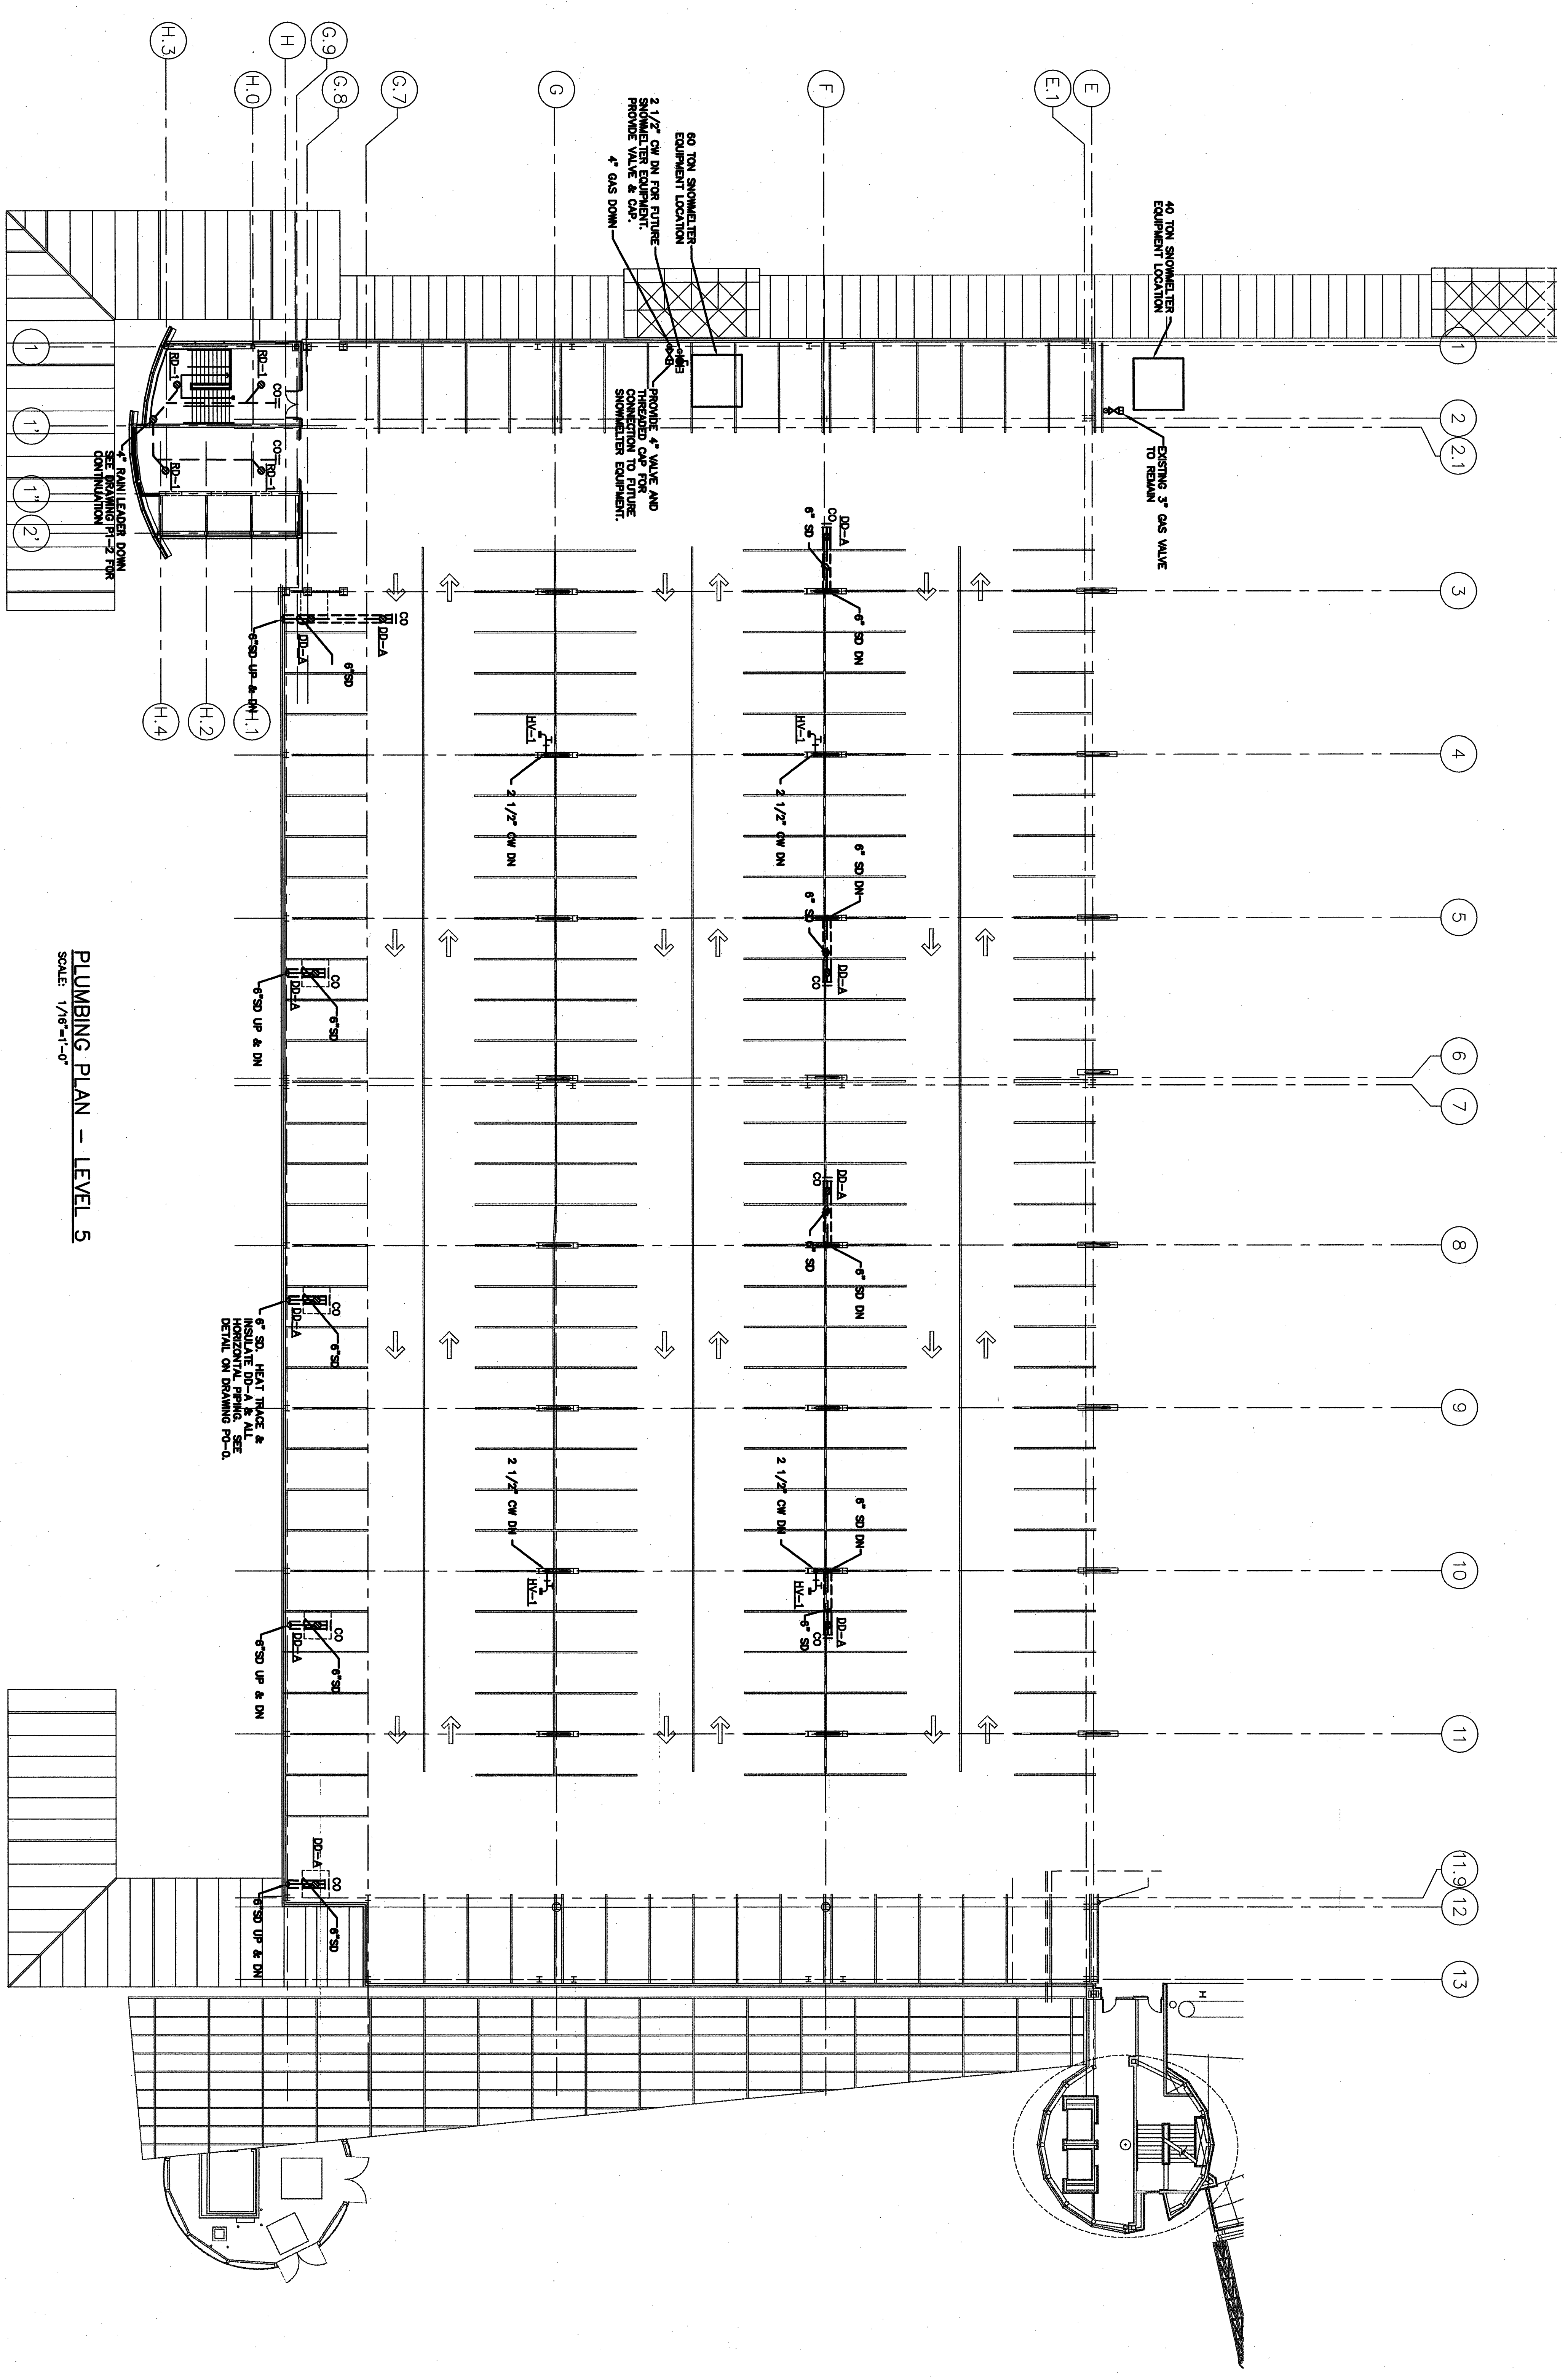

PLUMBING PLAN - LEVEL 5
SCALE: 1/8"=1'-0"

- NOTES:**
1. PROVIDE FIRE SLEEVES FOR DOMESTIC WATER PIPING AND STORM DRAINAGE PIPING IN GARAGE PENETRATING PRECAST CONCRETE DECK. SEAL SPACE BETWEEN PIPE AND SLEEVE WITH FIRE RATED SEALANT. TAPE SEALANT UP PIPE ABOVE GARAGE DECK TO SHED WATER.
 2. RUN HORIZONTAL PIPING AS HIGH AS POSSIBLE BETWEEN STRUCTURAL TEES AND AS CLOSE TO OUTSIDE WALL ON COLUMN LINE H AS POSSIBLE. RUN VERTICAL STORM LEADERS AS CLOSE TO COLUMNS AS POSSIBLE.

<p>DOMENECH HICKS & KROCKMALNIC ARCHITECTS</p> <p>155 Massachusetts Ave. Boston, MA 02115 Tel: 617-267-8408 Fax: 617-267-1890</p>		<p>Stattec Stattec Consulting Services Inc. 22 Free Street, Suite 205 Portland, ME USA Tel: 207-775-3211 Fax: 207-775-0834 www.stattec.com</p>	
<p>CONFORMED SET FOR FIELD USE</p>			
<p>CITY OF PORTLAND PORTLAND, MAINE DEPARTMENT OF WATERFRONT AND TRANSPORTATION</p> <p>PORTLAND INTERNATIONAL JETPORT</p> <p>PHASE II PARKING GARAGE 1001 WESTBROOK ST., PORTLAND, MAINE</p>			
<p>DATE: 10/26/06 DRAWN BY: EJD CHECKED BY: [Signature] DATE: 10/26/06 PROJECT NO.: 022906</p>		<p>STATE OF MAINE REGISTERED PROFESSIONAL ENGINEER PLUMBING No. 10178 Exp. 10/31/08</p>	
<p>LEVEL - 5 PLUMBING PLAN</p>			
<p>P1-3</p>			