

A) OVERLAPS AND SEAMS

B) PROJECTED WATER LINE C) CHANNEL BOTTOM/SIDE

SLOPE VERTICES

STAGGERED 4" (10CM) APART AND 4" (10CM) ON CENTER TO SECURE BLANKETS.

CHANNEL SURFACE.

B 15/2

ANCHOR THE BLANKETS.

ROW OF STAPLES STAGGERED 4" (10CM) APART AND 4" (10CM) ON CENTER OVER ENTIRE WIDTH OF THE CHANNEL.

EROSION CONTROL BLANKET DETAIL FOR CHANNEL INSTALLATION

USING CELL-O-SEED DO NOT SEED PREPARED AREA. CELL-O-SEED MUST BE INSTALLED WITH PAPER SIDE DOWN.

PLACED THROUGH EACH OF THE COLORED DOTS CORRESPONDING TO THE APPROPRIATE STAPLE PATTERN

EROSIONAL CONTROL BLANKET DETAIL FOR SLOPE INSTALLATION


CURLEX BLANKET


EVEN WITH THE COLORED SEAM STITCH ON THE PREVIOUSLY INSTALLED BLANKET.


SLOPE 2:1 MAX. —


NATURAL GROUND OR -FILL OR CUT SLOPES

(15CM) DEEP X 6" (15CM) WIDE TRENCH. BACKFILL AND COMPACT THE TRENCH AFTER STAPLING.

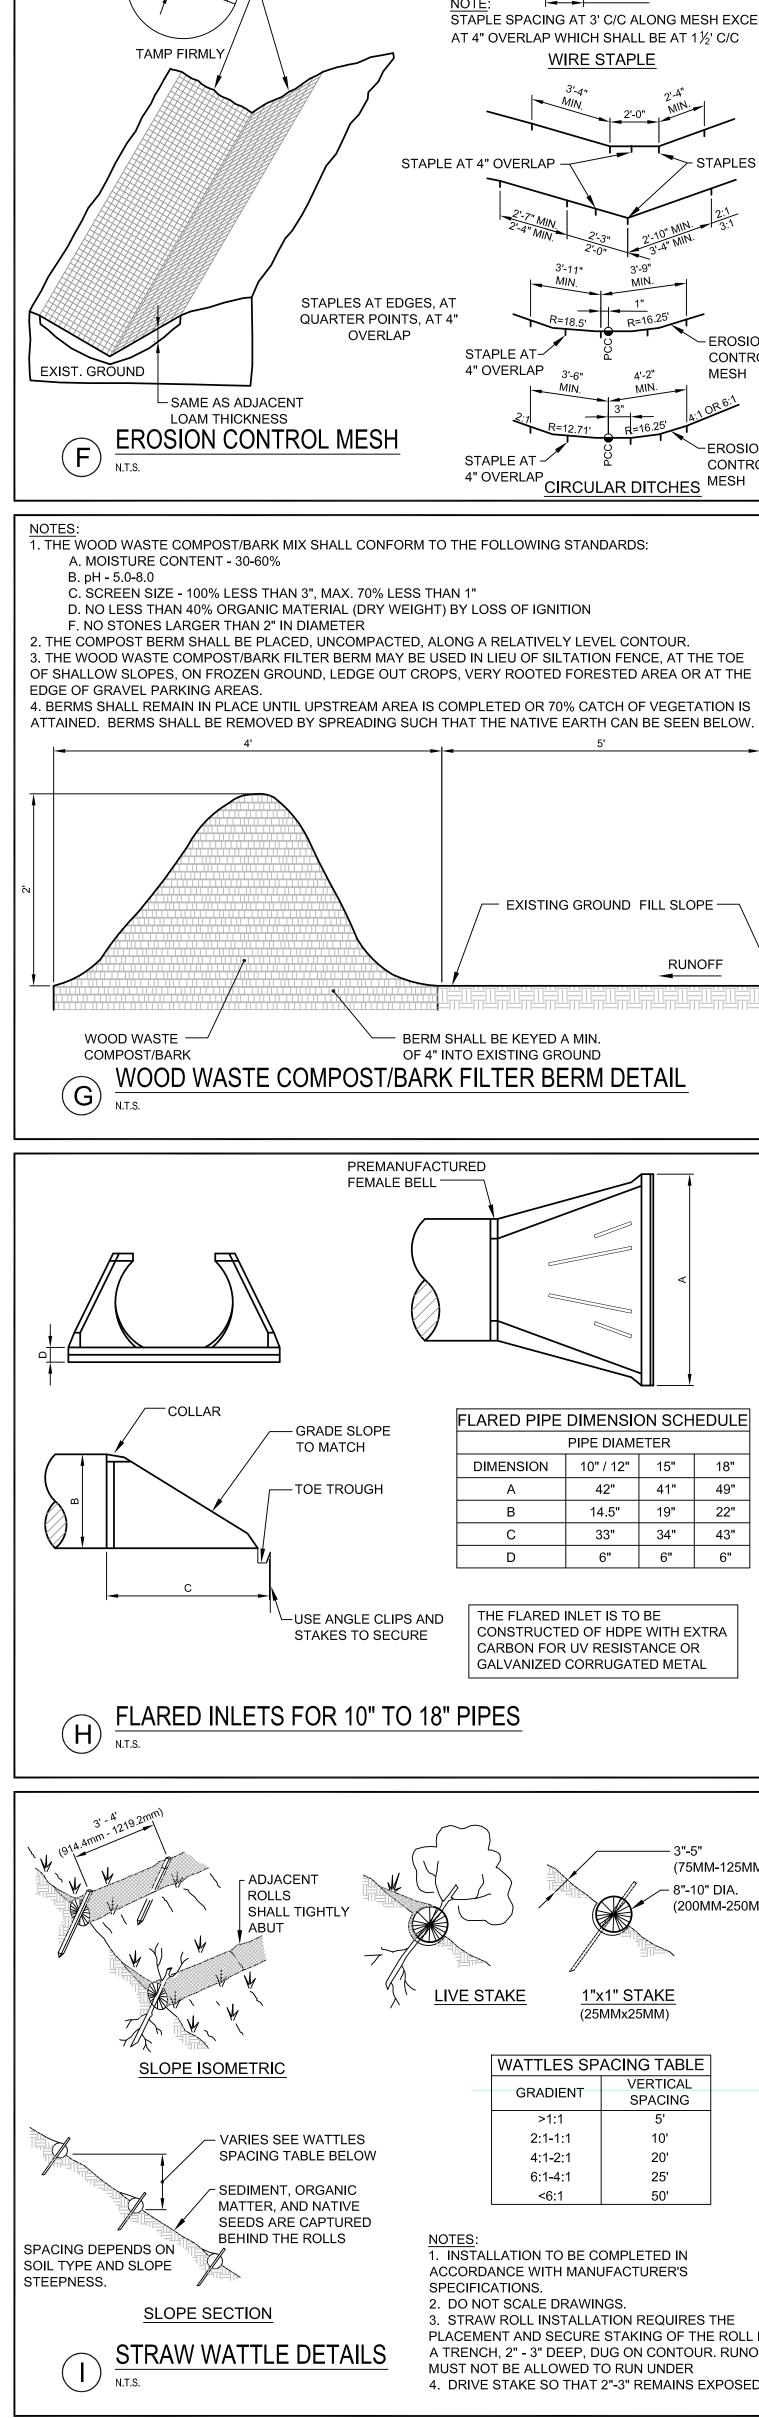

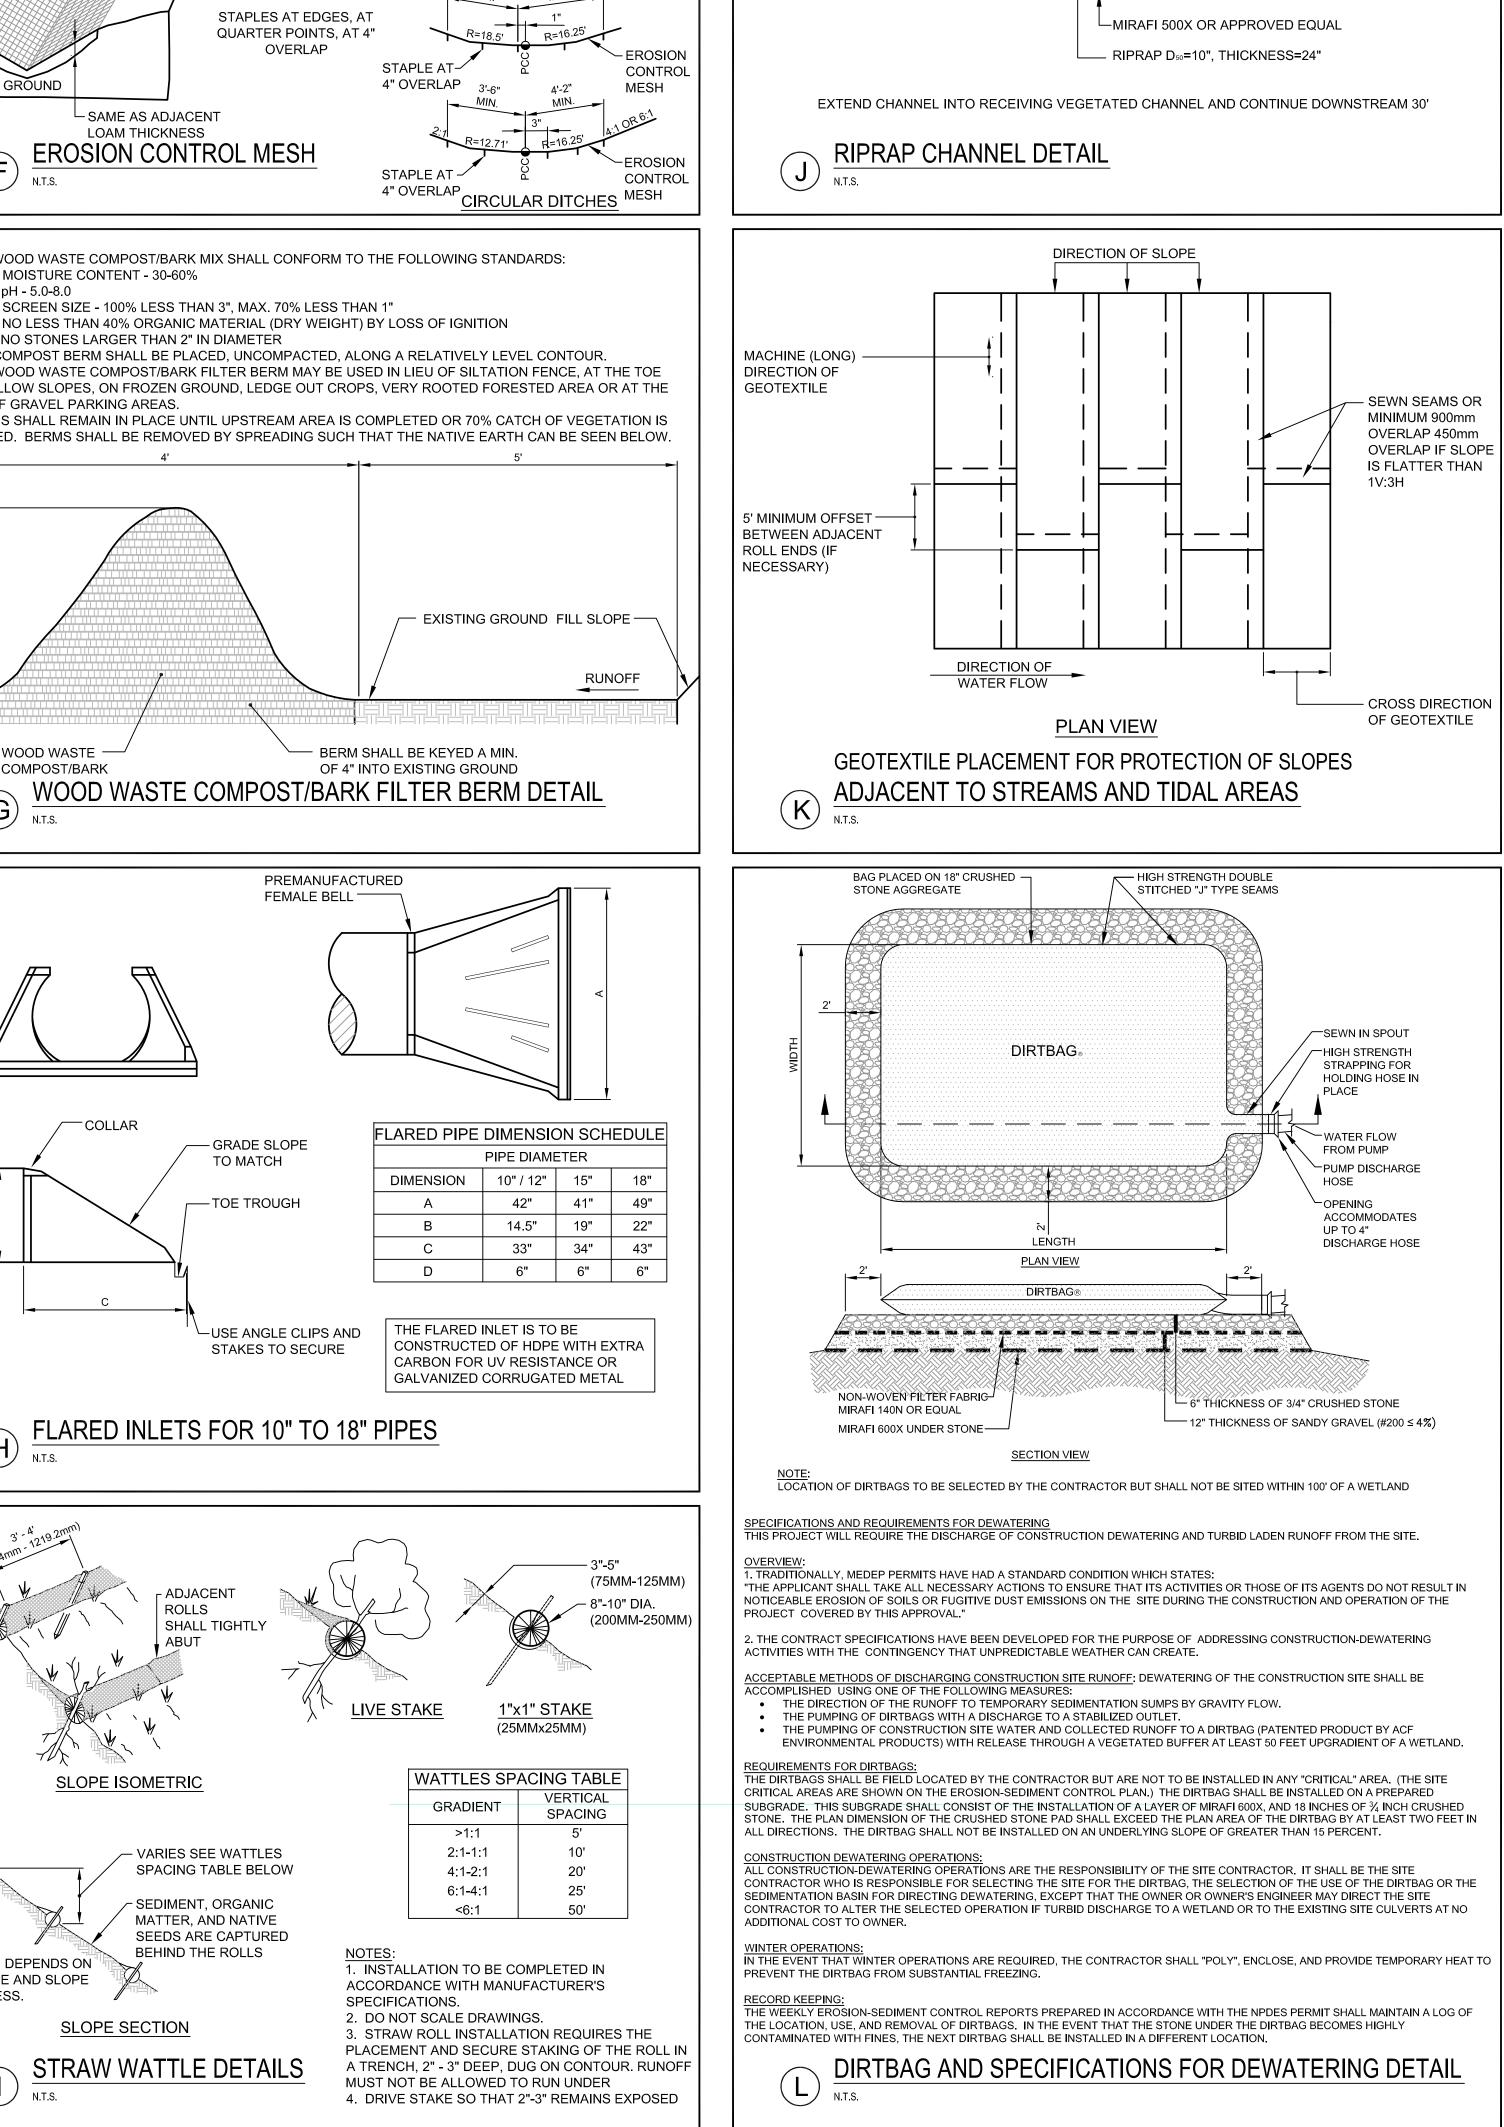

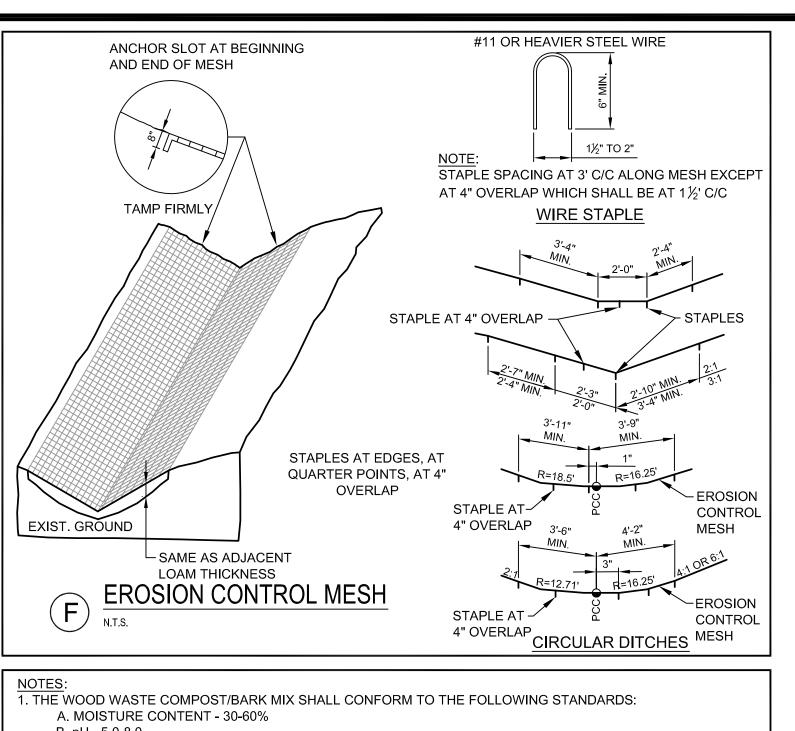

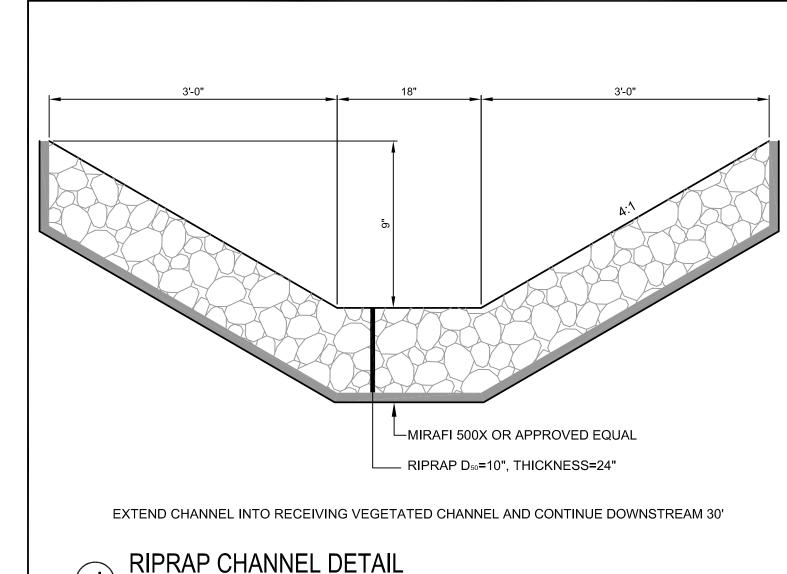

STANTEC CONSULTING SERVICES INC.

C-8.6

**Stantec** 

APRIL 2015

SCALE: N.T.S.

JOB NO. 195350044

482 PAYNE ROAD

DESIGNED: BEK

CHECKED: SRB

DRAWN:

SHEET

WWW.STANTEC.COM

FILE NAME: 2982.05-BS DET

SCARBOROUGH, ME 04074

BRICK NORTH AND SOUTH BUILDINGS A THE FOREFRONT AT THOMPSON'S POINT

**EROSION AND SEDIMENT** 

**CONTROL DETAILS** 

FOREFRONT PARTNERS |, LP

KENNEDY

No. 11994 08.17.16

LAMONES

E. BO KENNEDY

LIC. #11994

08.17.16 FINAL PLAN SUBMISSION TO CITY

APPLICATION

DATE DESCRIPTION

09.01.15 FINAL BRICK SOUTH LEVEL III SITE PLAN

REVISIONS