

6" THICK REINFORCED —

OVERFLOW WEIR

/— SLOPE TOWARDS

OUTLET PIPE, TYP.

/ 24" ACCESS PORT, TYP

√ SD FROM

- 1" DEEP KEY WAY TO

() JELLYFISH D1

RECEIVE WEIR WALL AND

WATER TIGHT SEALANT


- REINFORCED CONCRETE


ANTI-FLOATATION SLAB

- REINFORCED COPOLYMER


POLYPROPYLENE SAFETY


SD TO JELLYFISH D1

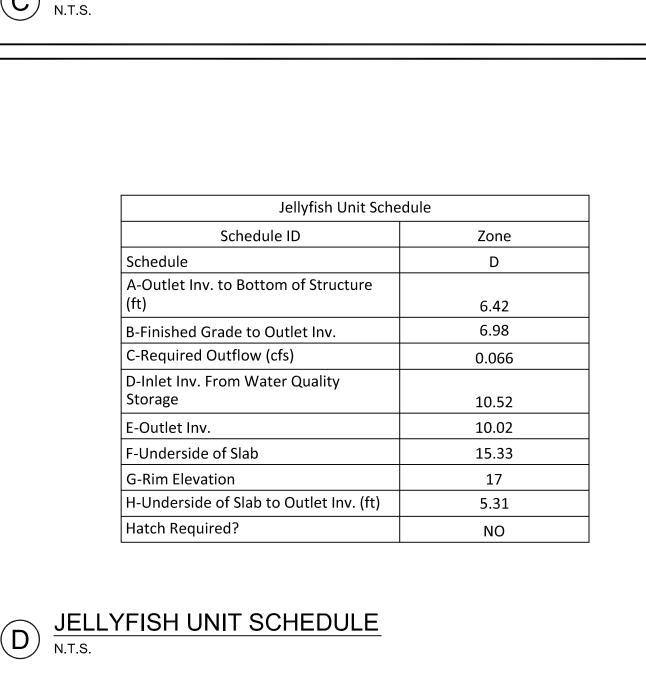

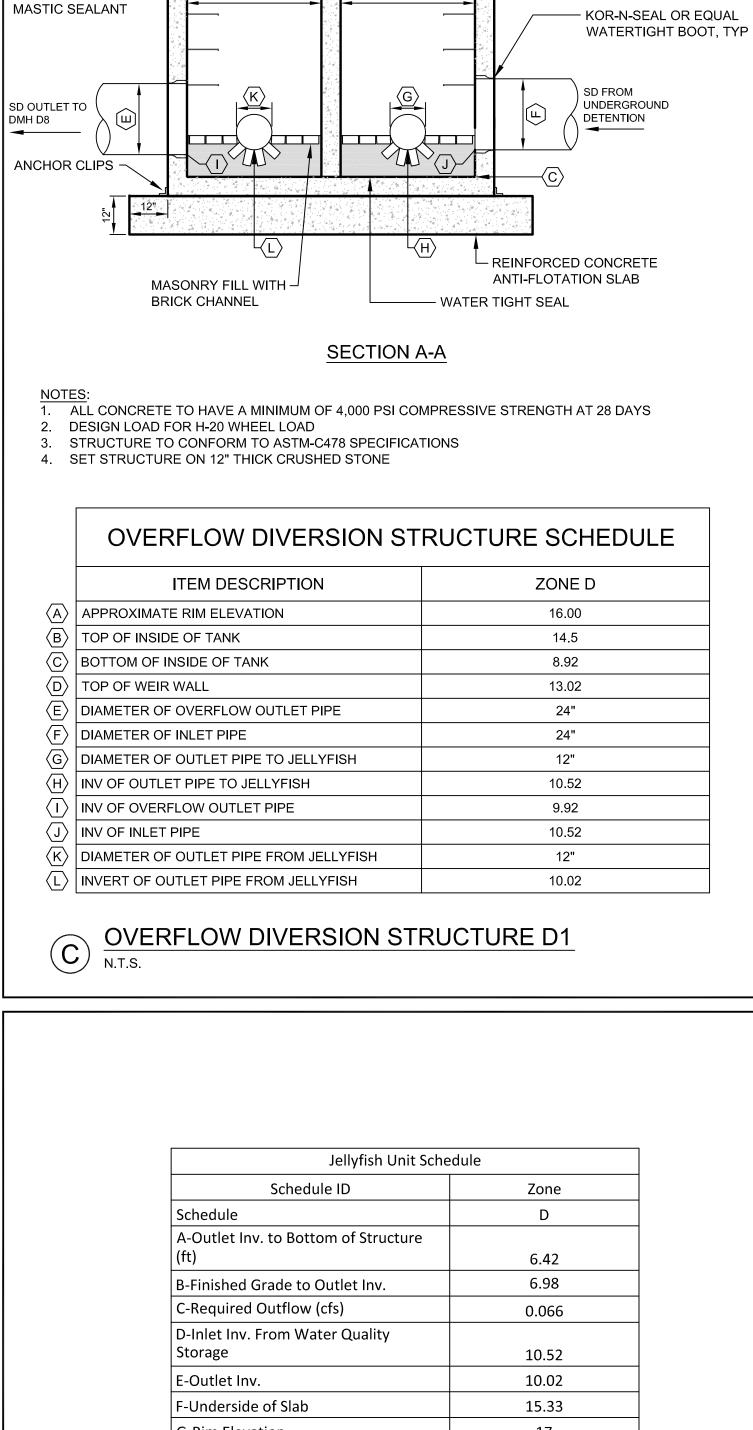

<u>PLAN</u>

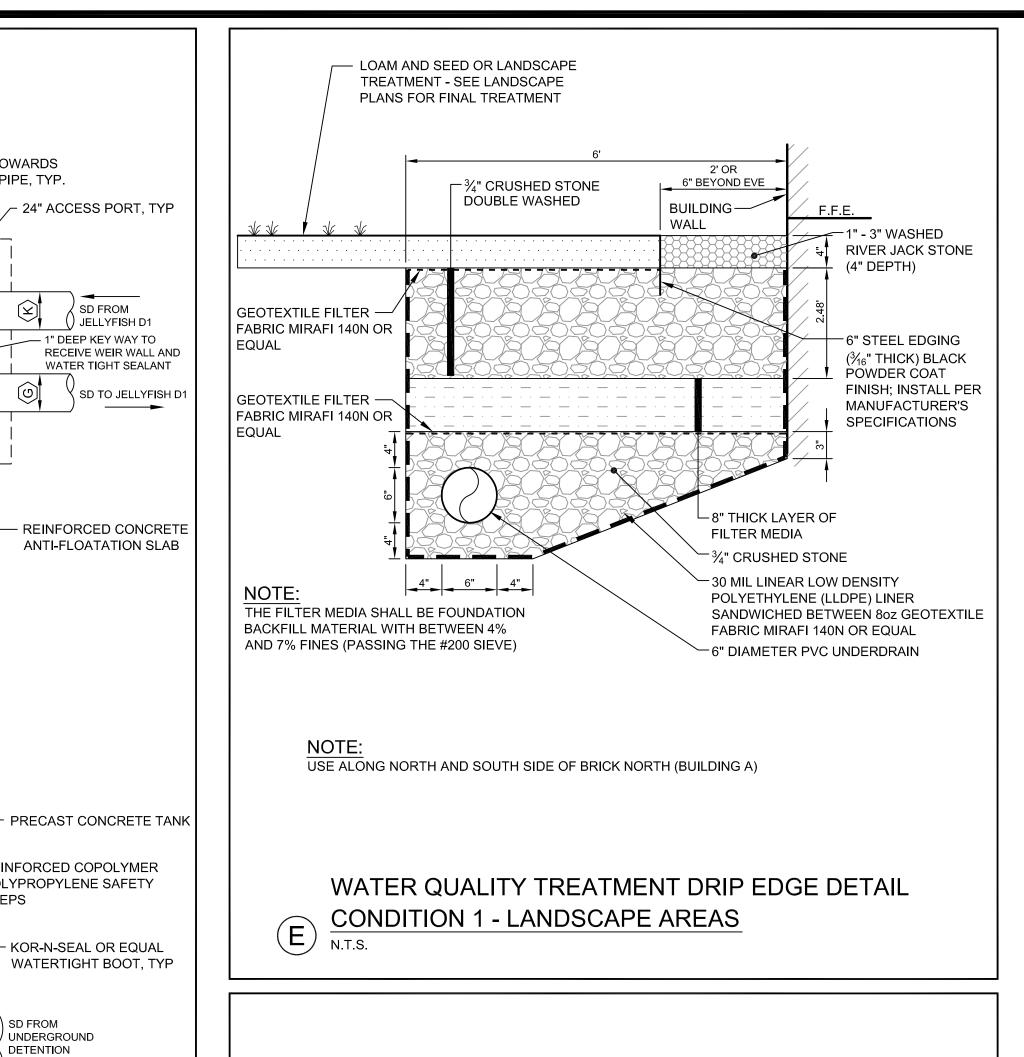

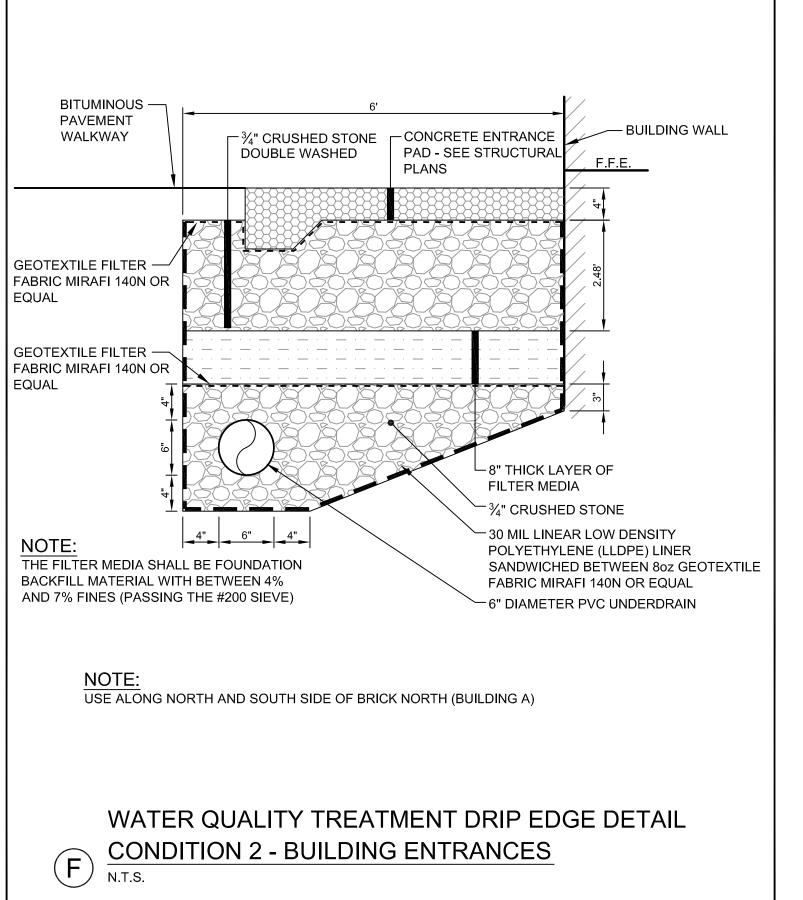

VARIES - SEE SITE PLANS

GEOTEXTILE

EQUAL

WARNING FABRIC

MIRAFI 140N OR

JACK STONE 4" DEPTH

LOAM AND SEED OR ——

LANDSCAPE TREATMENT

FOR FINAL TREATMENT

SPECIFICATIONS

SEE LANDSCAPING PLANS

6" STEEL EDGING (3/16" THICK) ———

SOUTH SIDES OF BRICK SOUTH (BUILDING C)

TYPICAL DRIP STRIP DETAIL

USE ALONG WEST SIDE OF BRICK NORTH (BUILDING A) AND NORTH AND

BLACK POWDER COAT FINISH,


6" CLEAN COMMON BORROW


(REFER TO VRAP WORK PLAN


ASSOCIATES DATED 9.11.12)


PREPARED BY CREDERE

INSTALL PER MANUFACTURER'S

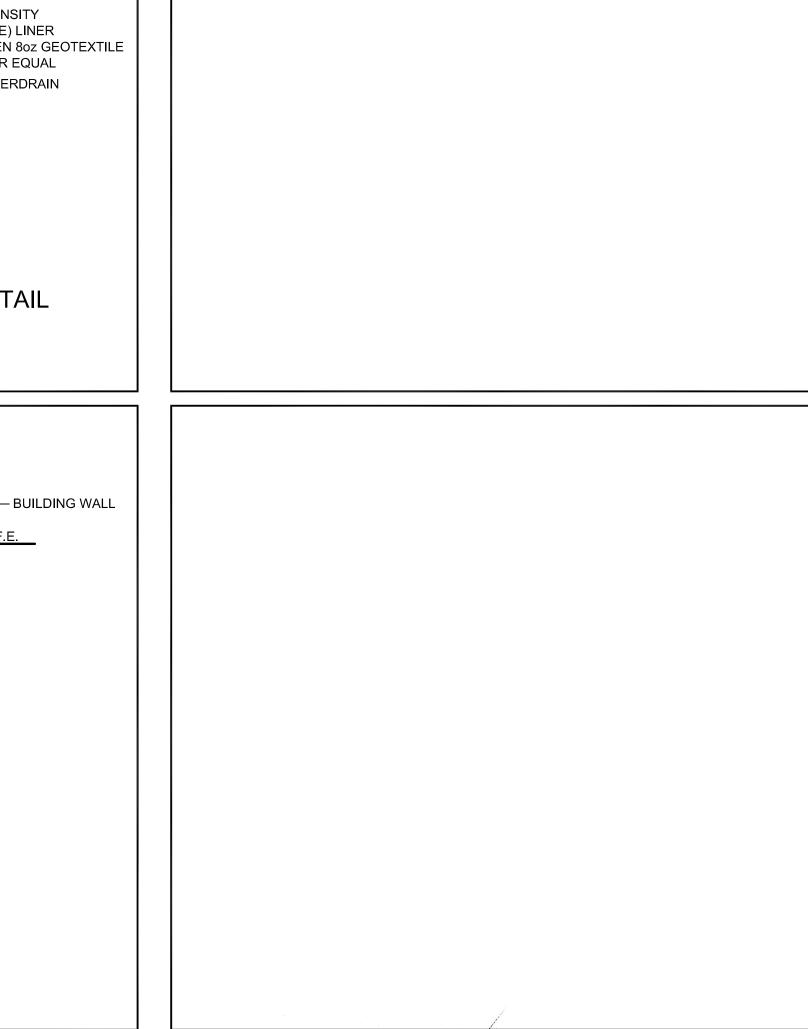

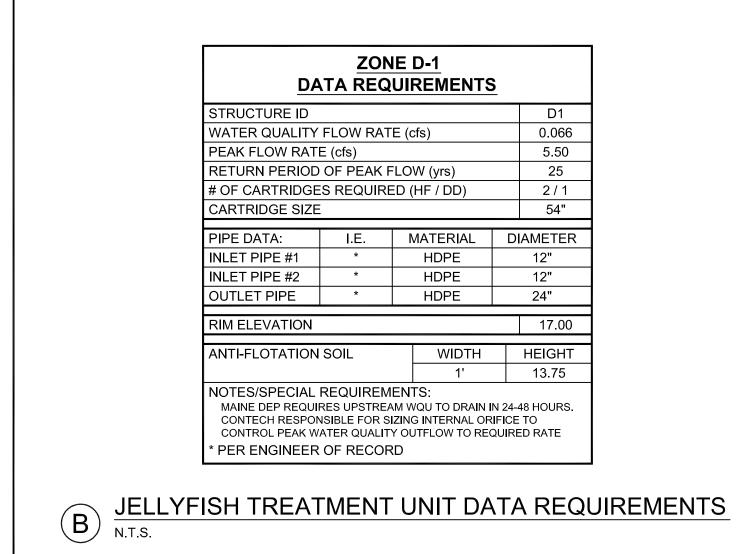

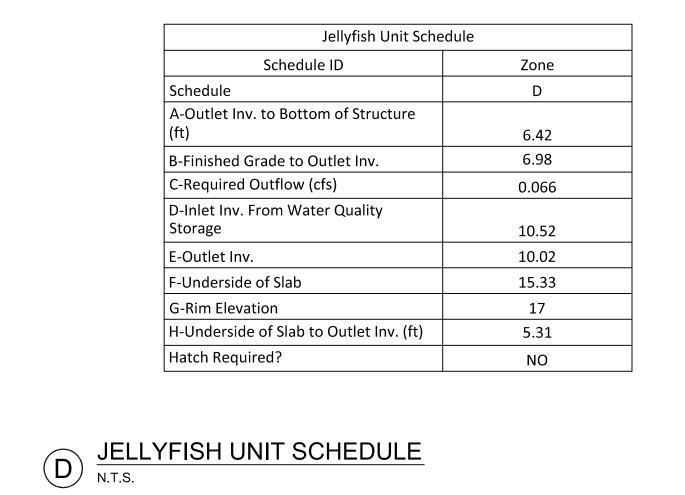

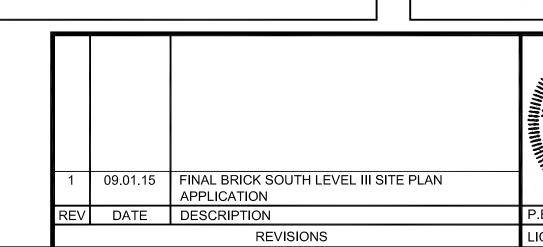

BRICK NORTH AND SOUTH BUILDINGS AT THE FOREFRONT AT THOMPSON'S POINT STORMWATER DETAILS AND DRIP EDGE TREATMENT

FAY, SPOFFORD & THORNDIKE ENGINEERS · PLANNERS · SCIENTISTS 778 MAIN ST, SUITE 8, SOUTH PORTLAND, ME 04106

DRAWN: DED DATE: APRIL 2015 DESIGNED: BEK SCALE: N.T.S. CHECKED: SRB JOB NO. 2982.05 FILE NAME: 2982.05-BS DET FOREFRONT PARTNERS |, LP C-7.0

PRELIMINARY - NOT FOR CONSTRUCTION