

SCHEDULE OF SILT FENCE REQUIREMENTS

SILT FENCE	TYPE PURPOSE	TIME OF INSTALLATION
— 881 — TYPE 1 SILT FENCE	TO TRAP SEDIMENT ALONG THE GRADING EDGE WHERE THE NEW CONTOURS NEARLY PARALLEL THE EXISTING CONTOURS	AT INITIAL SITE PREPARATION; PRIOR TO OTHER WORK

NOTES:

- ALL RUNOFF FROM DISTURBED AREAS SHALL BE DIRECTED TO A FILTERING DEVICE DESIGNATED TO LIMIT TURBIDITY IN ALL DISCHARGE TO THE FORE RIVER. THE FILTERING DEVICE MAY BE BUT IS NOT LIMITED TO SAND FILTERS, EROSION CONTROL MIX, STRAW WHATTLES, FLOCCULATION CHEMICALS, DIRTY GLUE AND SILT FENCE
- ALL CATCH BASINS TO HAVE 4" UNDERDRAIN PER DETAIL 'L' ON SHEET C-8.5
- ALL SUBSURFACE DETENTION AREAS ARE NOT TO BE PLACED "ON-LINE" UNTIL TRIBUTARY AREA IS STABILIZED WITH PAVEMENT OR 75% VEGETATION COVERAGE
- STOCKPILES TO BE TEMPORARILY SEEDED AND MULCHED AS REQUIRED BY THE PROJECT SPECIFICATIONS
- THE CONTRACTOR SHALL TREAT DISTURBED AREAS AND CONSTRUCTION HAUL PATH WITH DUST CONTROL BMPs TO LIMIT ALL FUGITIVE DUST



Summary of Storm Water Discharges

Discharge ID	Approximate Drainage Area (Ac)	Full Build Out 25 Yr Peak Flow (CFS)	Outlet Pipe Size (In)	Description	*Minimum Required Riprap D50 (IN)
F0	1.88	9.6	36	RCP Flared End W/ Bar Rack, Riprap Slope Apron	12
D0	0.99	20.21	36	RCP Flared End W/ Bar Rack, Riprap Slope Apron	12
D0.1	1.4	0.018	12	HDPE Flared End, Riprap Slope Apron	Existing


* D50 is a median rock size. Riprap should be a well graded mix of angular rock from about 1.5 to 0.25 times the size of the D50. The contractor shall protect existing riprap slope or replace rock to the meet the minimum required D50 stone size.

LEGEND

- INLET PROTECTION (STONE OR HAY SEDIMENT BARRIER)
- FILTERRA INLET PROTECTION (PER MANUFACTURERS REQUIREMENTS)
- RIPRAP OUTLET PROTECTION
- CURLEX BLANKET
- EROSION CONTROL MESH
- 30' WIDE ACCESS ROUTE
- WASH DOWN AREA
- STONE CONSTRUCTION ENTRANCE

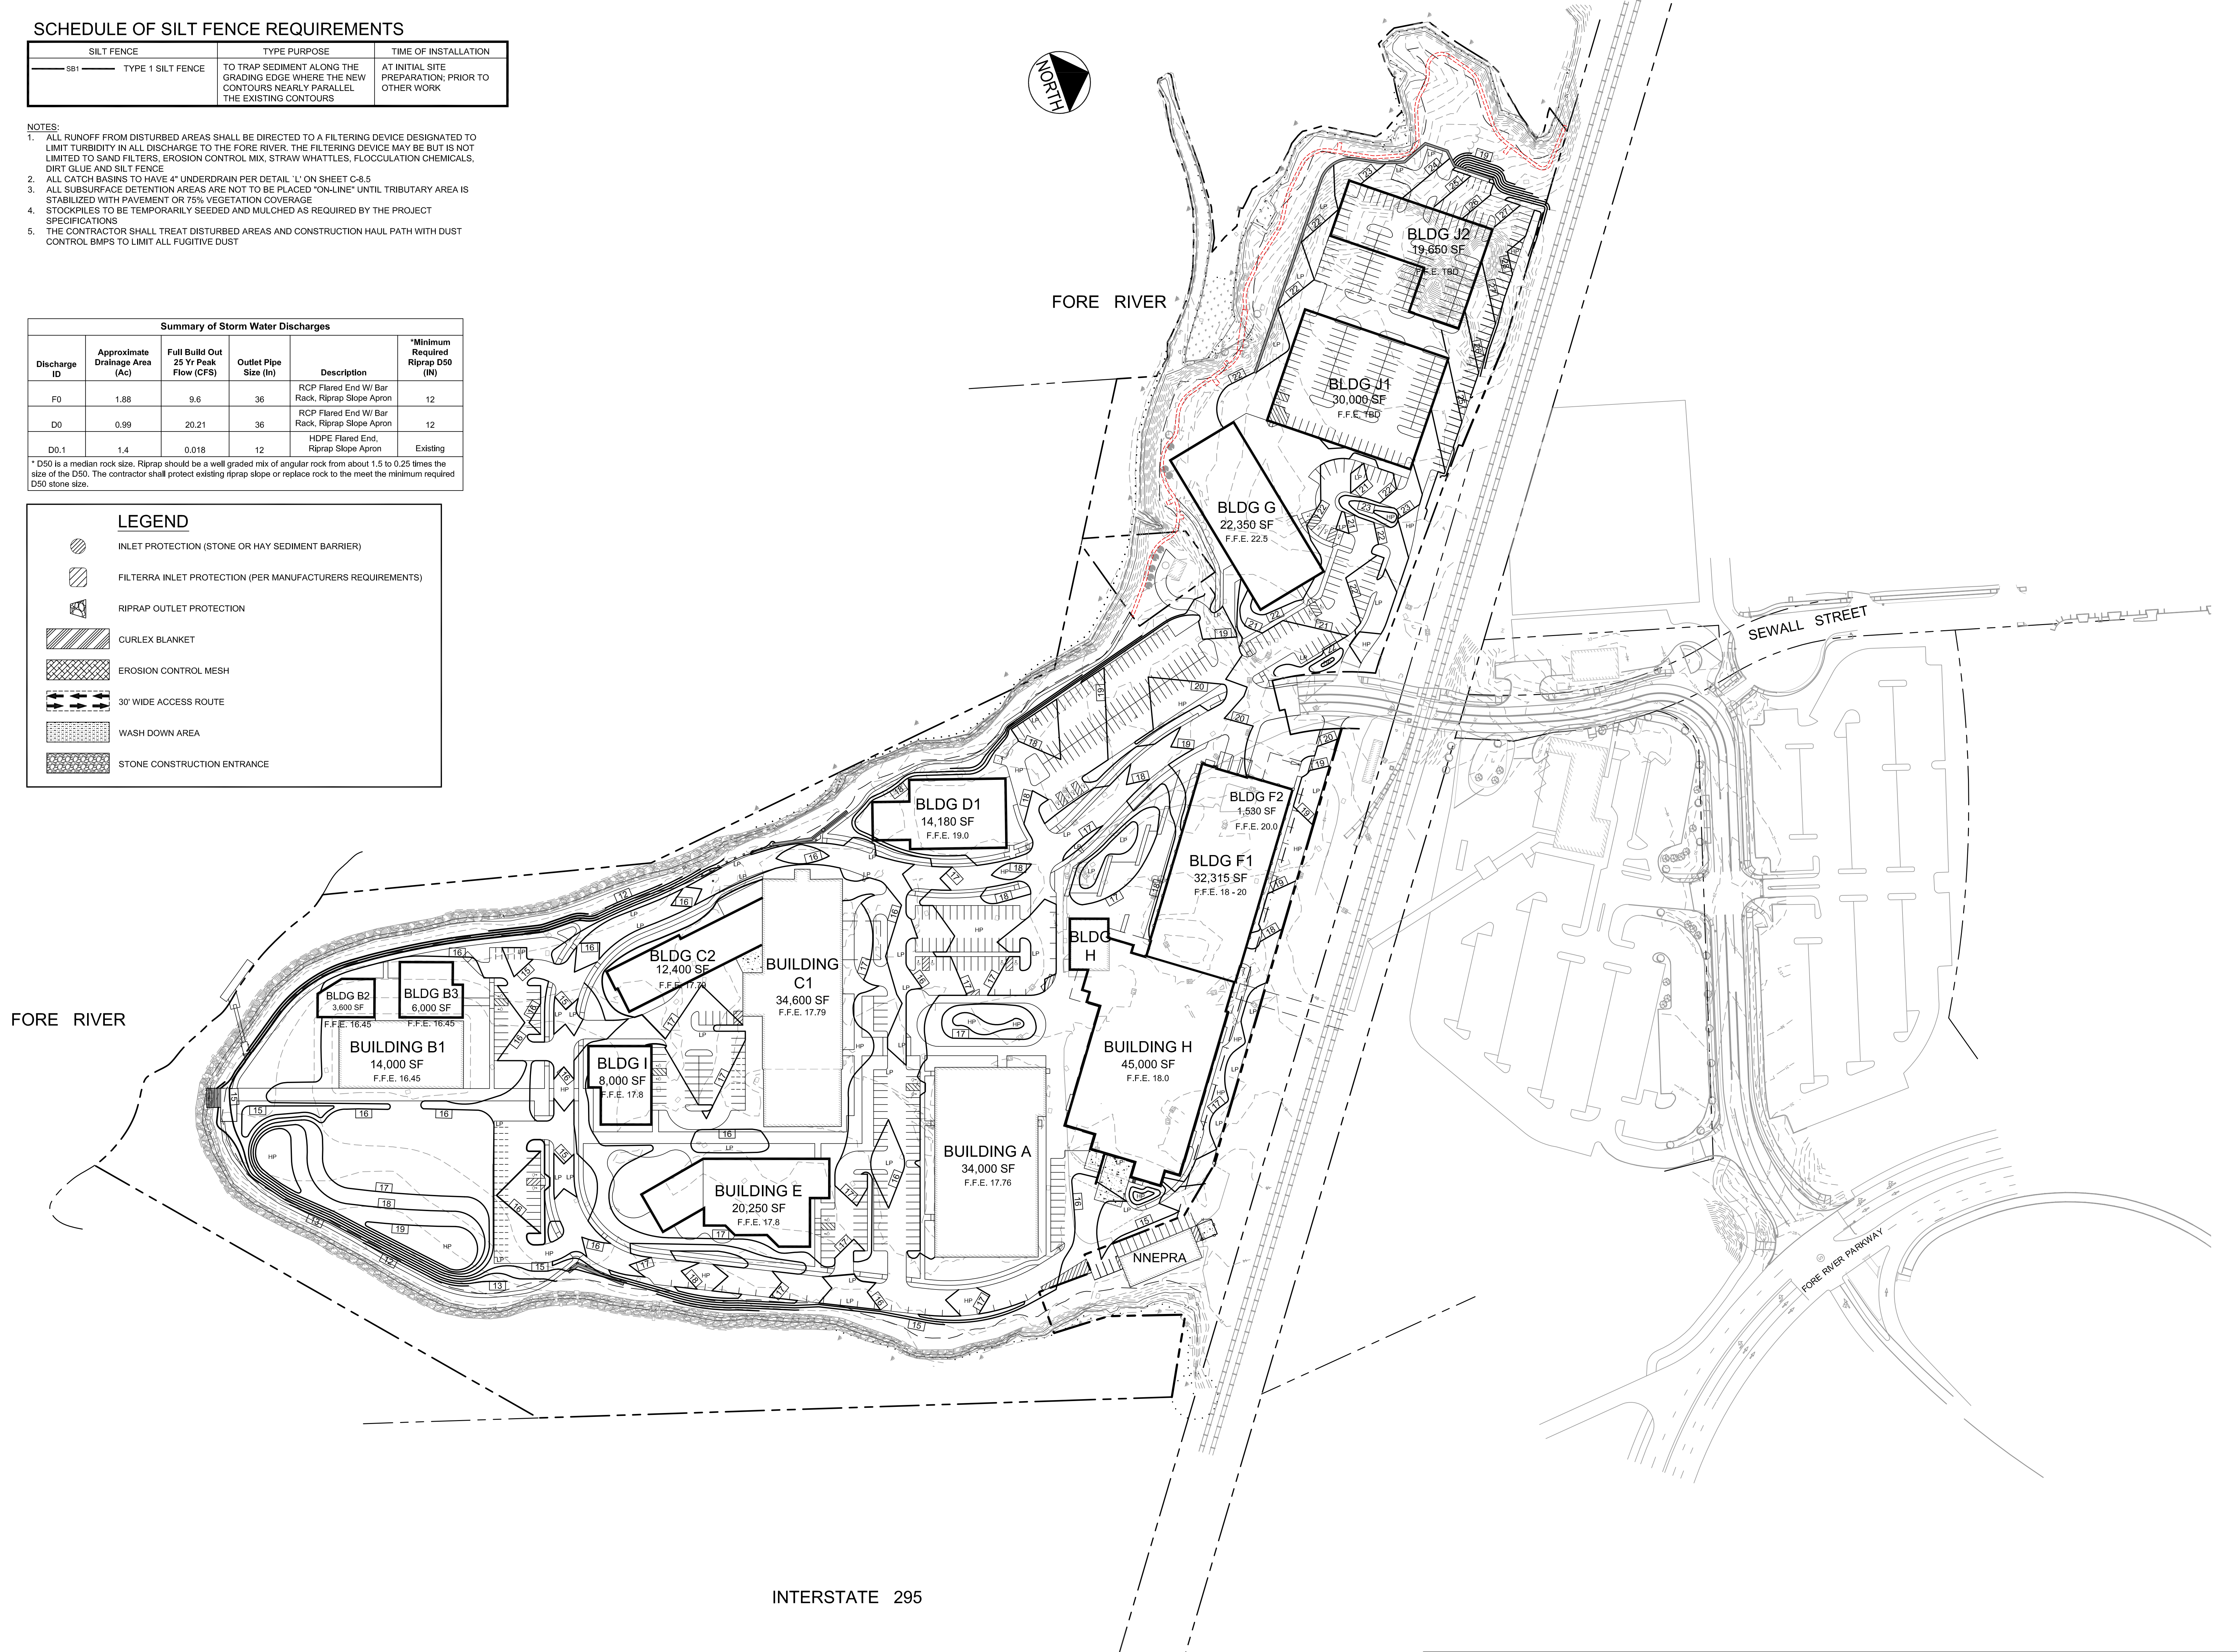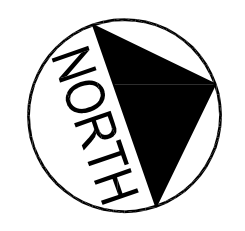

INTERSTATE 295

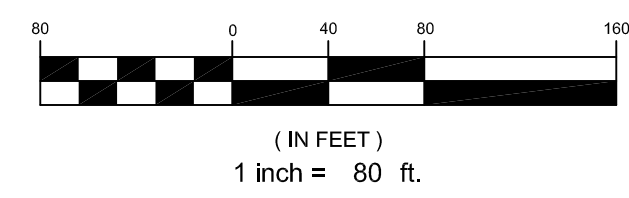

PROJECT		THE FOREFRONT AT THOMPSON'S POINT	
SHEET TITLE		OVERALL EROSION AND SEDIMENTATION CONTROL PLAN	
CLIENT		FOREFRONT PARTNERS LP	
DESIGNED: BEK	DATE: SEPT 2014	DRAWN: DED	
CHECKED: SRB	JOB NO. 2982.05	SCALE: 1" = 80'	
FILE NAME: 2982.05-SUB EROSION		LIC. #11994	
SHEET		C-5.0	

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