




STORM DRAIN PROFILE - D20 TO TEE
SCALE: H 1" = 4'
V 1" = 4'

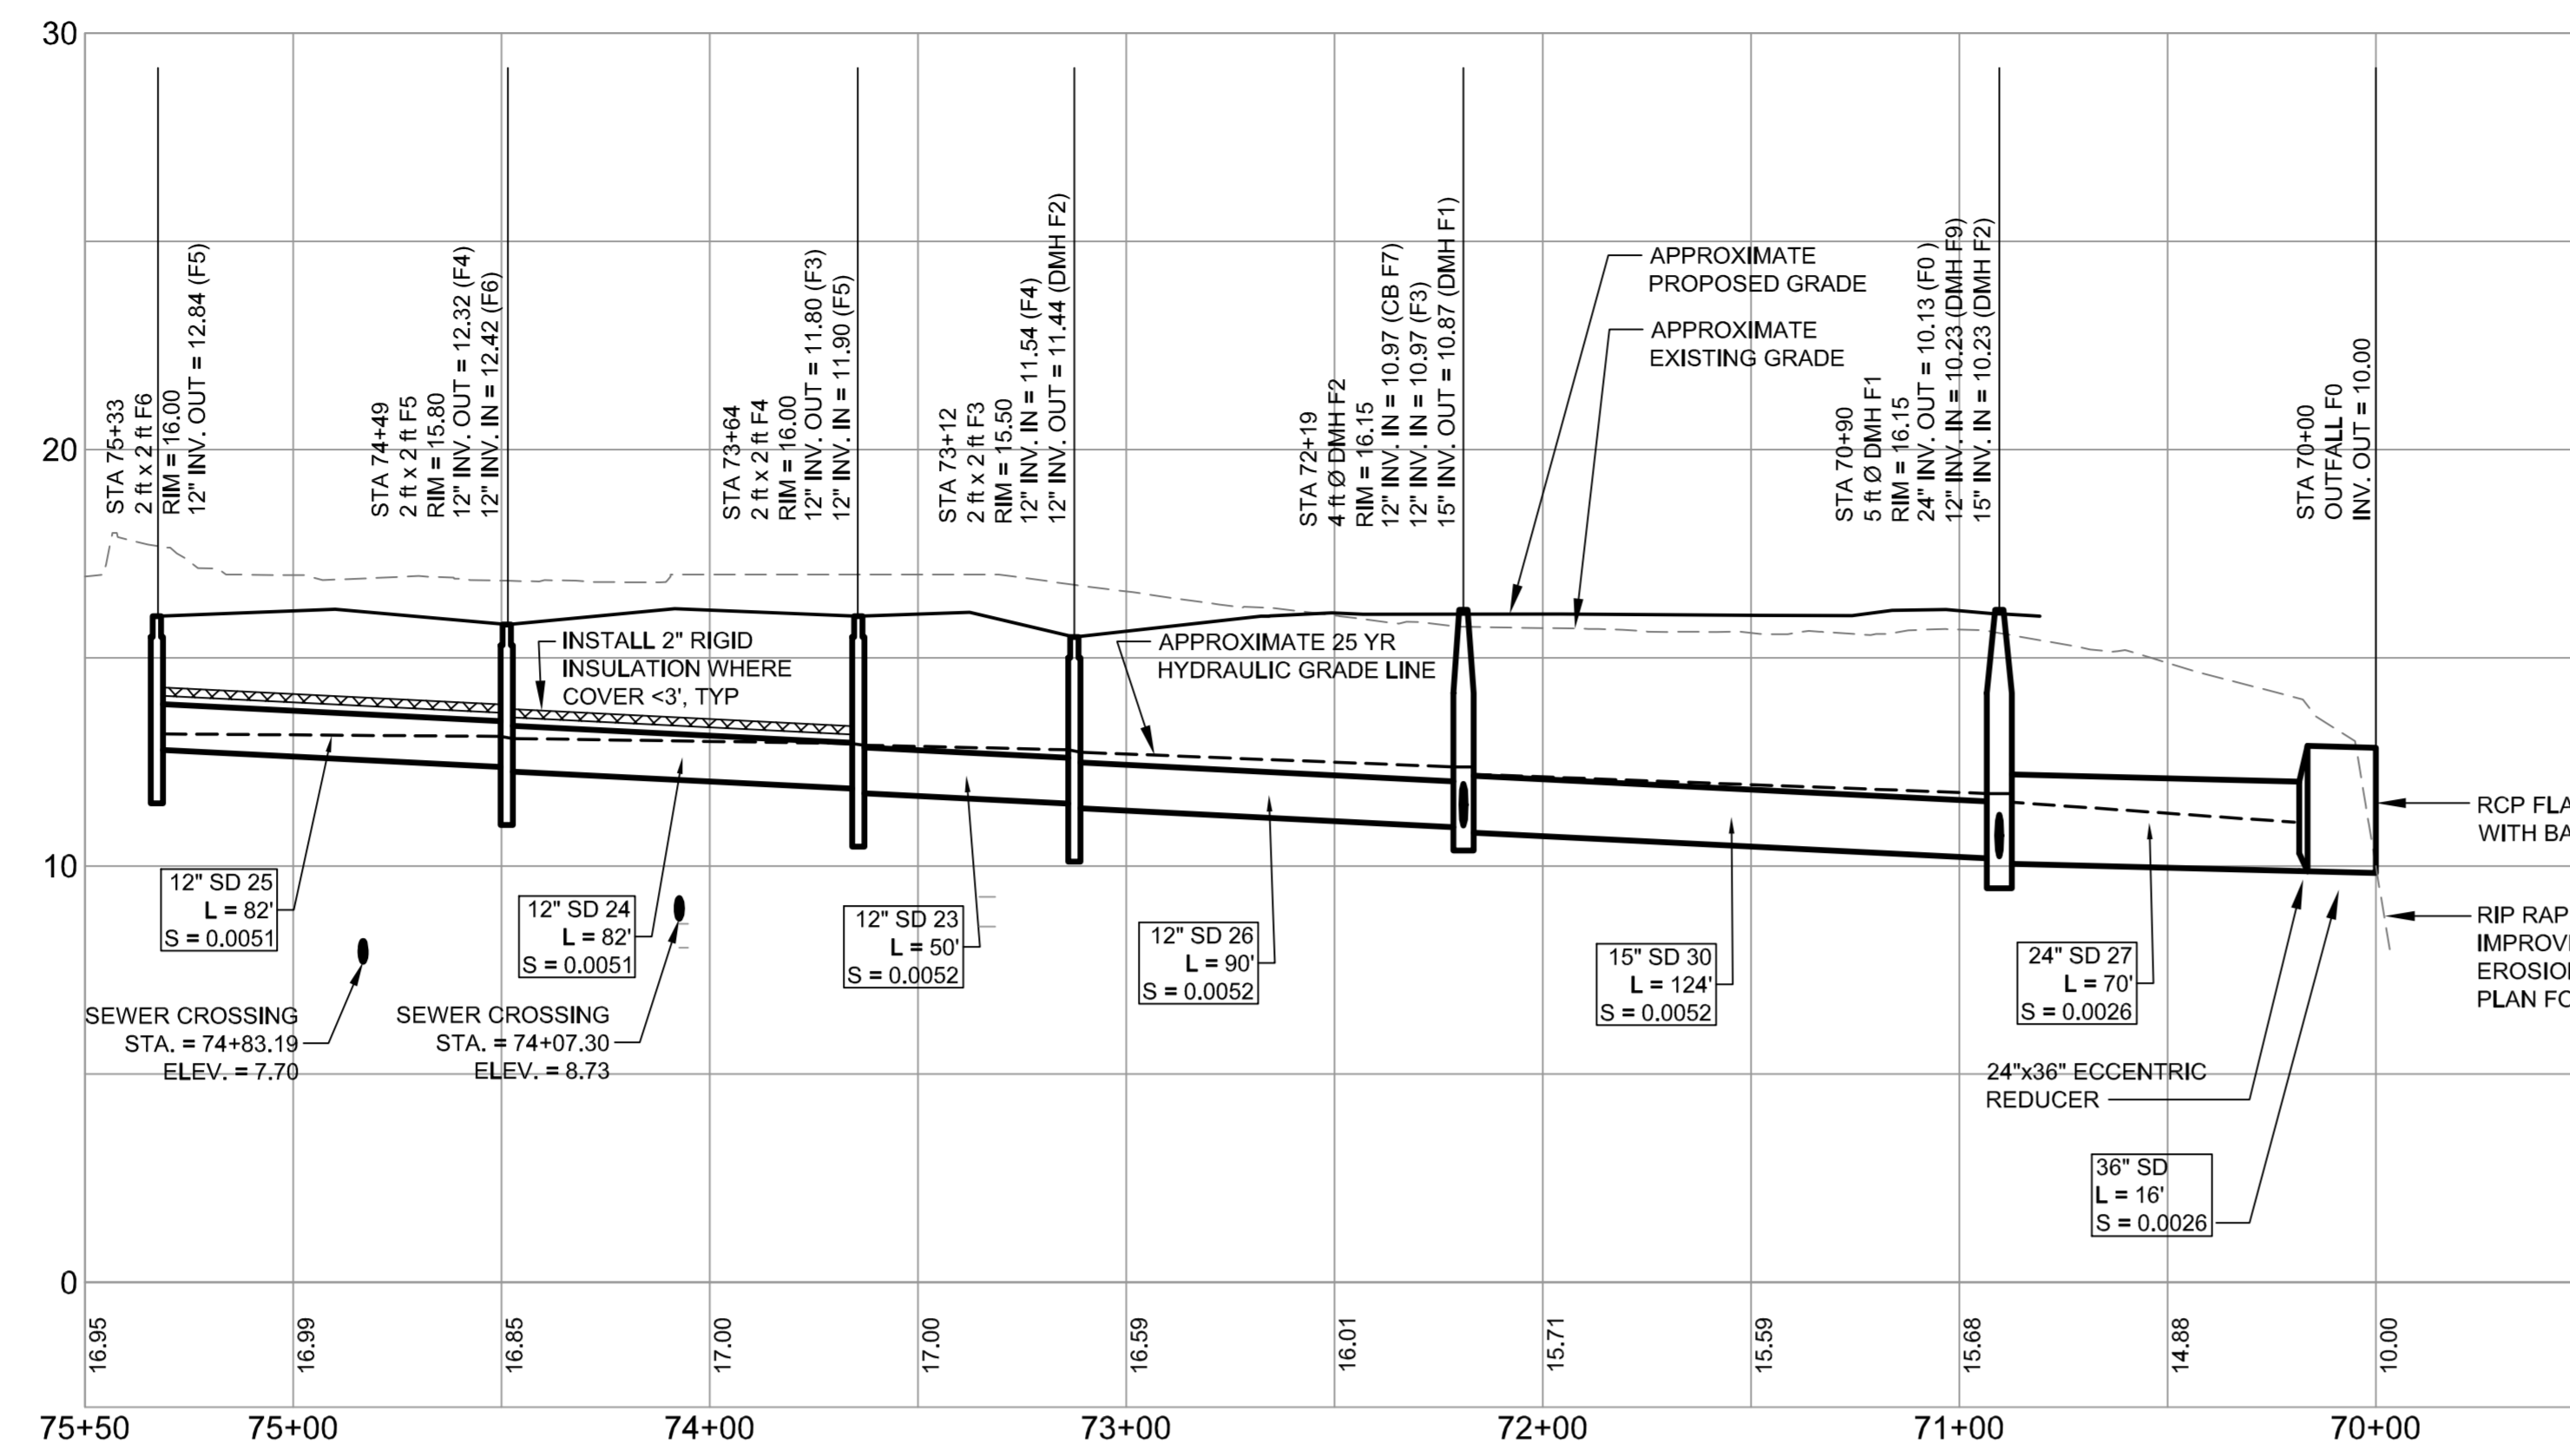


STORM DRAIN PROFILE - F6 TO F0
SCALE: H 1" = 4'
V 1" = 4'

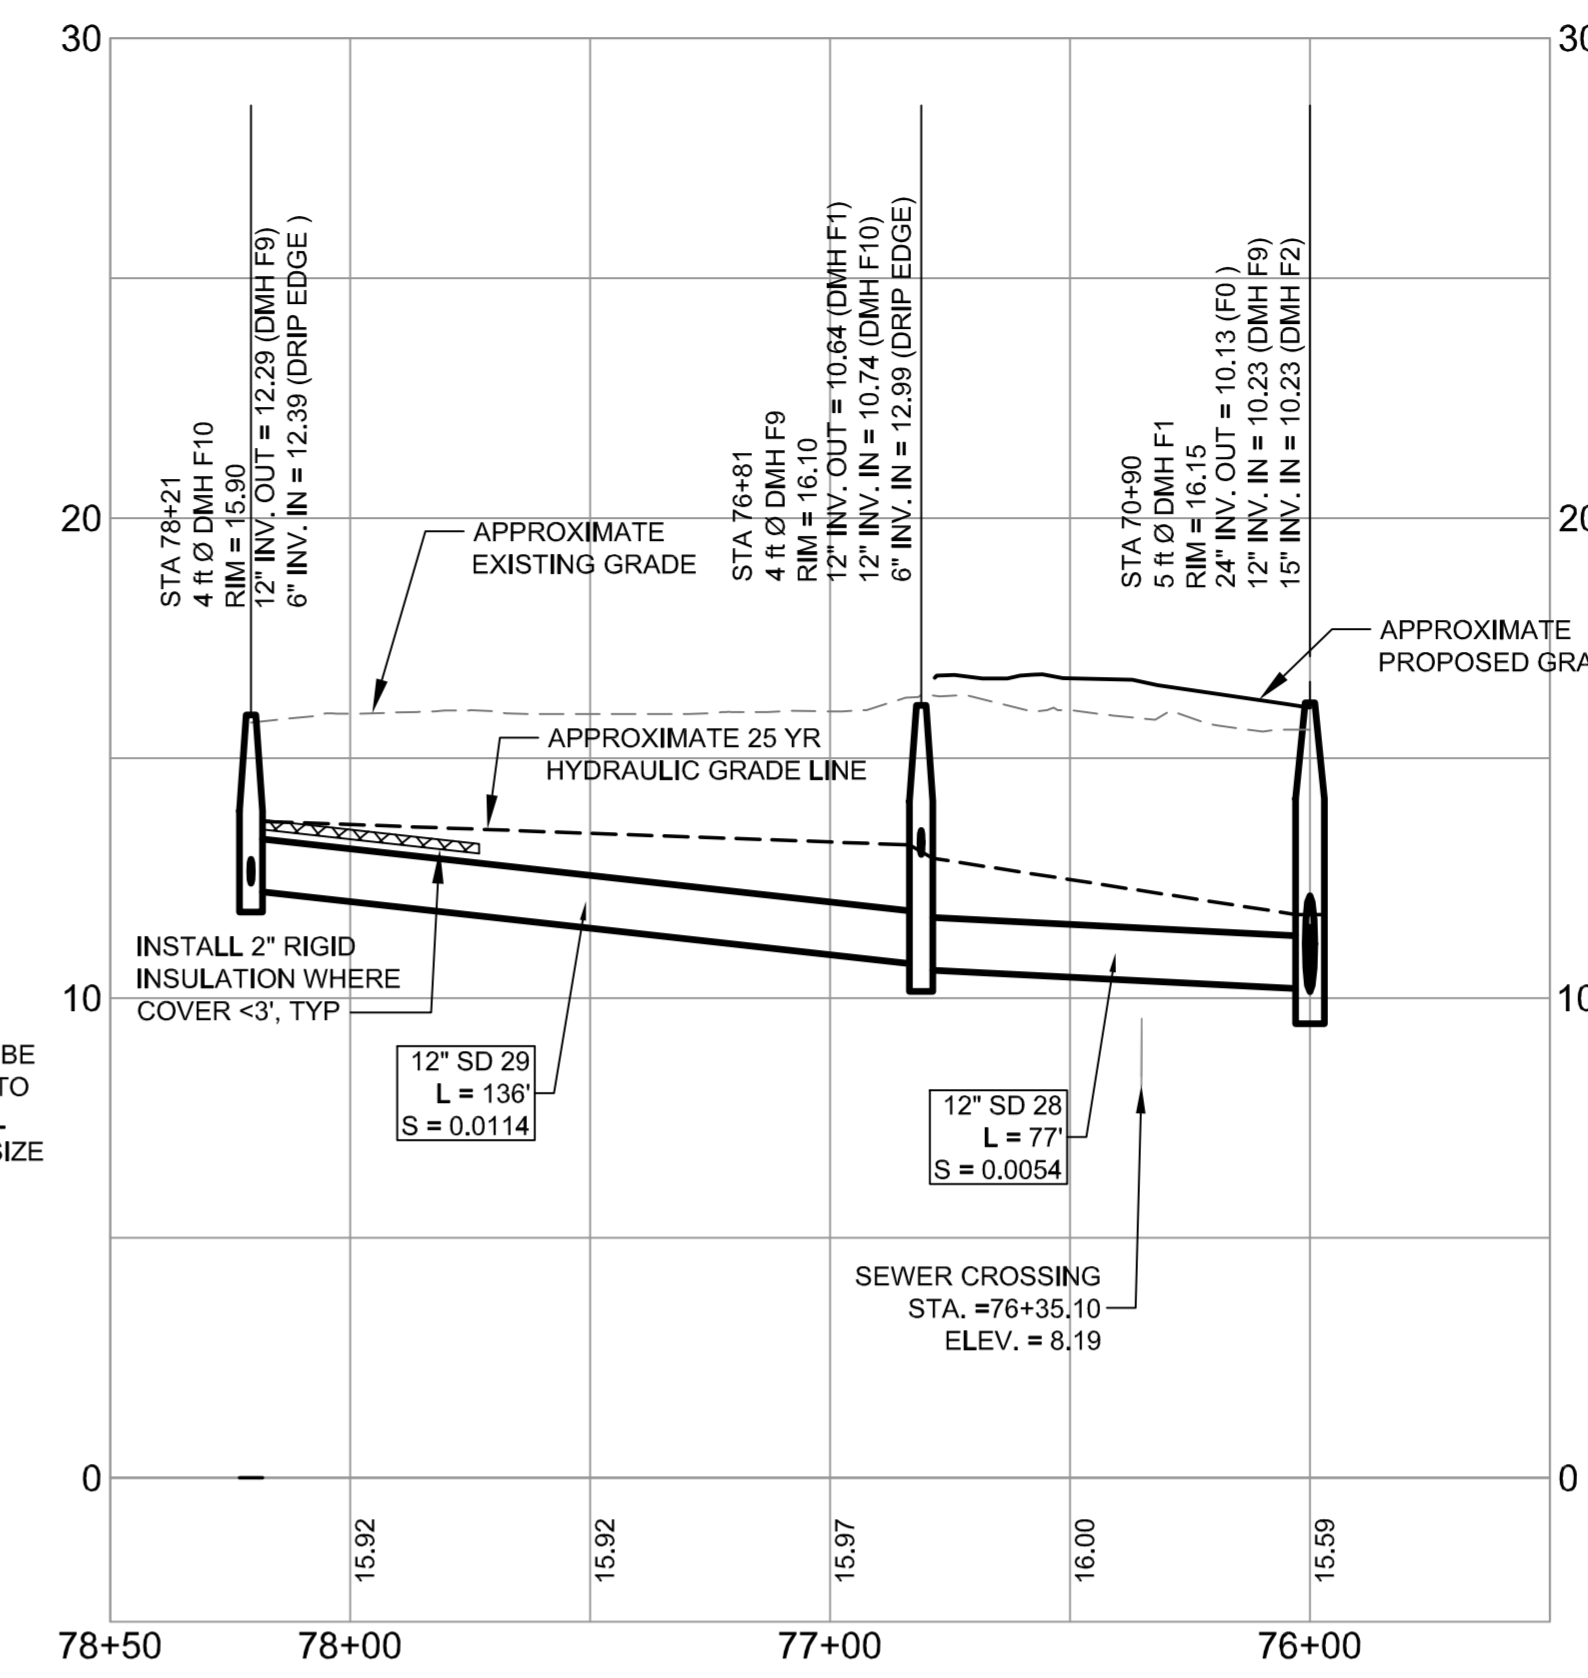


STORM DRAIN PROFILE - F10 TO DMH F1
SCALE: H 1" = 4'
V 1" = 4'

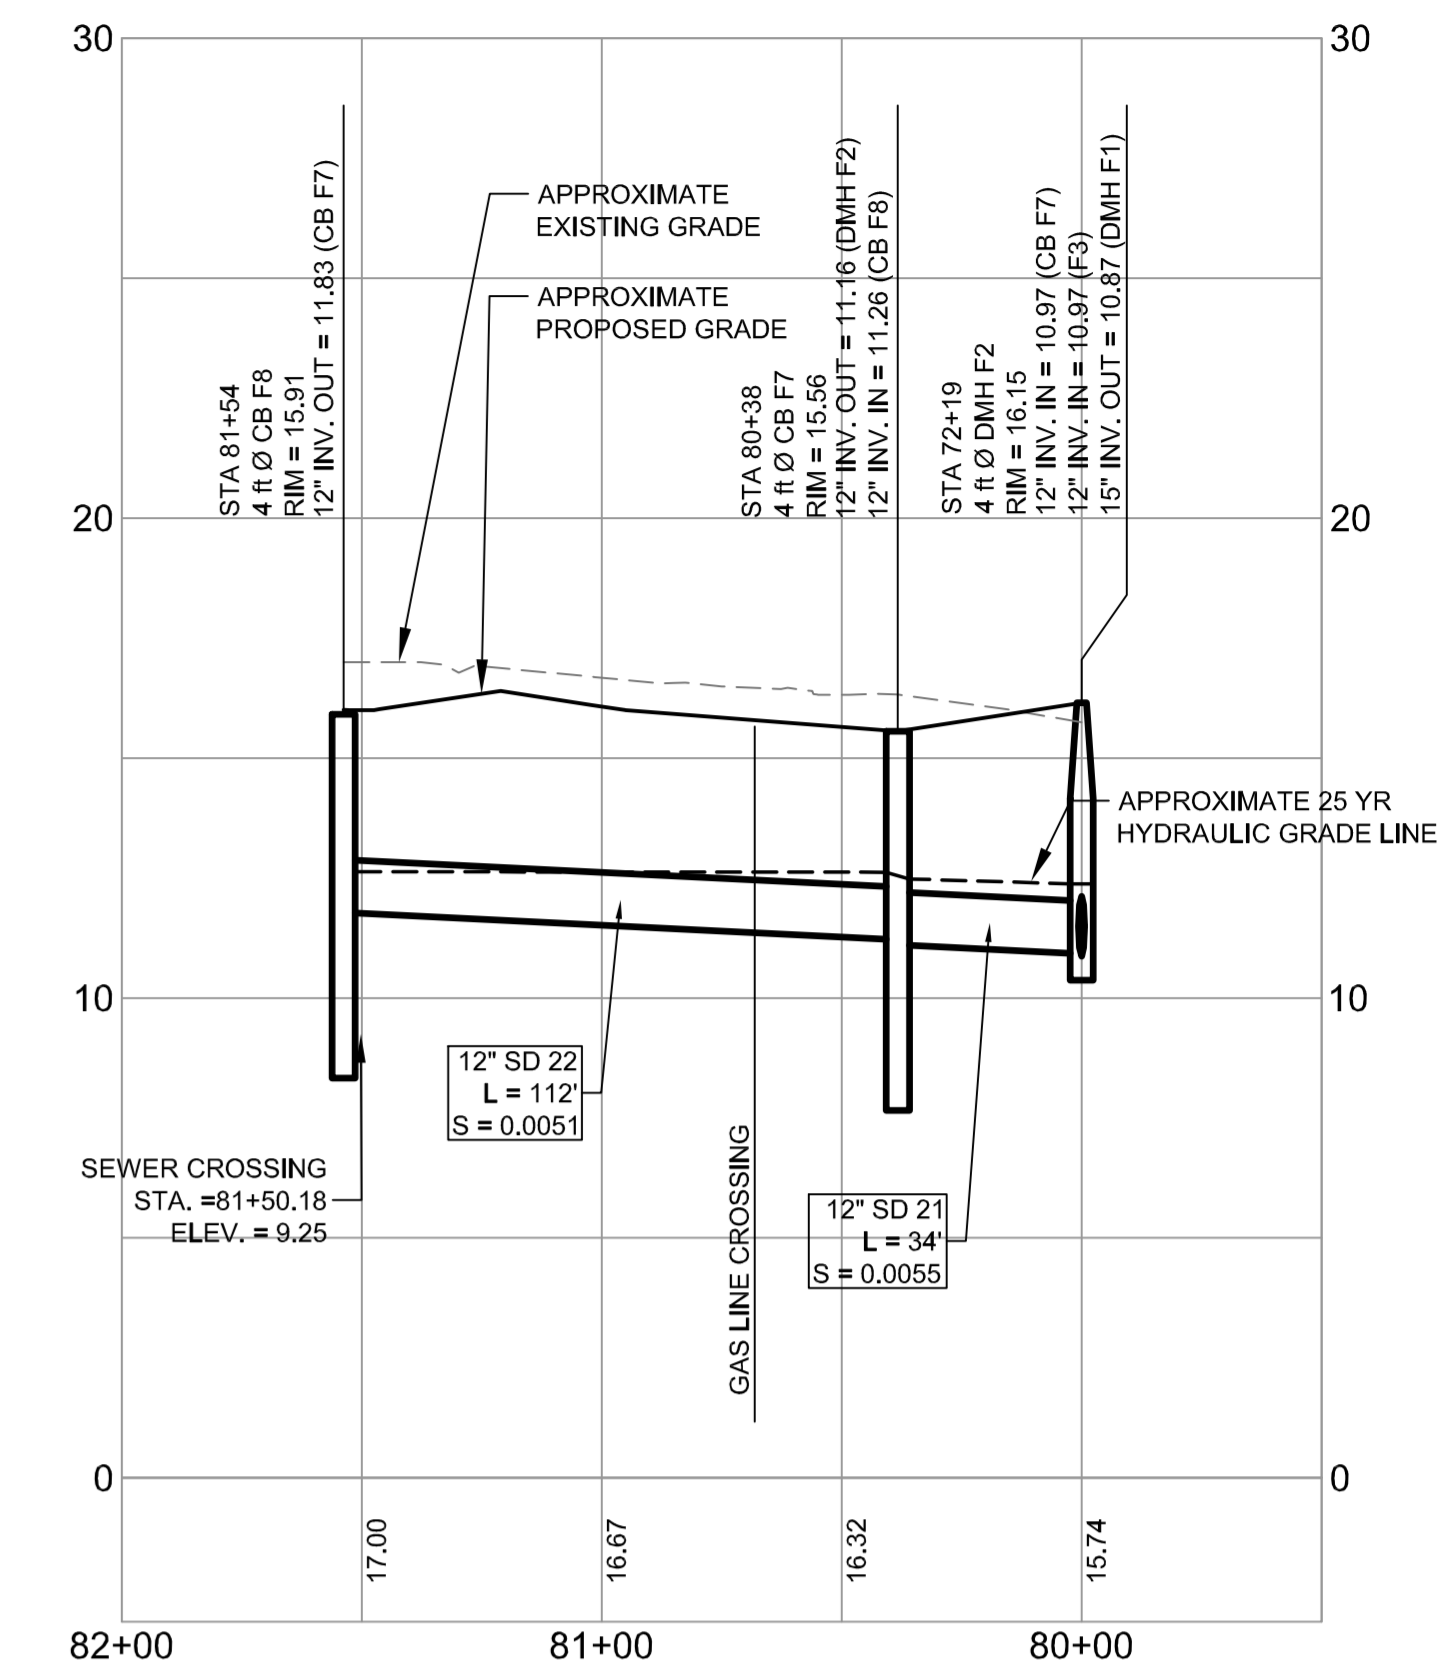


STORM DRAIN PROFILE - CB F8 TO DMH F2
SCALE: H 1" = 4'
V 1" = 4'

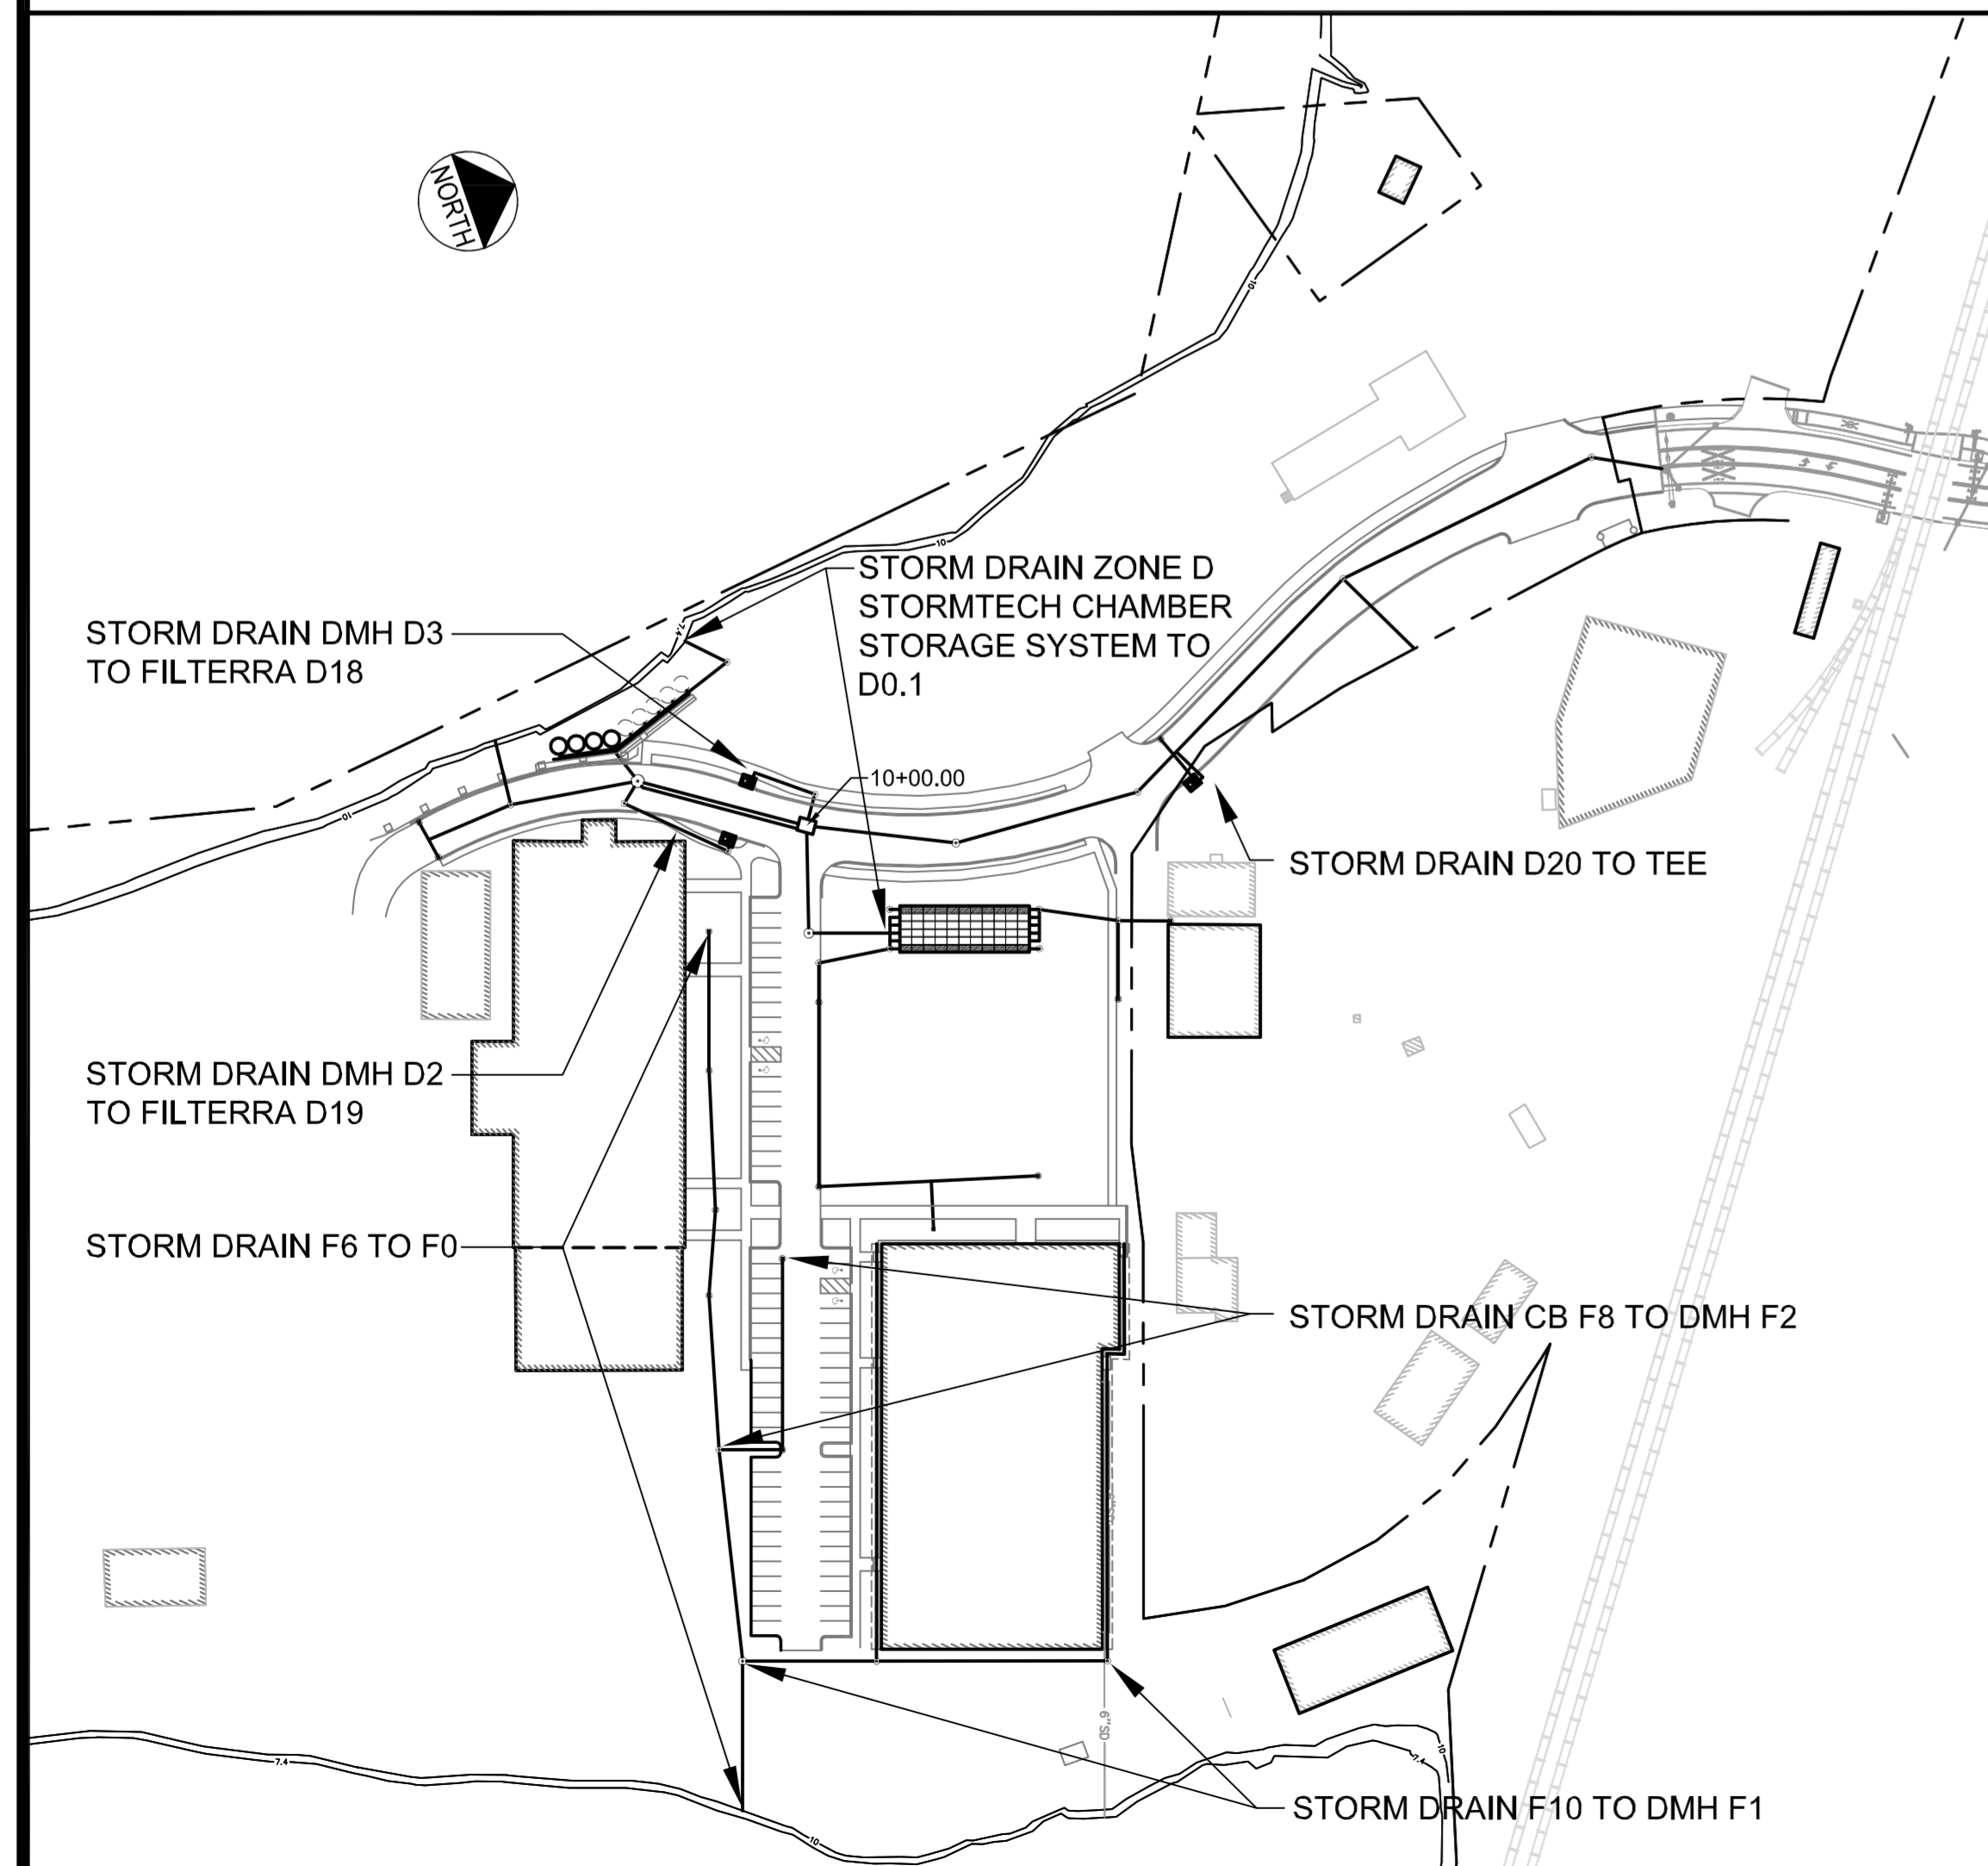


ORIENTATION SKETCH
N.T.S.

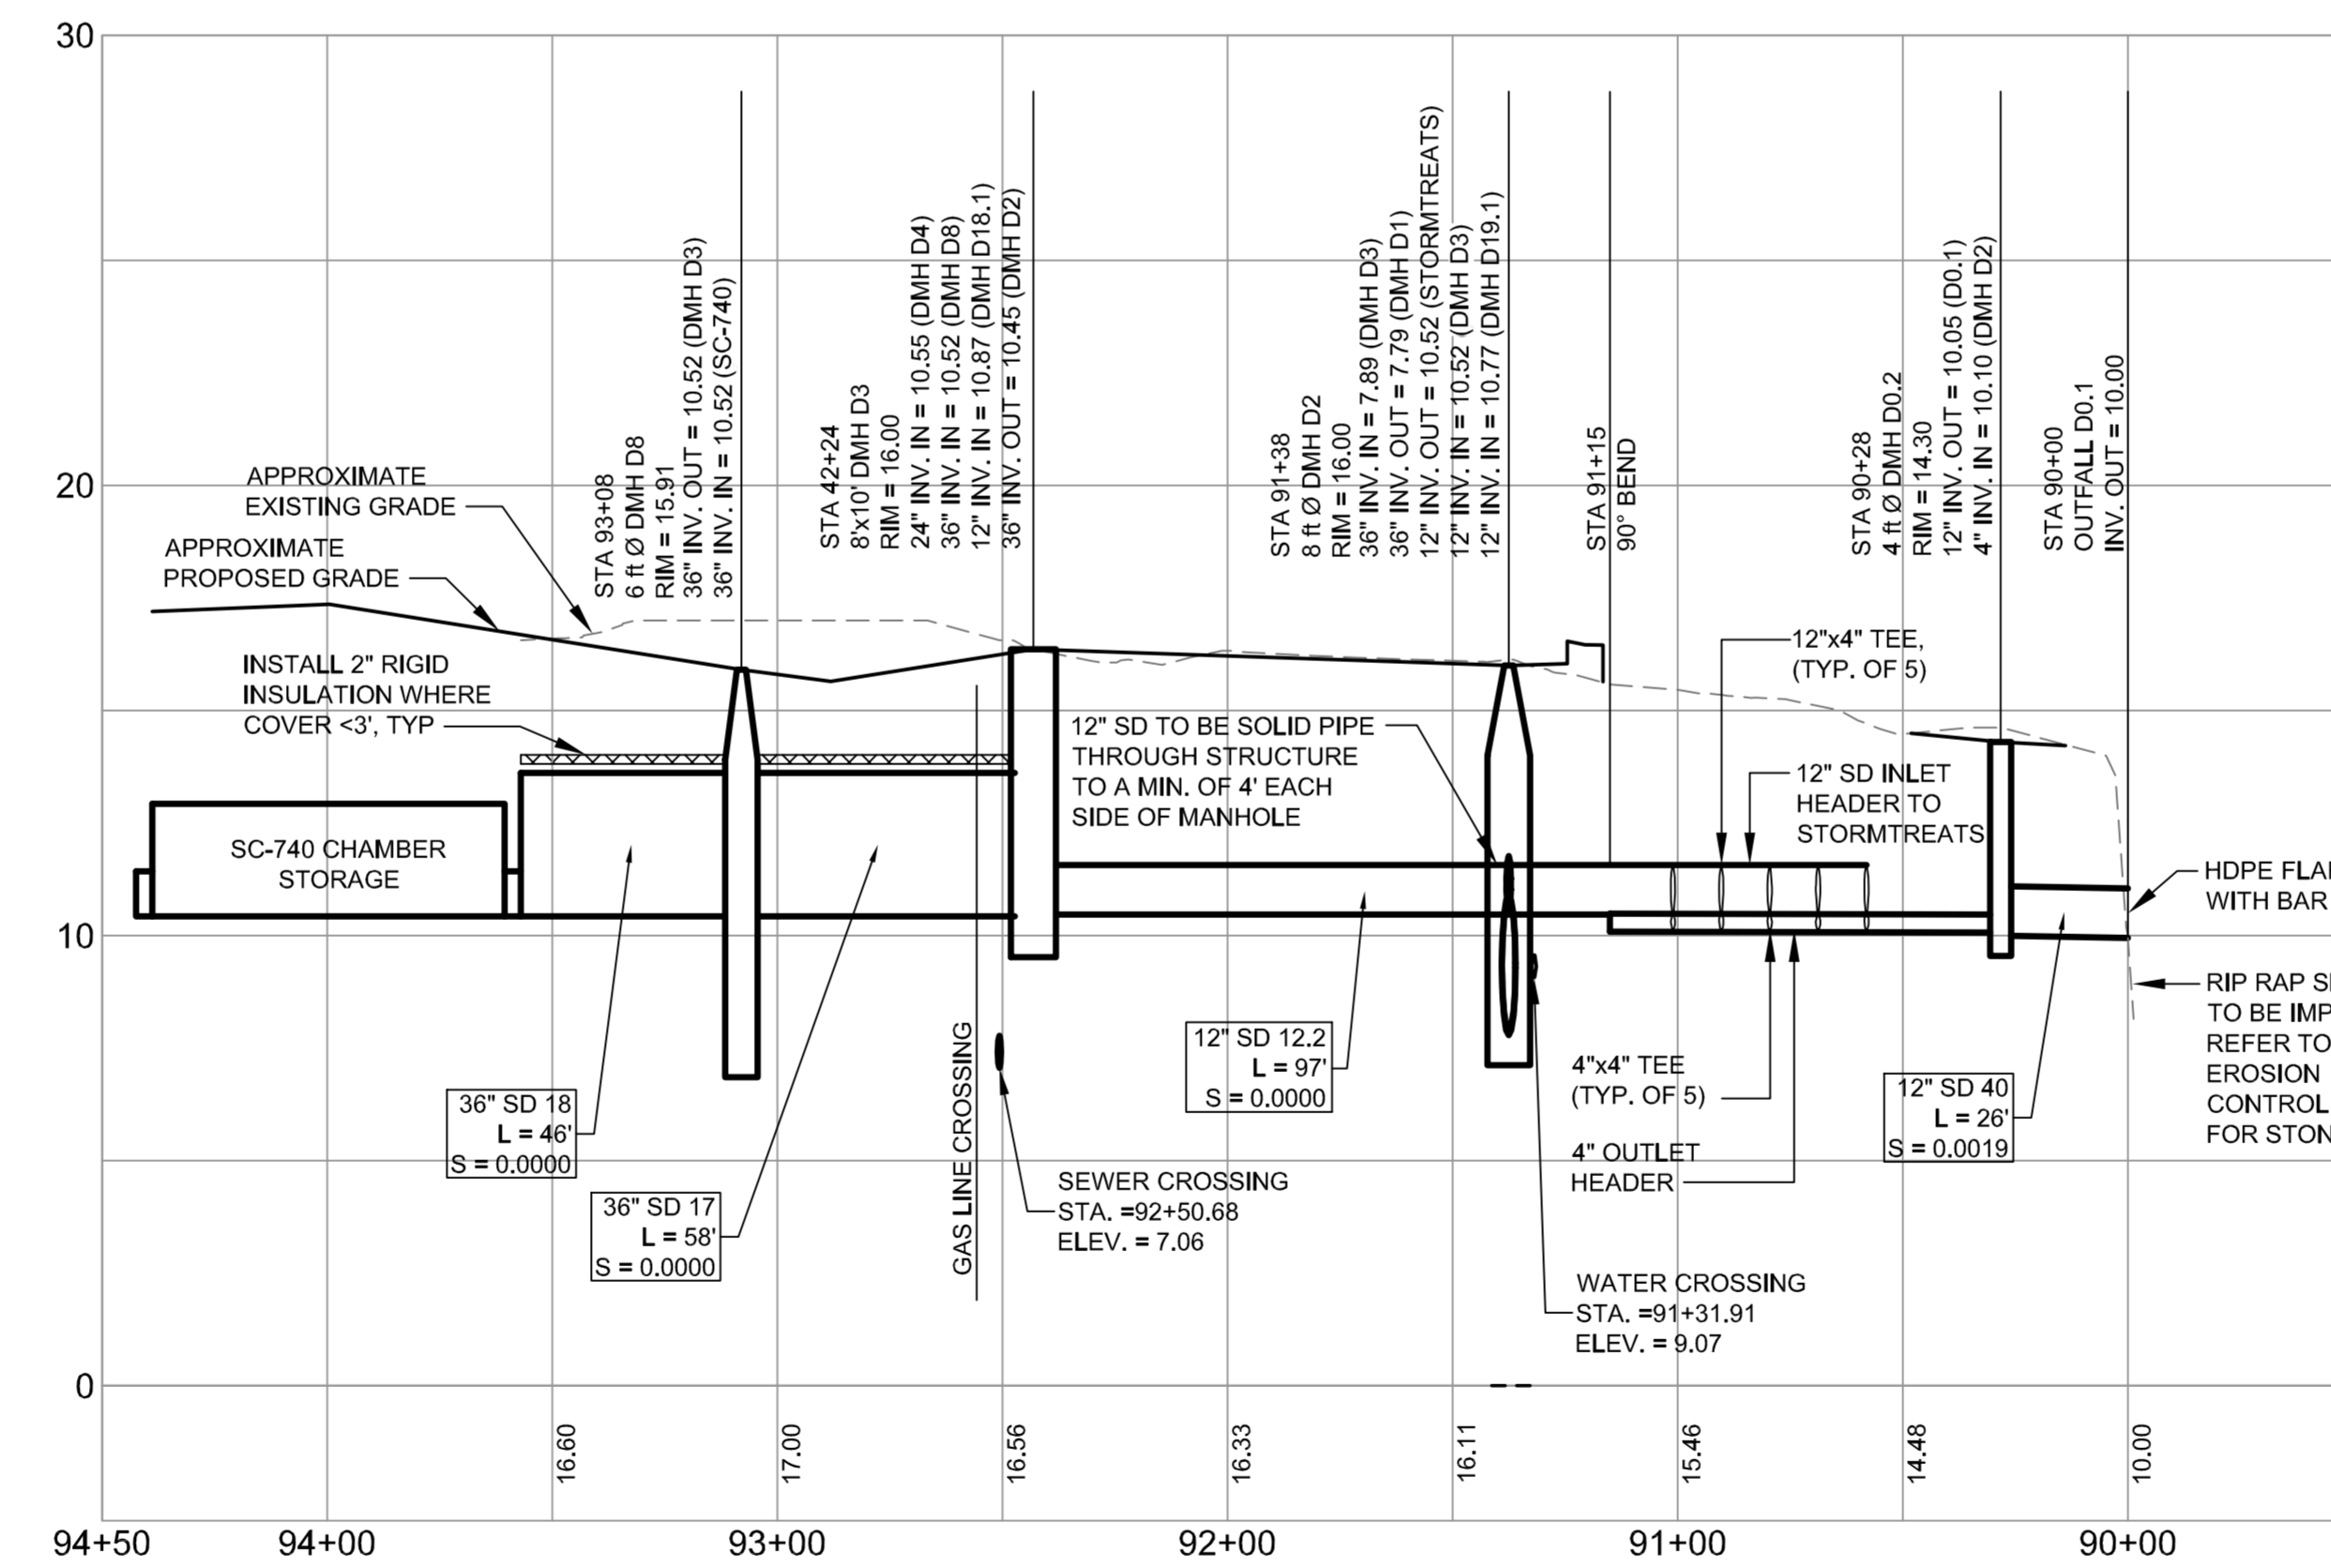

STORM DRAIN PROFILE - ZONE D STORMTECH CHAMBER STORAGE SYSTEM TO D0.1
SCALE: H 1" = 4'
V 1" = 4'

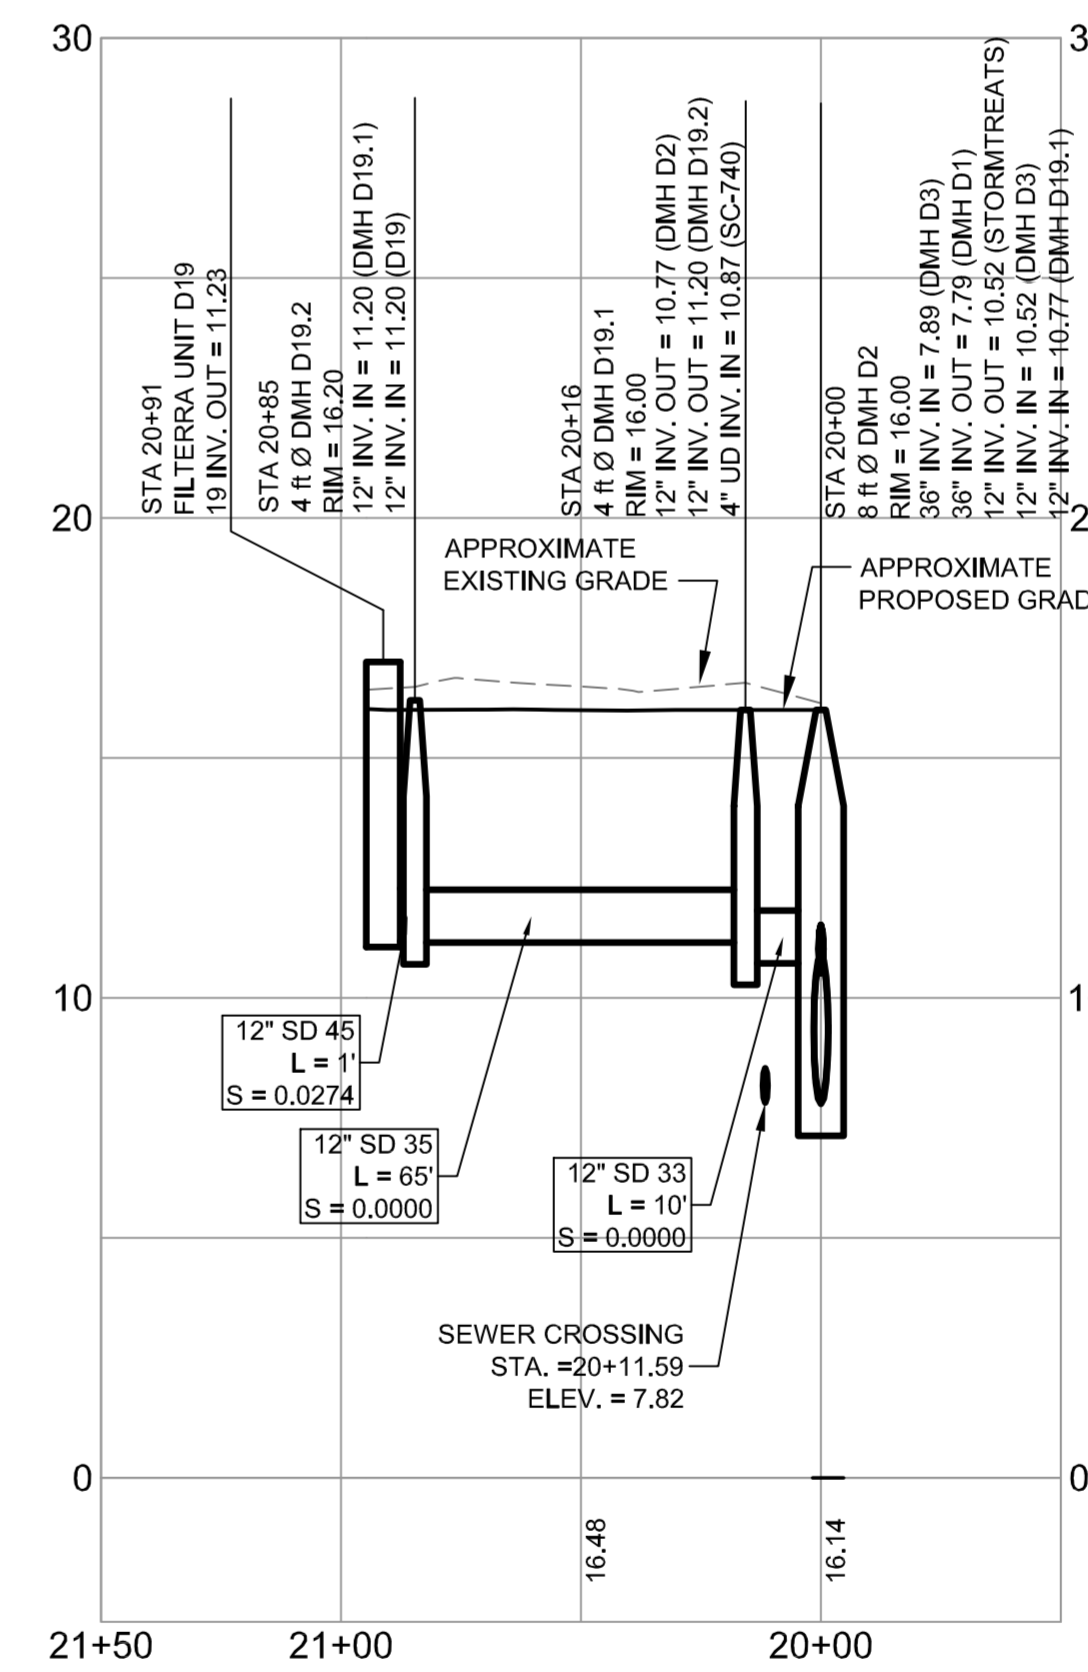


STORM DRAIN PROFILE DMH D2 TO FILTERRA D19
SCALE: H 1" = 4'
V 1" = 4'

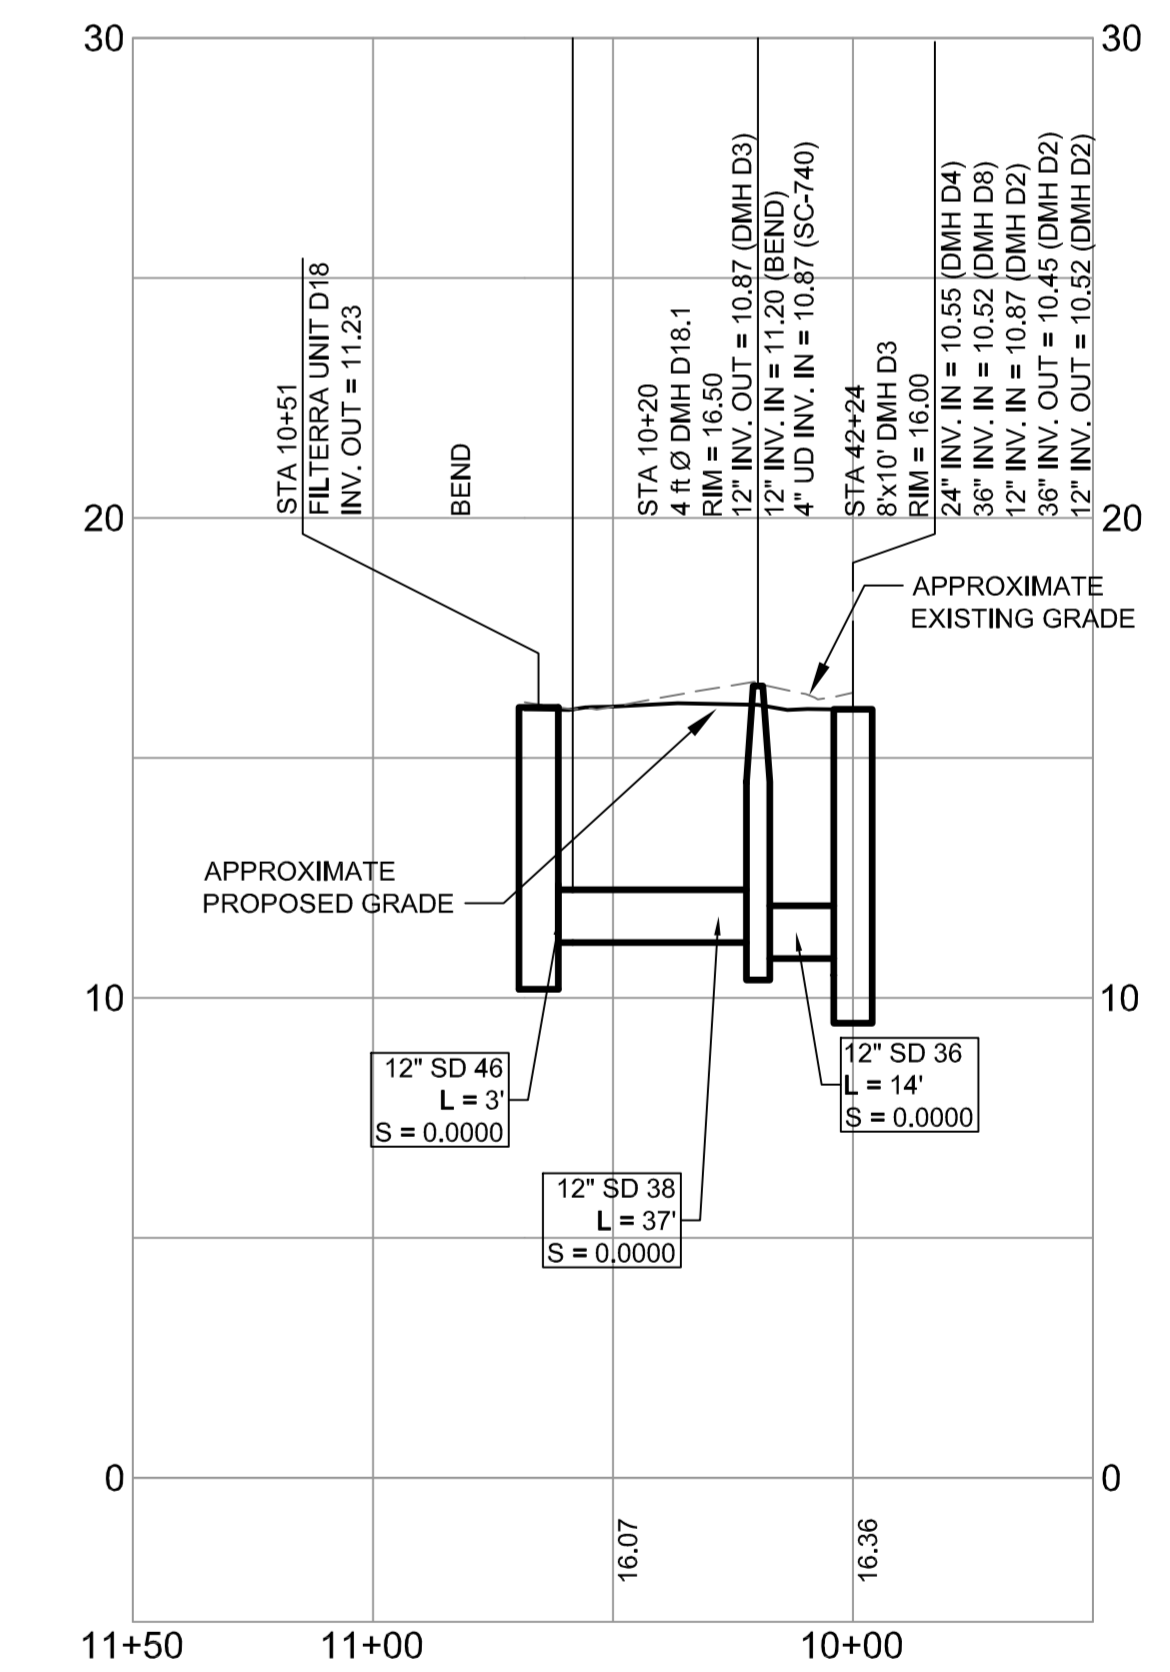

STORM DRAIN PROFILE DMH D3 TO FILTERRA D18
SCALE: H 1" = 4'
V 1" = 4'

REV	DATE	DESCRIPTION
3	12.01.14	FINAL PHASE 1A SITE PLAN SUBMITTED TO CITY
2	07.29.14	REVISED PHASE 1A SITE PLAN SUBMITTED TO CITY
1	06.30.14	AMENDED PHASE 1A SITE PLAN SUBMITTED TO CITY

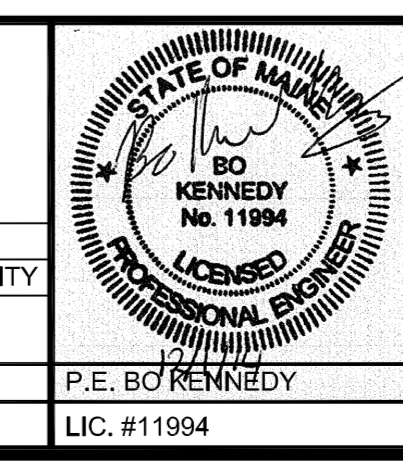

PROJECT: BRICK NORTH BUILDING AT THE FOREFRONT AT THOMPSON'S POINT
SHEET TITLE: STORM DRAIN PROFILES ZONE D AND F
CLIENT: FOREFRONT PARTNERS | LP

FST FAY, SPOFFORD & THORNDIKE
ENGINEERS - PLANNERS - SCIENTISTS
778 MAIN ST, SUITE 8, SOUTH PORTLAND, ME 04106
DRAWN: DEB
DESIGNED: DEB
CHECKED: DEB
FILE NAME: C-12.12
DATE: JUNE 2014
SCALE: CITY OF PORTLAND
JOB NO. 2014-120
PROJECT NO. 2014-120