




STORM DRAIN PROFILE - D0 TO EX. CB  
SCALE: H 1" = 40'  
V 1" = 4'

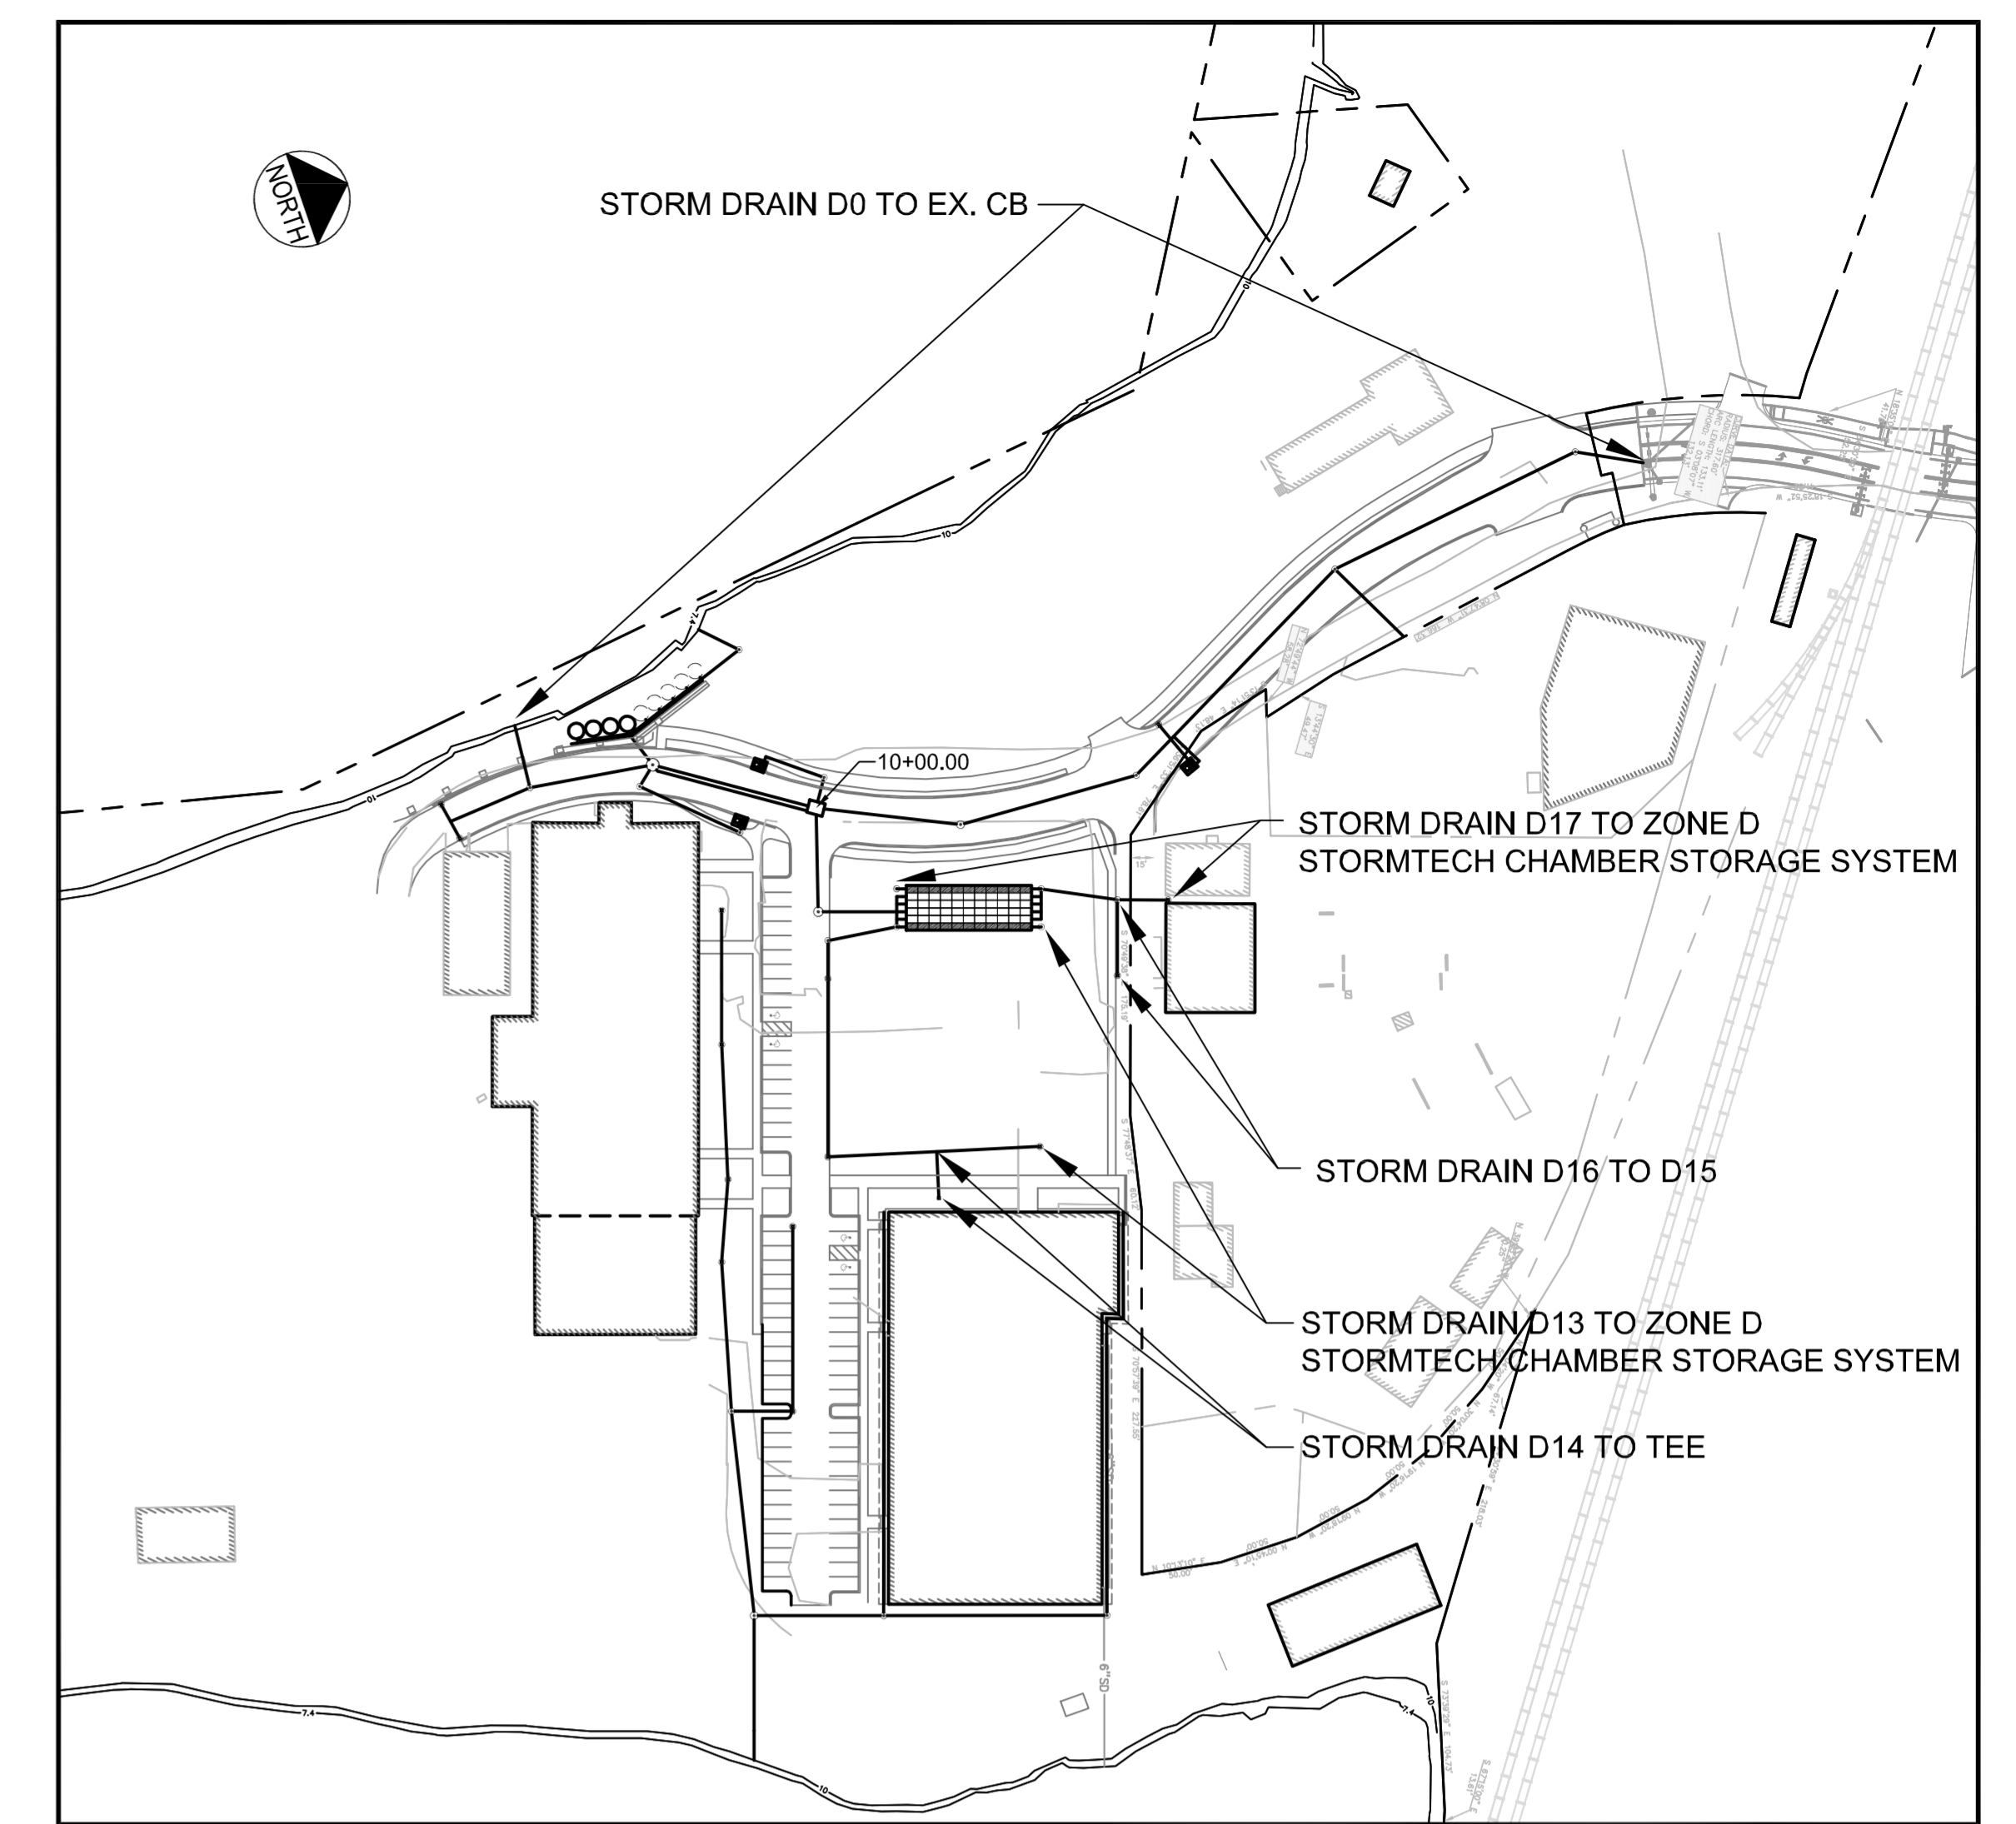


ORIENTATION SKETCH  
N.T.S.

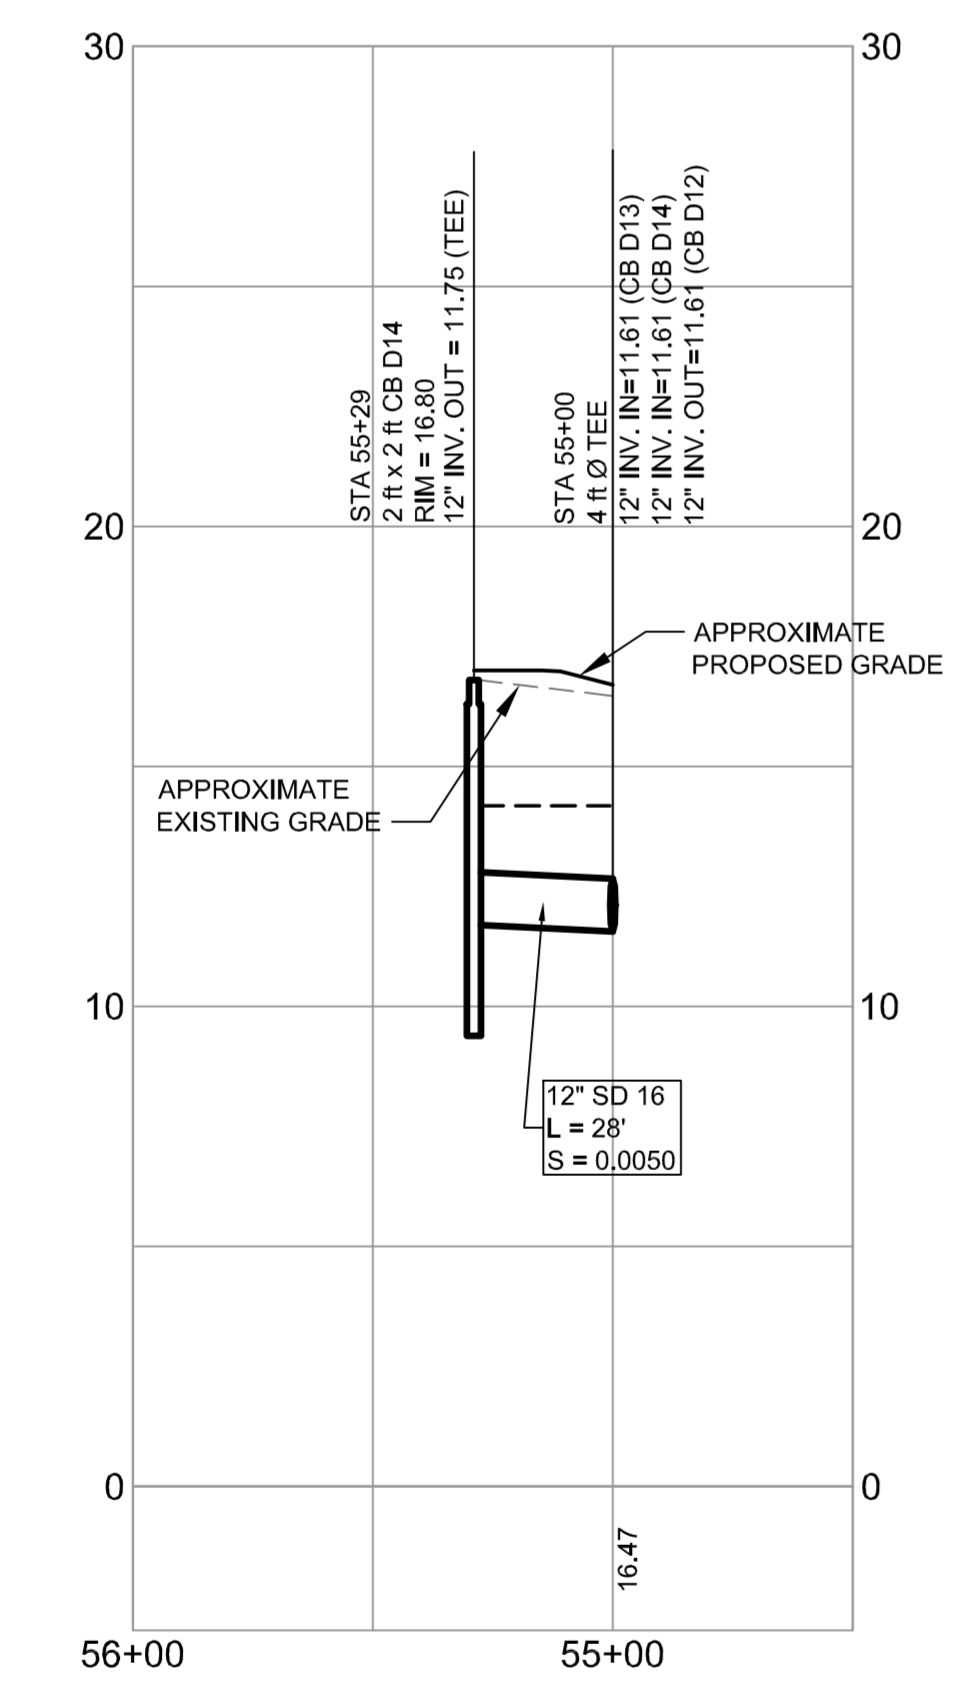


STORM DRAIN PROFILE - D14 TO TEE  
SCALE: H 1" = 40'  
V 1" = 4'

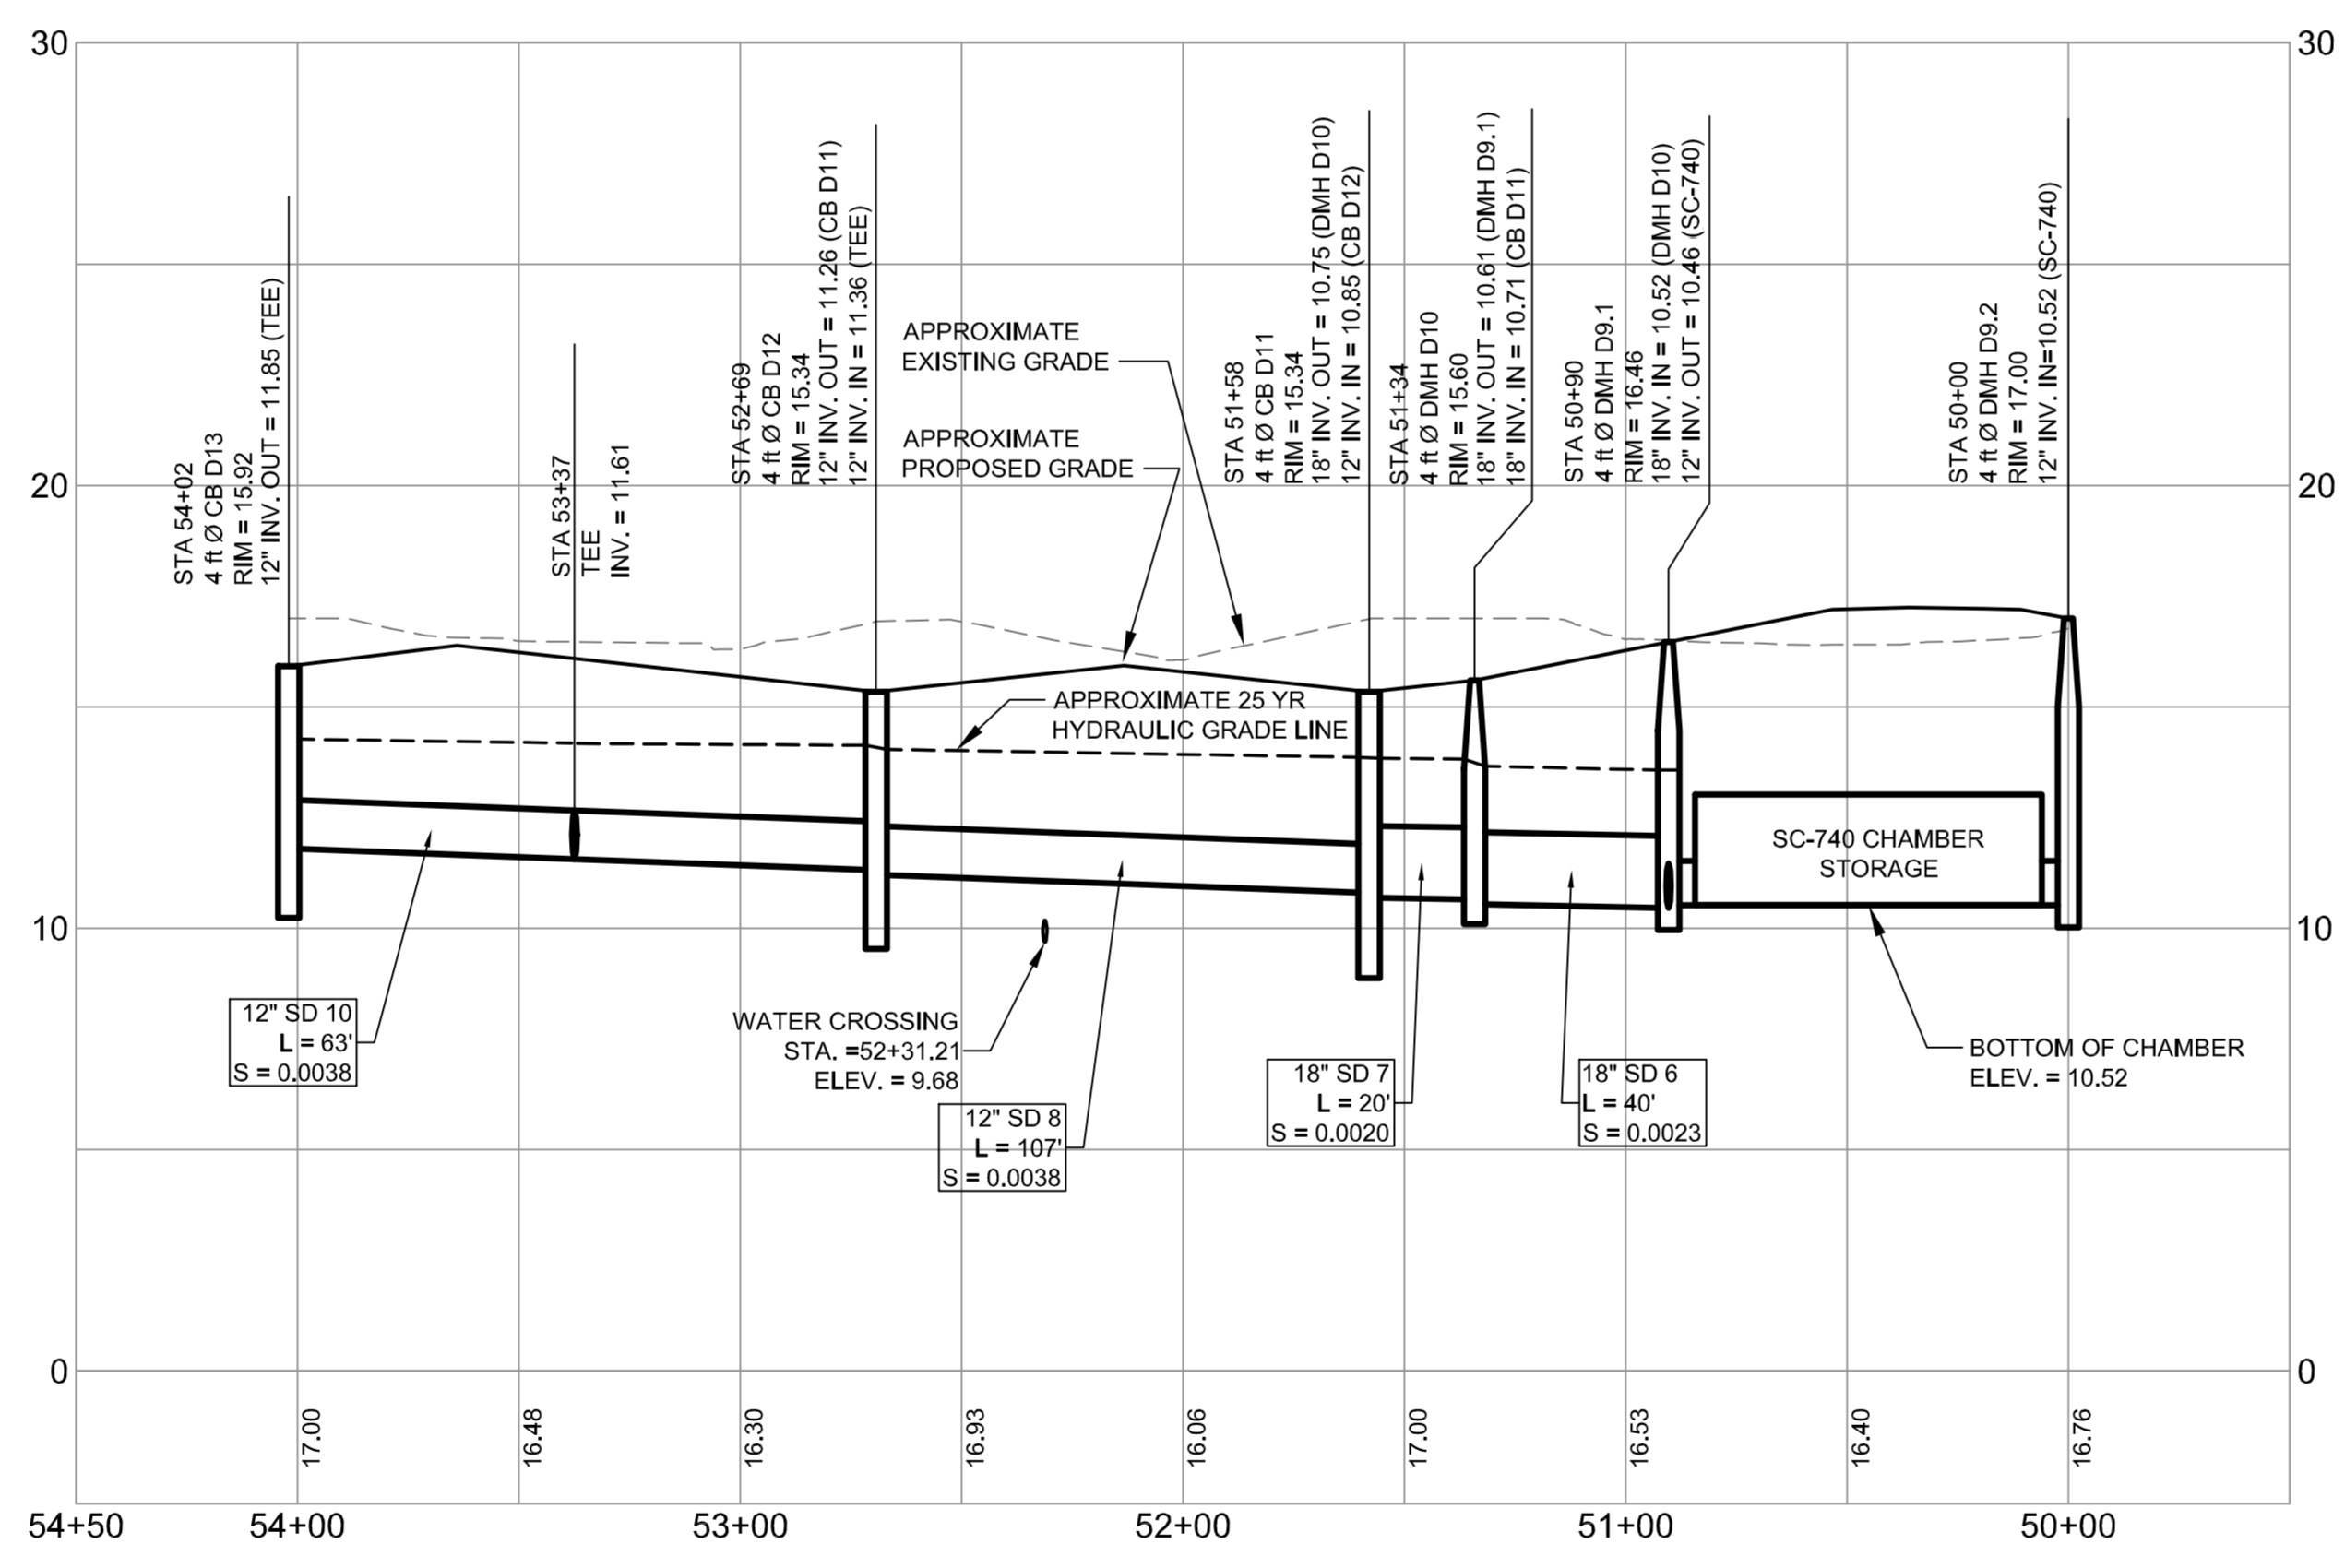

STORM DRAIN PROFILE - D13 TO ZONE D STORMTECH CHAMBER STORAGE SYSTEM  
SCALE: H 1" = 40'  
V 1" = 4'

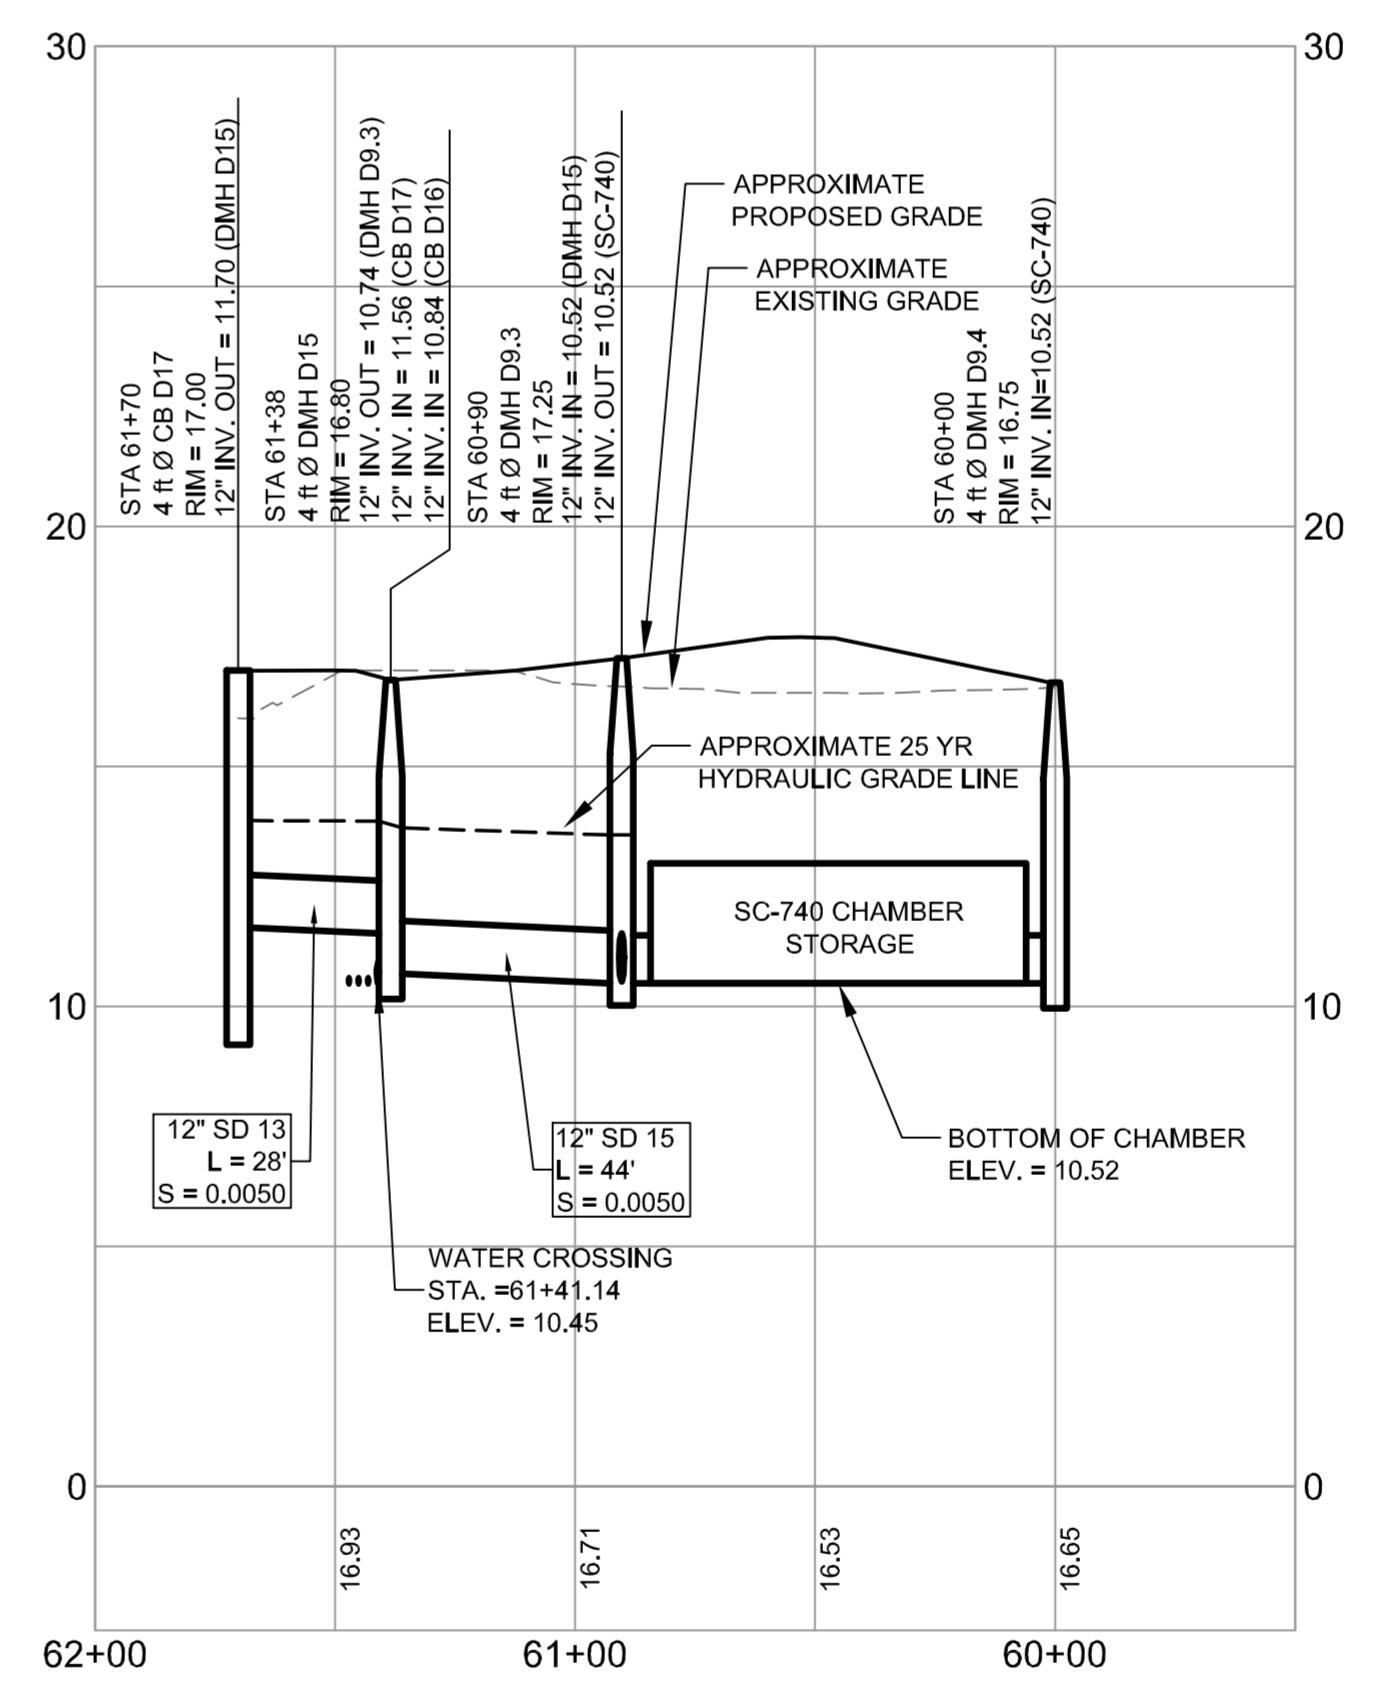


STORM DRAIN PROFILE - D17 TO ZONE D STORMTECH CHAMBER STORAGE SYSTEM  
SCALE: H 1" = 40'  
V 1" = 4'

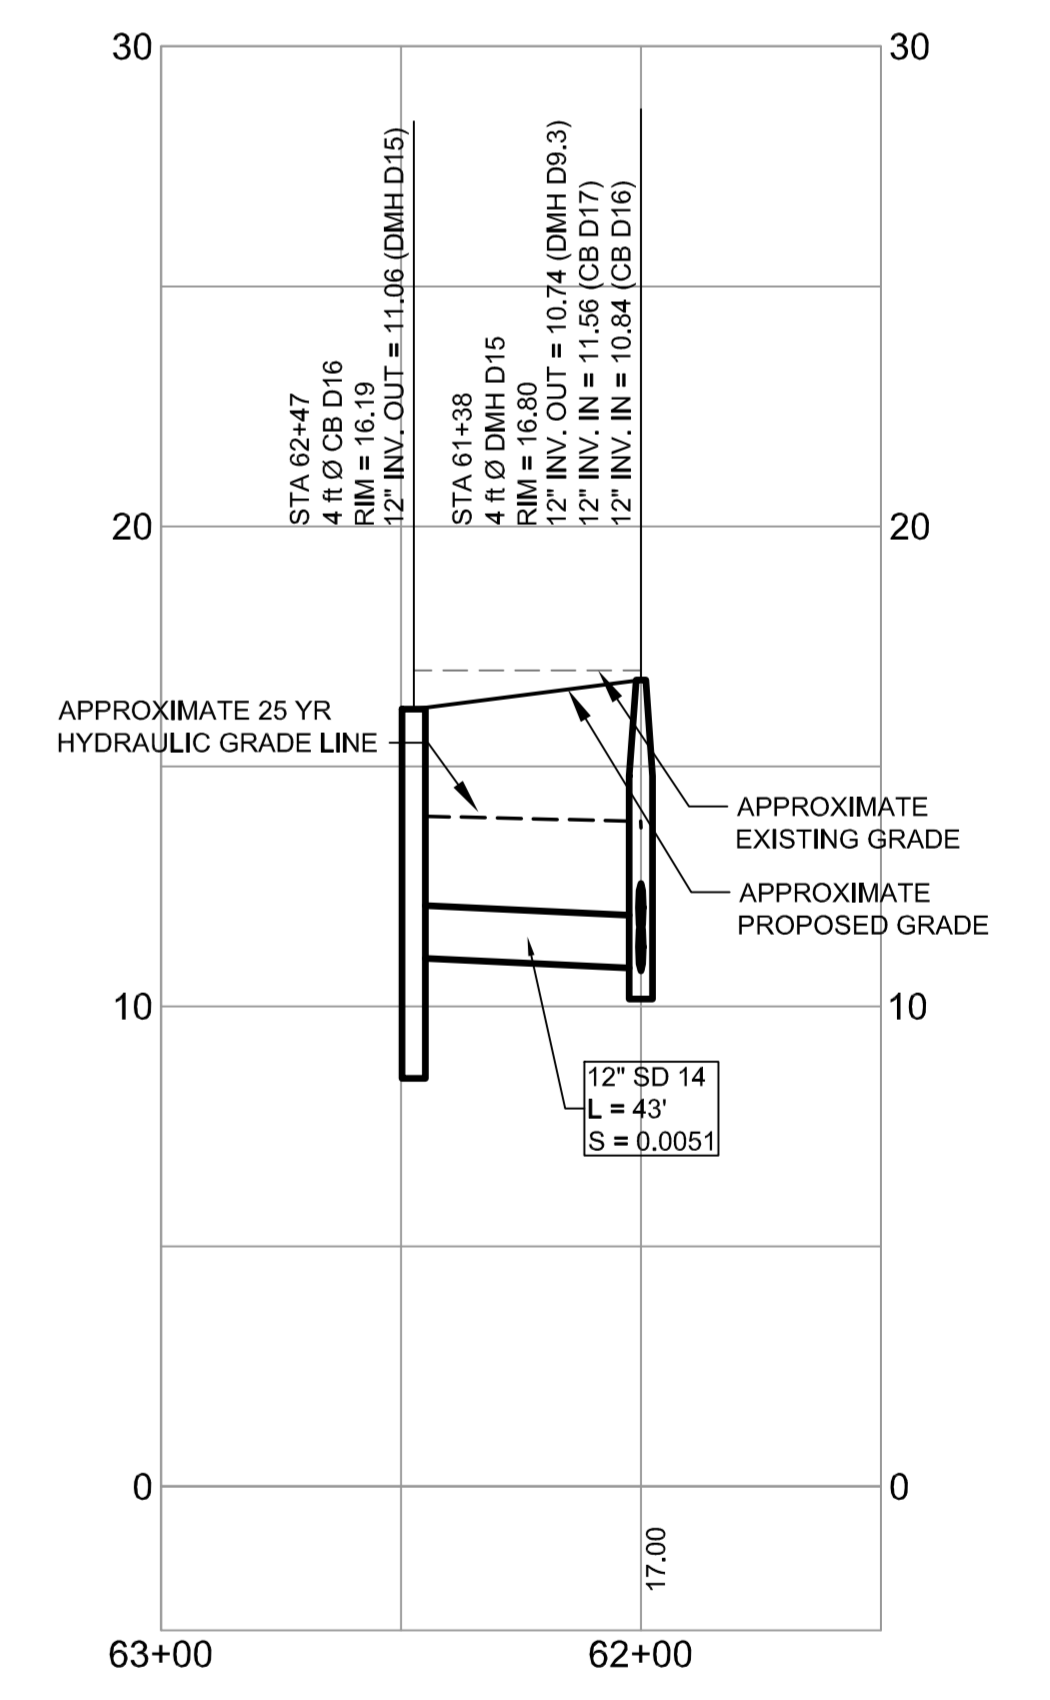

STORM DRAIN PROFILE - D16 TO D15  
SCALE: H 1" = 40'  
V 1" = 4'

REV	DATE	DESCRIPTION
3	12.01.14	FINAL PHASE 1A SITE PLAN SUBMITTED TO CITY
2	07.29.14	REVISED PHASE 1A SITE PLAN SUBMITTED TO CITY
1	06.30.14	AMENDED PHASE 1A SITE PLAN SUBMITTED TO CITY

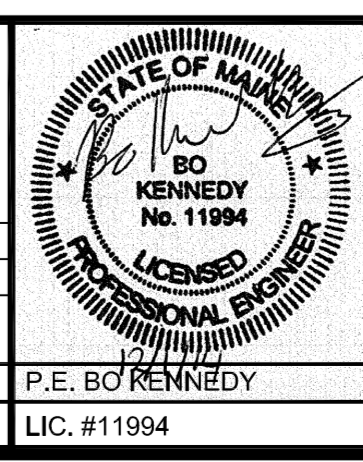

PROJECT: BRICK NORTH BUILDING AT THE FOREFRONT AT THOMPSON'S POINT  
SHEET TITLE: STORM DRAIN PROFILES ZONE D  
CLIENT: FOREFRONT PARTNERS | LP

FST FAY, SPOFFORD & THORNDIKE ENGINEERS - PLANNERS - SCIENTISTS  
778 MAIN ST, SUITE 8, SOUTH PORTLAND, ME 04106  
DRAWN: DEB DATE: JUNE 2014  
DESIGNED: BO KENNEDY SCALE: AS SHOWN  
CHECKED: BO KENNEDY JOB NO. 2014-120  
FILE NAME: C-12.0  
SHEET: 12 OF 12  
DATE OF APPROVAL: Dec 4, 2014  
PLANNER: Christine Grimando  
PROJECT NO.: 2014-120