




STORM DRAIN PROFILE - D0 TO EX. CB
SCALE: H 1" = 40'
V 1" = 4'

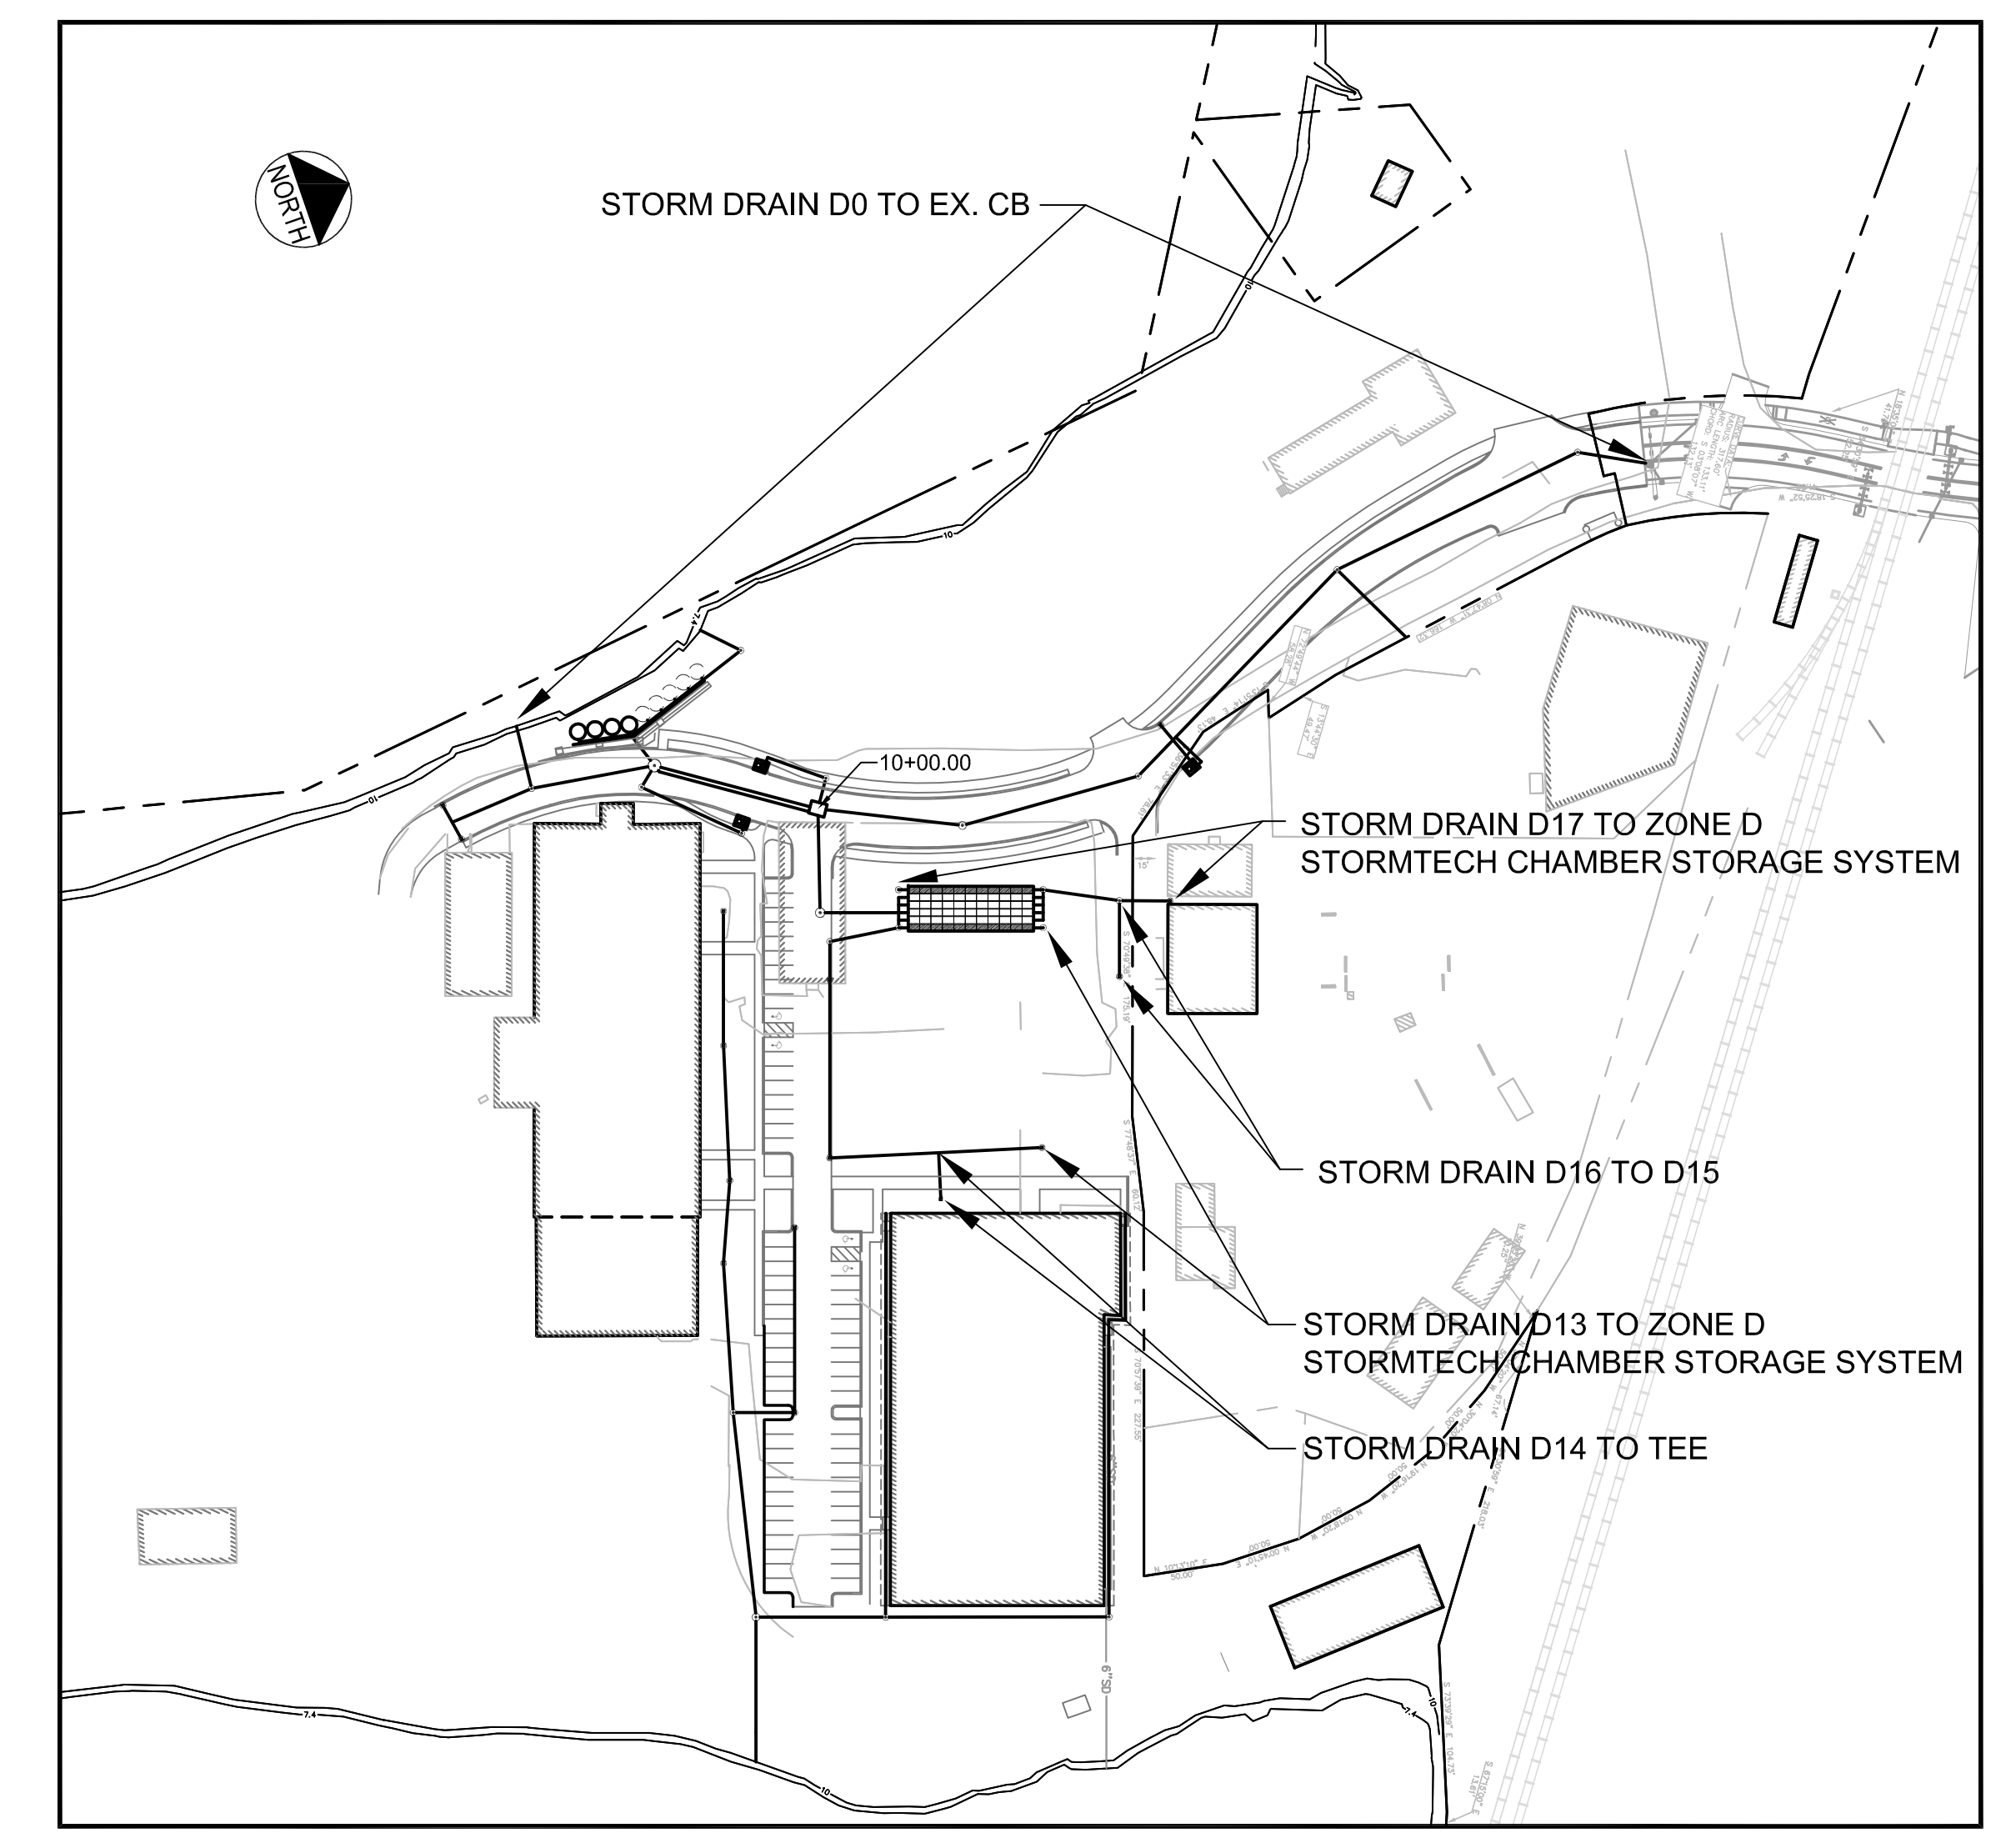


ORIENTATION SKETCH
N.T.S.

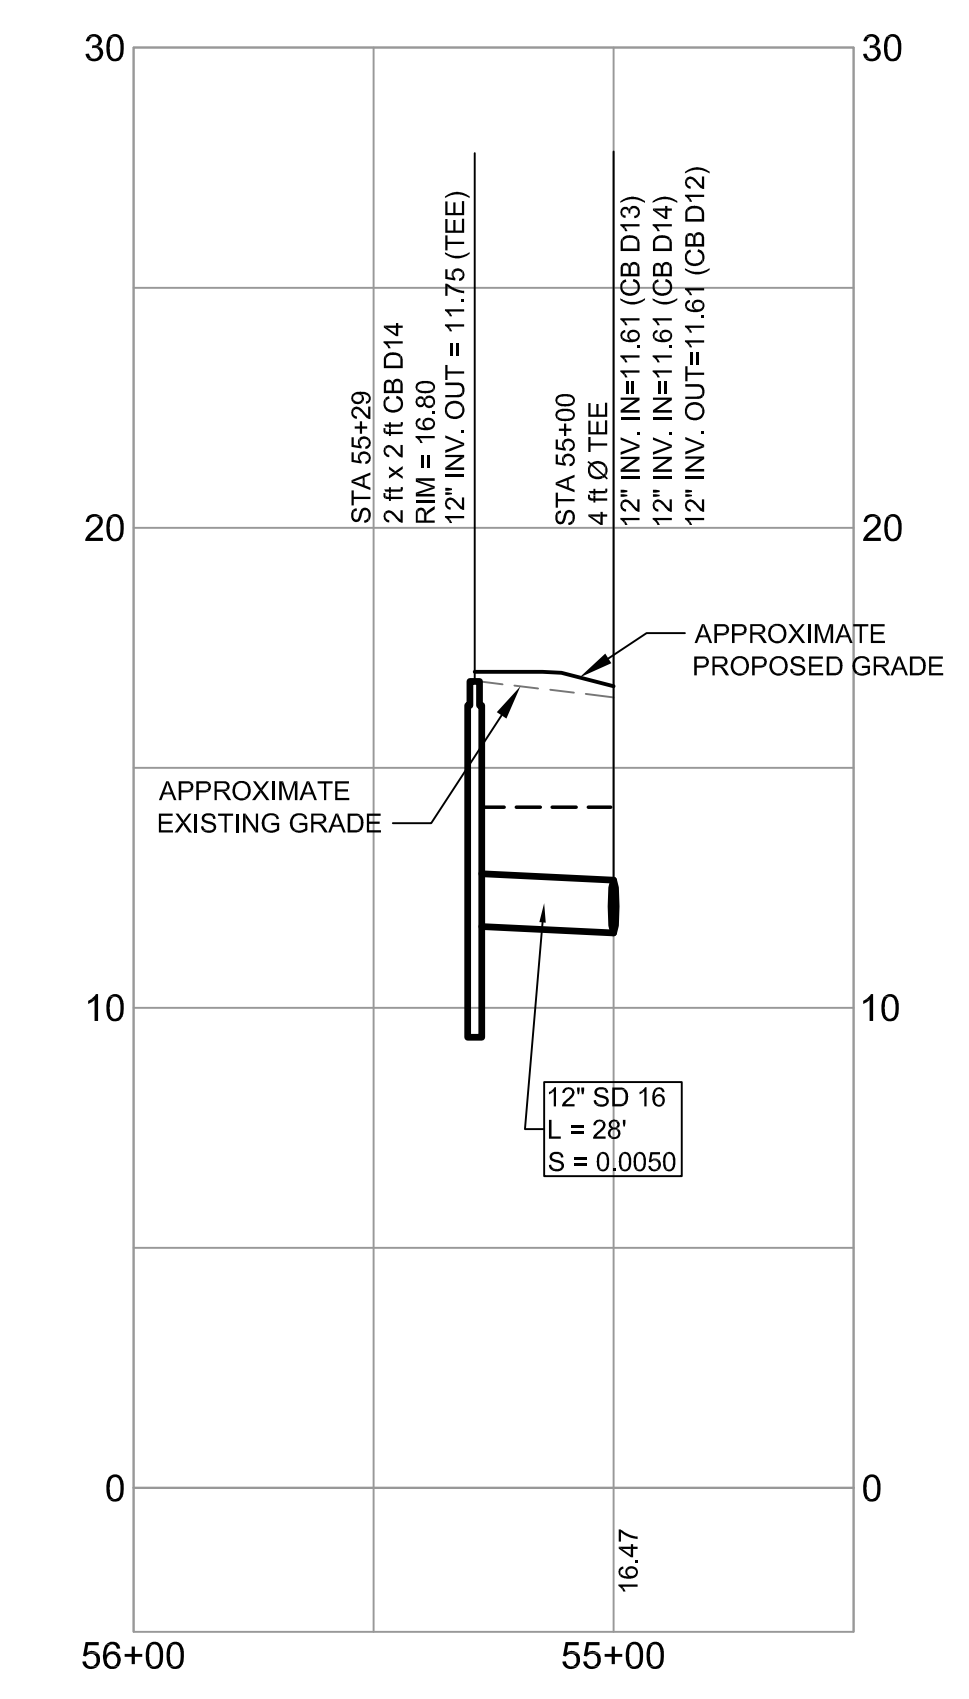


STORM DRAIN PROFILE - D14 TO TEE
SCALE: H 1" = 40'
V 1" = 4'

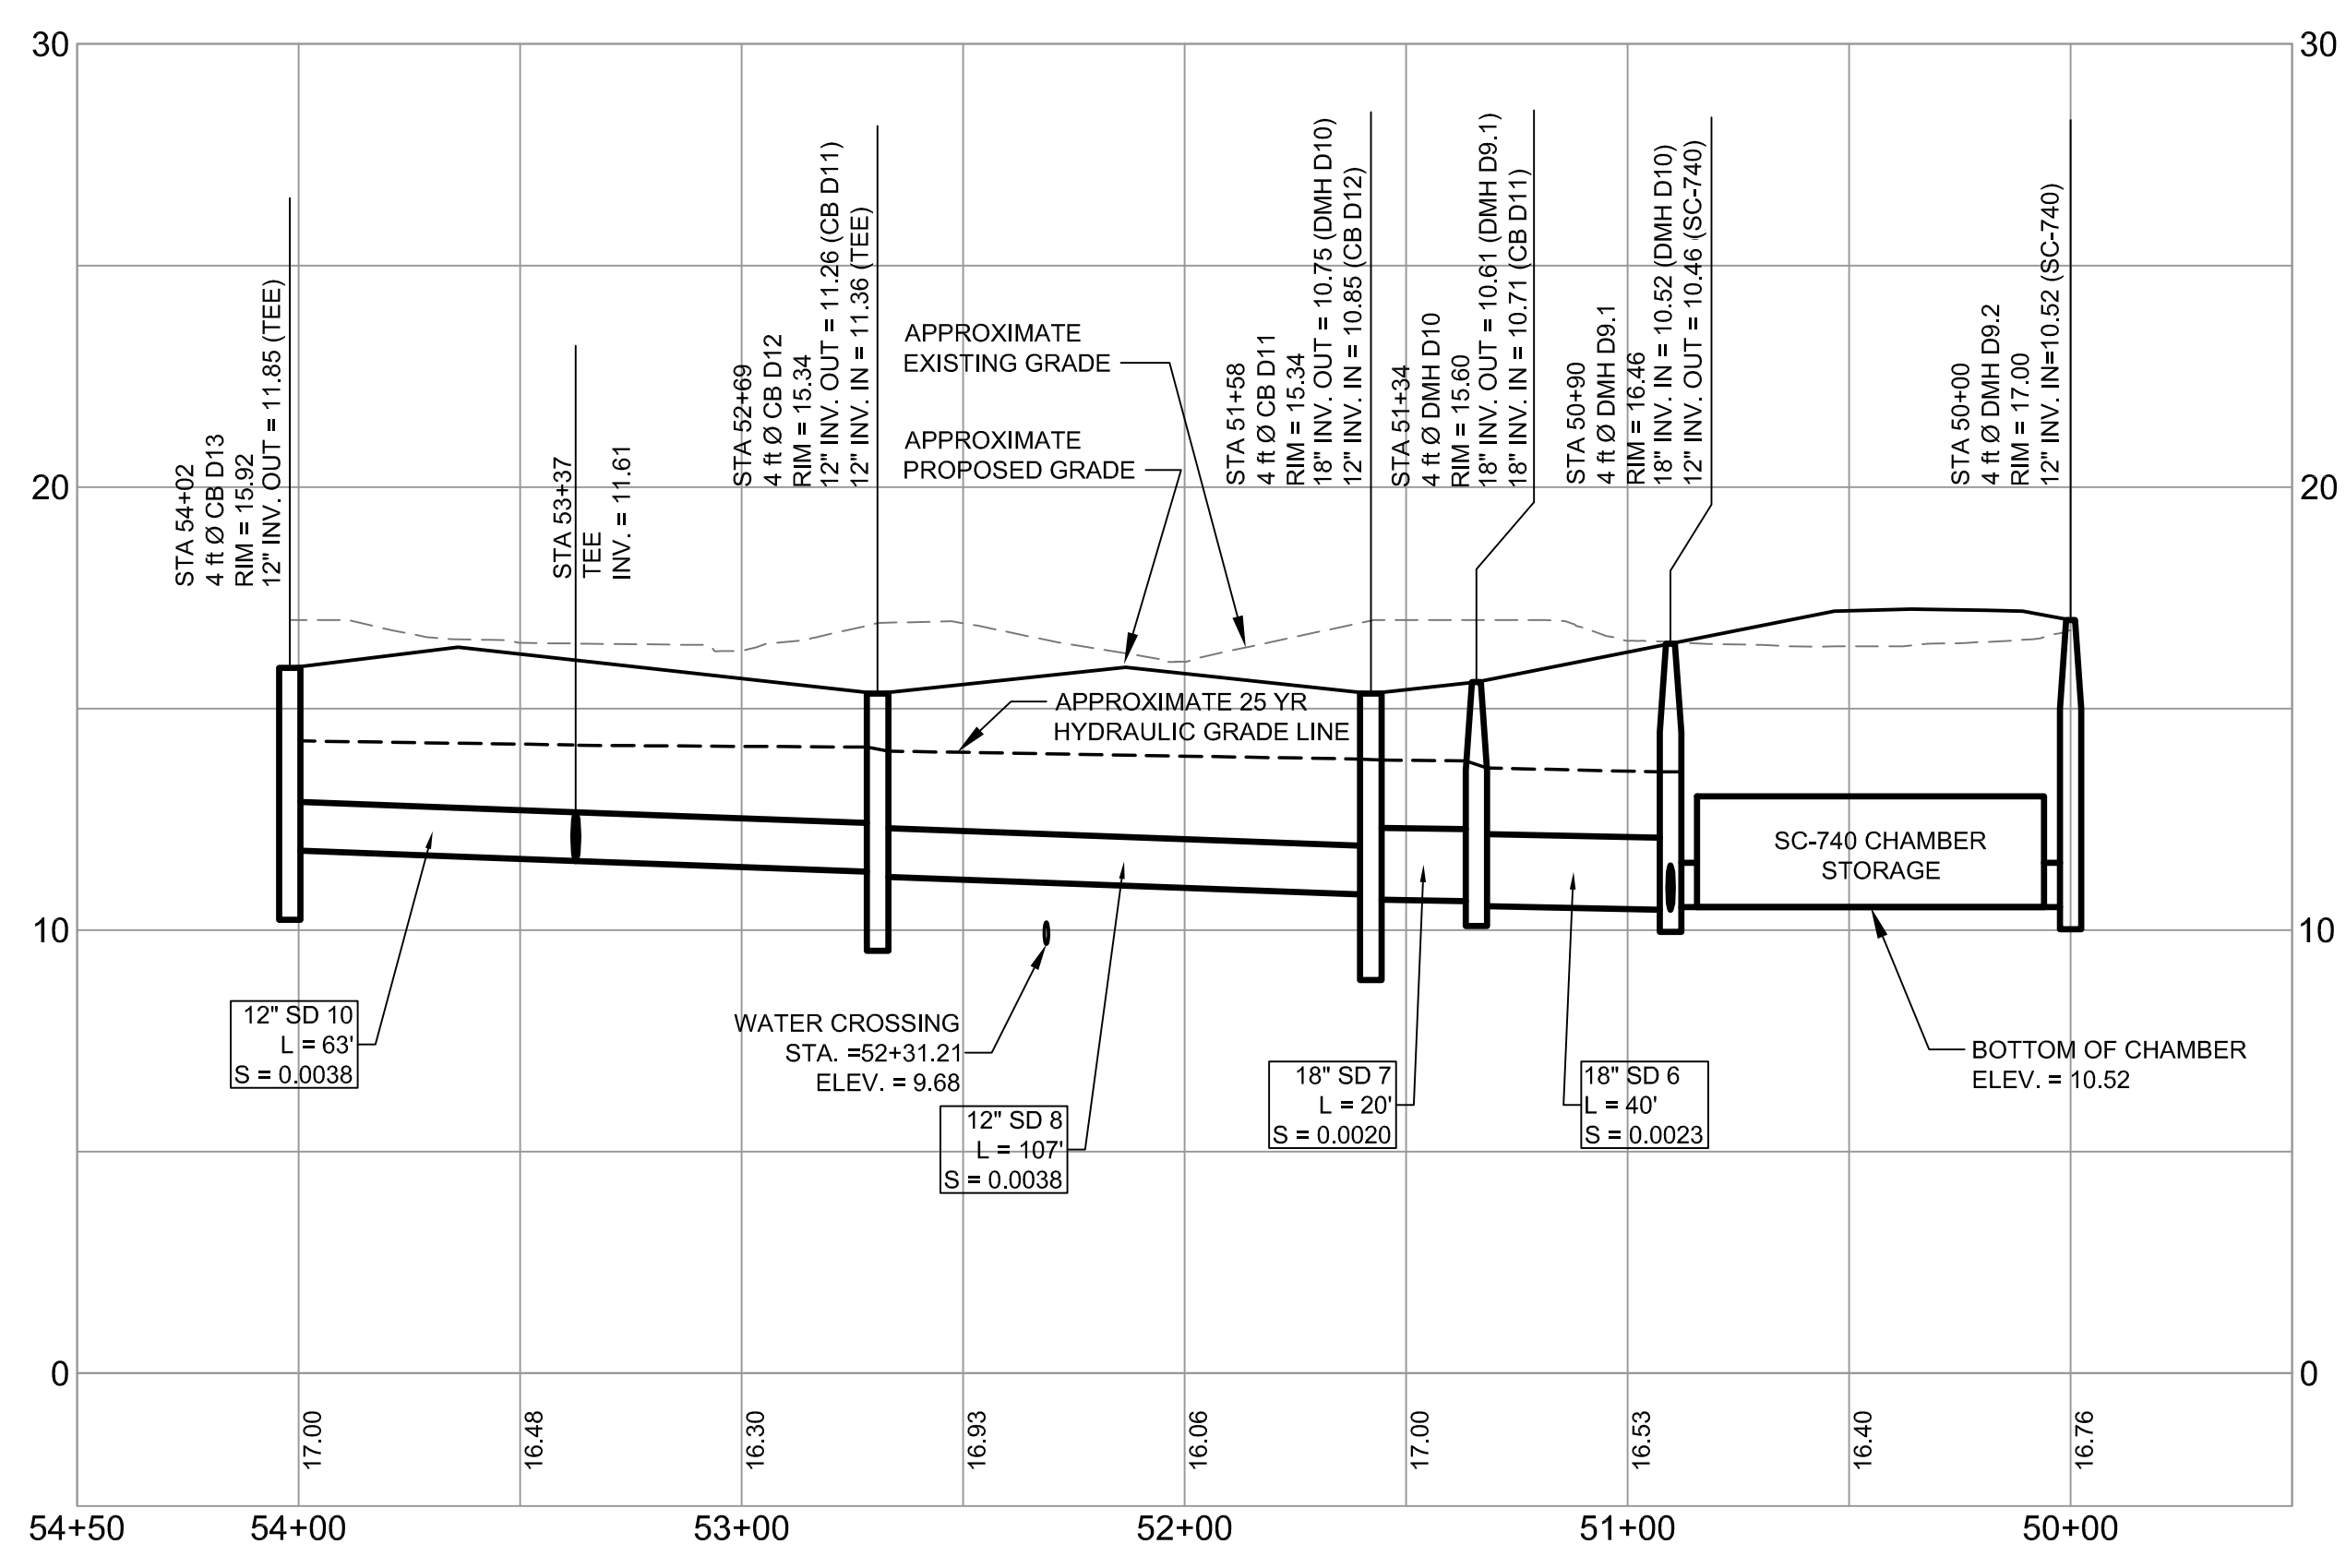

STORM DRAIN PROFILE - D13 TO ZONE D STORMTECH CHAMBER STORAGE SYSTEM
SCALE: H 1" = 40'
V 1" = 4'

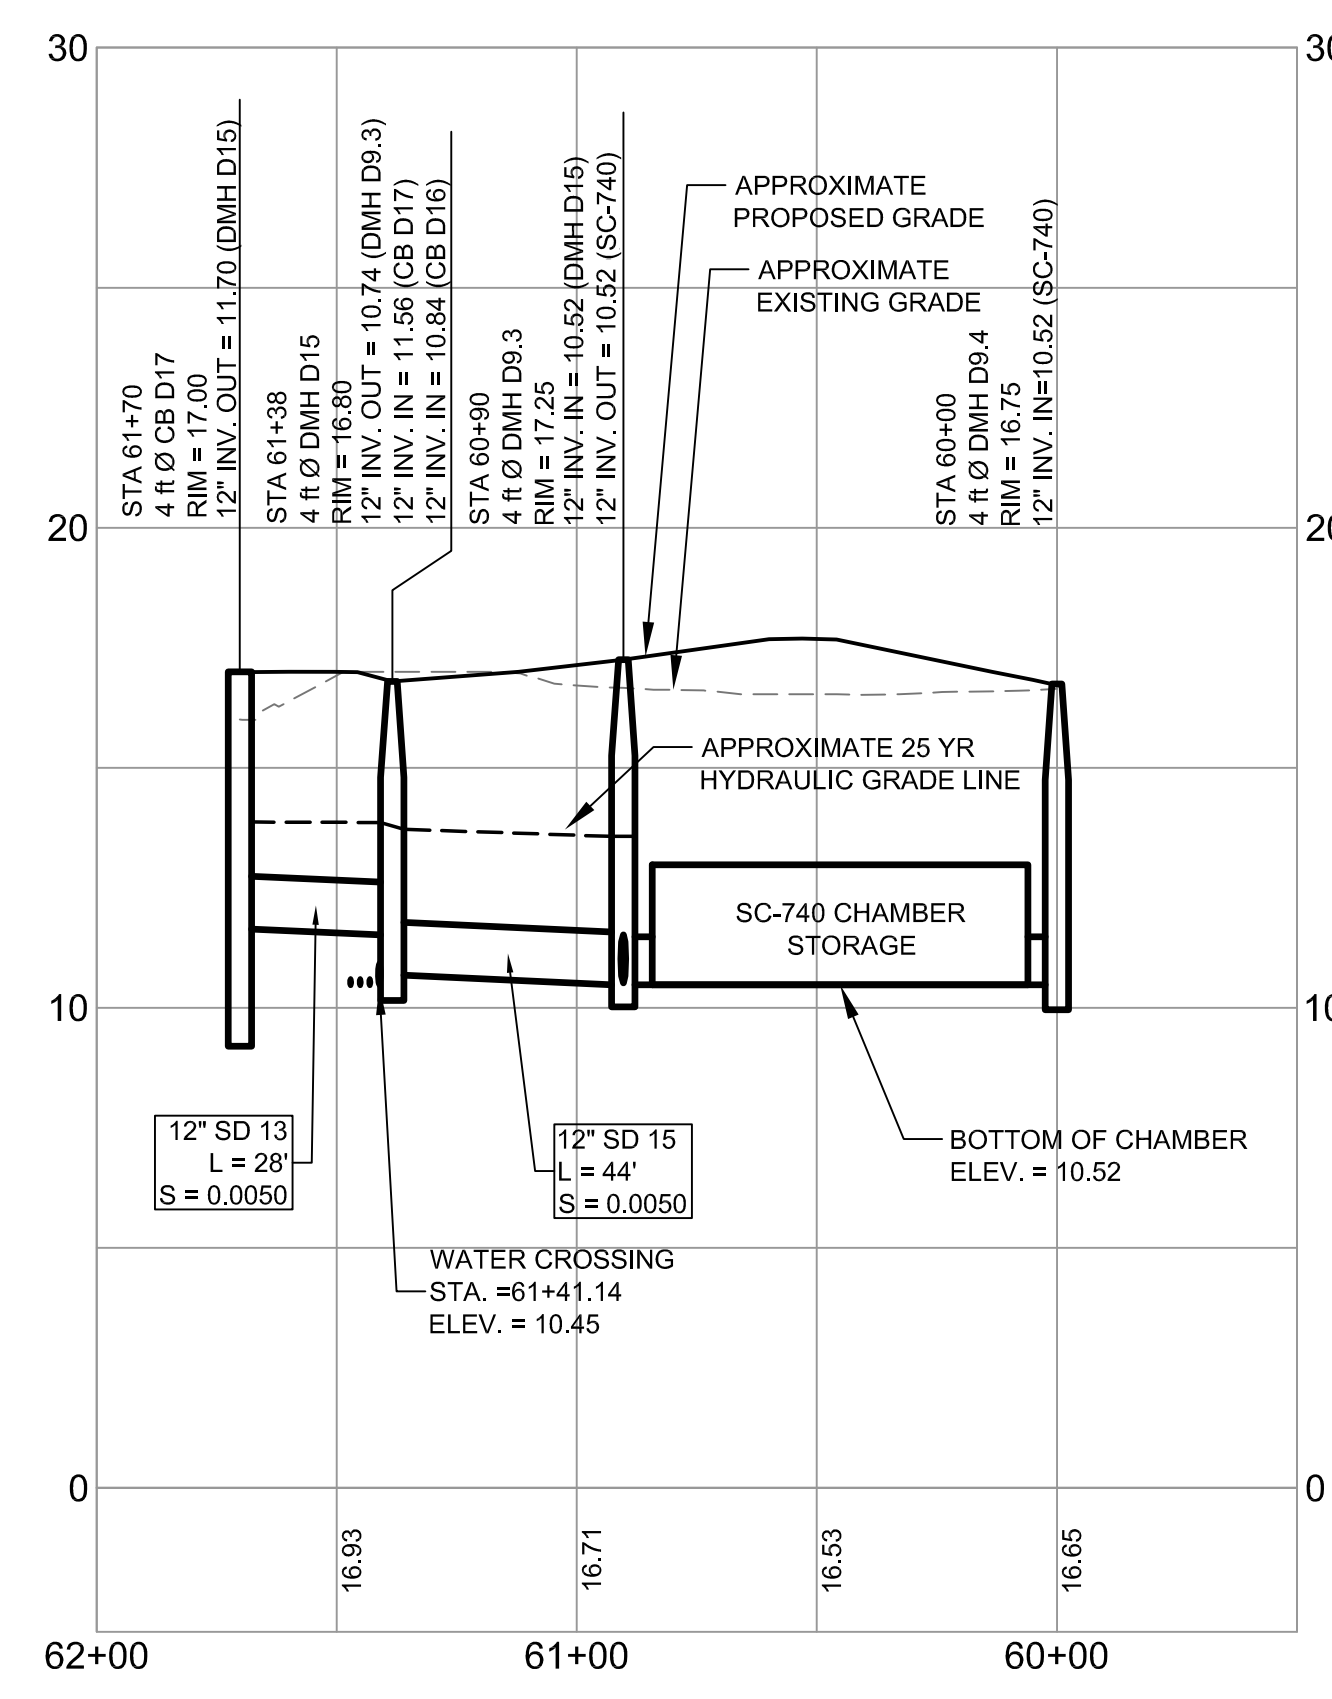

STORM DRAIN PROFILE - D17 TO ZONE D STORMTECH CHAMBER STORAGE SYSTEM
SCALE: H 1" = 40'
V 1" = 4'

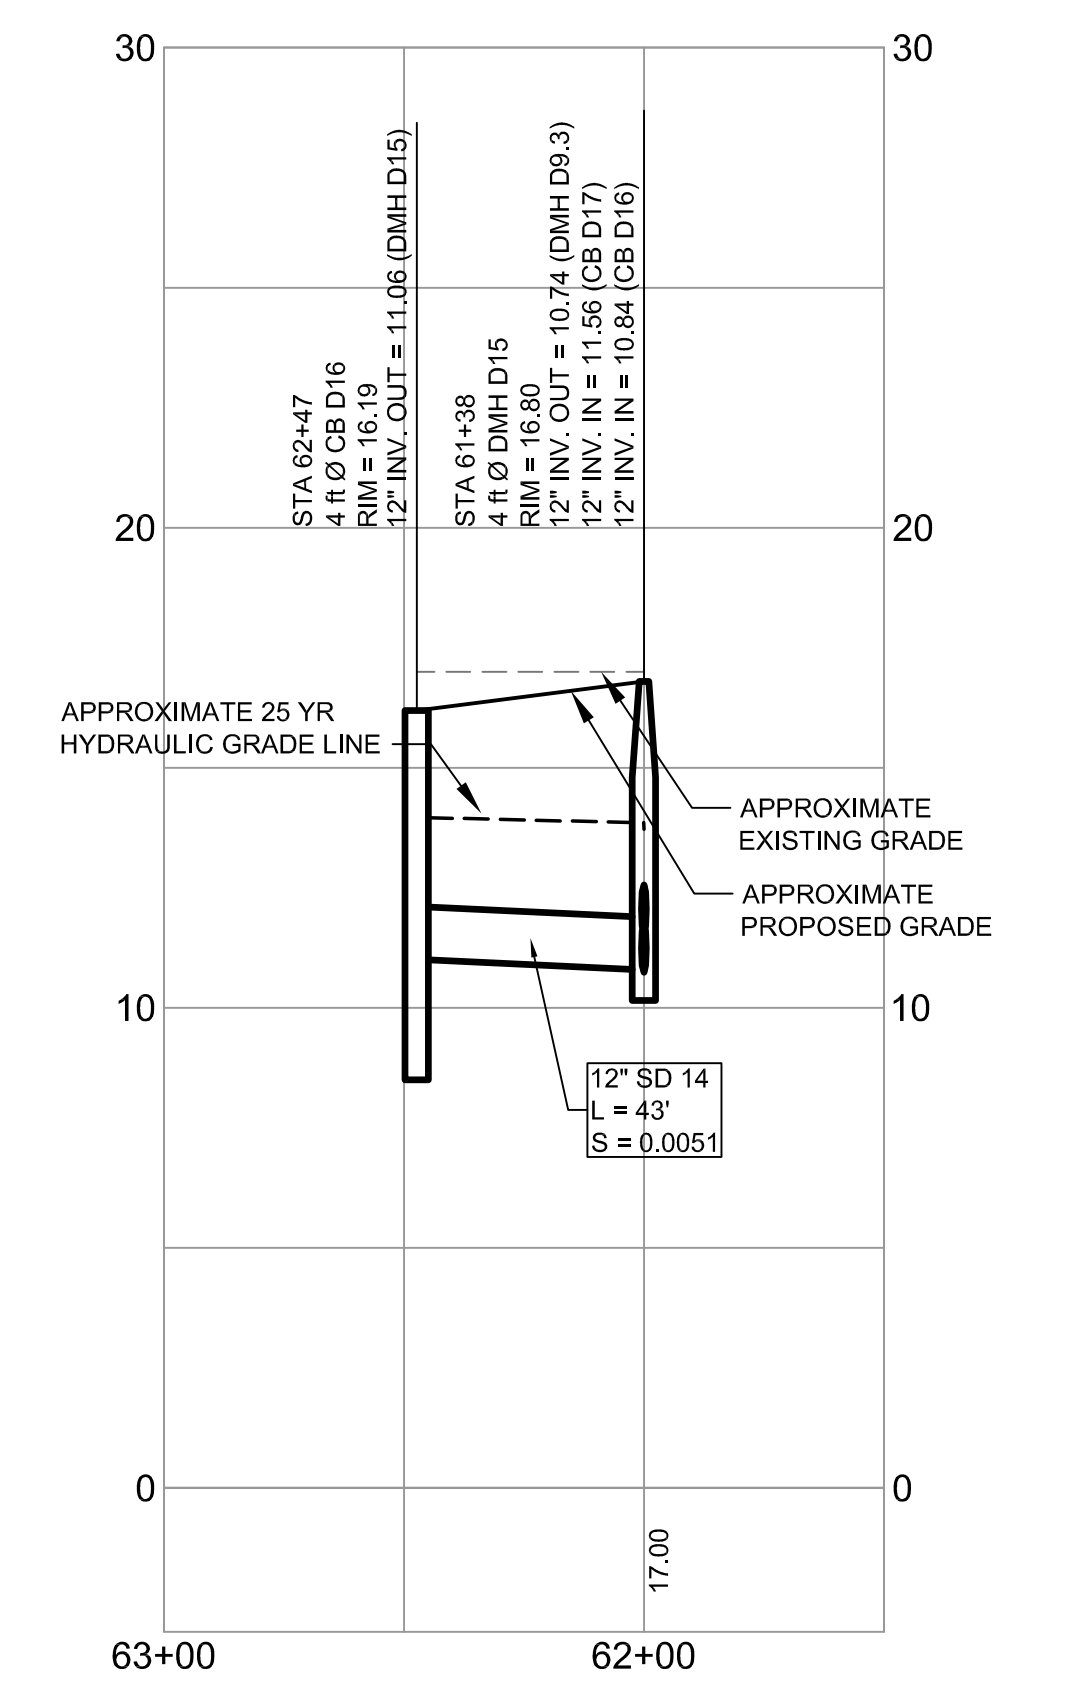

STORM DRAIN PROFILE - D16 TO D15
SCALE: H 1" = 40'
V 1" = 4'

		PROJECT BRICK NORTH BUILDING AT THE FOREFRONT AT THOMPSON'S POINT		FAY, SPOFFORD & THORNDIKE ENGINEERS - PLANNERS - SCIENTISTS 778 MAIN ST., SUITE 8, SOUTH PORTLAND, ME 04106	
SHEET TITLE STORM DRAIN PROFILES ZONE D		CLIENT FOREFRONT PARTNERS LP		DRAWN: DEB DESIGNED: BEK CHECKED: SRB FILE NAME: 2982.05-BN PROFILE SD	
REV DATE DESCRIPTION REVISIONS		DATE DESCRIPTION		DATE SCALE JUNE 2014 1" = 40' 2982.05 2982.05 C-12.0	
2	07.29.14	REVISED PHASE 1A SITE PLAN SUBMITTED TO CITY			
1	06.30.14	AMENDED PHASE 1A SITE PLAN SUBMITTED TO CITY			