




STORM DRAIN PROFILE - D0 TO EX. CB
 SCALE: H 1" = 40'
 V 1" = 4'

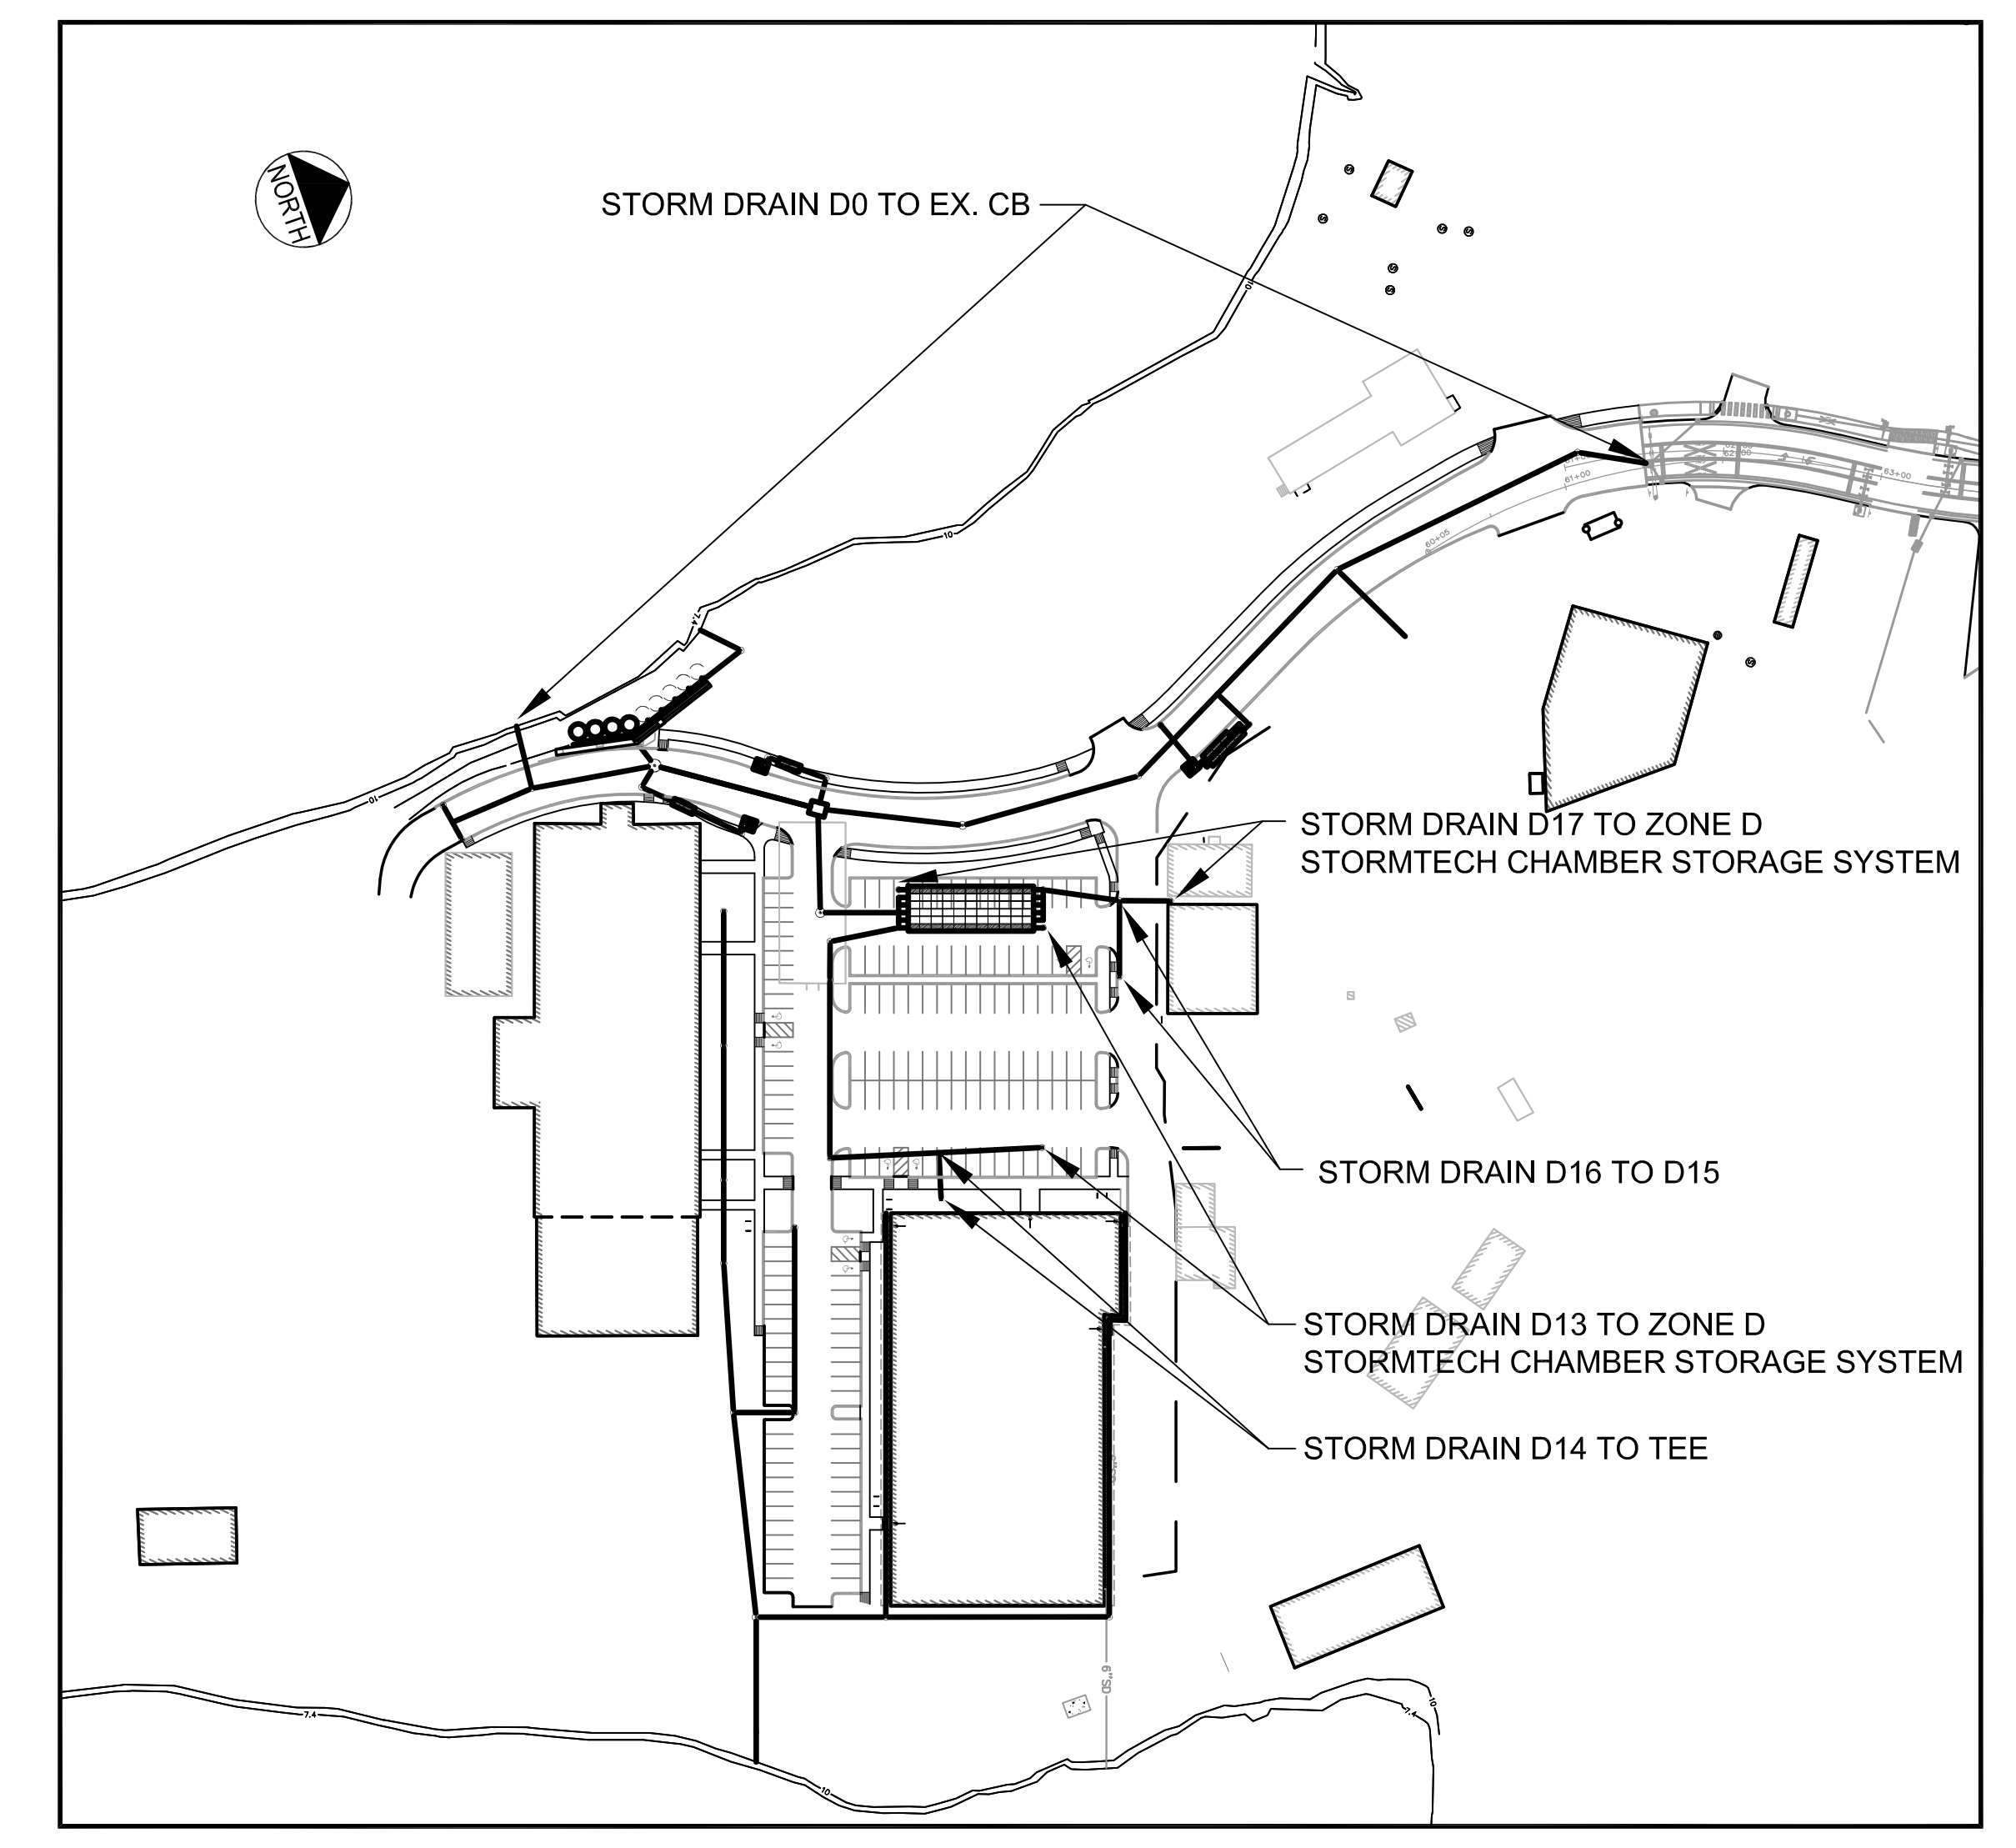


ORIENTATION SKETCH
 N.T.S.

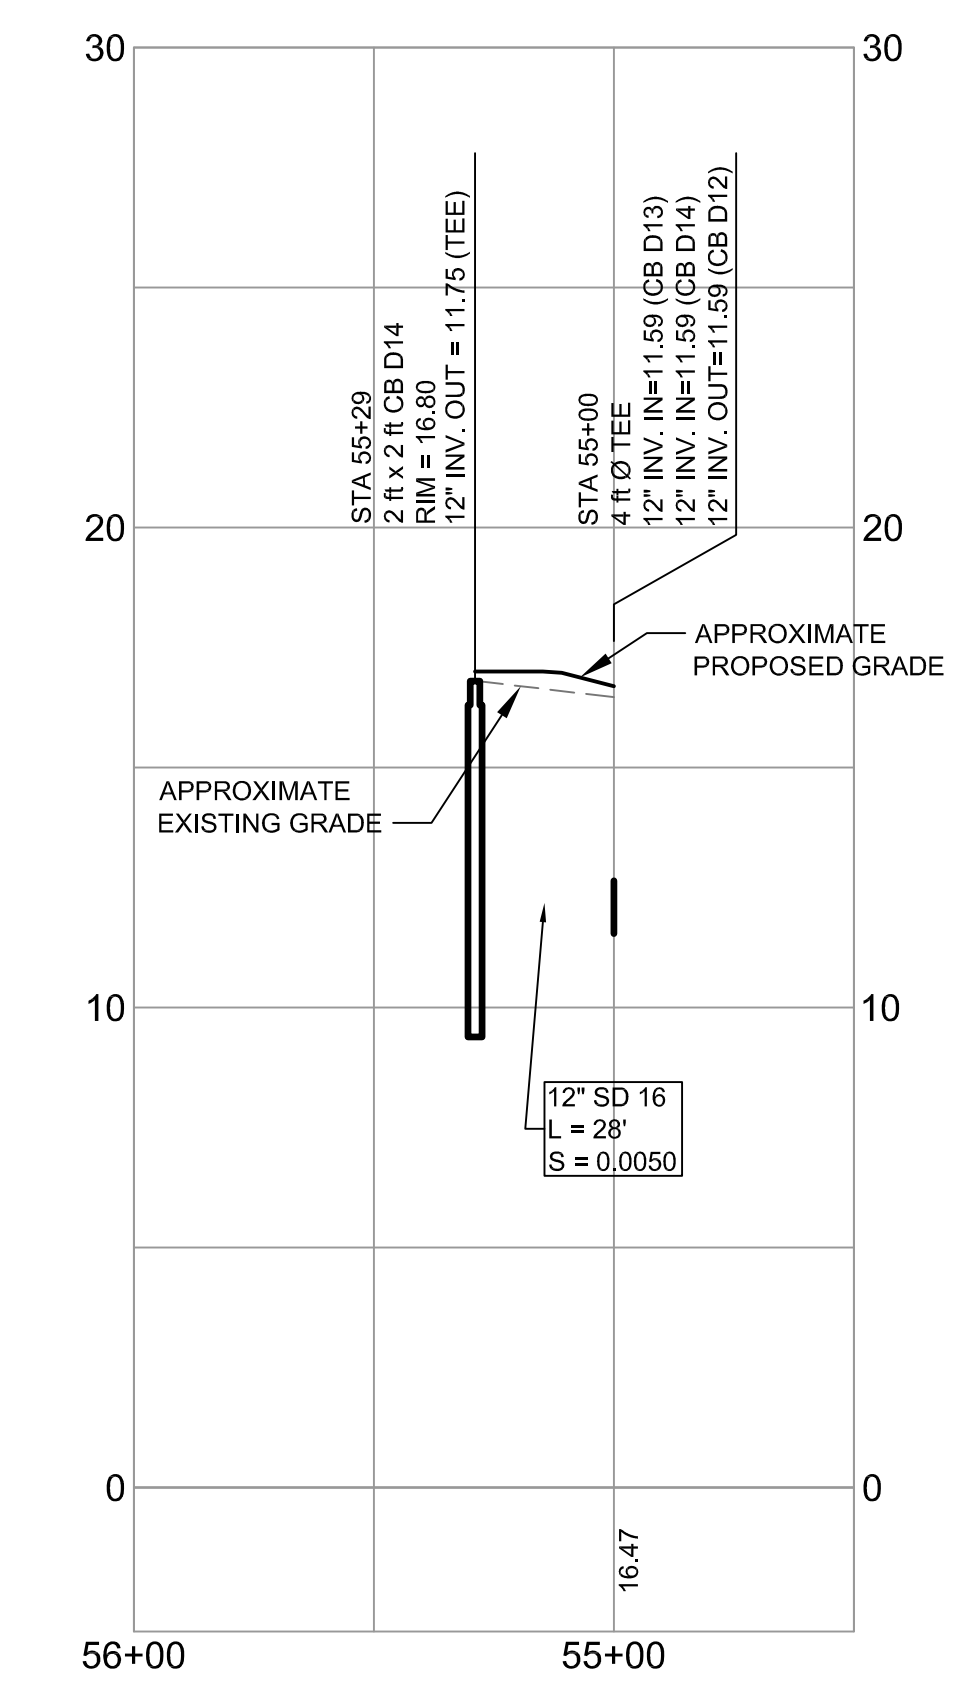


STORM DRAIN PROFILE - D14 TO TEE
 SCALE: H 1" = 40'
 V 1" = 4'

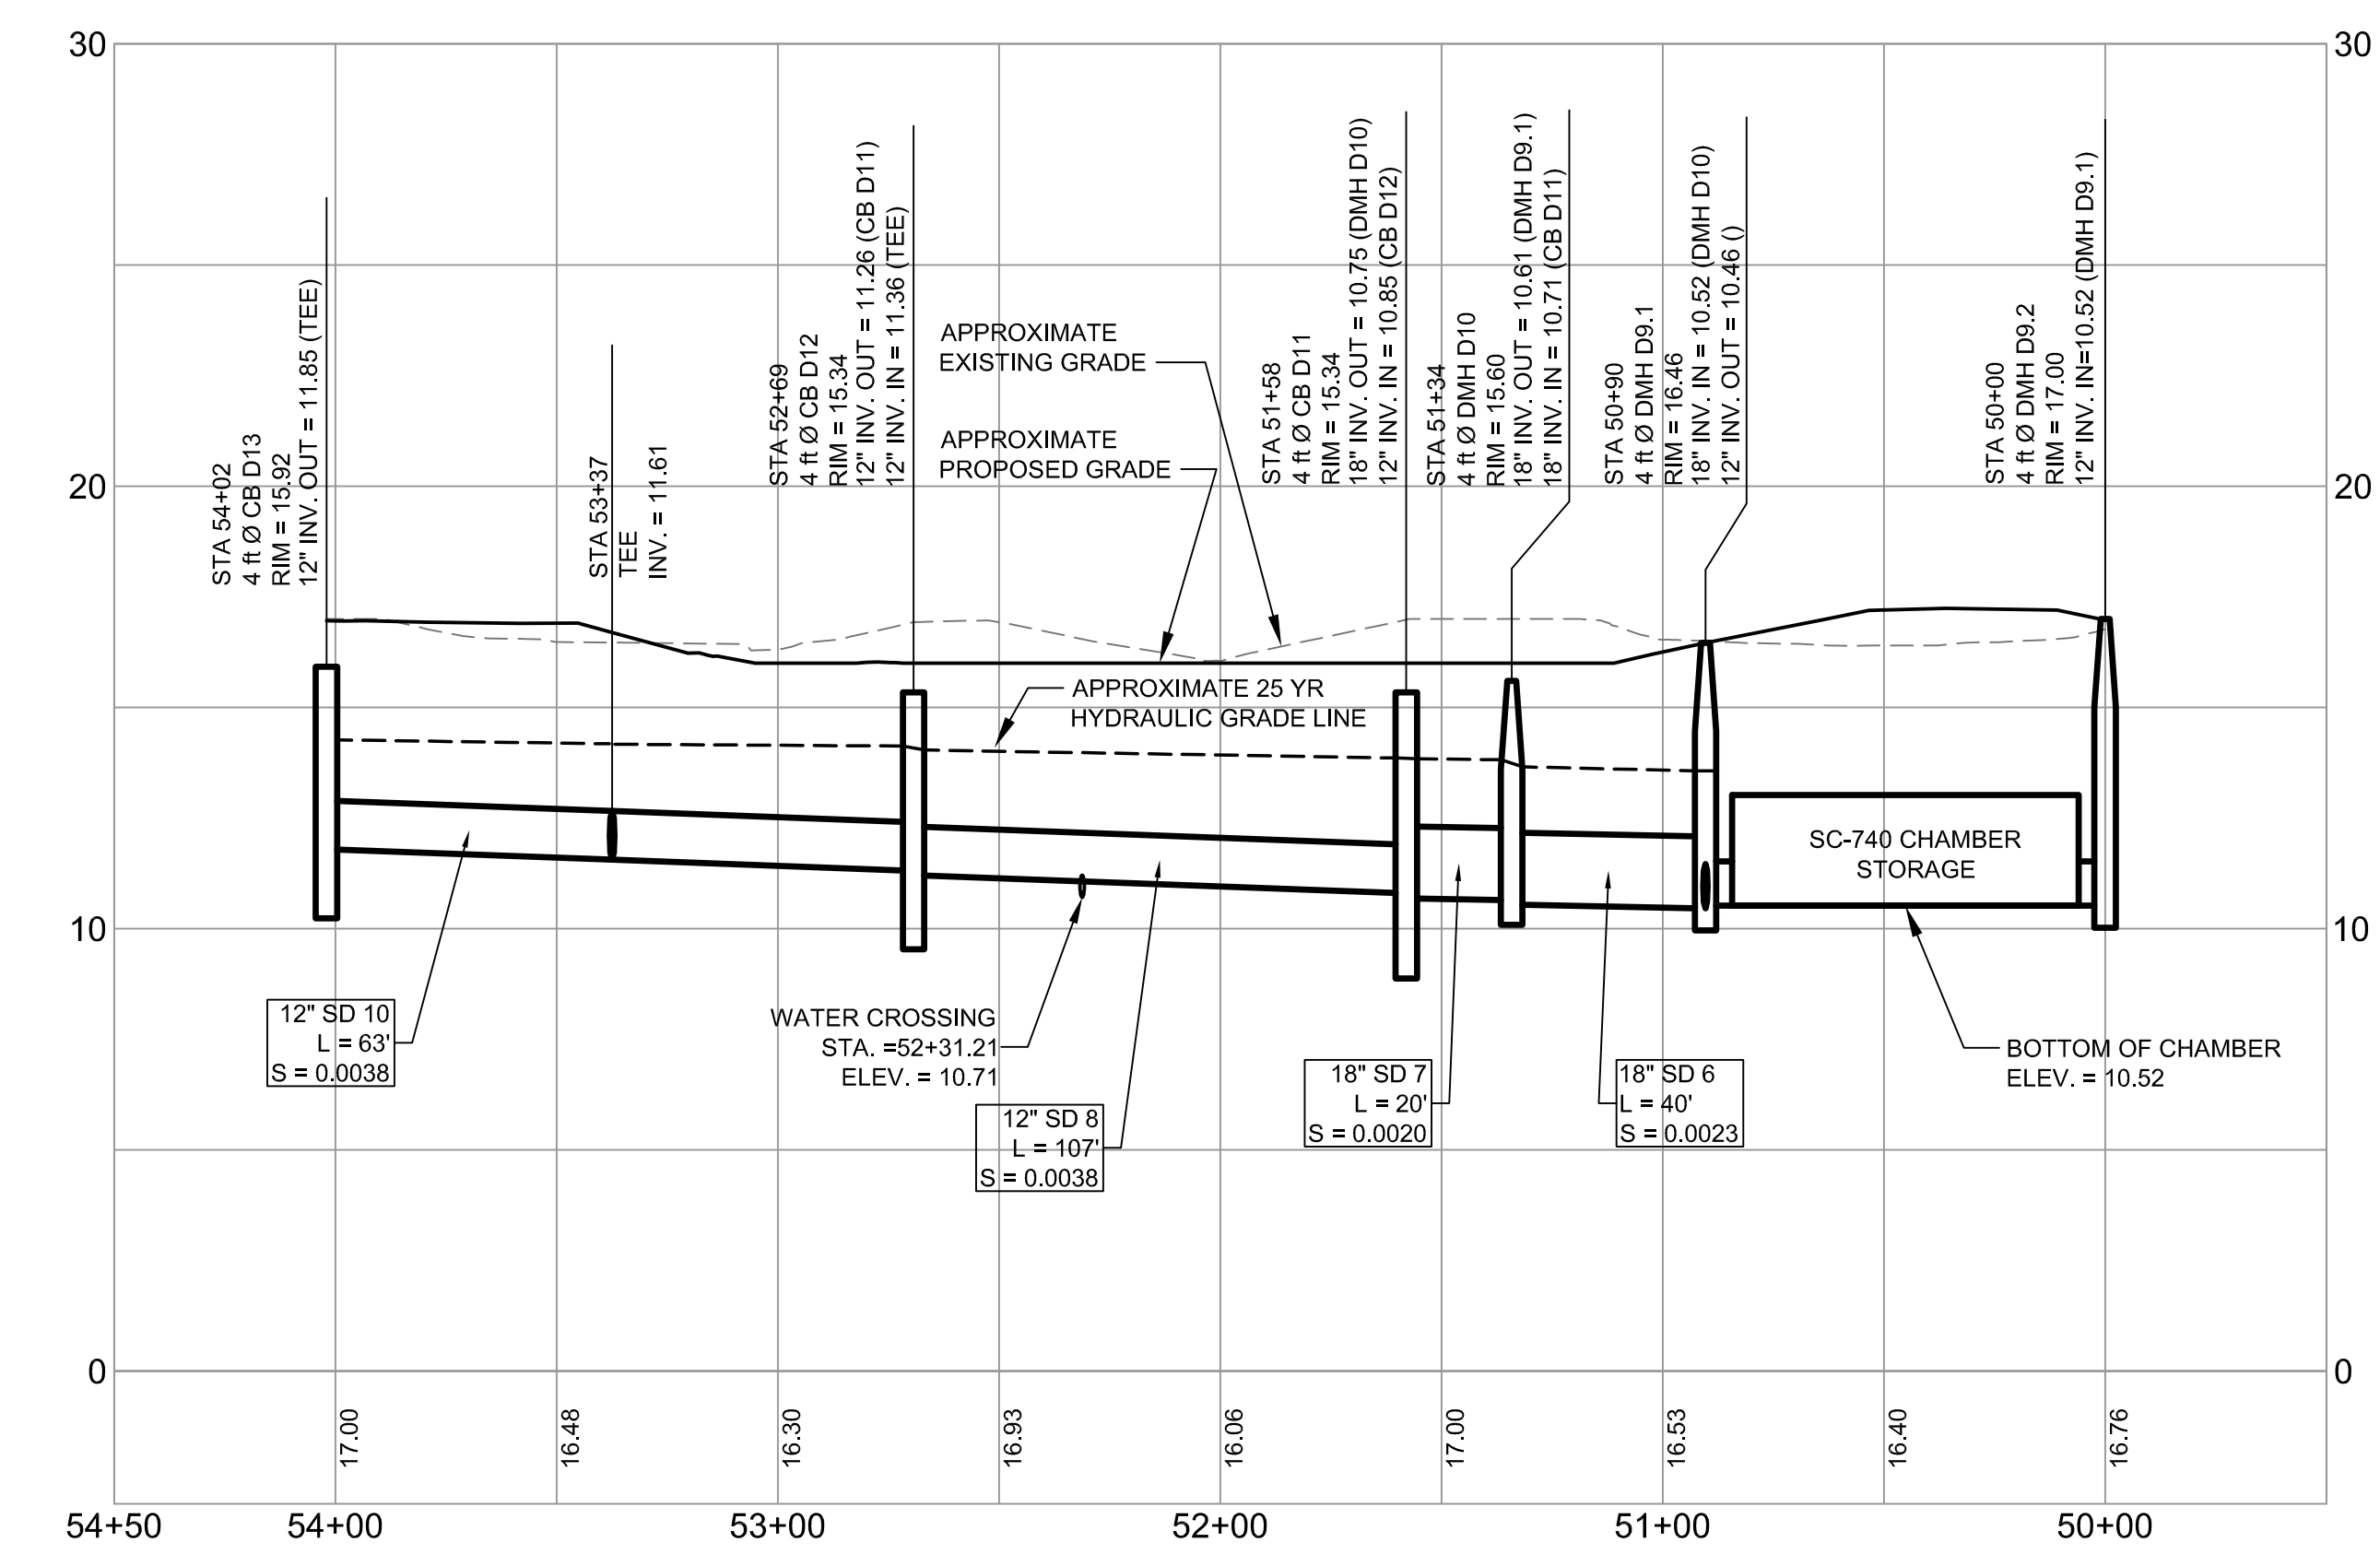

STORM DRAIN PROFILE - D13 TO ZONE D STORMTECH CHAMBER STORAGE SYSTEM
 SCALE: H 1" = 40'
 V 1" = 4'

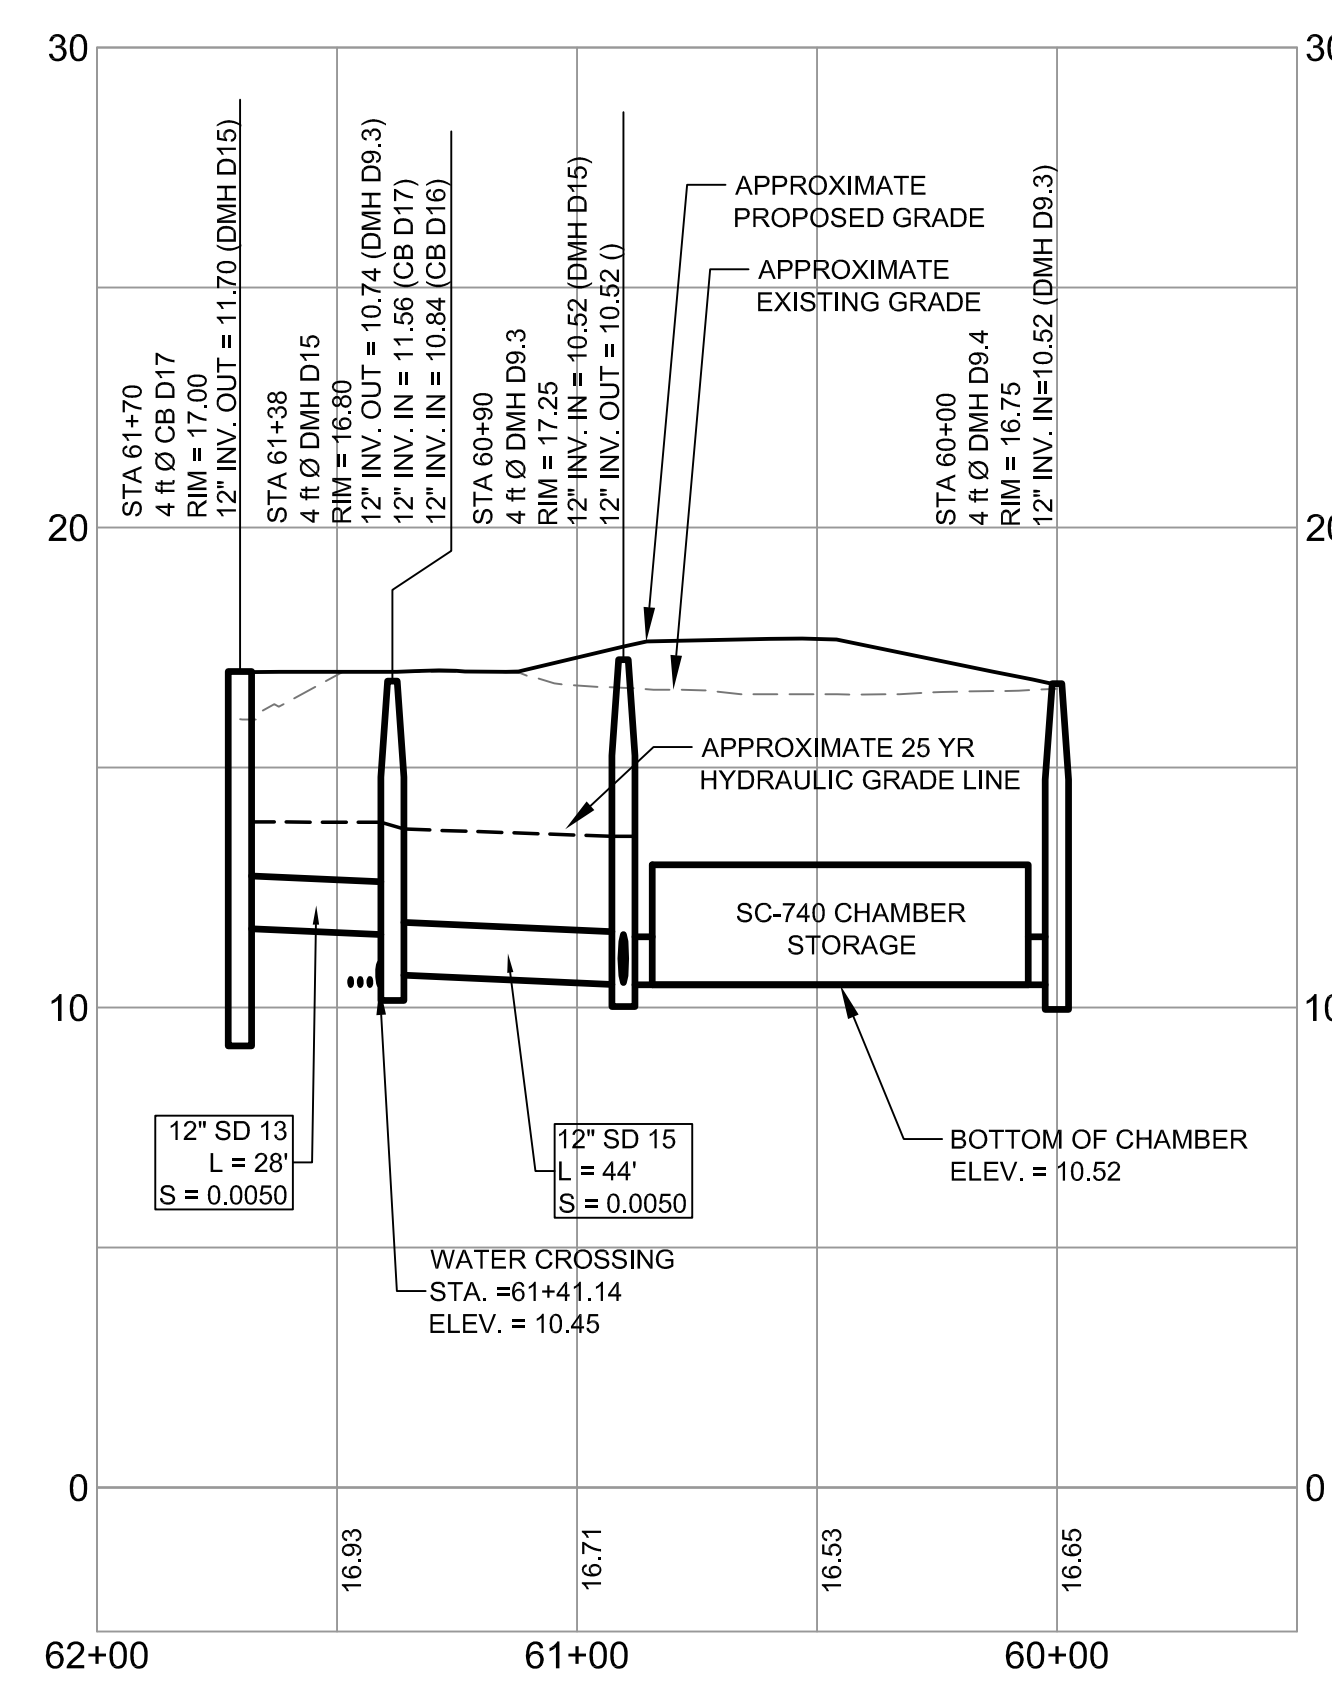

STORM DRAIN PROFILE - D17 TO ZONE D STORMTECH CHAMBER STORAGE SYSTEM
 SCALE: H 1" = 40'
 V 1" = 4'

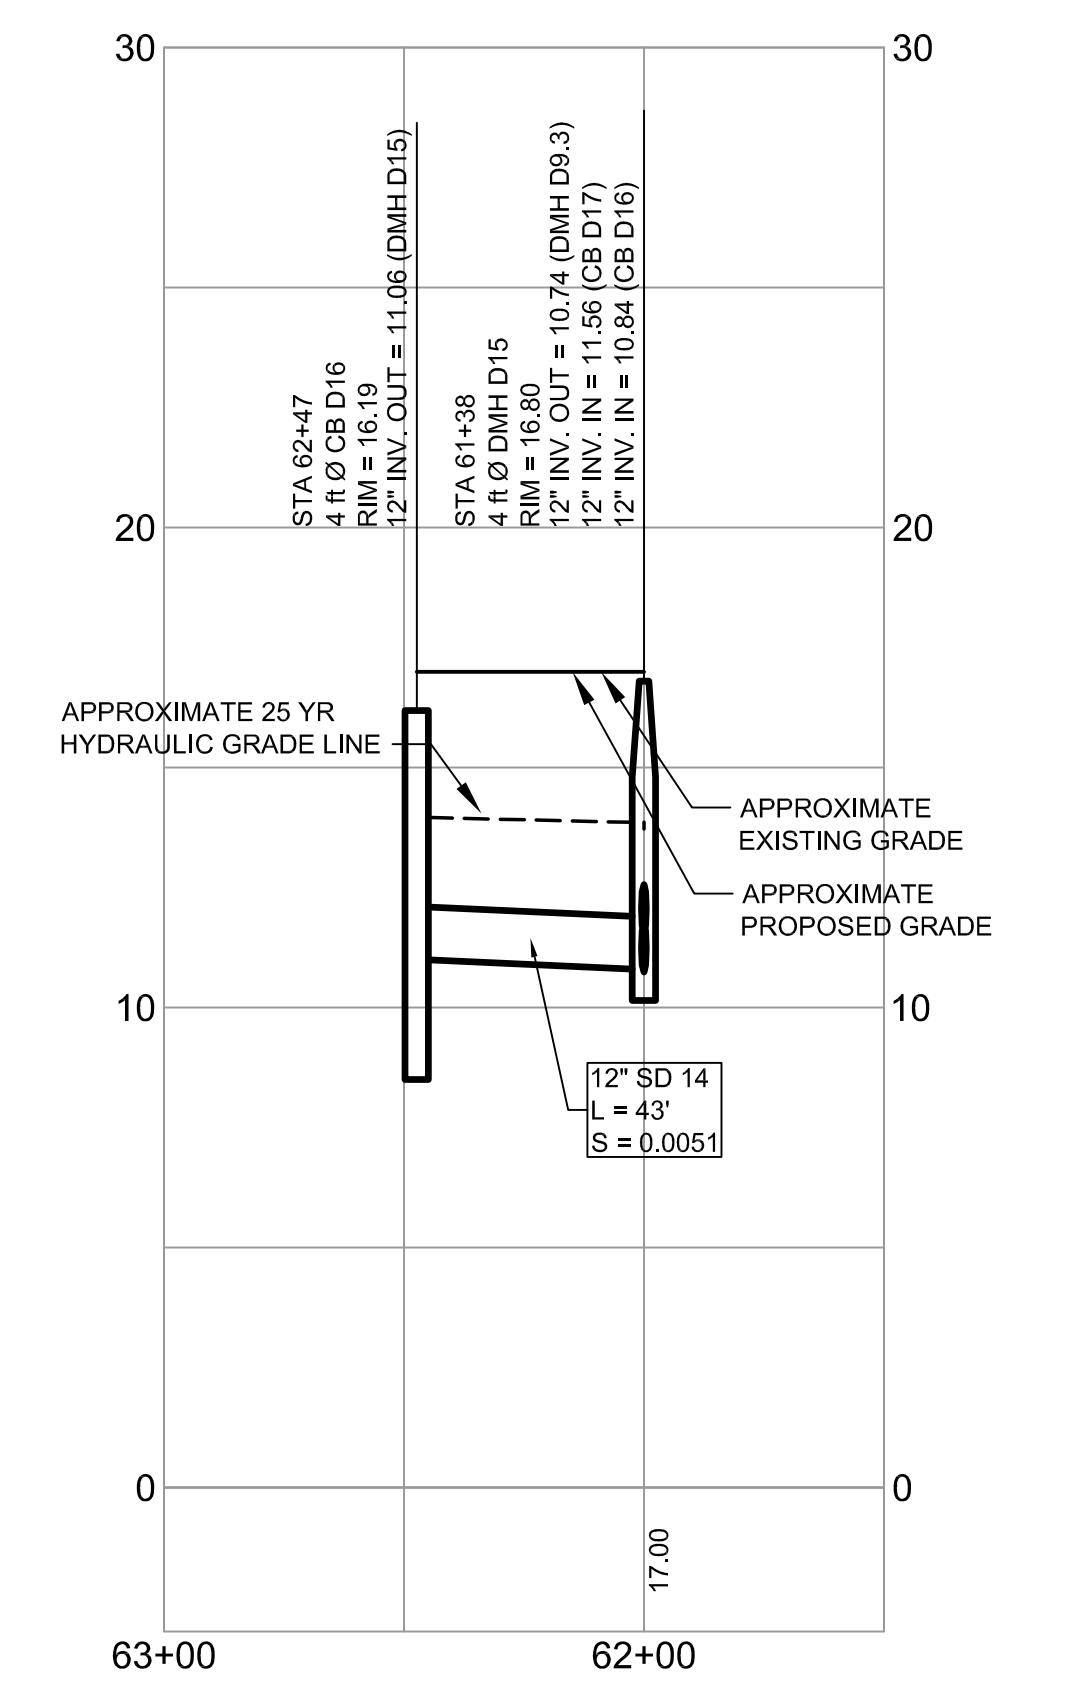

STORM DRAIN PROFILE - D16 TO D15
 SCALE: H 1" = 40'
 V 1" = 4'

		PROJECT BRICK NORTH BUILDING AT THE FOREFRONT AT THOMPSON'S POINT	FAY, SPOFFORD & THORNDIKE ENGINEERS - PLANNERS - SCIENTISTS 778 MAIN ST., SUITE 8, SOUTH PORTLAND, ME 04106
1 REV DATE DESCRIPTION REVISIONS	06.30.14 AMENDED PHASE 1A SITE PLAN SUBMITTED TO CITY	CLIENT FOREFRONT PARTNERS LP	SHEET TITLE STORM DRAIN PROFILES ZONE D
DRAWN: CED DESIGNED: BEK CHECKED: SRB FILE NAME: 2982.05-BN PROFILE SEWER		DATE: JUNE 2014 SCALE: 1" = 40' JOB NO.: 2982.05	SHEET C-12.0