

SITE LAYOUT NOTES

- ALL BARRIER FREE PARKING SPACES ARE TO RECEIVE BARRIER FREE SIGNS AND PAVEMENT MARKINGS AS ILLUSTRATED ON THE DETAIL SHEETS.
- ALL CURBING MATERIALS WILL BE SELECTED BY THE OWNER. THE DIMENSIONS PROVIDED ON THE PLAN ARE TO FACE OF CURB. ALL CURBING TYPES ARE DETAILED IN THE PROJECT DETAIL SHEETS.
- ALL DIMENSIONING, UNLESS NOTED OTHERWISE, IS TO THE FACE OF CURB. THE EDGE OF PAVEMENT OR THE FACE OF THE BUILDING.
- EXCEPT WHERE INDICATED OTHERWISE, THE PAVEMENT IS TO BE STANDARD DUTY PAVEMENT.
- ALL PAVEMENT MARKINGS SHOWN SHALL BE TEMPORARY PAINT PLACED ON BINDER PAVEMENT. UPON PLACEMENT OF FINAL SURFACE PAVEMENT TO BE CONSISTENT WITH THE APPROVED MARCH 2014 MASTER PLAN.

CURB LEGEND

- SLIP FORM CONCRETE CURB (VERTICAL, SLOPED OR CAPE COD BERM MOLD - SEE DETAILS)
- TYPE 1 VERTICAL GRANITE CURB
- TD TIP DOWN
- TS TRANSITION STONE (VERTICAL GRANITE TO SLIP FORM CONCRETE)

PAVEMENT MARKING LEGEND

- 4" DYCL 4" WIDTH DOUBLE YELLOW CENTERLINE
 - 4" SYLL 4" WIDTH SOLID YELLOW LANE LINE
 - 4" SWLL 4" WIDTH SOLID WHITE LANE LINE
 - STOP 12" WIDTH SOLID WHITE STOP LINE
- ALL PARKING STALLS TO BE 4" WIDTH SINGLE SOLID WHITE LINE EXCEPT AS SHOWN ON SITE LAYOUT PLAN.
- ALL SIGNAGE AND STRIPING SHALL CONFORM TO THE STANDARDS FOR SIZE, HEIGHT, LOCATION, COLOR, INSTALLATION AND REFLECTIVITY SET FORTH IN THE CURRENT VERSION OF THE MANUAL ON UNIFORM TRAFFIC CONTROL DEVICES (MUTCD).

PAVEMENT LEGEND

- HEAVY DUTY PAVEMENT
- STANDARD DUTY PAVEMENT
- LIGHT DUTY PAVEMENT
- RECLAIM, FINE GRADE AND PAVE
- SPOT PAVEMENT REPAIR
- BITUMINOUS PAVEMENT SIDEWALK

SIGN LEGEND

- STOP
 - RESERVED PARKING (WHEELCHAIR)
 - RESERVED PARKING (WHEELCHAIR) - ADA ACCESSIBLE
 - HEAD
 - SUBURBAN PROPANE CUSTOMERS ONLY
- R1-1 24"x24" A
R7-8 12"x18" B
R7-8 12"x18" C
R7-8 12"x18" D
W11-2 24"x24" W16-12 12"x18" E
W11-2 24"x24" W16-12 12"x18" F
R7-13M 12"x18" G

100 / 16 / 8 PARKING SPACE - STANDARD / COMPACT / ACCESSIBLE


BASELINE LINE TABLE

ID	LENGTH	DIRECTION
L1	79.72	S27° 00' 14.12"E
L2	11.42	S09° 45' 59.98"E
L3	16.81	S61° 47' 25.34"E
L4	9.86	S59° 11' 41.40"E
L5	476.41	S70° 56' 10.77"E

BASELINE CURVE TABLE

ID	RADIUS	ARC LENGTH	DELTA	TANGENT	PC STATION	PT STATION
C1	360.00	252.05	040° 07'	131.44	10+00	12+52.05
C2	200.00	110.10	031° 33'	56.48	13+31.77	14+41.87
C3	320.00	195.80	035° 04'	101.08	14+41.87	16+37.67
C4	190.00	106.38	032° 05'	54.63	16+37.67	17+44.06
C5	270.00	81.44	017° 17'	41.03	17+44.06	18+25.50
C6	50.00	45.40	052° 01'	24.40	18+36.92	18+82.31
C10	50.00	10.25	011° 44'	5.14	20+09.86	20+20.11

TIDAL AREA

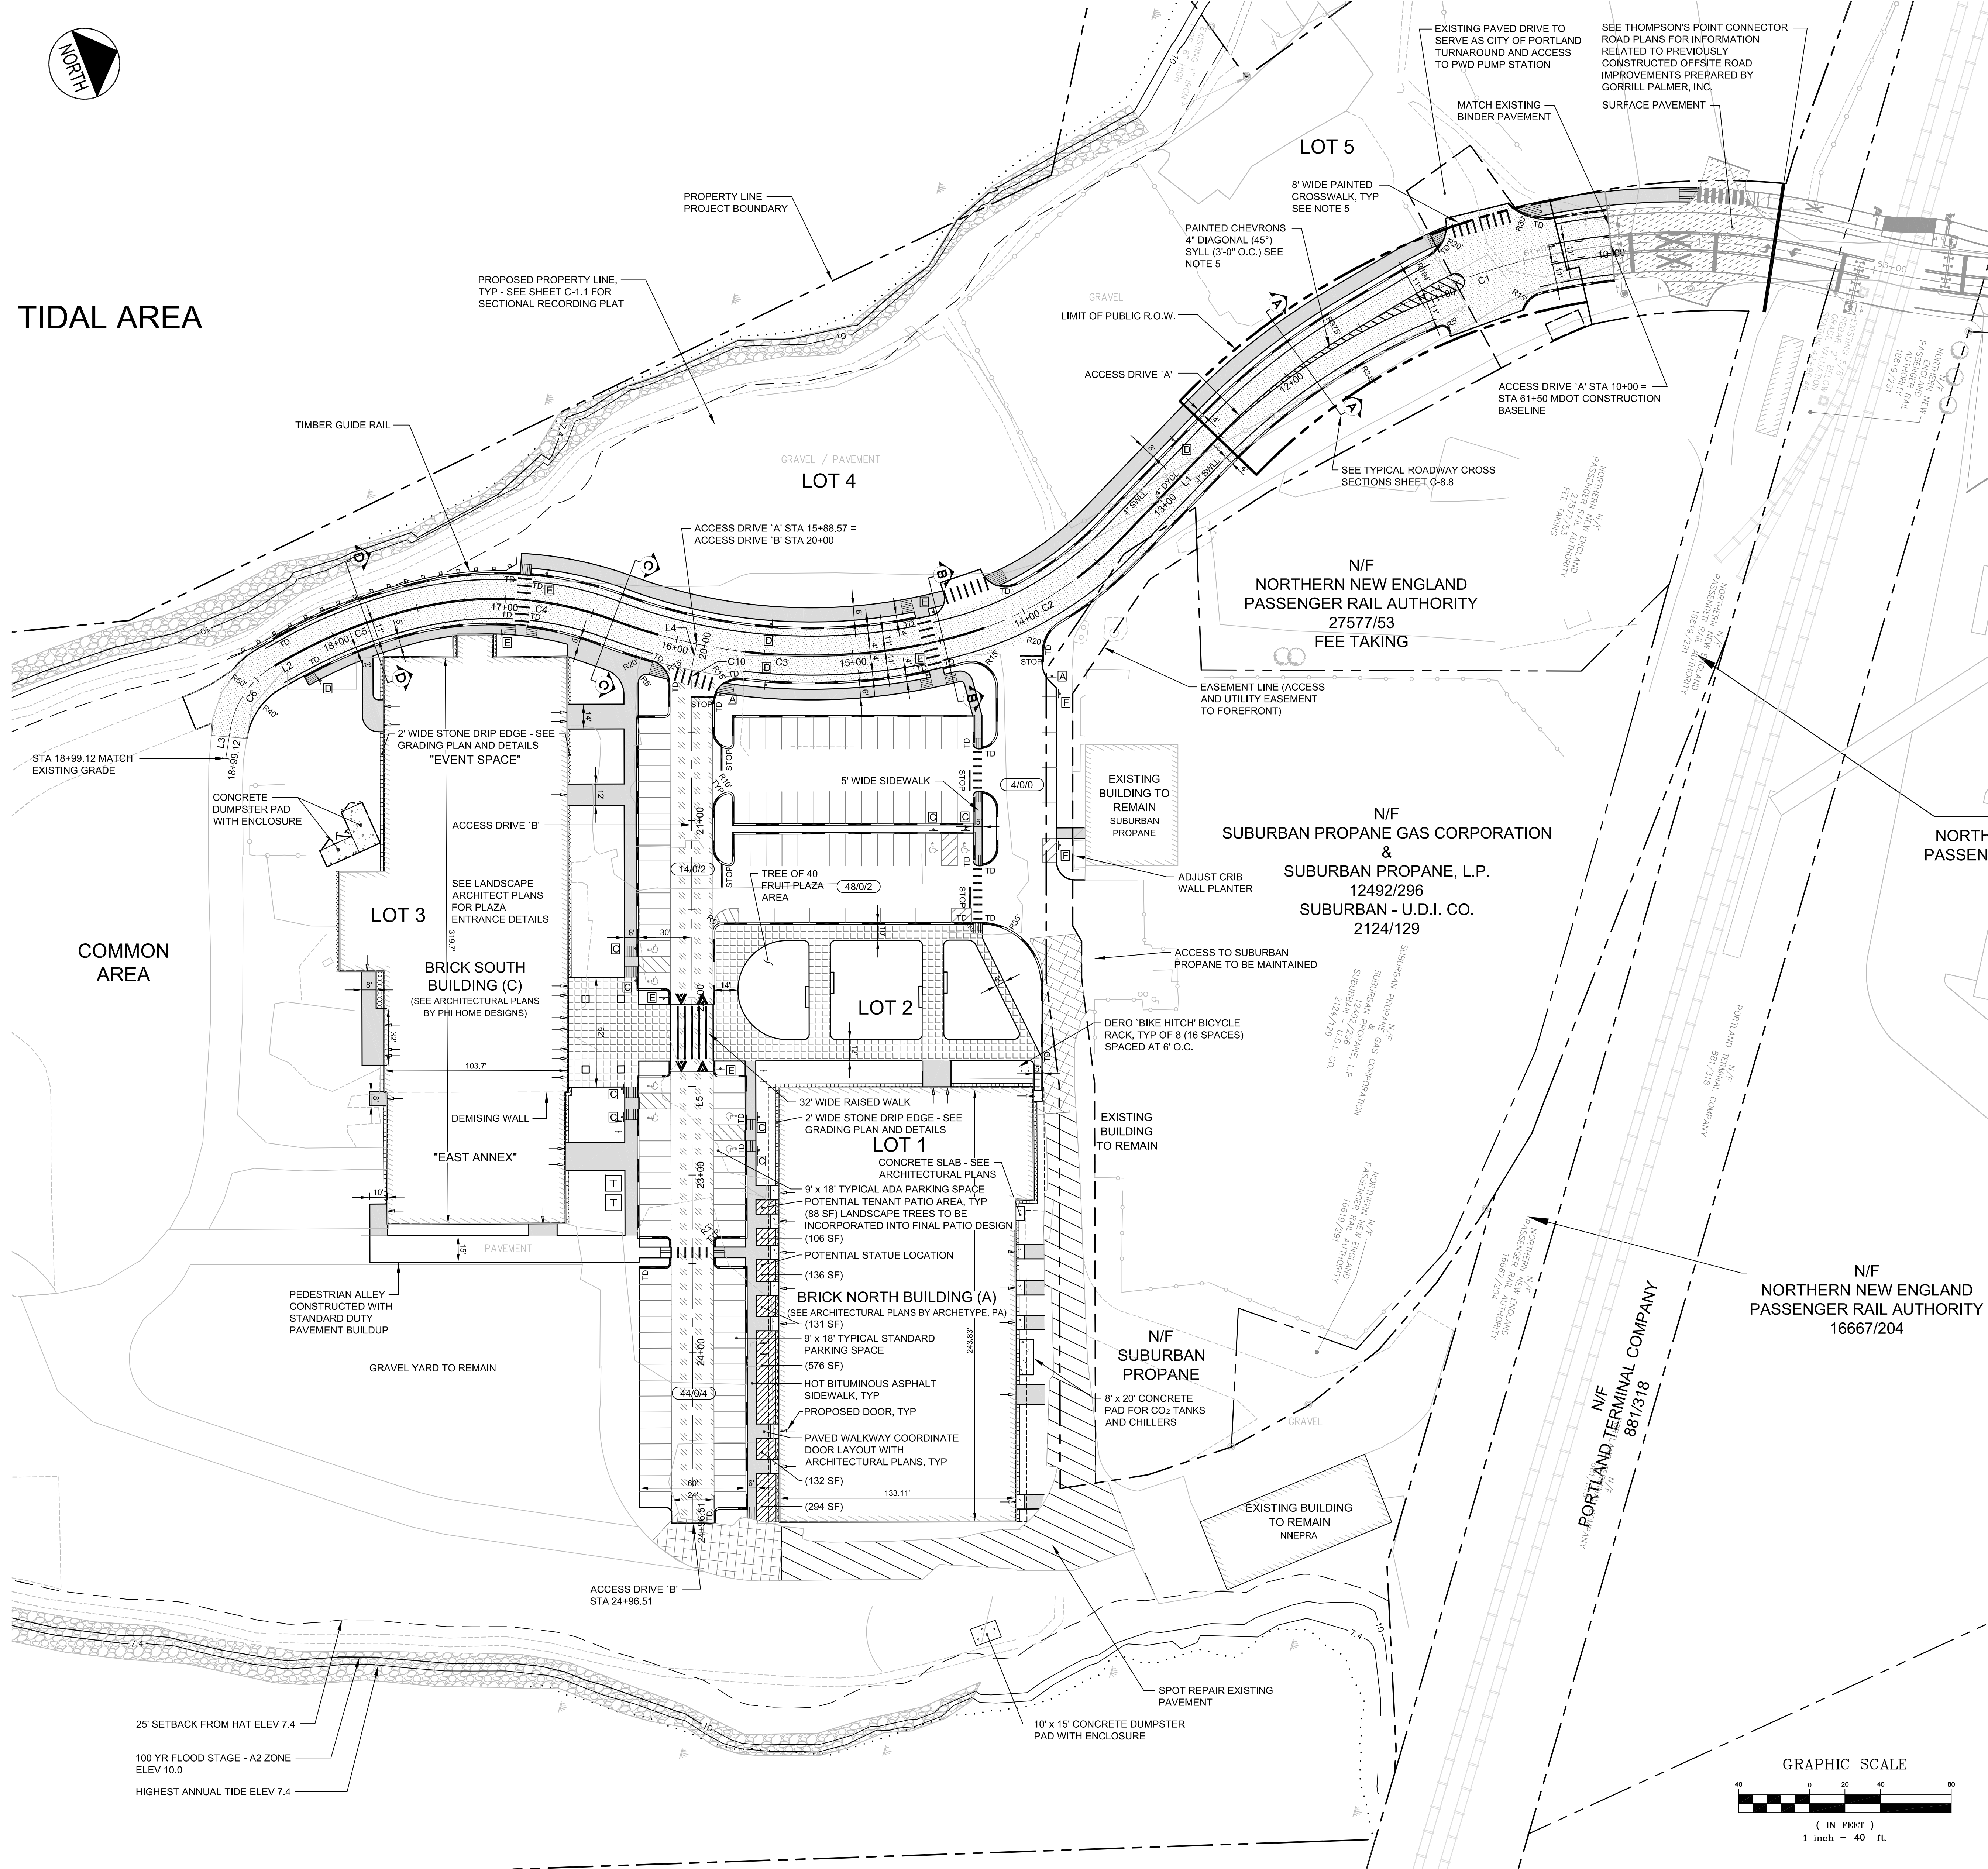

COMMON AREA

PRELIMINARY - NOT FOR CONSTRUCTION

REV	DATE	DESCRIPTION	REVISIONS
4	01.06.16	ADDED CONCRETE PAD FOR BRICK NORTH	
3	12.17.15	REVISED FOR THOMPSON'S POINT CONNECTOR ROAD PUBLIC R.O.W. EXTENSION	
2	12.16.15	REVISED BRICK NORTH ENTRANCE DOORS AND ADDED POTENTIAL PATIO AREAS	
1	09.01.15	FINAL BRICK SOUTH LEVEL III SITE PLAN APPLICATION	

P.E. BO KENNEDY
LIC. #11994

PROJECT BRICK NORTH AND SOUTH BUILDINGS AT THE FOREFRONT AT THOMPSON'S POINT	
SHEET TITLE SITE LAYOUT PLAN	
CLIENT FOREFRONT PARTNERS LP	

FAY, SPOFFORD & THORNDIKE ENGINEERS - PLANNERS - SCIENTISTS 778 MAIN ST, SUITE 8, SOUTH PORTLAND, ME 04106	
DRAWN: DED	DATE: APRIL 2015
DESIGNED: BEK	SCALE: 1" = 40'
CHECKED: SRB	JOB NO. 2982.05
FILE NAME: 2982.05-B5 SITE LAYOUT	
SHEET	C-3.0