



**SITE LAYOUT PLAN VIEW**  
1" = 30'

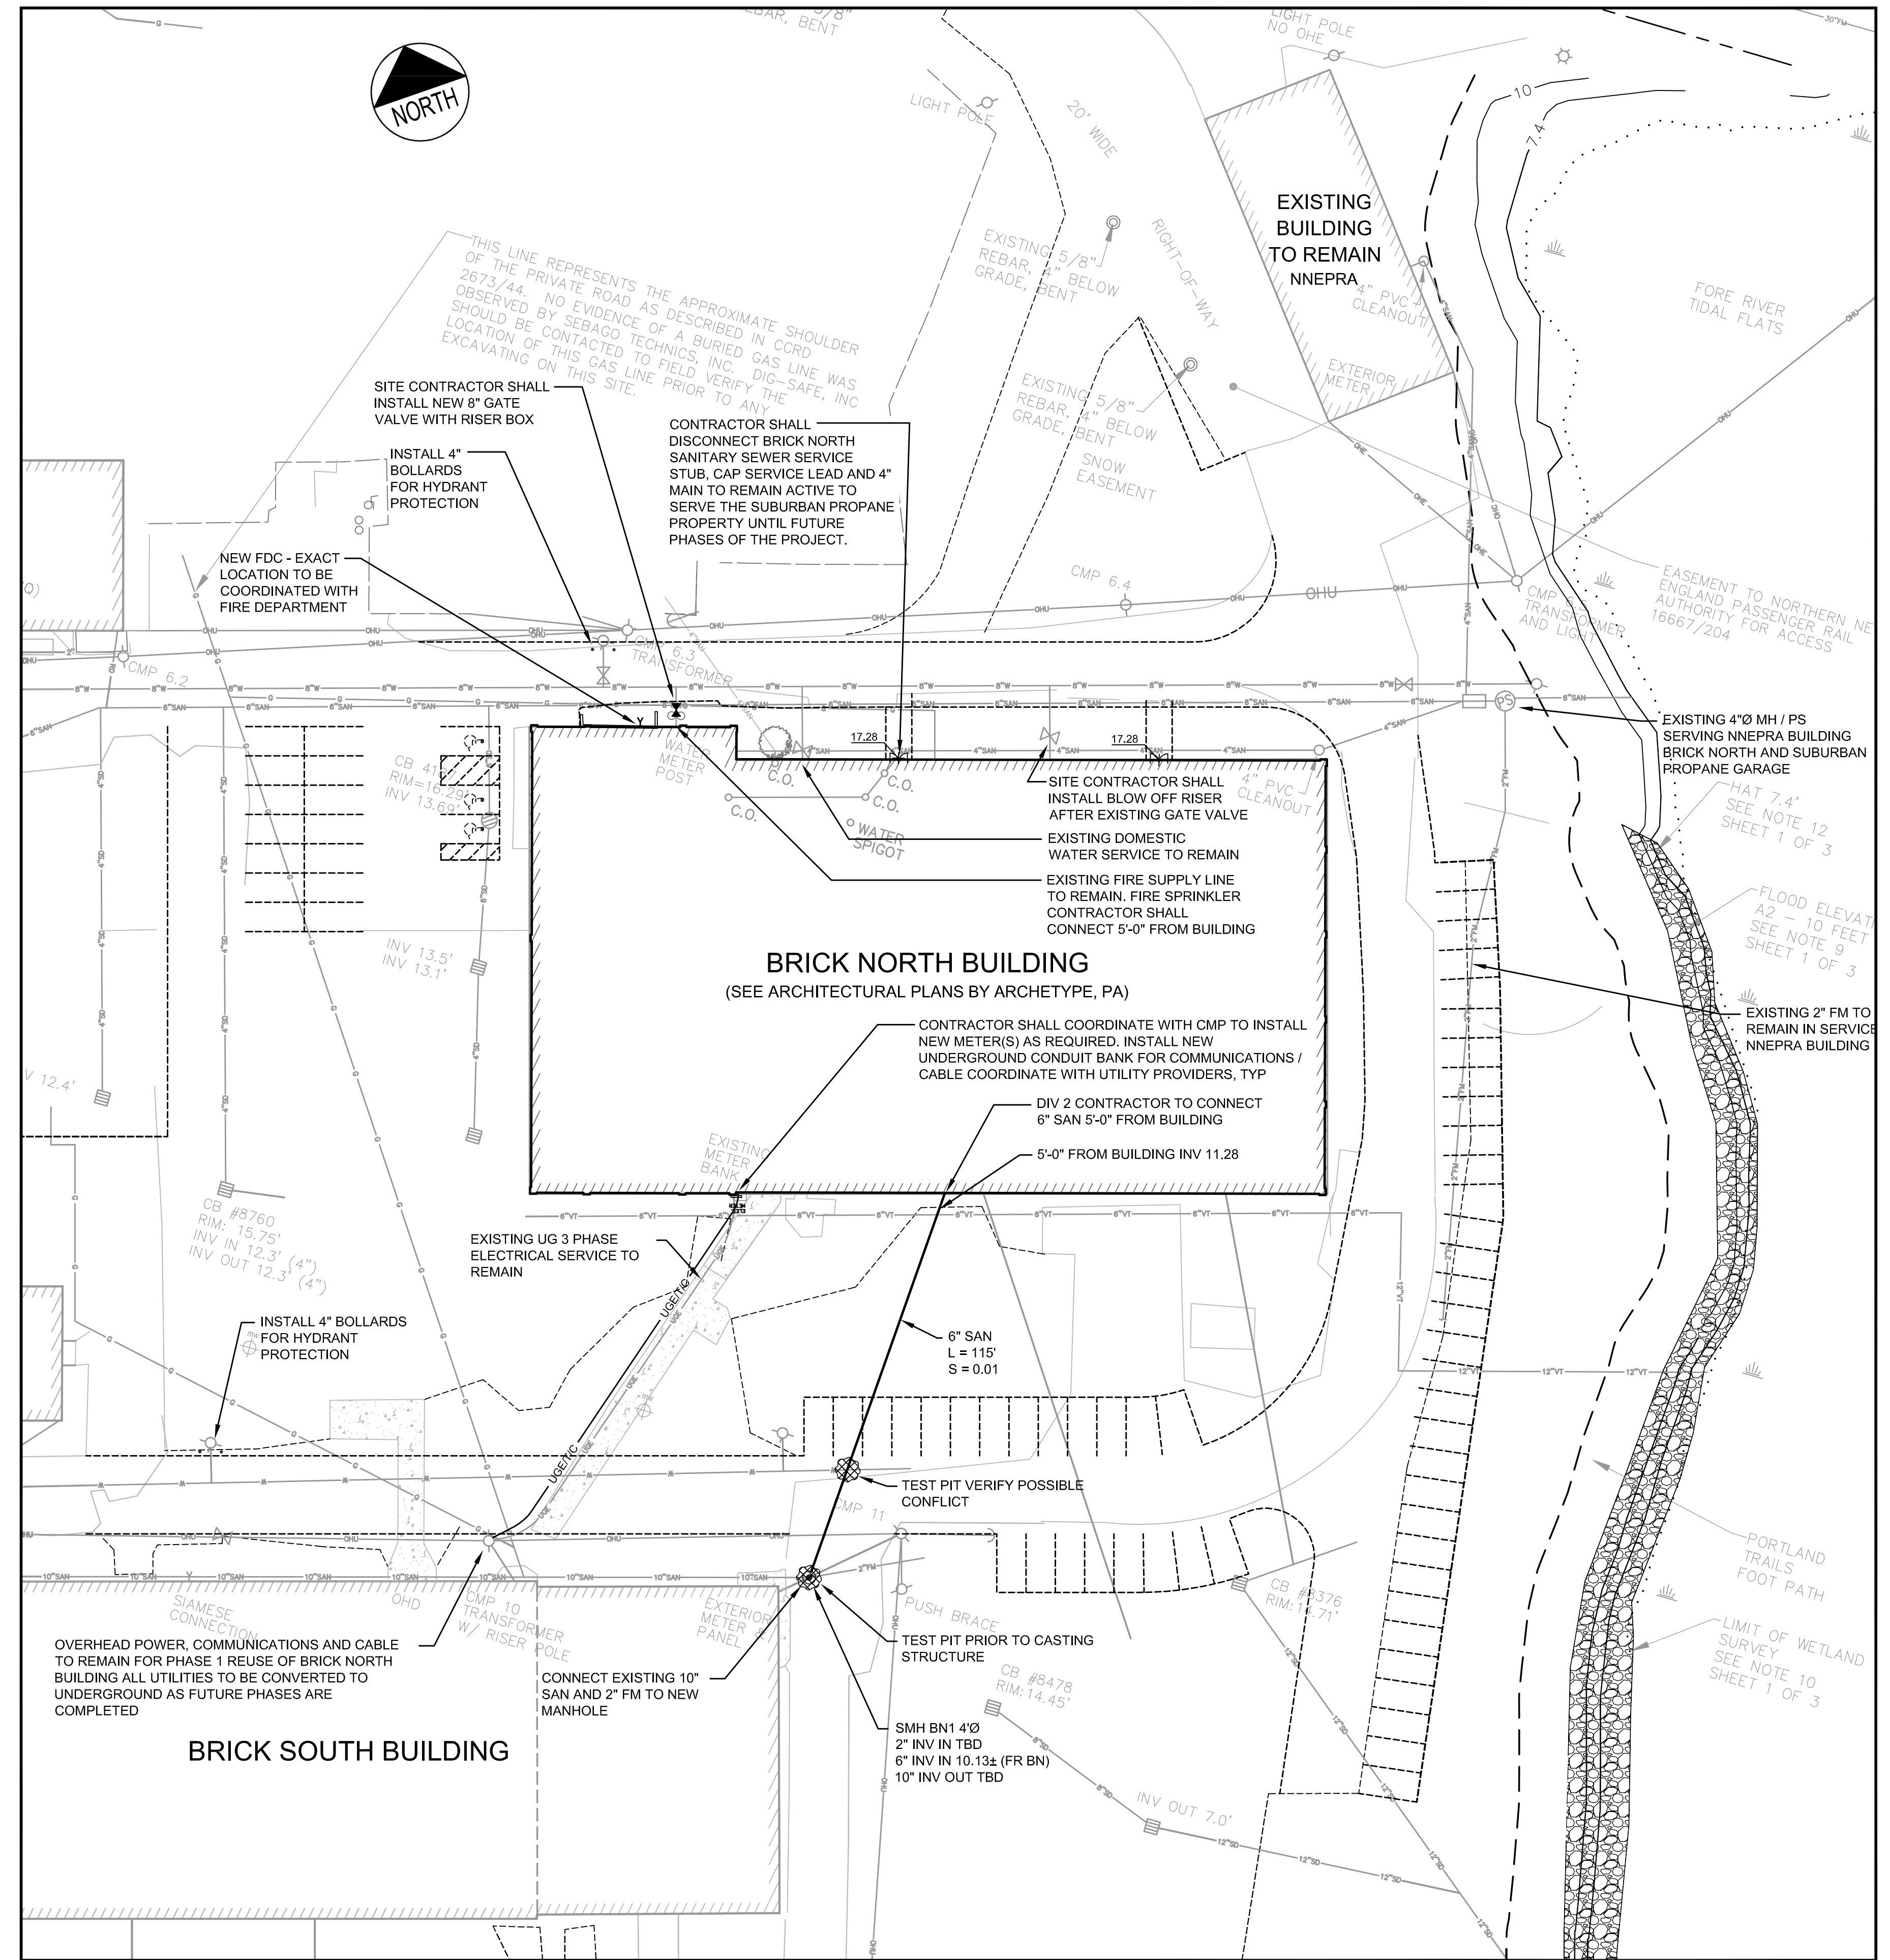

**UTILITY PLAN VIEW**  
1" = 30'

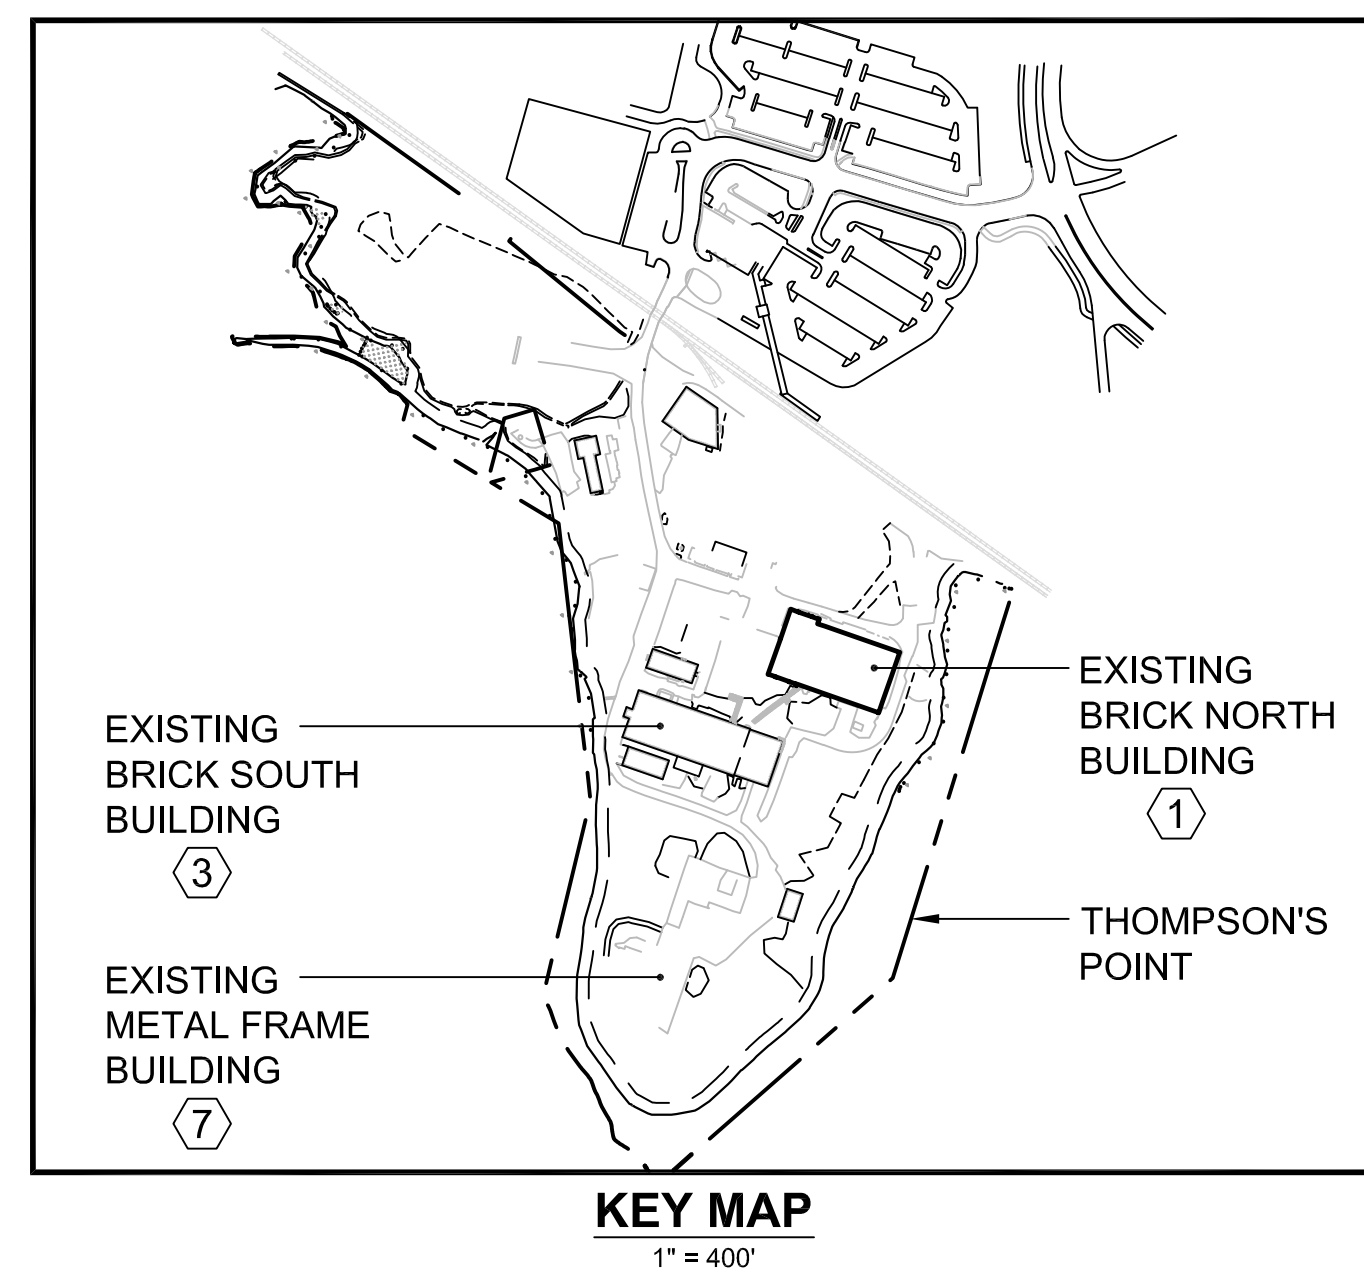


**KEY MAP**  
1" = 400'


DESCRIPTION	SIZE (SF)	ZONING STANDARD	REQUIRED	PROVIDED
OFFICE	14,000	1 SPACE / 400 SF = 35	35	
SHARED STUDIO	9,000	1 SPACE / 1,000 SF = 9	9	
CAFE	1,000	1 SPACE / 150 SF = 7	7	
OTHER	10,000	1 SPACE / 1,000 SF = 10	10	
TOTAL	34,000		61	
VEHICLE PARKING PROVIDED				61*
BICYCLE PARKING PROVIDED		2 SPACE / 10 VPS	12.2	14

\* PARKING PROVIDED IS BASED ON THE AVAILABLE PARKING AREAS SHOWN ON THE SITE LAYOUT PLAN. ADDITIONAL PARKING AND ACCESS IS CURRENTLY AVAILABLE SHOULD ACTUAL DEMAND REQUIRE.

THE APPLICANT REQUESTS, AS A CONDITION OF APPROVAL, THE OPPORTUNITY TO COMPLETE FUTURE LANDSCAPING AND LIGHTING DESIGNS FOR STAFF REVIEW. IF, WITHIN A REASONABLE PERIOD NOT TO EXCEED 5 YEARS, FUTURE DEVELOPMENT OF THE BRICK NORTH SITE UNDER THE FORTHCOMING MASTER PLAN HAS NOT COMMENCED.

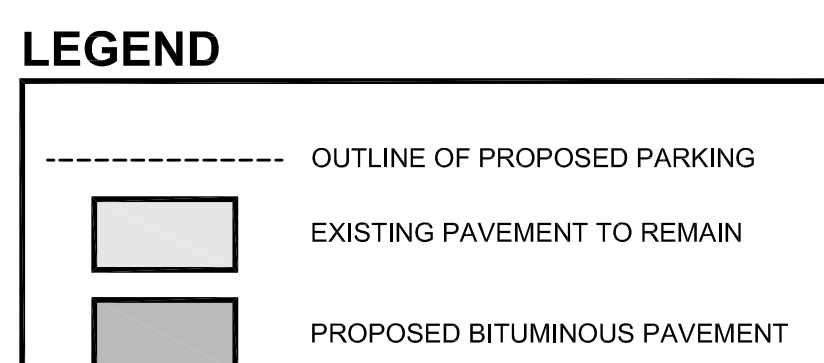

**SIGN LEGEND**

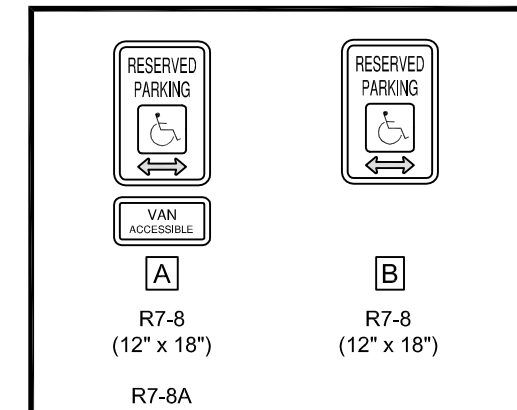


**UTILITY NOTES:**


- ALL REQUIRED UTILITIES SERVING THE PROJECT SHALL BE COORDINATED AND CONSTRUCTED BY THE SITE CONTRACTOR TO WITHIN 5 FEET OF THE BUILDINGS, AT A LOCATION COORDINATED WITH THE MEP CONTRACTOR(S) AND THE BUILDING PLANS. SITE WORK WITHIN 5 FEET OF UNDERSLAB UTILITIES SHALL CONSIST OF TRENCHING AND BACKFILLING. ACTUAL UTILITY INSTALLATION SHALL BE BY THE MEP CONTRACTOR. ALL REQUIRED CONNECTION FEES SHALL BE PAID BY THE GENERAL CONTRACTOR.
- UNDERGROUND ELECTRICAL CONDUIT MATERIAL AND INSTALLATION SHALL CONFORM TO UTILITY COMPANY STANDARDS AND PROJECT SPECIFICATIONS, WHICH EVER IS MORE STRINGENT.
- ADJUST ALL MANHOLES, CATCH BASINS, CURB BOXES, ETC. WITHIN LIMITS OR WORK TO FINISH GRADE.
- ALL UNDERGROUND CONDUITS SHALL HAVE NYLON PULL ROPES TO FACILITATE PULLING CABLES.
- THE CONTRACTOR SHALL OBTAIN, PAY FOR, AND COMPLY WITH ALL REQUIRED PERMITS, ARRANGE FOR ALL INSPECTIONS, AND SUBMIT COPIES OF ACCEPTANCE CERTIFICATES TO THE OWNER PRIOR TO COMPLETION OF THE PROJECT.
- THE CONTRACTOR SHALL PROVIDE AND INSTALL ALL BOXES, FITTINGS, CONNECTORS, COVER PLATES AND OTHER MISCELLANEOUS ITEMS NOT NECESSARILY DETAILED ON THE DRAWINGS TO RENDER INSTALLATION OF UTILITIES COMPLETE AND OPERATIONAL. AT NO EXTRA EXPENSE TO THE OWNER.
- A 10 FOOT MINIMUM EDGE TO EDGE HORIZONTAL SEPARATION SHALL BE PROVIDED BETWEEN ALL WATER AND SANITARY SEWER LINES. AN 18 INCH OUTSIDE TO OUTSIDE VERTICAL SEPARATION SHALL BE PROVIDED AT ALL WATER AND SANITARY SEWER CROSSINGS.
- THE CONTRACTOR SHALL PHASE UTILITY CONSTRUCTION AND PROVIDE TEMPORARY SERVICES AS REQUIRED TO PROVIDE CONTINUOUS SERVICE TO THE JOB SITE, SUBURBAN PROPANE AND NNEPRA. TEMPORARY SERVICES SHALL COMPLY WITH ALL FEDERAL, STATE, LOCAL AND UTILITY COMPANY STANDARDS. COORDINATE ALL TEMPORARY SERVICES WITH UTILITY COMPANY, OWNER AND AFFECTED BUSINESSES.

**SUMMARY OF UTILITIES - BRICK NORTH:**

- WATER SUPPLY**  
PHASE 1 - THE EXISTING FIRE AND DOMESTIC LINES WILL REMAIN IN SERVICE AND WILL INCLUDE INTERNAL RISER IMPROVEMENTS. A NEW FIRE DEPARTMENT CONNECTION WILL BE INSTALLED ON THE NORTH SIDE OF THE BUILDING  
FUTURE - THE DOMESTIC AND FIRE SERVICES WILL BE TIED INTO A NEW WATER SUPPLY SYSTEM
- SANITARY SEWER**  
PHASE 1 - THE EXISTING BUILDING SERVICE IS THOUGHT TO DISCHARGE INTO THE PUMP STATION NORTHEAST OF THE BUILDING. FOR PHASE 1 A NEW 6" GRAVITY BUILDING SERVICE IS PROPOSED TO TIE INTO AN EXISTING 10" SEWER MAIN LOCATED ADJACENT TO THE BRICK SOUTH (BUILDING #3)  
FUTURE - THE PROPOSED 6" SEWER WILL BE CONNECTED TO A NEW SANITARY SEWER SYSTEM SERVING FUTURE PHASE ACTIVITY
- POWER / COMMUNICATION / CABLE**  
PHASE 1 - THE EXISTING UNDERGROUND FEED FROM POLE #CMP 10 WILL CONTINUE IN USE. NEW UNDERGROUND COMMUNICATIONS / CABLE WILL BE INSTALLED  
FUTURE - ALL OVERHEAD UTILITIES WILL BE REMOVED AND A NEW UNDERGROUND SUPPLY SYSTEM WILL BE INSTALLED. THE BRICK NORTH SERVICE WILL BE CONNECTED TO THE NEW SYSTEMS

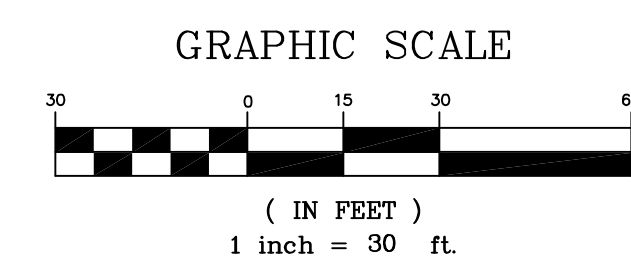

REV	DATE	DESCRIPTION	REVISIONS
2	03.03.14	FINAL PHASE 1A PLANS INC. REVISIONS NOTED IN CONDITIONS OF APPROVAL	
1	11.01.13	PHASE 1A PLAN SUBMISSION	

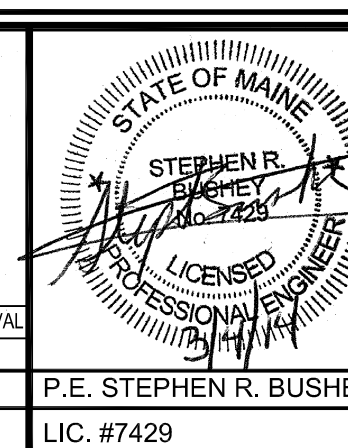

**FAY, SPOFFORD & THORNDIKE, INC.**  
ENGINEERS - PLANNERS - SCIENTISTS  
778 MAIN ST., SUITE 6, SOUTH PORTLAND, ME 04106

**PROJECT:** BRICK NORTH BUILDING AT THE FRONTEND AT THOMPSON'S POINT  
**SHEET TITLE:** SITE LAYOUT AND UTILITY PLAN

**CLIENT:** FOREFRONT PARTNERS | LP

**DRAWN:** DED  
**DESIGNED:** BEK  
**CHECKED:** SRB

**DATE:** OCT 2013  
**SCALE:** 1" = 30'  
**JOB NO.:** 2982.05  
**FILE NAME:** 2982.05 BRICK NORTH  
**SHEET:** C-3.0