

## NORTHEAST AIR

PORTLAND INTERNATIONAL JETPORT



PORTLAND, MAINE 04102


## ABBREVIATIONS GENERAL NOTES 1. ALL WORK SHALL CONFORM TO LOCAL AND STATE LAWS, ORDINANCES AND PREVAILING EDITIONS OF ADOPTED BUILDING CODES. IT IS THE CONTRACTOR'S RESPONSIBILITY TO SECURE ALL PERMITS FOR WORK. SOUTH SUSPENDED ACOUSTICAL TILE CEILING SHOWER CURTAIN SOAP DISPENSER SCHEDULE ABOVE FINISH FLOOR ALUMINUM HANDICAP HARDWOOD ALUM or AL AWP ACOUSTICAL WALL PANEL 2. THE CONTRACTOR SHALL VERIFY ALL CONDITIONS AND DIMENSIONS PRIOR TO COMMENCING THE WORK AND REPORT ANY DISCREPANCIES TO THE ARCHITECT. CONTRACTOR SHALL PROCEED WITH THE WORK ONLY AFTER SUCH DISCREPANCIES HAVE BEEN RESOLVED BY THE ARCHITECT. CONTRACTOR SHALL ALLOW A 48 HOUR BENCH MARK BOTTOM BEARING TIME FRAME FOR RESOLVING DISCREPANCIES ONCE THE ARCHITECT HAS ACKNOWLEDGED THE CONDITION. SUSPENDED GYPSUM INSIDE DIAMETER INSIDE FACE BOARD CEILING BRICK 3. THE CONTRACTOR SHALL REVIEW AND VERIFY ALL EXISTING CONDITIONS PRIOR TO STARTING THE WORK SIMILAR SANITARY NAPKIN DISPOSAL INSULATION INTERIOR IN ANY GIVEN AREA. 4. WORK WITH GIVEN DIMENSIONS AND LARGE SCALE DETAILS. DO NOT SCALE THE DRAWINGS AS THE REPRODUCTIVE PROCESS TENDS TO DISTORT THE ACCURACY OF THE GRAPHIC SCALE INDICATED. STRUCTURAL STRAIGHT VINYL BASE SHEET VINYL STRUCT STV KICK PLATE 5. ALL CONSTRUCTION ACTIVITIES SHALL BE PERFORMED IN A NEAT, SAFE, AND CLEAN MANNER. ALL CONCRETE MASONRY UNIT CONSTRUCTION WASTE SHALL BE REMOVED FROM THE BUILDING. SITE BURNING IS NOT ALLOWED. LEAVE WORK AREA IN A CLEAN, SAFE CONDITION AT THE END OF EACH WORK DAY. TACK BOARD THERMAL (INSULATED) THICKNESS 6. ALL CONSTRUCTION DEBRIS SHALL BE DISPOSED OF AT AN APPROVED OFF-SITE FACILITY IN COMPLIANCE M MAS MAX MB MECH MFCR MIN MISC MO MR MRGB DOUBLE DOOR CLOSER DIAMETER DIMENSION DOES NOT APPLY DOOR DETAIL DRAWING MARBLE MASONRY TOP OF BEAM TOP OF MASONRY TOP OF WALL TOILET PAPER DISPENSER TYPICAL MAXIMUM MARKER BOARD 7. ALL WOOD IN CONTACT WITH MASONRY OR CONCRETE SHALL BE PRESSURE TREATED. 8. ALL CEILINGS SHALL BE LEVEL TO TO A TOLERANCE OF 1/8" IN A 20'-0" RADIUS WHEN CHECKED WITH A VINYL COMPOSITION TILE VERTICAL MISCELLANEOUS MASONRY OPENING VINYL WALL COVERING 9. INSTALL SOLID BLOCKING AT WALL FRAMING BEHIND ALL SURFACE MOUNTED FIXTURES, TRIM AND HANDRAILS WATER CLOSET IO. ALL GRAB BARS AND HANDRAILS SHALL BE ABLE TO SUPPORT A DEAD WEIGHT OF 250 LBS. AT ANY POINT. WOOD WATER FOUNTAIN WIRE GLASS WOOD PANELING II. THESE ARCHITECTURAL DRAWINGS WERE PREPARED FOR THE GENERAL CONTRACTOR/OWNER AS PART OF AN LECTROMAGNETIC OLD OPEN ABBREVIATED SERVICES AGREEMENT, AND AS SUCH, DO NOT DELINEATE ALL ASPECTS OF THE WORK. NUMBER NOMINAL NOT TO SCALE 12. THE GENERAL CONTRACTOR SHALL BE RESPONSIBLE FOR THE COORDINATION OF ALL ASPECTS OF THE WORK CTRIC WATER COOLER INCLUDING, BUT NOT LIMITED TO MECHANICAL AND ELECTRICAL DESIGN-BUILD ENGINEERING DISCIPLINES EXPANSION EXTERIOR FLOOR COATING SYSTEM FLOOR DRAIN 13. THE LOCATION OF ANY DOOR JAMBS NOT DIMENSIONED SHALL BE 6" FROM ADJACENT PERPENDICULAR WALL. FOUNDATION FIRE EXTINGUISHER FINISH FLOOR ELEVATION 14. ALL WALL PARTITIONS SHALL EXTEND FLOOR TO STRUCTURE ABOVE, UNLESS OTHERWISE NOTED. PROVIDE DEFELCTION TRACK SYSTEM AT ROOF DECK LOCATIONS. PAINTED PL PLY WD 5. REFER TO THE ACCESSIBILITY DETAILS FOR AMERICANS WITH DISABILITIES ACT (ADA) AND MAINE HUMAN FINISH GRADE PLYWOOD RIGHTS ACT (MHRA) CONSTRUCTION CRITERIA. FIRE RATING FRMG FEET (FOOT) FIELD VERIFY FABRIC WALL COVERING PAPER TOWEL & WASTE DISPENSER REFRIGERATOR REINFORCED REQUIRED

## CONCRETE MASONRY UNIT STUD PARTITION (EXISTING) WOOD FRAMING WOOD BLOCKING PLYWOOD GYPSUM BOARD SUSPENDED ACOUSTICAL TILE BATT INSULATION RIGID INSULATION FINISH WOOD ONE HOUR RATED PARTITION TWO HOUR RATED PARTITION

MATERIALS

CONCRETE

## WINDOW NUMBER BUILDING SECTION WALL SECTION DETAIL SECTION CASEWORK ELEVATION INTERIOR ELEVATION VERTICAL ELEVATION PARTITION TYPE STRUCTURAL CENTERLINE PROJECT TEAM CIVIL/SITE DESIGN SEBAGO TECHNICS INC 75 JOHN ROBERTS ROAD, SUITE 1A SOUTH PORTLAND, MAINE 04106 207.200.2100 STRUCTURAL/MECHANICAL/ELECTRICAL ALLIED ENGINEERING INC 160 VERANDA STREET EXISTING PARTITION (SCREENED) PORTLAND, MAINE 04103

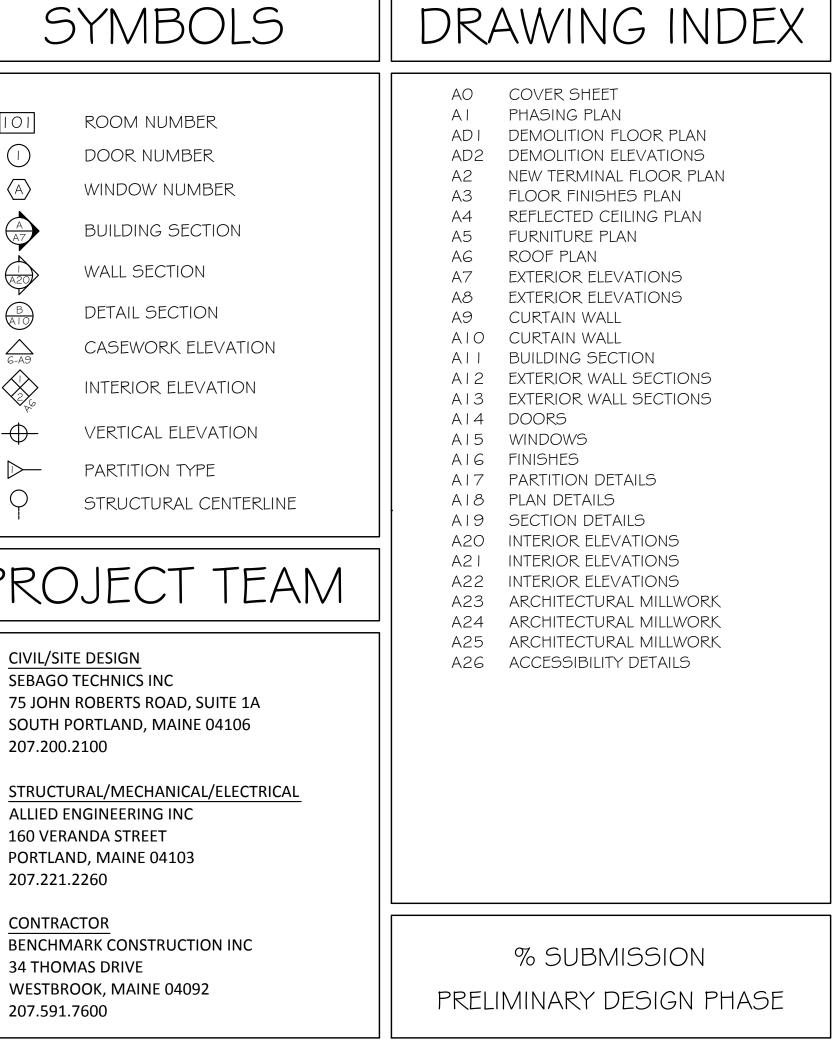



ASSOCIATES

DRAWING NAME


**∫**ĦEET

3 AUG '15

NO/CALE MFH/mgk

150655

PERMISSION FROM GRANT HAYS ASSOCIATES IS PROHIBITED

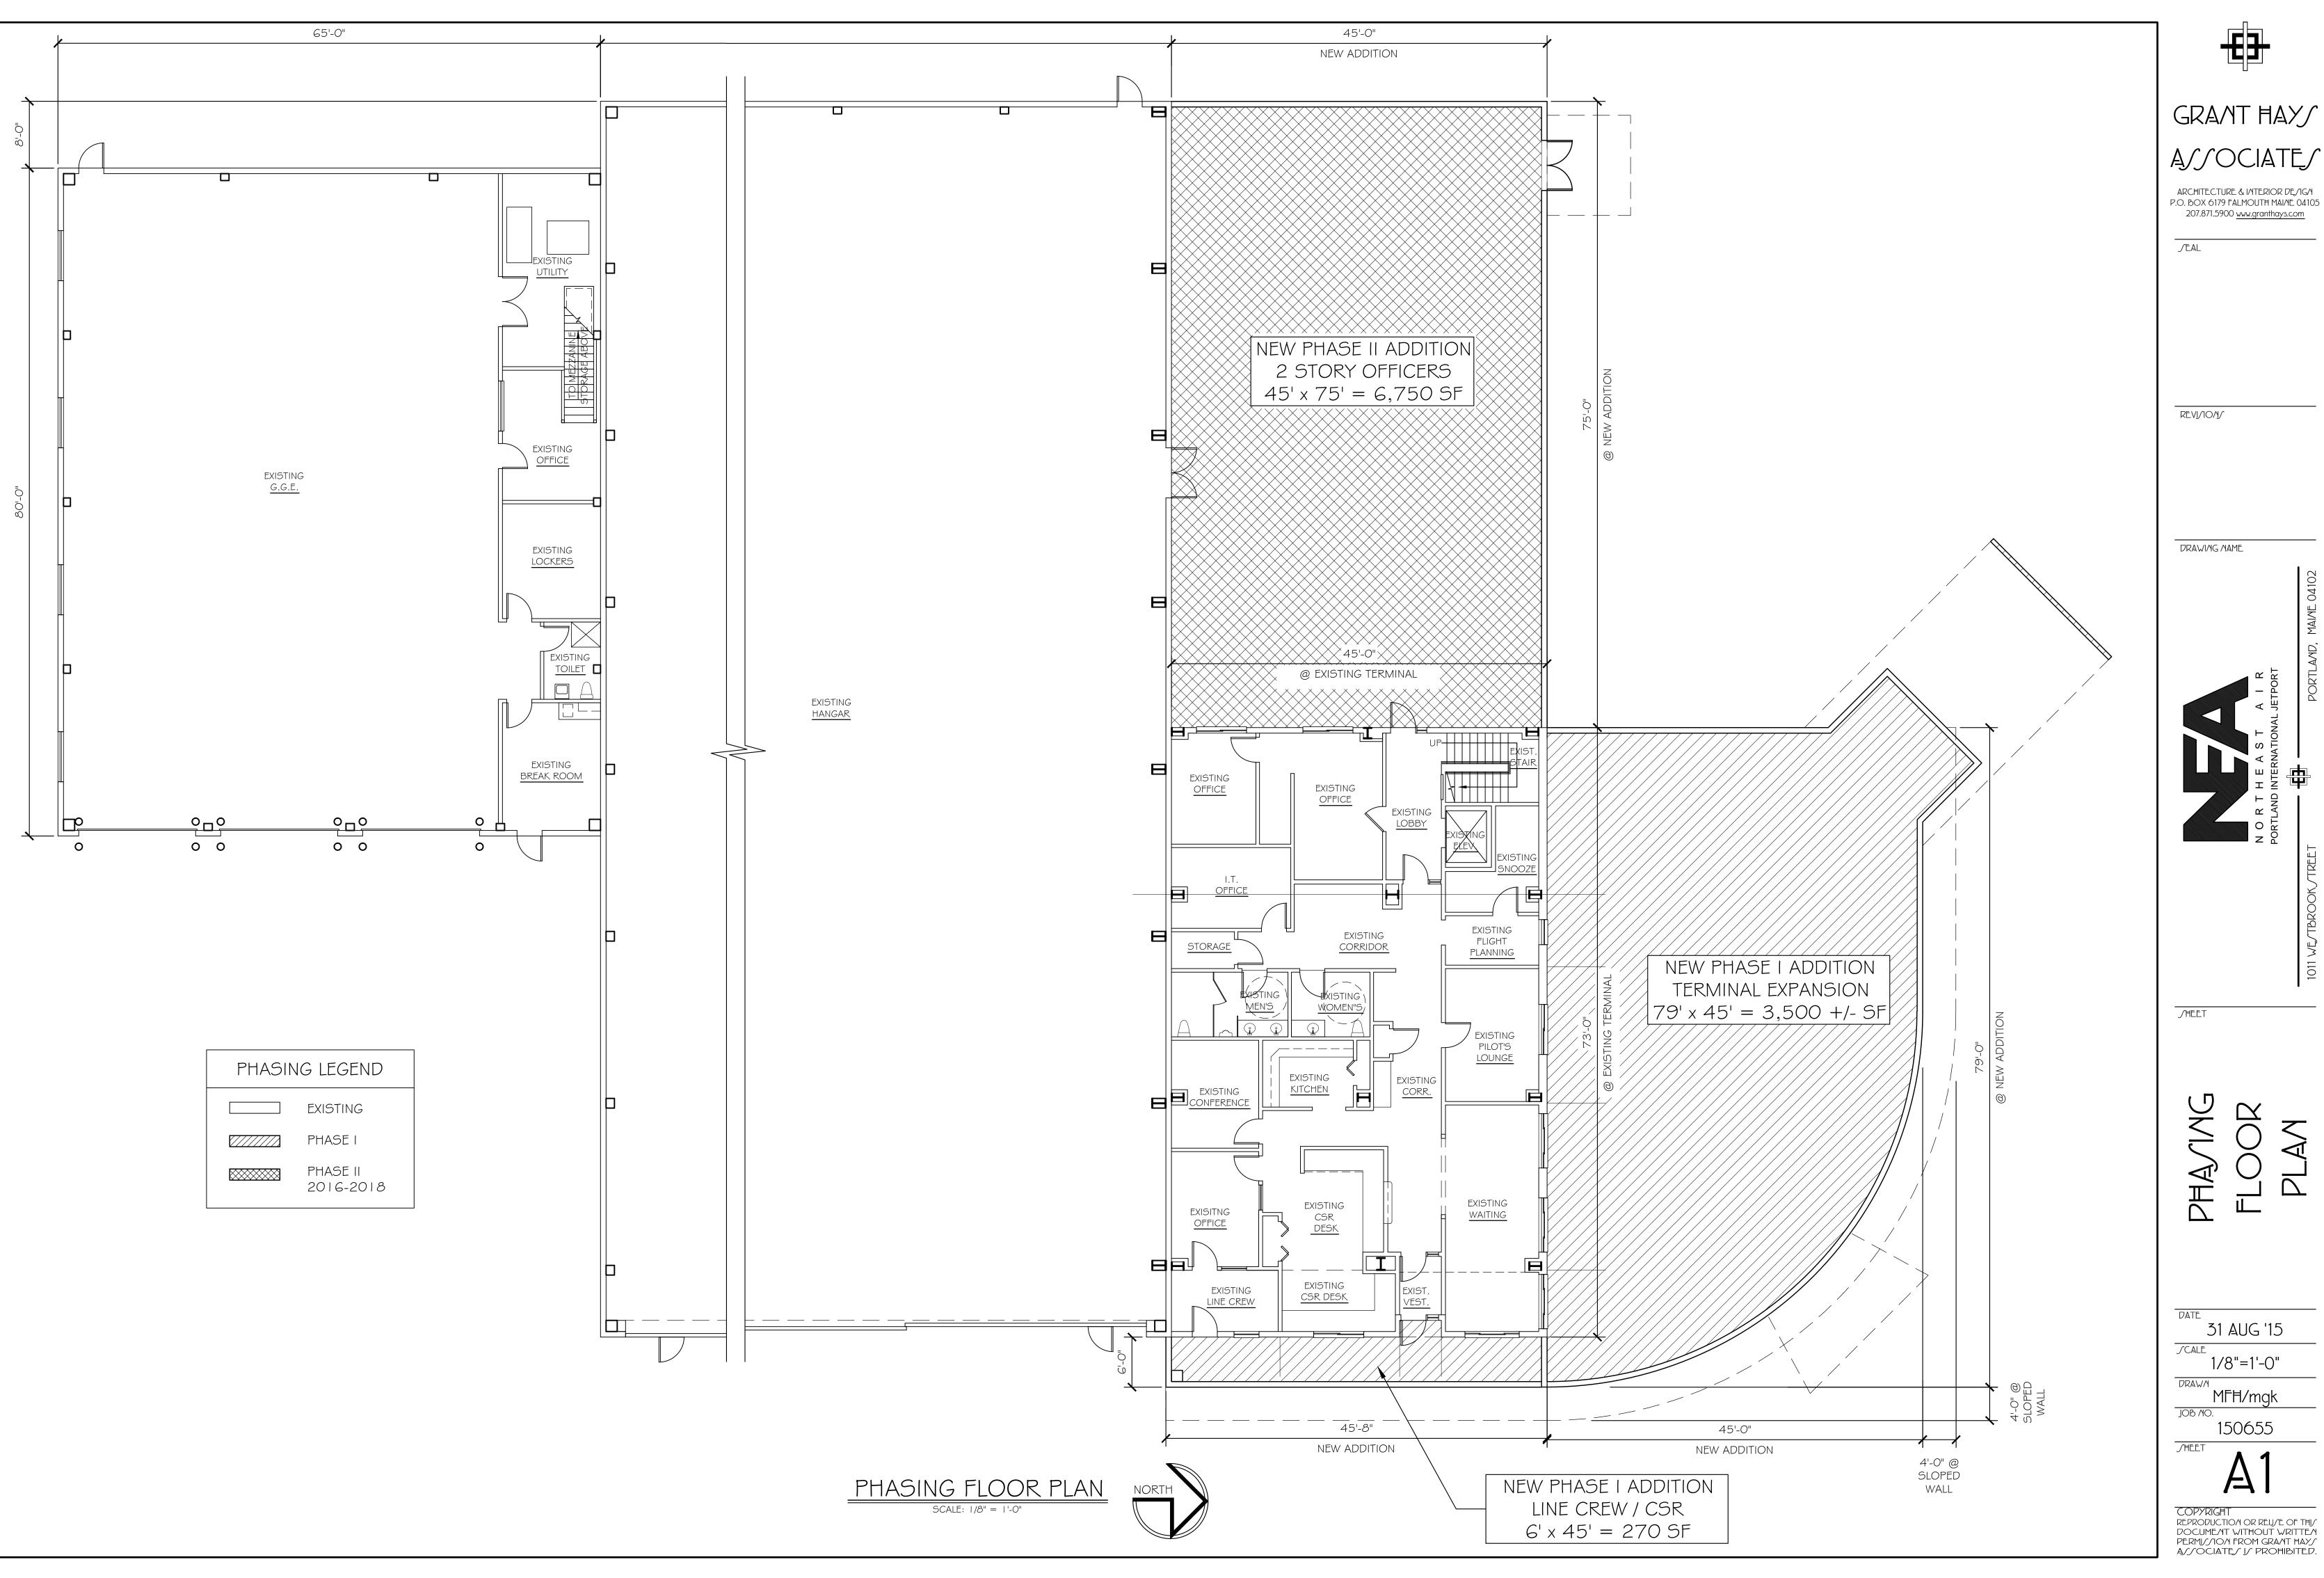

GRANT HAY

ARCHITECTURE & INTERIOR DE/IGN P.O. BOX 6179 FALMOUTH MAINE 04105

31 AUG '15


1/8"=1'-0"

MFH/mgk

150655

COPYRIGHT

REPRODUCTION OR REU/E OF THI/
DOCUMENT WITHOUT WRITTEN
PERMI//ION FROM GRANT HAY/
A//OCIATE/ J/ PROHIBITED.

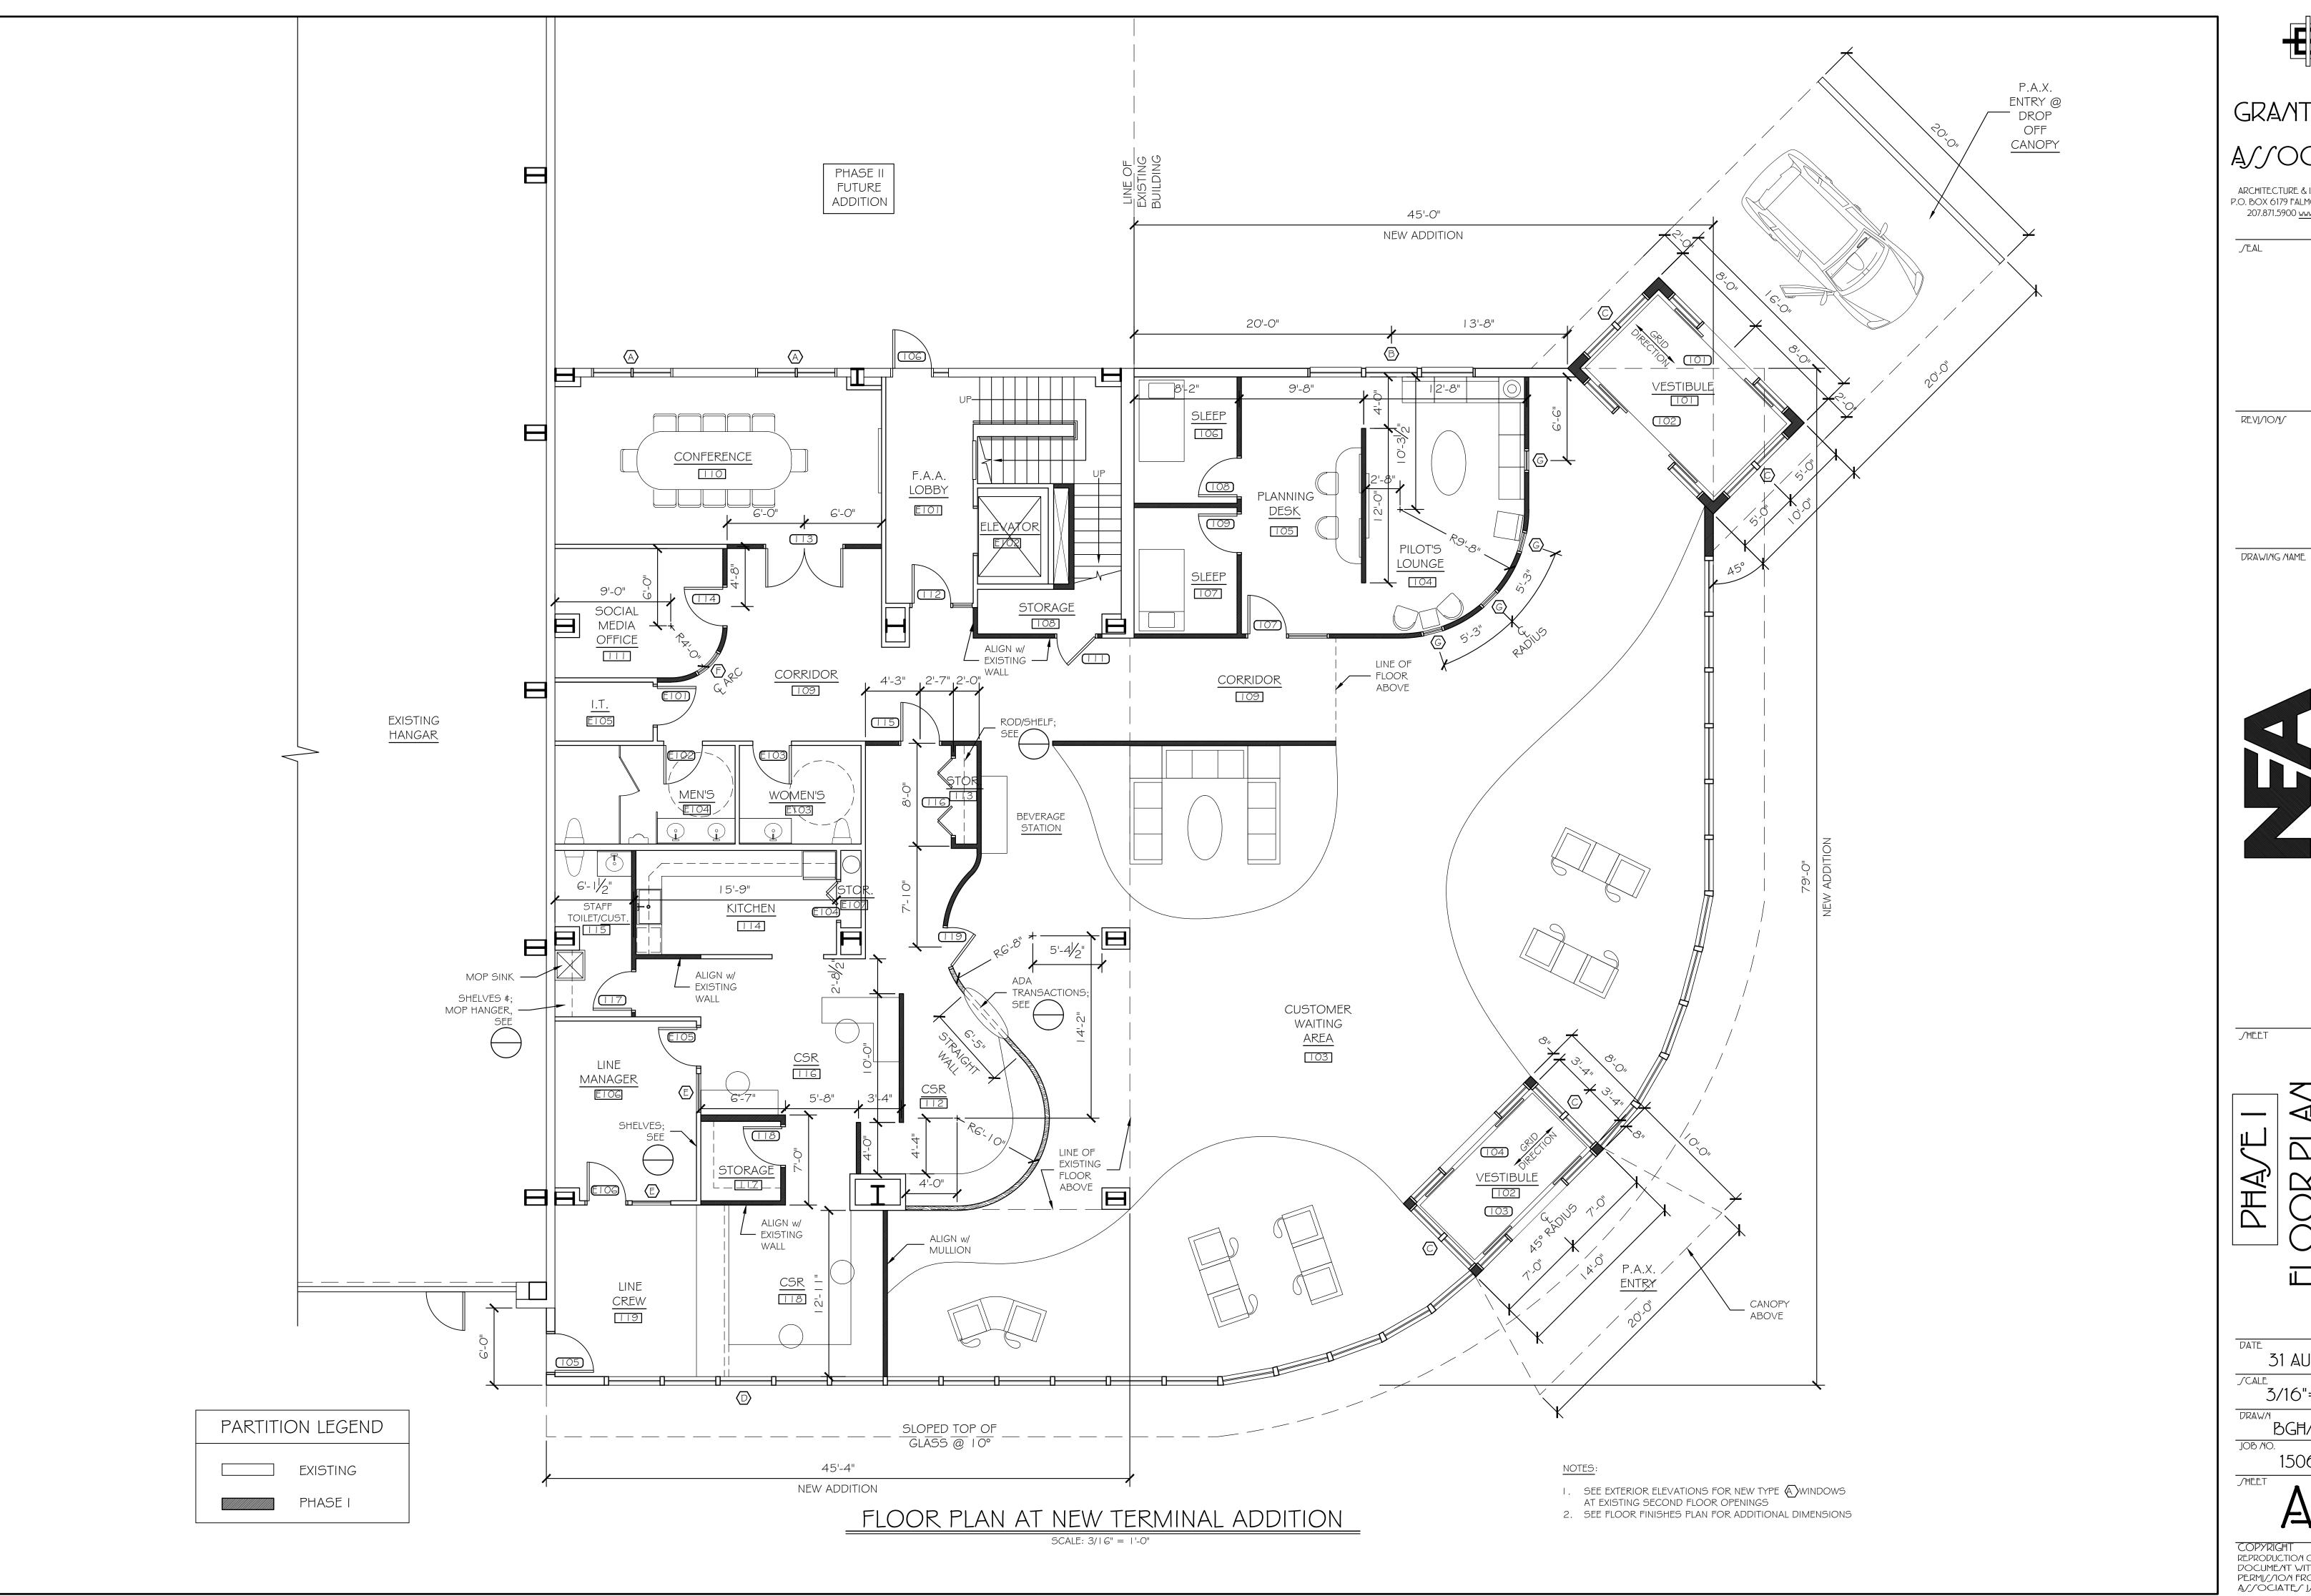

GRANT HAY ASSOCIATES

ARCHITECTURE & INTERIOR DE/IGN P.O. BOX 6179 FALMOUTH MAINE 04105 207.871.5900 www.granthays.com

31 AUG '15

3/16"=1'-0"

BGH/mgk

150655


COPYRIGHT

REPRODUCTION OR REU/E OF THI/

DOCUMENT WITHOUT WRITTEN

PERMI/JON FROM GRANT HAY/

A//OCIATE/ J/ PROHIBITED.

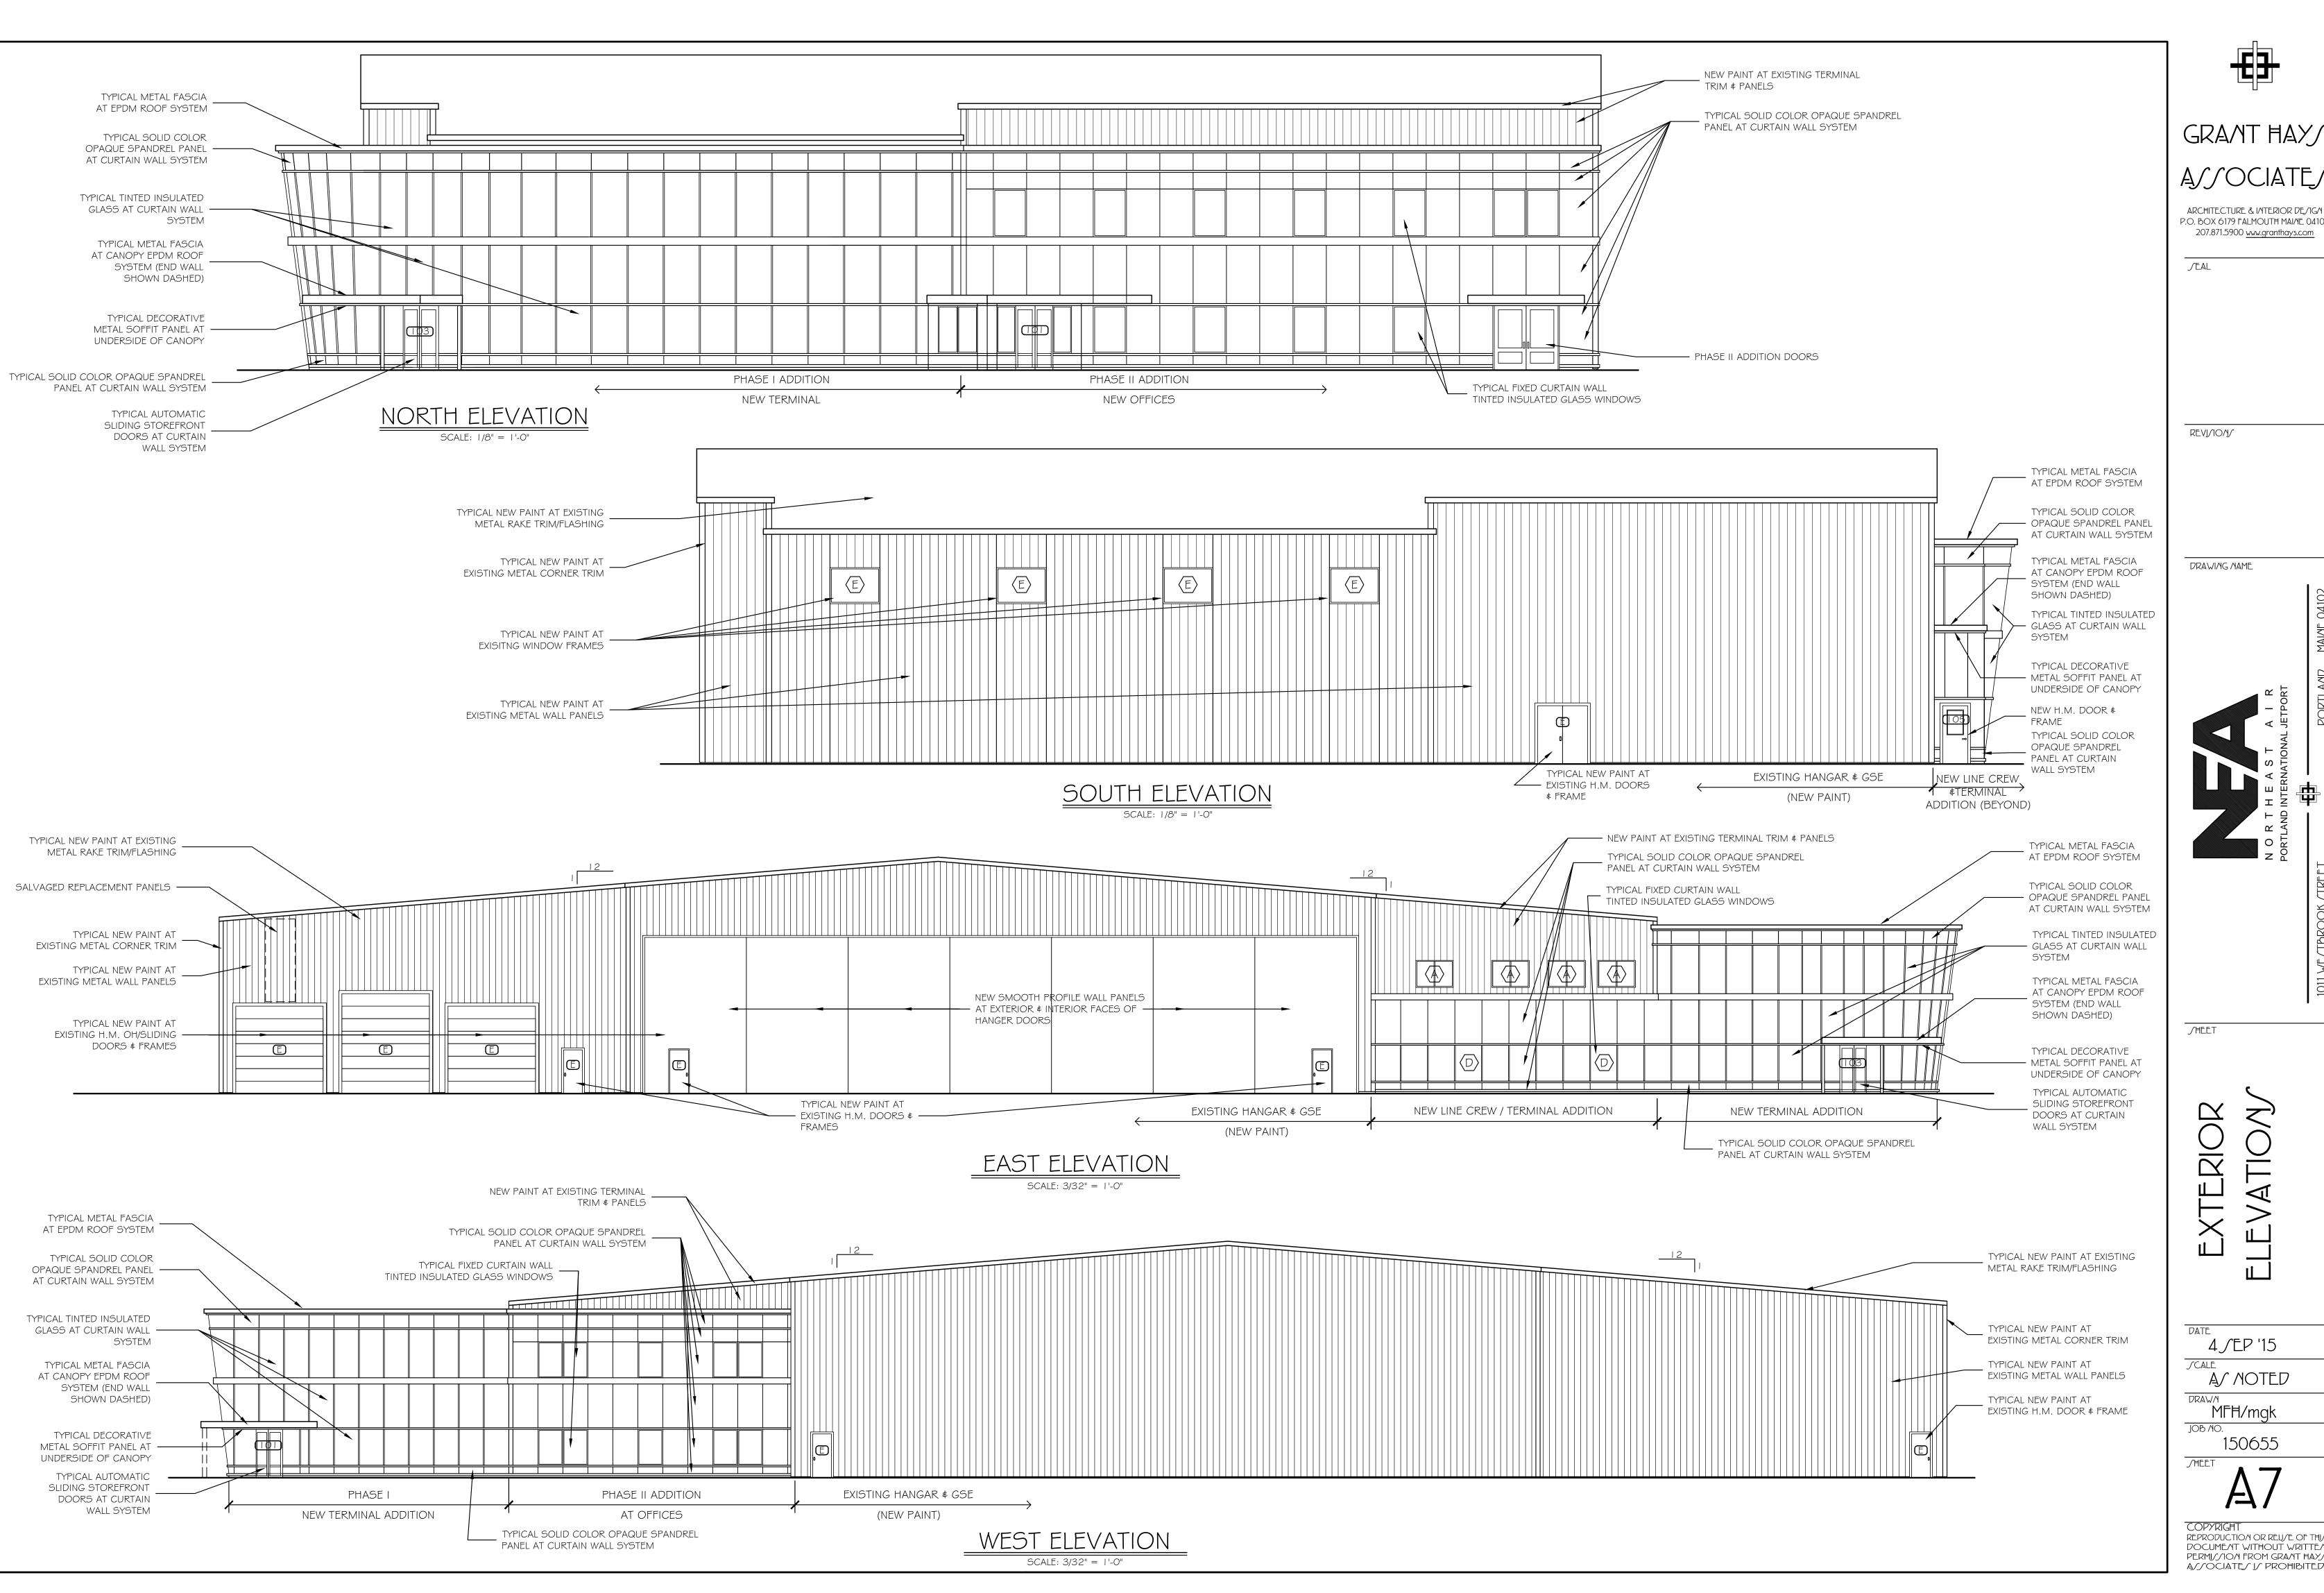

GRANT HAY

ASSOCIATES

P.O. BOX 6179 FALMOUTH MAINE 04105 207.871.5900 <u>www.granthays.com</u>

DRAWING MAME


4 JEP '15

A/ NOTED

MFH/mgk

150655

REPRODUCTION OR REU/E OF THI DOCUMENT WITHOUT WRITTEN PERMY/ION FROM GRANT HAY/A/OCIATE/ J/ PROHIBITED.

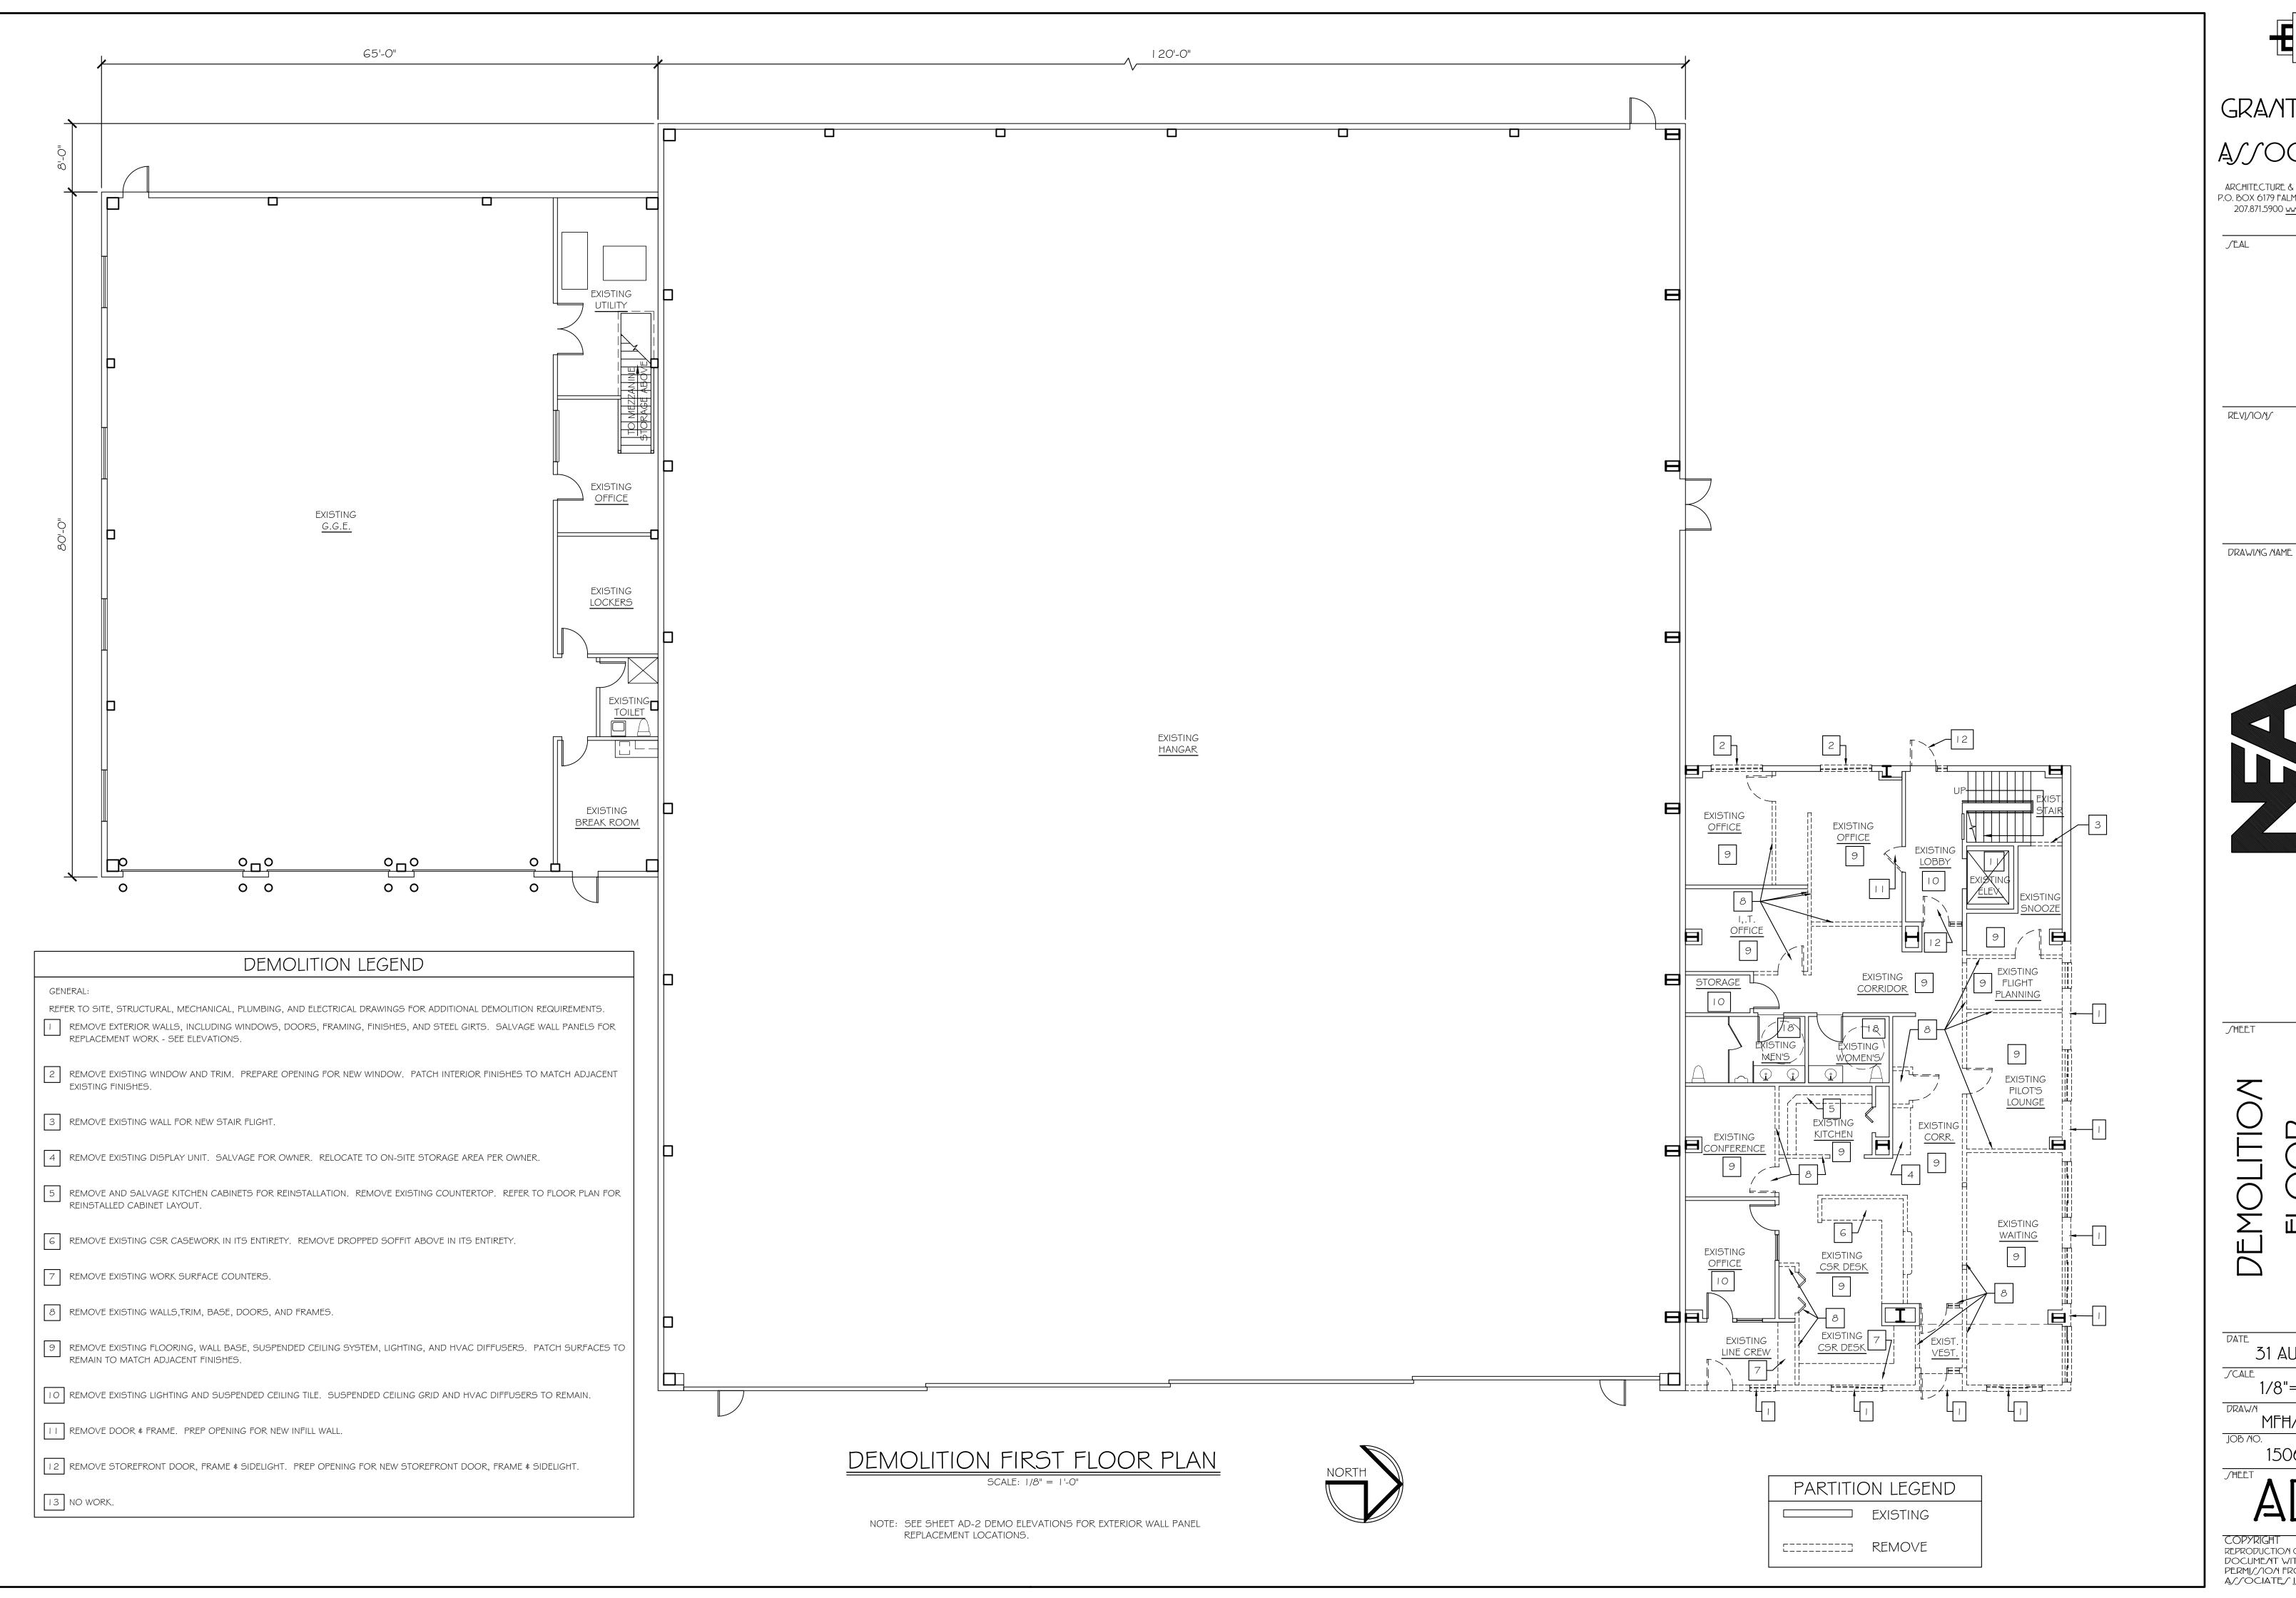

GRANT HAY


ARCHITECTURE & INTERIOR DE/IGN P.O. BOX 6179 FALMOUTH MAINE 04105 207.871.5900 <u>www.granthays.com</u>

31 AUG '15

1/8"=1'-0"

MFH/mgk

REPRODUCTION OR REU/E OF THU DOCUMENT WITHOUT WRITTEN PERMU/JON FROM GRANT HAY/A//OCIATE/ J/ PROHIBITED.

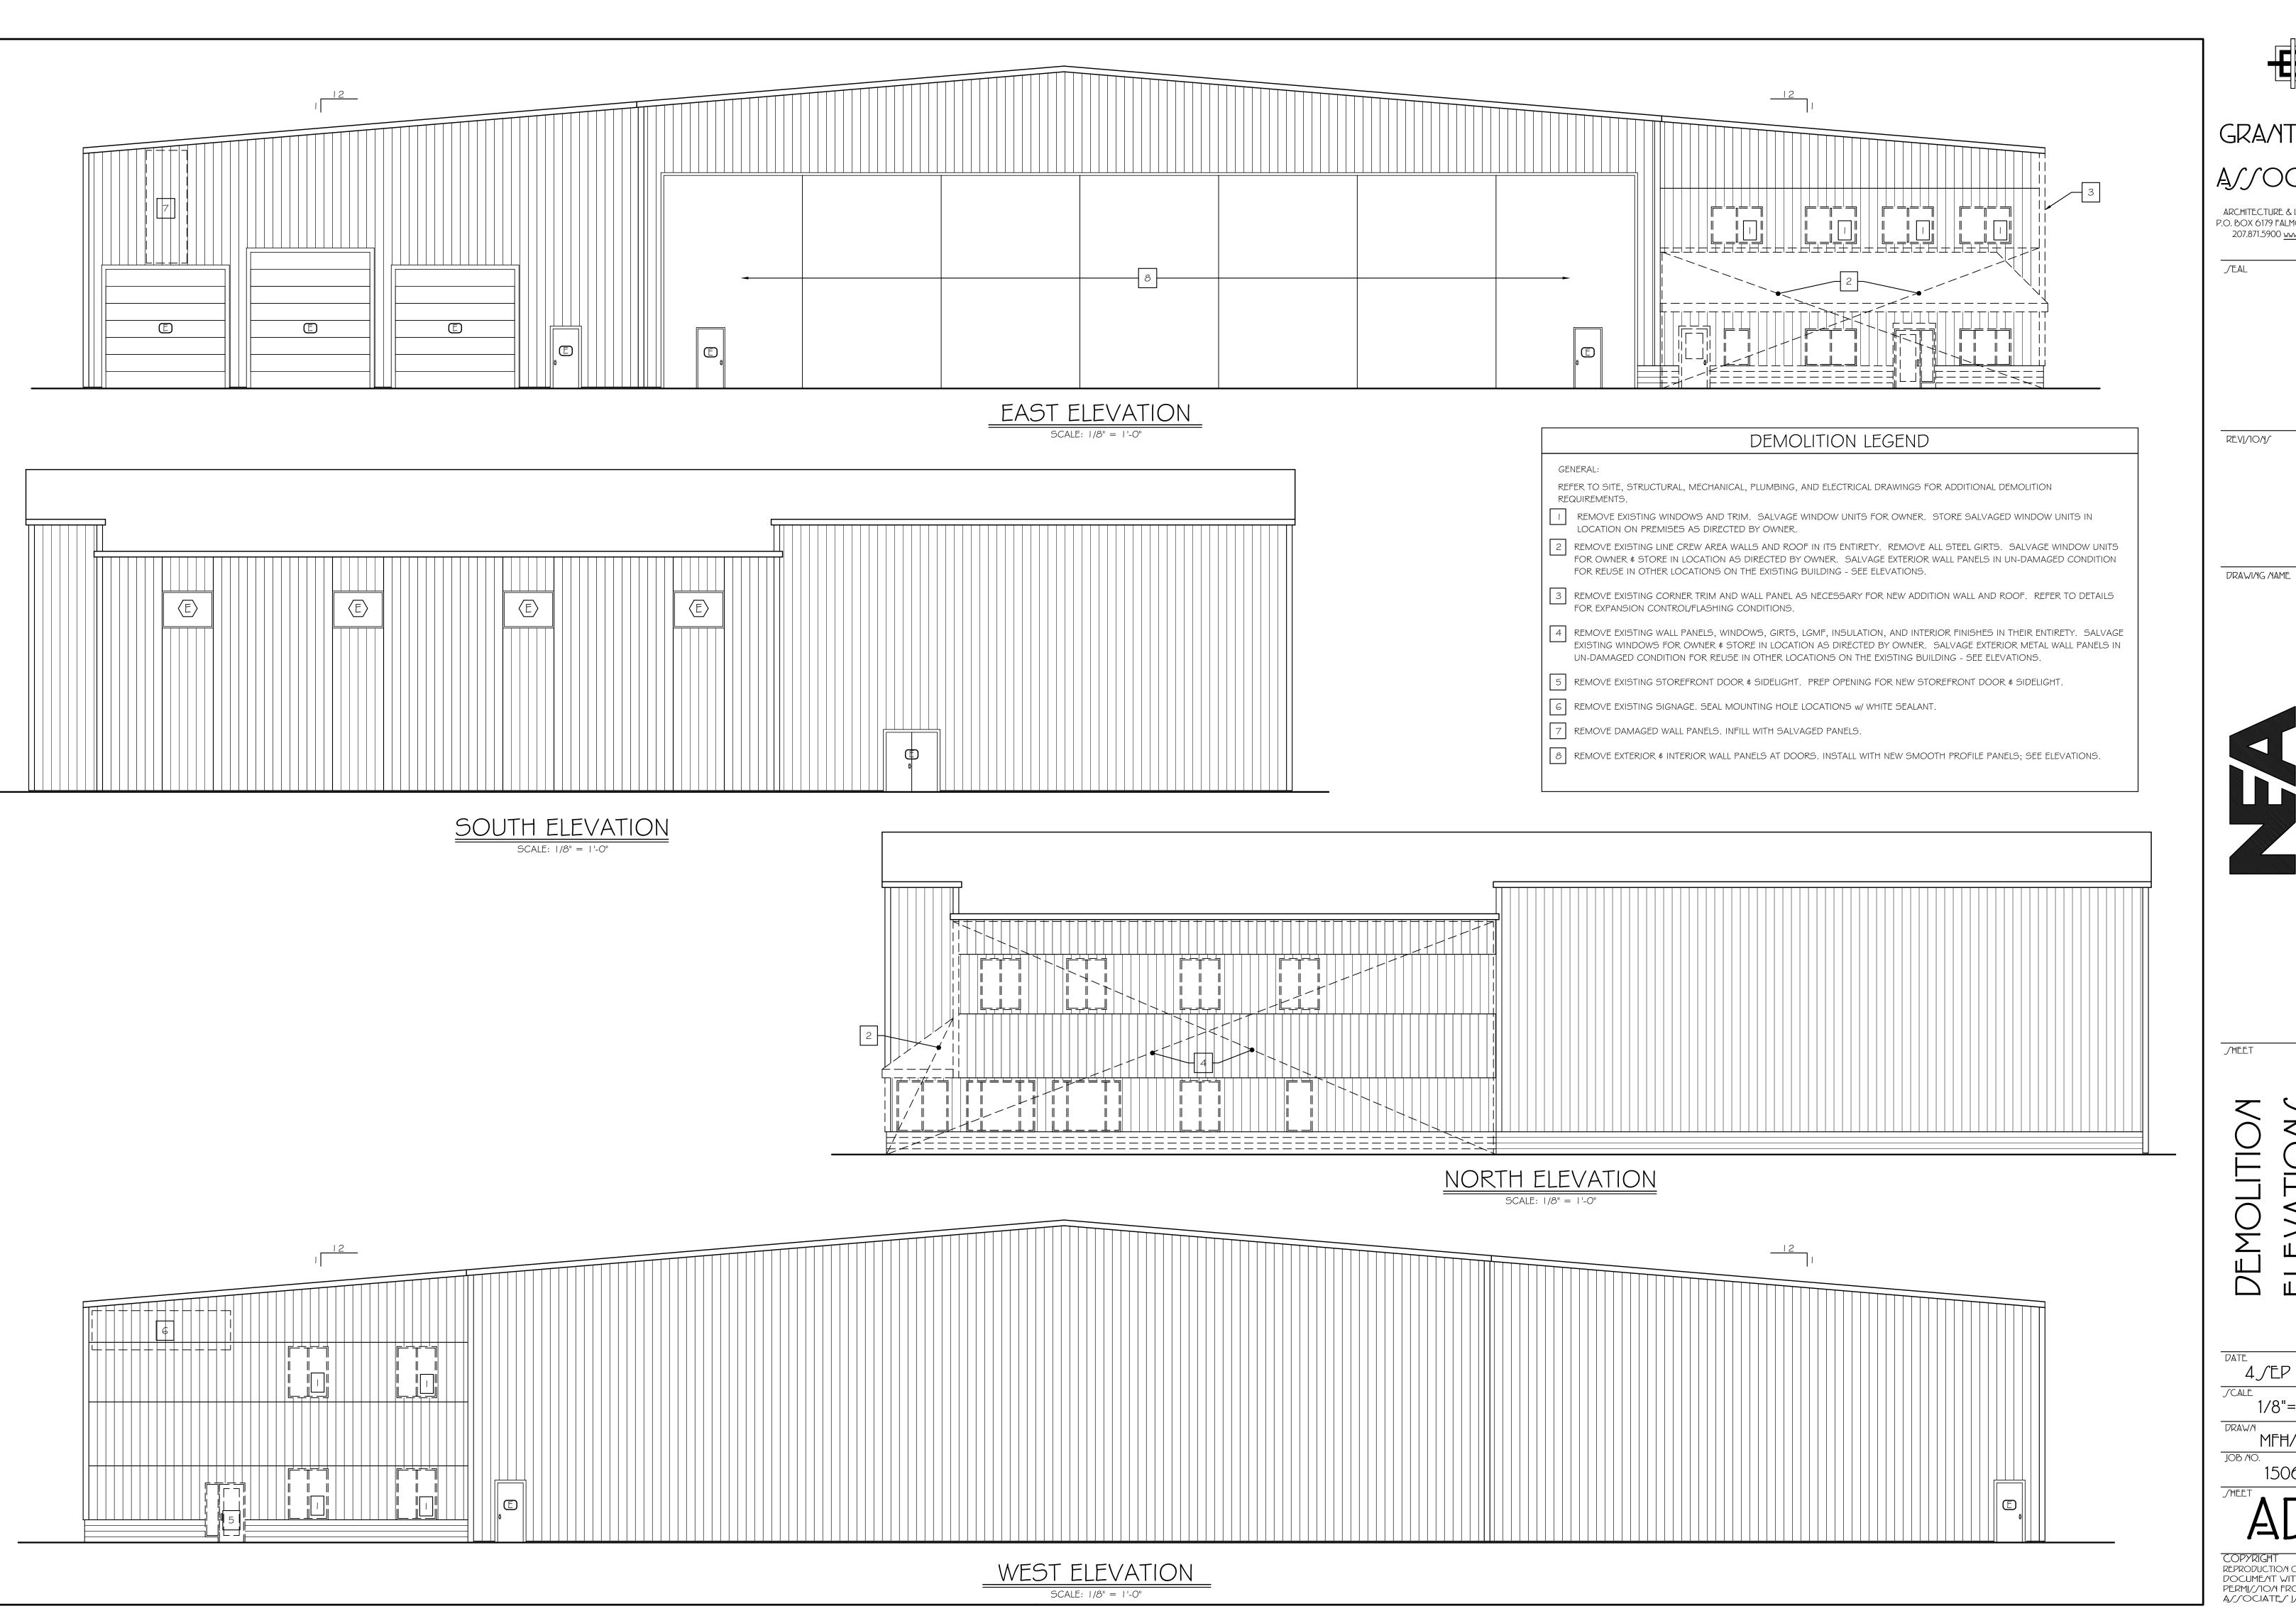

GRANT HAY ASSOCIATES

ARCHITECTURE & INTERIOR DE/IGN P.O. BOX 6179 FALMOUTH MAINE 04105 207.871.5900 <u>www.granthays.com</u>

4∫EP '15

1/8"=1'-0"

MFH/mgk

150655

COPYRIGHT

REPRODUCTION OR REU/E OF THI/
DOCUMENT WITHOUT WRITTEN
PERMI//ION FROM GRANT HAY/
A//OCIATE/ J/ PROHIBITED.