


GENERAL NOTES

- All work included in these drawings and specifications shall conform to all state, national, and other codes and ordinances.
 The General Contractor shall be responsible for obtaining building permits and for payment of all fees and hook—ups.
- 3. General contractor shall verify all dimensions and report any discrepancies to the architect before proceeding with work. Do not scale drawings, work from dimensions only.
- 4. The General Contractor shall obtain approval from the owner for staging areas and hours of allowable work times.
- 5. Provide appropriate reinforcing within partitions for support of all grab bars, shelving brackets, cabinets, door frames, water coolers, cubbies, fire extinguishers, lighting, and other wall mounted equipment or appliances indicated in documents.
- 6. Provide ADA insulation under sinks at exposed pipes.
- 7. All gypsum wall board within 3'-0" of plumbing fixtures shall be moisture resistant.
- 8. Before penetrating or otherwise modifying joists, beams, or other structural members, consult with the Architect on maximum size and location of penetrations.
- 9. Provide double studs at all door frames over 3'-0" wide.


 10. All penetrations through rated walls and floor/ceiling assemblies shall be firestopped by specific subcontractor requiring penetration.
- 11. Location of every exit shall be clearly indicated by exit signs placed, if required, at an angle with the exit opening. Install directional signs to serve as guides form all portions of the corridor or floor.

APPLICABLE CODES

- City of So. Portland
 International Building Code, 2009
 NFPA 101, Life Safety Code, 2006
 Maine State Internal Plumbing Code
 NFPA 13 Sprinklers
 ASHRAE 90.1 2007 Energy Standards for Buildings except
 Low—Rise Residential
 ASHRA 62.1 2007 Ventilation for Acceptable Indoor Air Quality
 2009 International Energy Conservation Code
- Plumbing, Mechanical, Electrical, and Sprinkler system shall be design/build and shall meet all applicable codes.

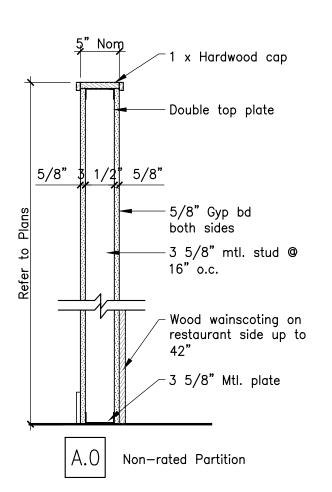




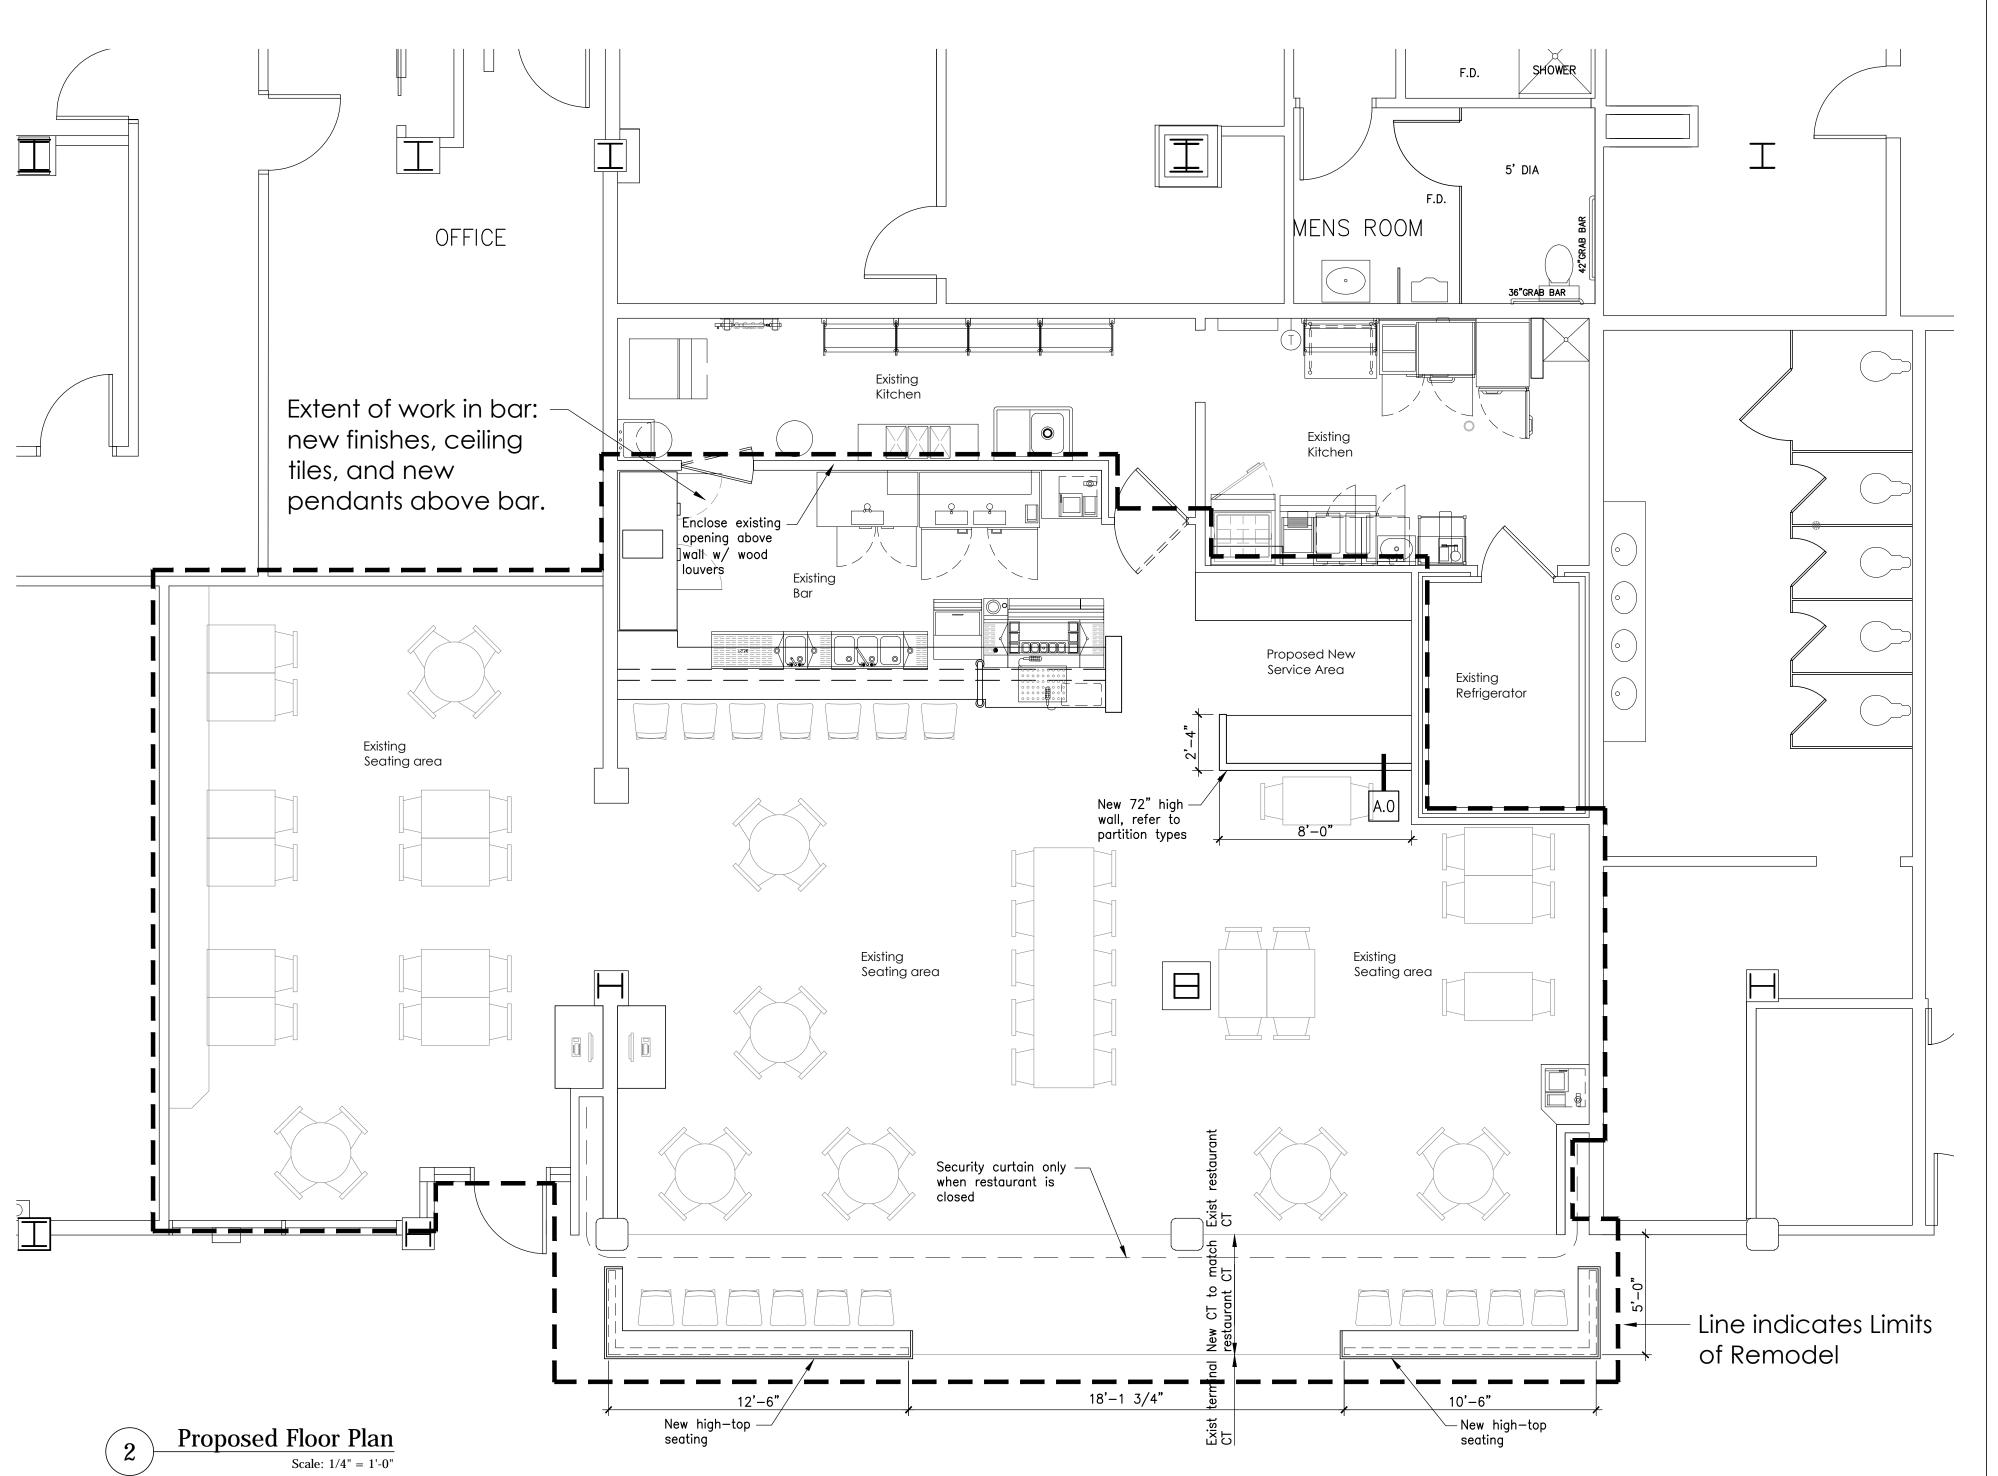

David Matero Architecture

100 Front Street Suite 40 Bath, Maine 04530 207.671.6820 david@davidmatero.com

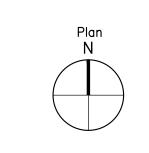


<u>Consultants</u>

Revisions

Portland International Jetport

1001 Westbrook St So Portland, Maine 04102

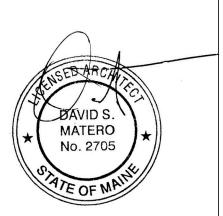

Job Number: 13.000 Date: 12.10.13 Scale: As Noted

Drawing Title:

Key Plan and Proposed Floor Plan

A. 1

Issued for Permit

Copyright 2013 David Matero Architecture, LLC

EGRESS — IBC (Table 1004.1.1)			EGRESS — Life Safety (Table 7.3.1.2)			
		Ground Floor				
1,040 sf @ 15 sf net =	69 Occupants	Assembly Space (Unconcentrated)	1,040 sf @ 15 sf net =	69 Occupants		
18 Seats =	18 Occupants	Bar Seating	18 Seats =	18 Occupants		
300 sf @ 200 gross sf =	2 Occupants	Kitchen	300 sf @ 100 gross sf =	3 Occupants		
	89 Occupants	Total Occupants		90 Occupants		
	18 Seats =	18 Seats = 18 Occupants 300 sf @ 200 gross sf = 2 Occupants	Ground Floor 1,040 sf @ 15 sf net = 69 Occupants Assembly Space (Unconcentrated) 18 Seats = 18 Occupants Bar Seating 300 sf @ 200 gross sf = 2 Occupants Kitchen	Ground Floor 1,040 sf @ 15 sf net = 69 Occupants Assembly Space (Unconcentrated) 1,040 sf @ 15 sf net = 18 Seats = 18 Occupants Bar Seating 18 Seats = 300 sf @ 200 gross sf = 2 Occupants Kitchen 300 sf @ 100 gross sf = 100 gross sf = 100 gross sf = 100 gross sf 100 gross sf = 100 gross sf 100 gross sf = 100 gross sf 100 gross s		

GENERAL NOTES - VISUAL NOTIFICATION

- 1. Flash rate of strobe shall not exceed two flashes per second (2Hz) nor be less than one flash every second (1Hz) throughout the listed voltage range of the
- 2. Maximum pulse duration shall be 0.2 seconds with a maximum duty cycle of 40%
- 3. Wall mounted strobes shall be mounted such that the entire lens is not less than 80" and not greater then 96" above the finished floor or at mounting height specified using the performance-based alternative.
- 4. If two groups of strobes are in the same room or visible, each group shall be synchronized, including if strobes are operated by separate systems.
- 5. In square rooms w/ strobes not centered or in non-square rooms, the effective intensity from one strobe shall be determined by the max room size dimension by measuring the distance to the farthest wall or by doubling the distance to the farthest adjacent wall, whichever is greater.
- 6. Strobes shall be located not more than 15' from the end of a corridor with a separation not greater than 100' and shall flash in synchronization. The effective intensity shall be rated not less than 15 cd.

GENERAL NOTES - VISUAL NOTIFICATION

- 1. Audible sound level of fire alarm horns shall be at least 15 dB above the average ambient sound level or 5 dB above the maximum sound level having a duration of at
- 2. An average ambient sound level greater than 105 dBA shall require the use of visible notification.
- 3. The total sound pressure level produced by combining the ambient sounds pressure level with all audible notification appliances operating shall not exceed 110 dBA at the min hearing distance.

SYMBOL LEGEND

- LED Exit Light (unswitched)
- Self Contained, wall—mounted, Emergency Lighting Unit with 2 Heads and battery backup
- Self Contained, ceiling—mounted, Emergency Lighting Unit with 2 Heads and battery backup
- Single Head Remote Emergency Light
- Fire Alarm Audio/Visual, mount 6'-8" AFF, dB Level in
- SD Fire Alarm Visual Strobe only, Flush mount 6'-8" AFF, set Candela Level in Field according to code
- System connected Smoke Detector, photoelectric type
- F Fire Alarm pull station, mount 48" AFF
- FACP Fire Alarm Control Panel Station, location to be approved by Portland Fire Department
- Knox Box (location and type to be approved by Portland Fire Department)
- Fire extinguisher cabinet and type
- ETR Existing to Remain
- Magnetic Hold Open (requires smoke detectors located MHO on each side of door and connected to sprinkler system)
- WP Exterior grade / waterproof


w/ Sounder base

- 1. Life safety equipment and locations shall conform to all
- applicable codes. Provide pull station at each assembly door egress.
 Provide duct smoke detectors at each 2,000 CFM supply
- 4. Provide duct smoke detectors at each 15,000 CFM supply
- and exhaust duct. 5. Integrate kitchen smoke/fire detection/suppression system with main fire panel. Provide automatic cooking fuel
- shut-off mechanism. 6. Electrical outlets shall be provided for all plug—in equipment. All other outlets shall be located per all
- applicable codes. 7. Provide laminated floor plan at each public room indicating

Fire Extinguisher Cabinet

direction to building exit.


- Semi—recessed Fire Extinguisher Cabinet by Larsen of approved equivalent. Include Class K hazard in Kitchen
- Portable Fire Extinguishers:
- 1. Location of fire extinguishers and cabinets shall conform to NFPA 10 Standards for Fire Extinguisher Cabinets.
- 2. Portable fire extinguisher rating shall be 2-A, spacing shall not exceed a maximum of 75' and 3,000 sf.
- 3. Portable fire extinguisher rating in combustible cooking media exist shall be rated Class K, spacing shall not exceed a maximum travel distance of 30'

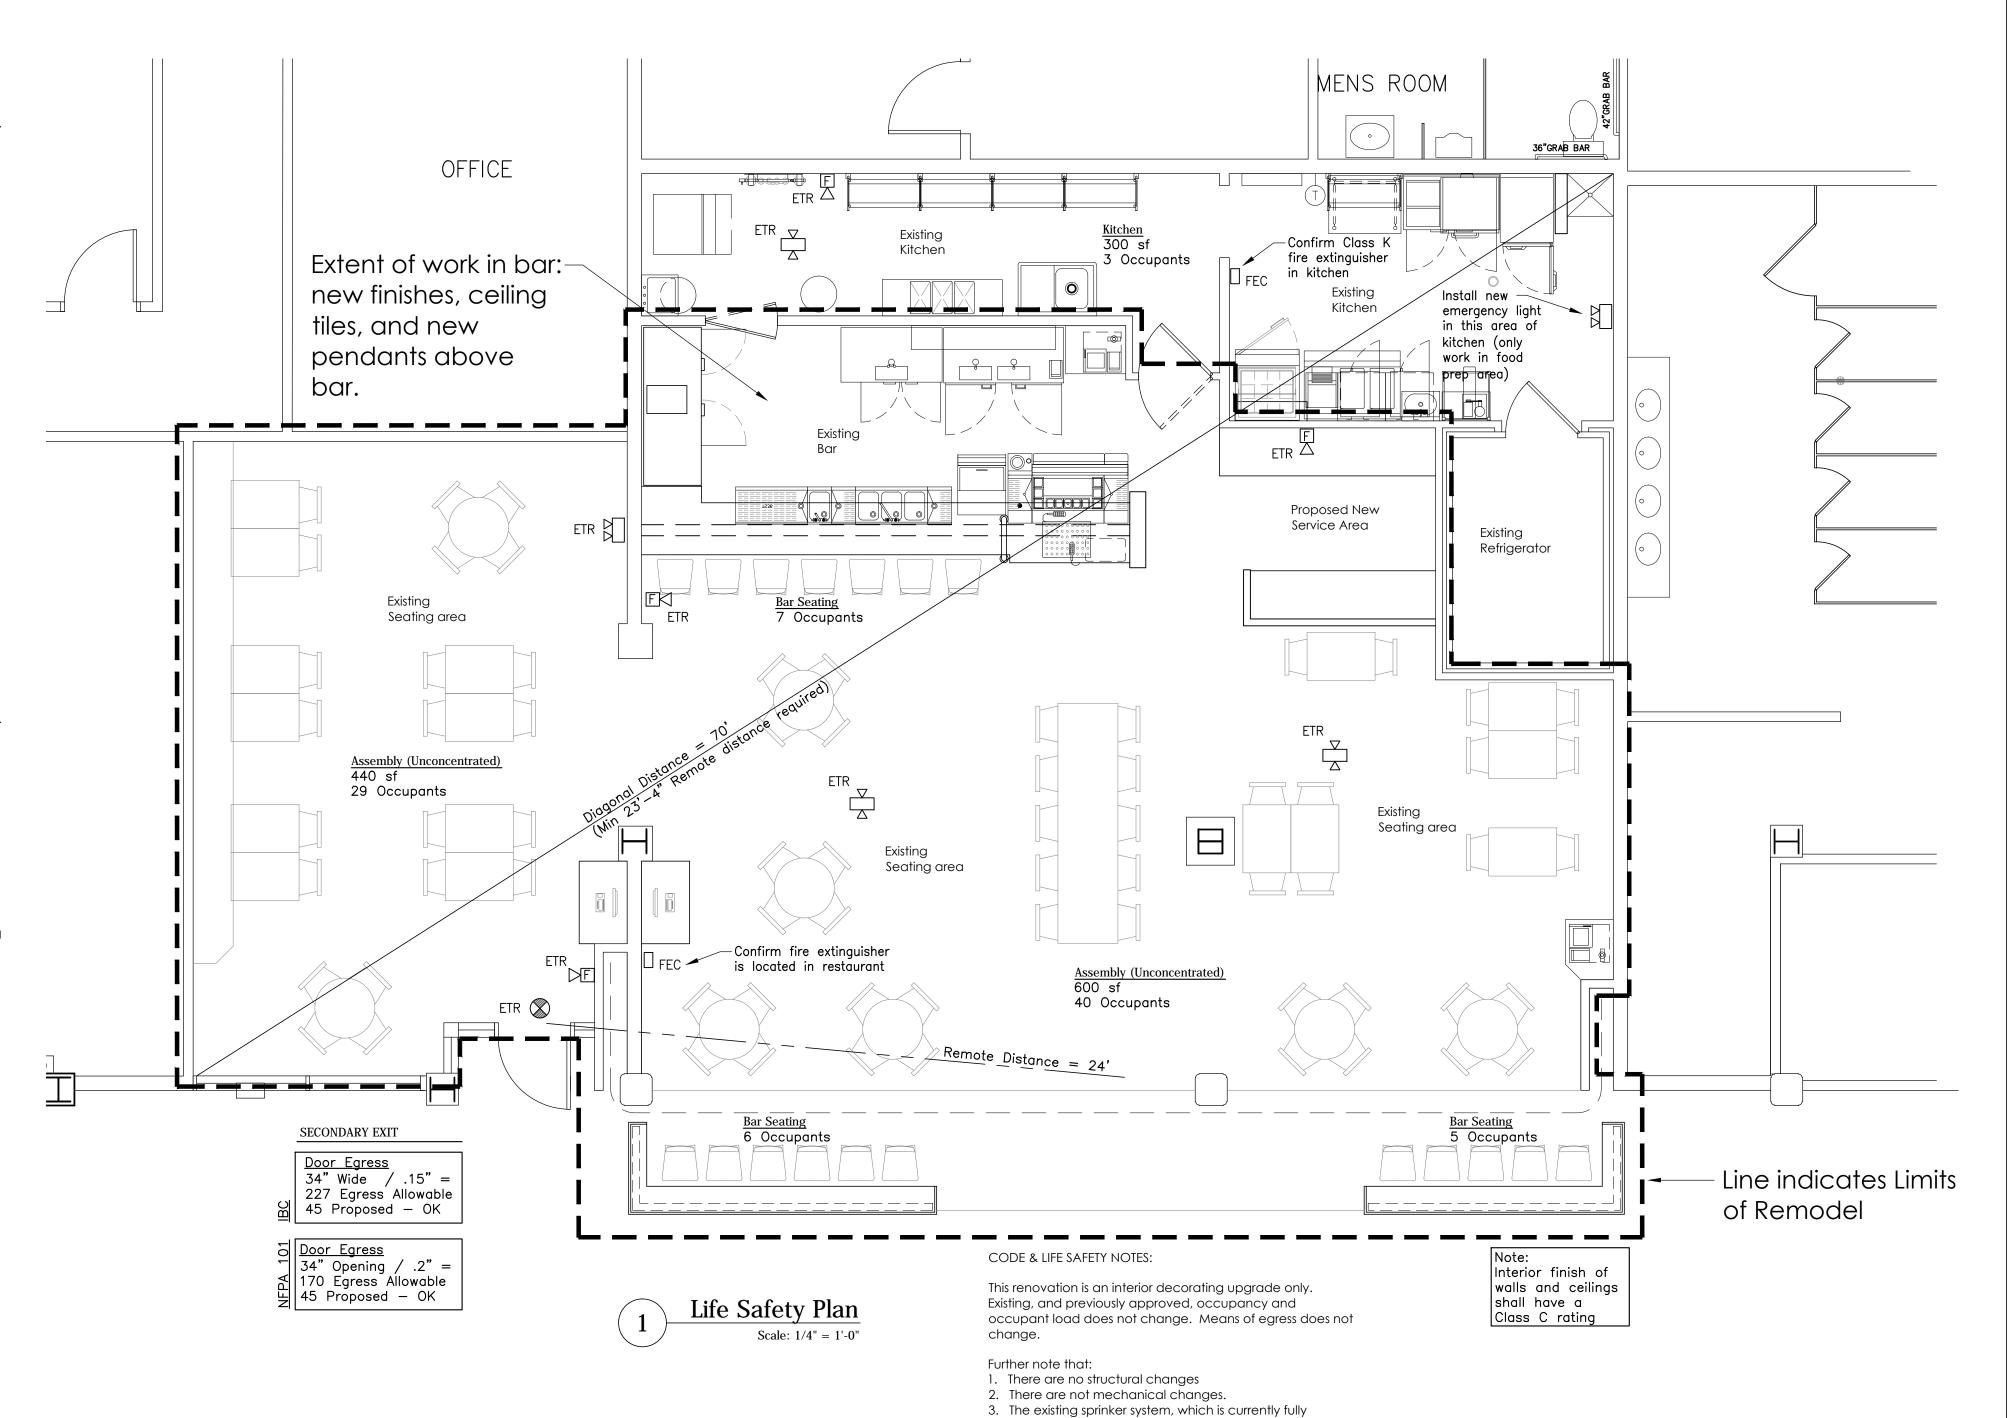

compliant, will not be altered in any way.

David Matero Architecture

100 Front Street Suite 40 Bath, Maine 04530 207.671.6820 david@davidmatero.com

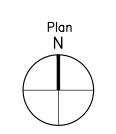


<u>Consultants</u>

<u>Revisions</u>

Portland International Jetport

1001 Westbrook St So Portland, Maine 04102

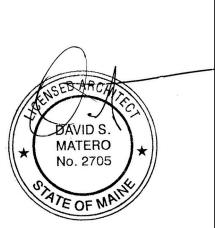

Job Number: 13.000 Date: 12.10.13 Scale:


Drawing Title:

Life Safety Plan

Issued for

Copyright 2013 David Matero Architecture, LLC

Permit

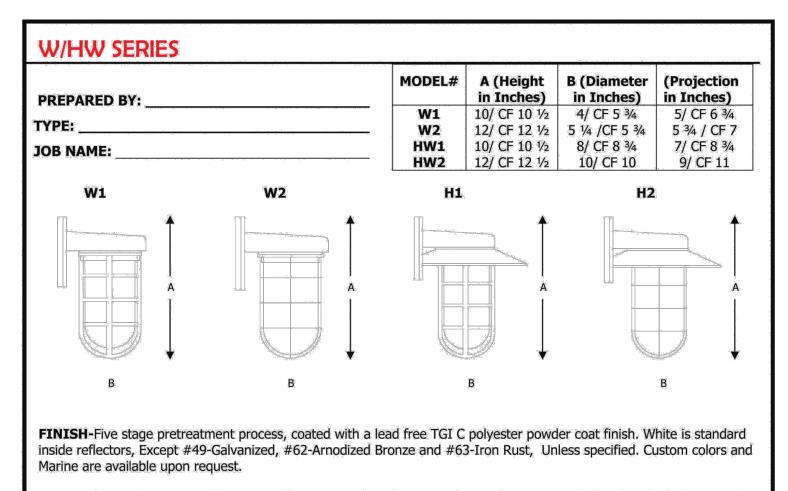

LAMP HOLDERS- Accommodates **Incandescent** medium base porcelain socket, copper shell with nicked plate, rated 250V, 660W. **Compact Fluorescent** 4 pin heat resistant thermoplastic socket accommodates 26/32W (Gx24q-3 base) and 42W (Gx24q-4 base). Twist lock design provides for vibration and earthquake resistance, rated 75W, 600V. **High Intensity Discharge (H.I.D.)** medium base, 4KV pulse start socket, rated 660W/600V.

MOUNTING- 1/2" or 3/4" tapped hub is supplied. Top or side mount available. Fixtures are pre-wired with 48" or 96" leads. Available with cord or stem sets.

REFLECTOR- Spun from heavy gauge 1100-0 aluminum, ranging in thickness from .050 to .125. Galvanized is from 20 gauge sheets. Copper is spun from .040 gauge and 110 soft alloy.


MODEL# FINISH		LIGHT SOURCE				
MODEL#	LINISH	INC	CF	HID(MH & HPS)		
W1	40,41,42,43,44,45,	100W	26 OR 32W*	35,50,70, OR 100W*		
W2	46,48,49,50,51,52,	200W	26,32, OR 42W*	35,50,70, OR 100W*		
HW1	53,54,55	100W	26 OR 32W*	35,50,70,100,150W*		
HW2	1	200W	26,32, OR 42W*	35,50,70,100,150W*		

*FOR REMOTE BALLAST SEE MOUNTING SOURCE


GLASS: MOUNTING SOURCE: ACCESSORIES:



A Type A Fixture

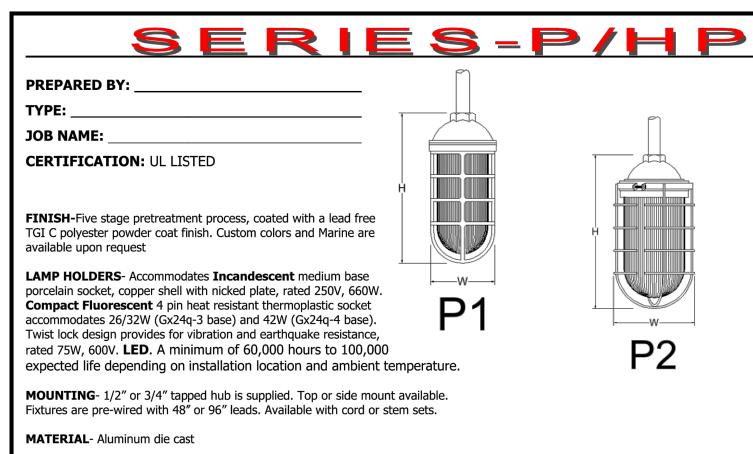

GLASS GUAR CL3-3" clear FR3-3" frosted PR3-3" prismatic RE3-3" red	41-black 42-dr. green 43-red 44-white 45-med. blue 46-yellow	100W	26, 32 or 42W	LED¹	MOUNTING INC BLC-8' black	DIMENSION 10"H x 4 1/4"W
FR3-3" frosted PR3-3" prismatic RE3-3" red	42- dr. green 43- red 44- white 45- med. blue 46- yellow	100W		10W	BLC-8' black	10"H x 4 1/4"\
BL3-3" blue GR3-3" green AH3-3" amber Hyde	42-dr. green 43-red 44-white 45-med. blue 46-yellow 48-polish alum. 49-galvanized 50-navy blue 51-arch. 52-patina 53-rust 54-stucco 55-sage 59-coppertone 60-canal green 61-anod. charcoal 62-anod. bronze 63-iron rust				cord STXX-18", 24", 36" or 48" stem STC- ½"stem mount canopy SLC ½- ½" slope ceiling canopy	10 11 2 7 74 1
CL4-4" clear FR4-4" frosted PR4-4" prismatic RE4-4" red BL4-4" blue GR4-4" green AH4-4" amber		200W	26,32 or 42W	20W	CF CFBLC-8' Black cord STXX 18",24", 36" or 48" stem CFSTC- ½"stem mount canopy CFSLC ½- ½" slope ceiling canopy	11 ½″H x 5″
G gı A	R4- 4" reen H4- 4" mber Hyde	R4-4" reen H4-4" mber Hyde	R4- 4" reen H4- 4" mber	R4-4" reen H4-4" mber Hyde	R4-4" reen H4-4" mber Hyde	L4-4" blue R4-4" reen H4-4" mber Hyde Mount canopy CFSLC 1/2- 1/2" slope ceiling canopy

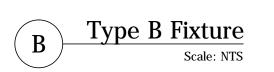


Electrical Notes

- 1. All lighting equipment and associated electrical systems and their installation must conform to all applicable local, state and national codes.
- 2. Outlets or junction boxes mounted back to back shall be prohibited
- 3. Final location of all fixtures and devices to be approved in the field by owner prior to rough—in.
- 4. Existing light fixtures shall remain as indicated, except above bar area where existing pendants shall be switched as noted.
- 5. Ceiling grid and soffits, existing to remain.

Lighting Fixture Schedule					
Type	Description	Total			
А	Wall mounted sconce light — Barn Light Electric, W1, clear glass, size 10 1/2" h x 5 3/4" w	10 total			
В	Ceiling mounted pendant light, series P by Baselite, size 10" h x 4 1/2" w	8 total			

Lighting Symbol Legend

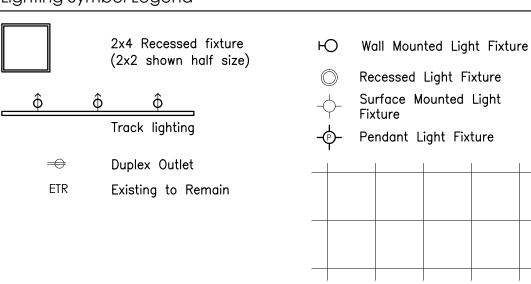

— Provide duplex outlets under

new seating bar area

electrical work

24" x 24" Suspended acoustical panel ceiling

<u>Revisions</u>

David Matero

Architecture

100 Front Street

Suite 40


Bath, Maine 04530

207.671.6820 david@davidmatero.com

<u>Consultants</u>



1001 Westbrook St So Portland, Maine 04102

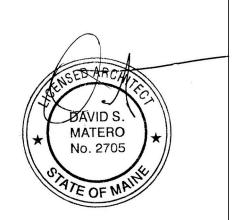


Job Number: 13.000 Date: 12.10.13 Scale:

Drawing Title:

Reflected
Ceiling and
Electrical
Plan

Issued for Permit

Copyright 2013 David Matero
Architecture, LLC

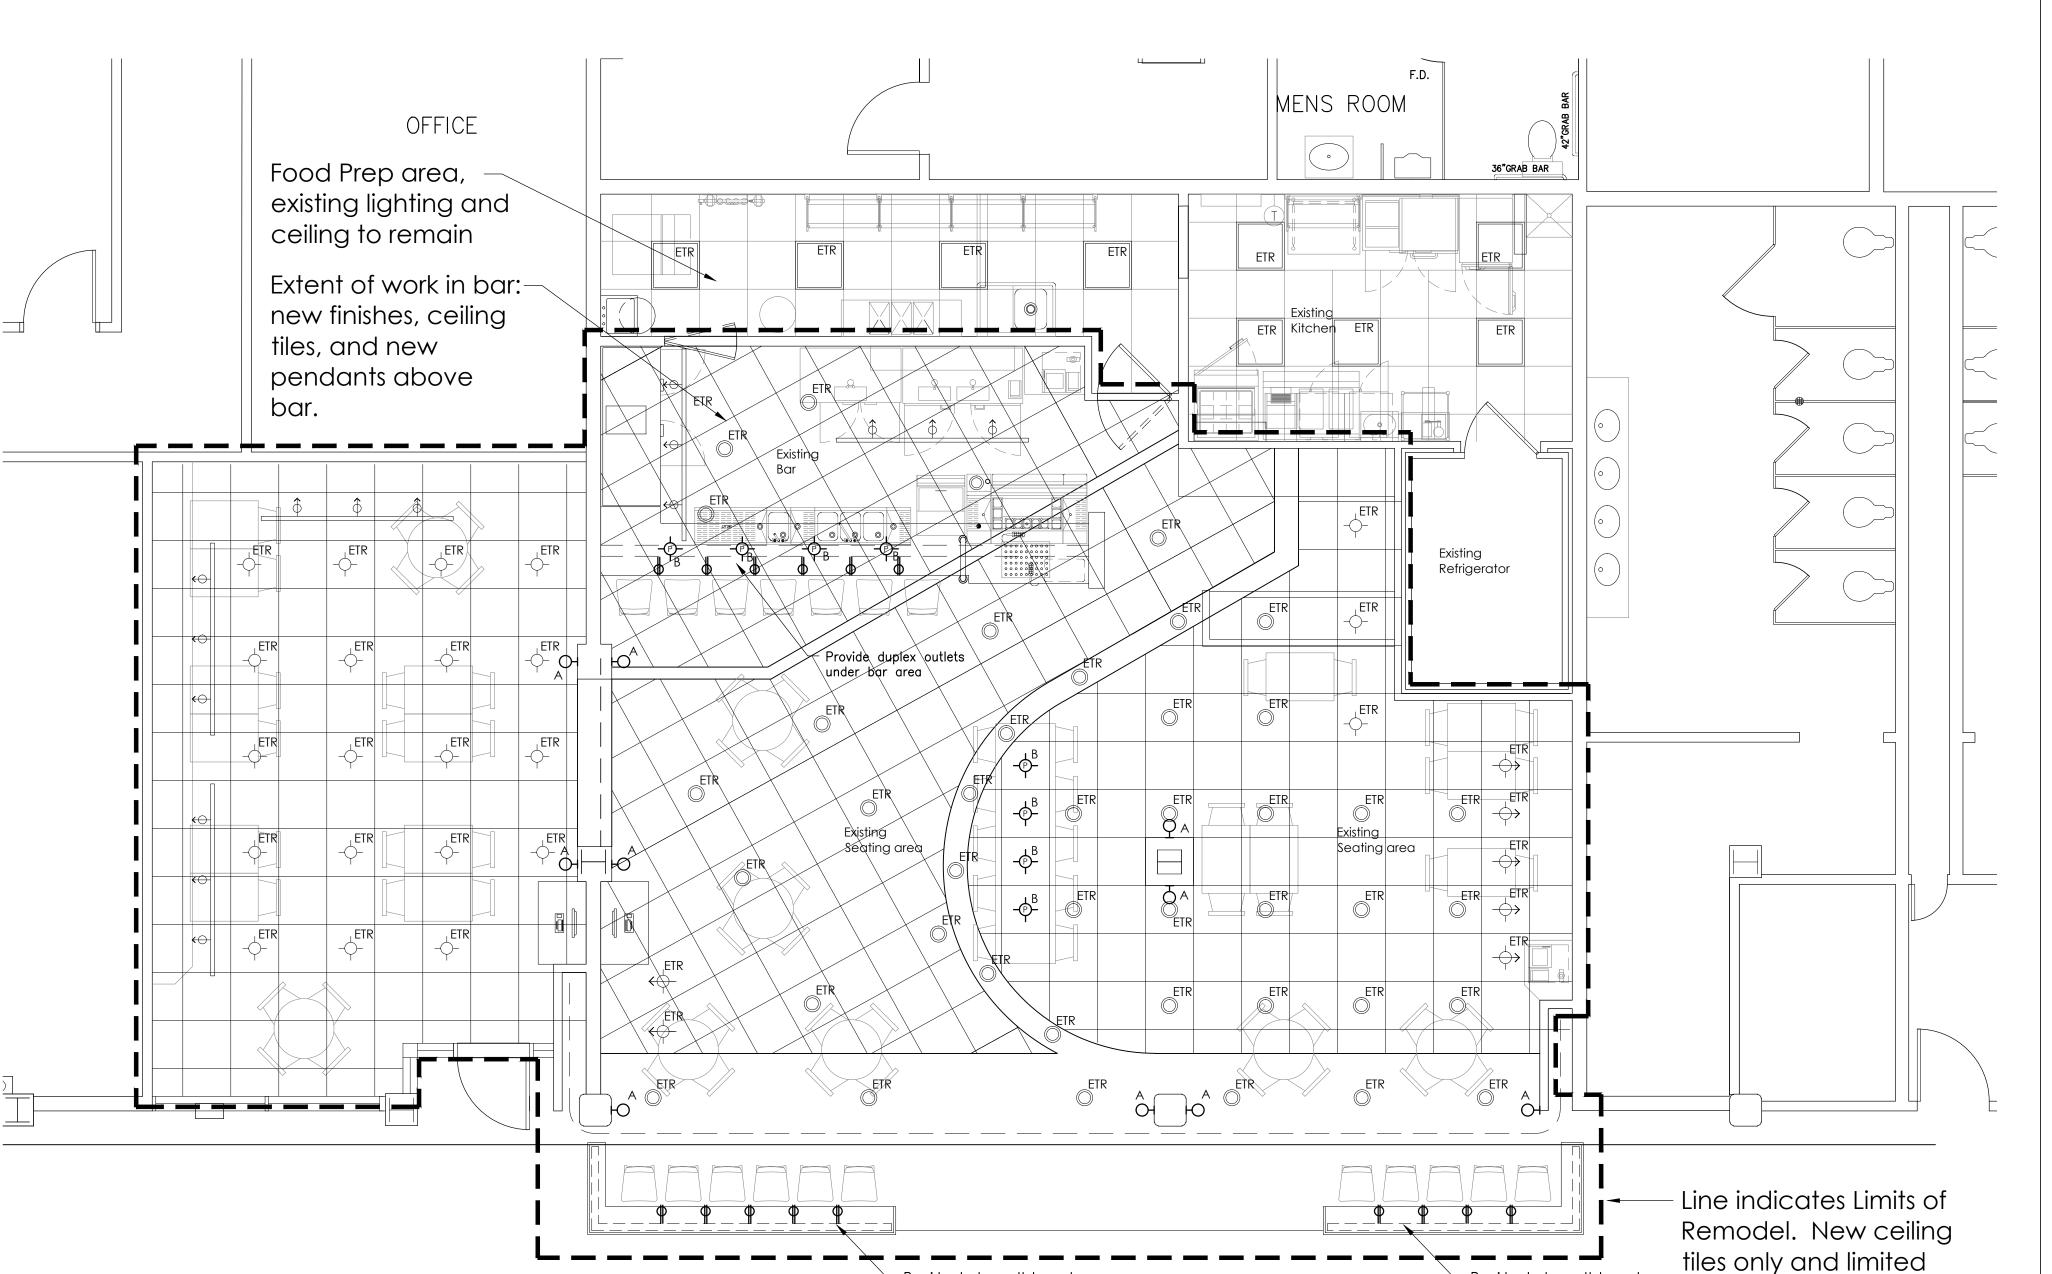

— Provide duplex outlets under

new seating bar area