Revisions:

 05/10/11
 REVISED PLANS

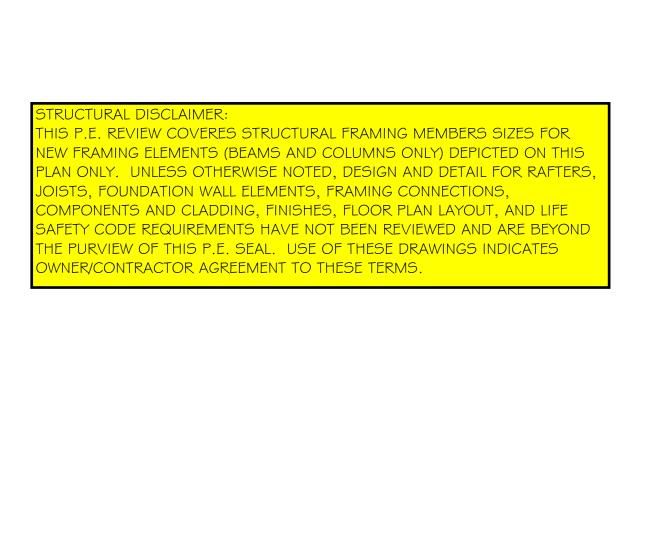
 05/12/11
 REVISED PLANS

 05/27/11
 REVISED PLANS

Date: 05/27/11
Scale: 1/4"=1'-0"
Drawn By: JTM

Project: AW031111
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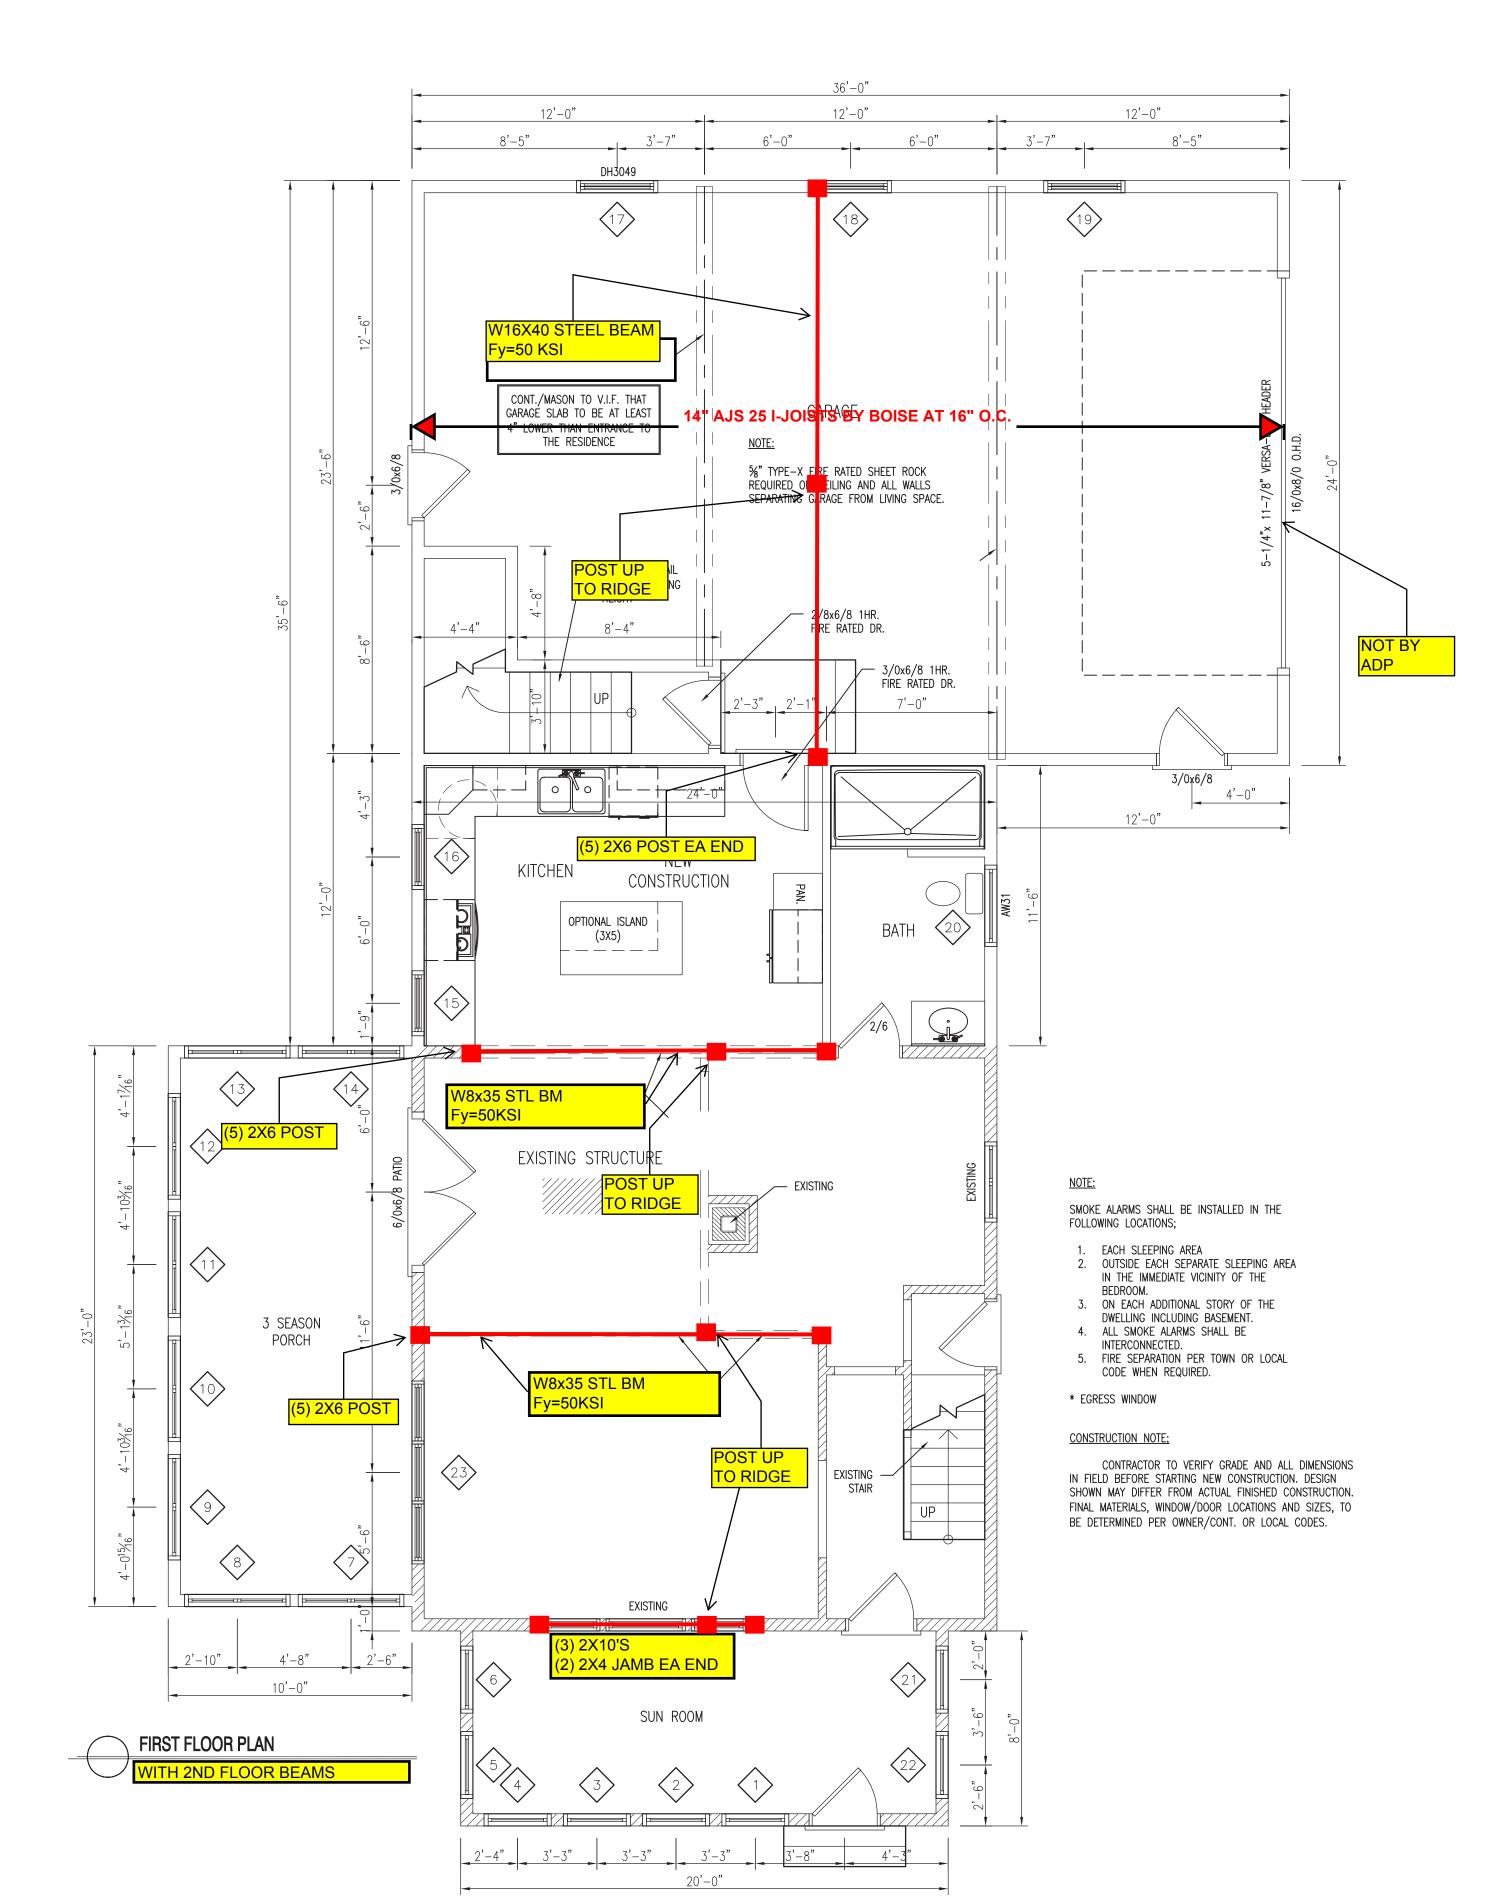


Mark	Manufacturer	Style	Size		Egroos	Hooder Size	NOTES
			Width	Height	Egress	Header Size	NOTES
1	ANDERSEN	CW15	2'-4 1⁄8"	5'-0 ¾"	N/A	(3) 2x8 w/ 1/2" Ply	
2	ANDERSEN	CW15	2'-4 %"	5'-0 3/8"	N/A	(3) 2x8 w/ 1/2" Ply	
3	ANDERSEN	CW15	2'-4 %"	5'-0 ¾"	N/A	(3) 2x8 w/ 1/2" Ply	
4	ANDERSEN	CW15	2'-4 %"	5'-0 3/8"	N/A	(3) 2x8 w/ 1/2" Ply	
5	ANDERSEN	CW15	2'-4 %"	5'-0 3/8"	N/A	(3) 2x8 w/ 1/2" Ply	
6	ANDERSEN	CW15	2'-4 %"	5'-0 ¾"	N/A	(3) 2x8 w/ 1/2" Ply	
7	ANDERSEN	CW24	4'-0 ½"	4'-0 ½"	N/A	(3) 2x8 w/ 1/2" Ply	
8	ANDERSEN	CW24	4'-0 ½"	4'-0 ½"	N/A	(3) 2x8 w/ 1/2" Ply	
9	ANDERSEN	CW24	4'-0 ½"	4'-0 ½"	N/A	(3) 2x8 w/ 1/2" Ply	
10	ANDERSEN	CW24	4'-0 ½"	4'-0 ½"	N/A	(3) 2x8 w/ 1/2" Ply	
11	ANDERSEN	CW24	4'-0 ½"	4'-0 ½"	N/A	(3) 2x8 w/ 1/2" Ply	
12	ANDERSEN	CW24	4'-0 ½"	4'-0 ½"	N/A	(3) 2x8 w/ 1/2" Ply	
13	ANDERSEN	CW24	4'-0 ½"	4'-0 ½"	N/A	(3) 2x8 w/ 1/2" Ply	
14	ANDERSEN	CW24	4'-0 ½"	4'-0 ½"	N/A	(3) 2x8 w/ 1/2" Ply	
15	ANDERSEN	244DH2430	2'-4"	3'-0"	N/A	(3) 2x8 w/ 1/2" Ply	
16	ANDERSEN	244DH2430	2'-4"	3'-0"	N/A	(3) 2x8 w/ 1/2" Ply	
17	ANDERSEN	244DH3049	3'-0"	4'-9"	N/A	(3) 2x8 w/ 1/2" Ply	
18	ANDERSEN	244DH3049	3'-0"	4'-9"	N/A	(3) 2x8 w/ 1/2" Ply	
19	ANDERSEN	244DH3049	3'-0"	4'-9"	N/A	(3) 2x8 w/ 1/2" Ply	
20	ANDERSEN	AW31	3'-0 ½"	2'-4 %"	N/A	(3) 2x8 w/ 1/2" Ply	
21	ANDERSEN	CW15	2'-4 %"	5'-0 ¾"	N/A	(3) 2x8 w/ 1/2" Ply	
22	ANDERSEN	CW15	2'-4 %"	5'-0 3/8"	N/A	(3) 2x8 w/ 1/2" Ply	
23	ANDERSEN	244DH2849	2'-8"	4'-9"	N/A	(3) 2x8 w/ 1/2" Ply	

AARON S. WILSON 70. 10429

ANDERSEN WINDOWS NFRC CERTIFIED UNIT PERFORMANCE					
ANDERSEN WINDOWS PRODUCT TYPE:		HP LOW-E: WITH GRILLS			
CASEMENT/AWNING & PICTURE WINDOW	U-FACTOR SHGC VT	0.31 0.29 0.49			
200 Series Double— Hung	U-FACTOR SHGC VT	0.45 0.54 0.56			
400 series Double— Hung	U-FACTOR SHGC VT	0.31 0.28 0.48			
TILT-WASH TRANSOM	U-FACTOR SHGC VT	0.31 0.28 0.48			
GLIDER	U-FACTOR SHGC VT	0.32 0.26 0.44			

\*ANDERSEN NRFC CERTIFIED TOTAL UNIT PERFORMANCE



Date: 05/27/17
Scale: 1/4"=1'-0"
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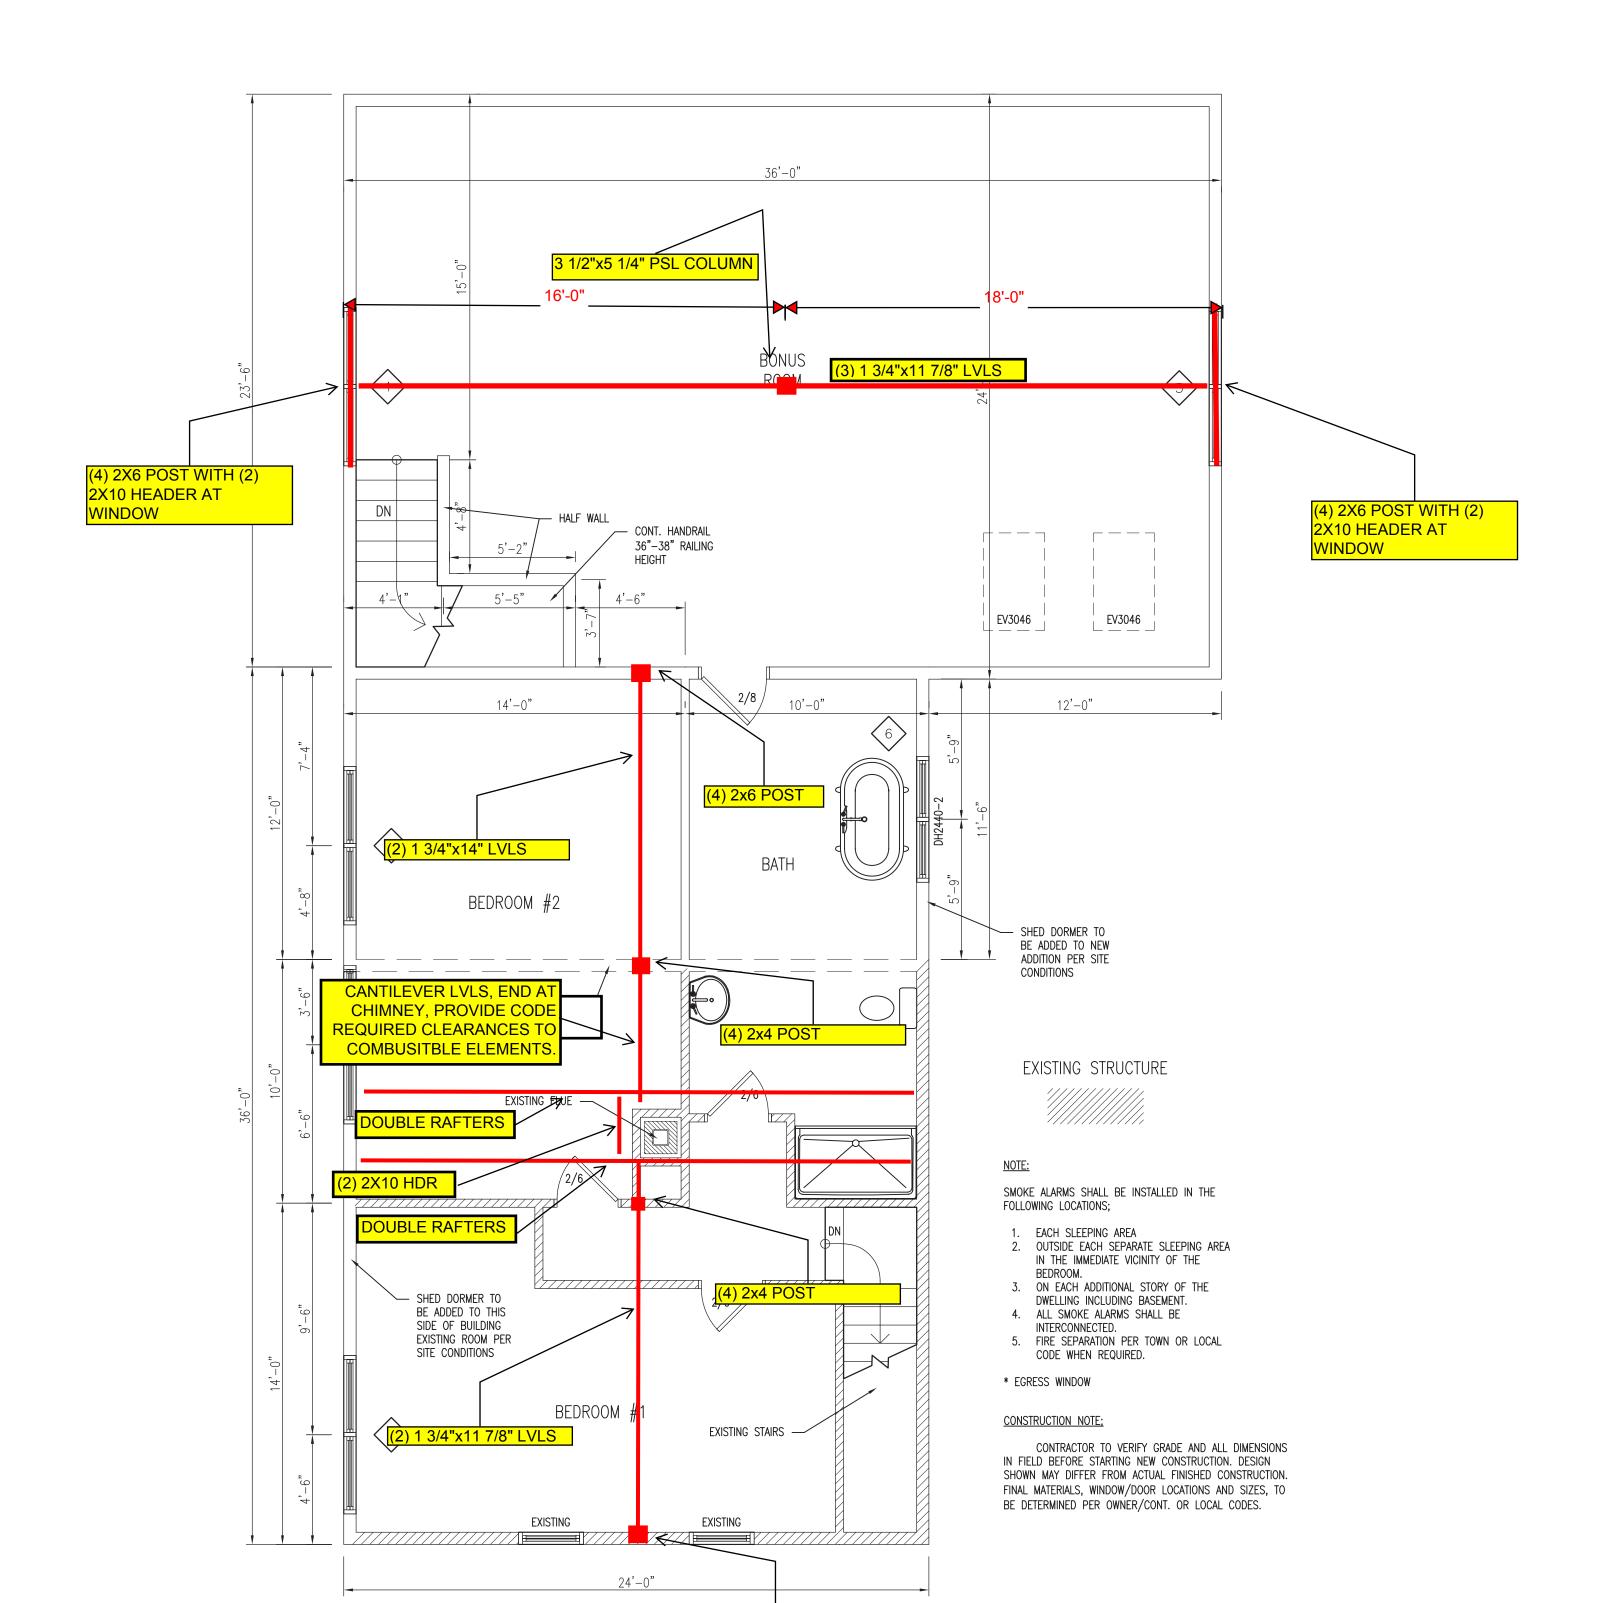
THIS P.E. REVIEW COVERES STRUCTURAL FRAMING MEMBERS SIZES FOR NEW FRAMING ELEMENTS (BEAMS AND COLUMNS ONLY) DEPICTED ON THIS PLAN ONLY. UNLESS OTHERWISE NOTED, DESIGN AND DETAIL FOR RAFTERS JOISTS, FOUNDATION WALL ELEMENTS, FRAMING CONNECTIONS, COMPONENTS AND CLADDING, FINISHES, FLOOR PLAN LAYOUT, AND LIFE BAFETY CODE REQUIREMENTS HAVE NOT BEEN REVIEWED AND ARE BEYOND THE PURVIEW OF THIS P.E. SEAL. USE OF THESE DRAWINGS INDICATES DWNER/CONTRACTOR AGREEMENT TO THESE TERMS.





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TILT-WASH TRANSOM	U-FACTOR SHGC VT	0.31 0.28 0.48
GLIDER	U-FACTOR SHGC VT	0.32 0.26 0.44

\*ANDERSEN NRFC CERTIFIED TOTAL UNIT PERFORMANCE



(4) 2x6 POST

SECOND FLOOR PLAN

WITH ROOF BEAMS