

Owner

OWNER REVIEW  
NAME \_\_\_\_\_ Date \_\_\_\_\_

\_\_\_\_\_  
\_\_\_\_\_  
\_\_\_\_\_  
\_\_\_\_\_


05.30.08 ISSUED FOR BID  
NO. DATE DESCRIPTION  
ISSUE LOG  
△ = CLOUDED CHANGE

**Banknorth**  
1410 Congress Street  
Portland ME 04102

**ROOF FRAMING PLAN**


SCALE \_\_\_\_\_ As indicated  
DRAWN BY \_\_\_\_\_ ITK  
CHECK BY \_\_\_\_\_  
PROJ. ARCH./ENGR. \_\_\_\_\_  
PROJ. MRG. \_\_\_\_\_  
JOB NO. \_\_\_\_\_ 07133.00  
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**S1.02**

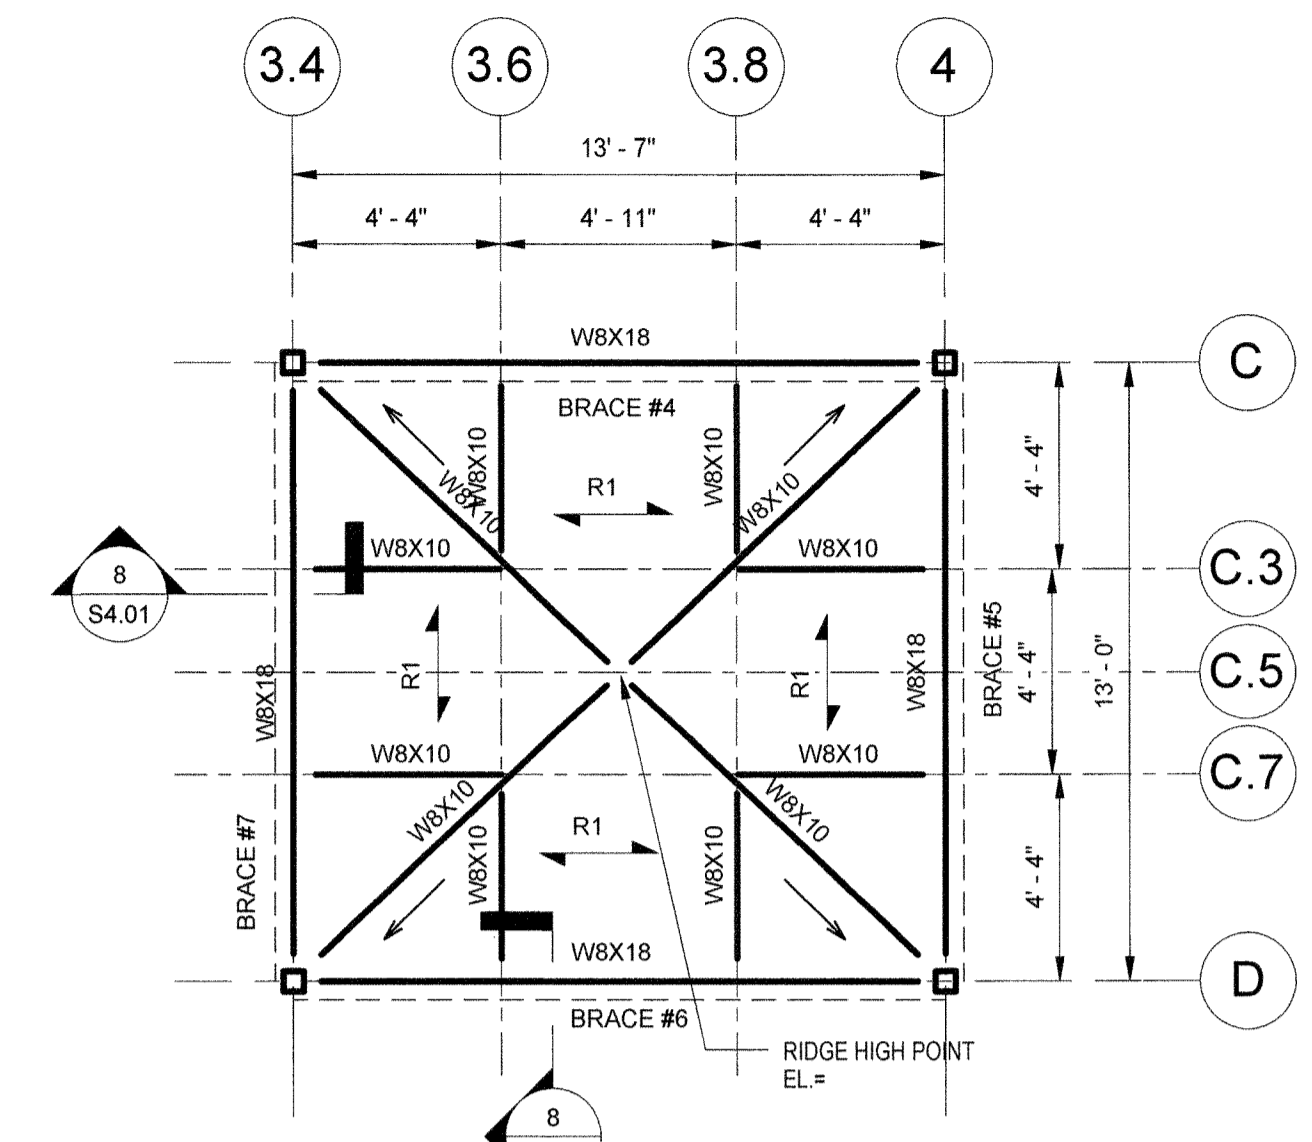


**NOTES:**  
1. TOP OF STEEL EL. = 127'-0" UNLESS OTHERWISE NOTED THUS (±0'-0").  
R1  
2. → INDICATES SPAN DIRECTION OF 1 1/2"x20 GAGE GALV. WIDE RIB METAL ROOF DECK.

② TOWER FRAMING PLAN  
1/4" = 1'-0"

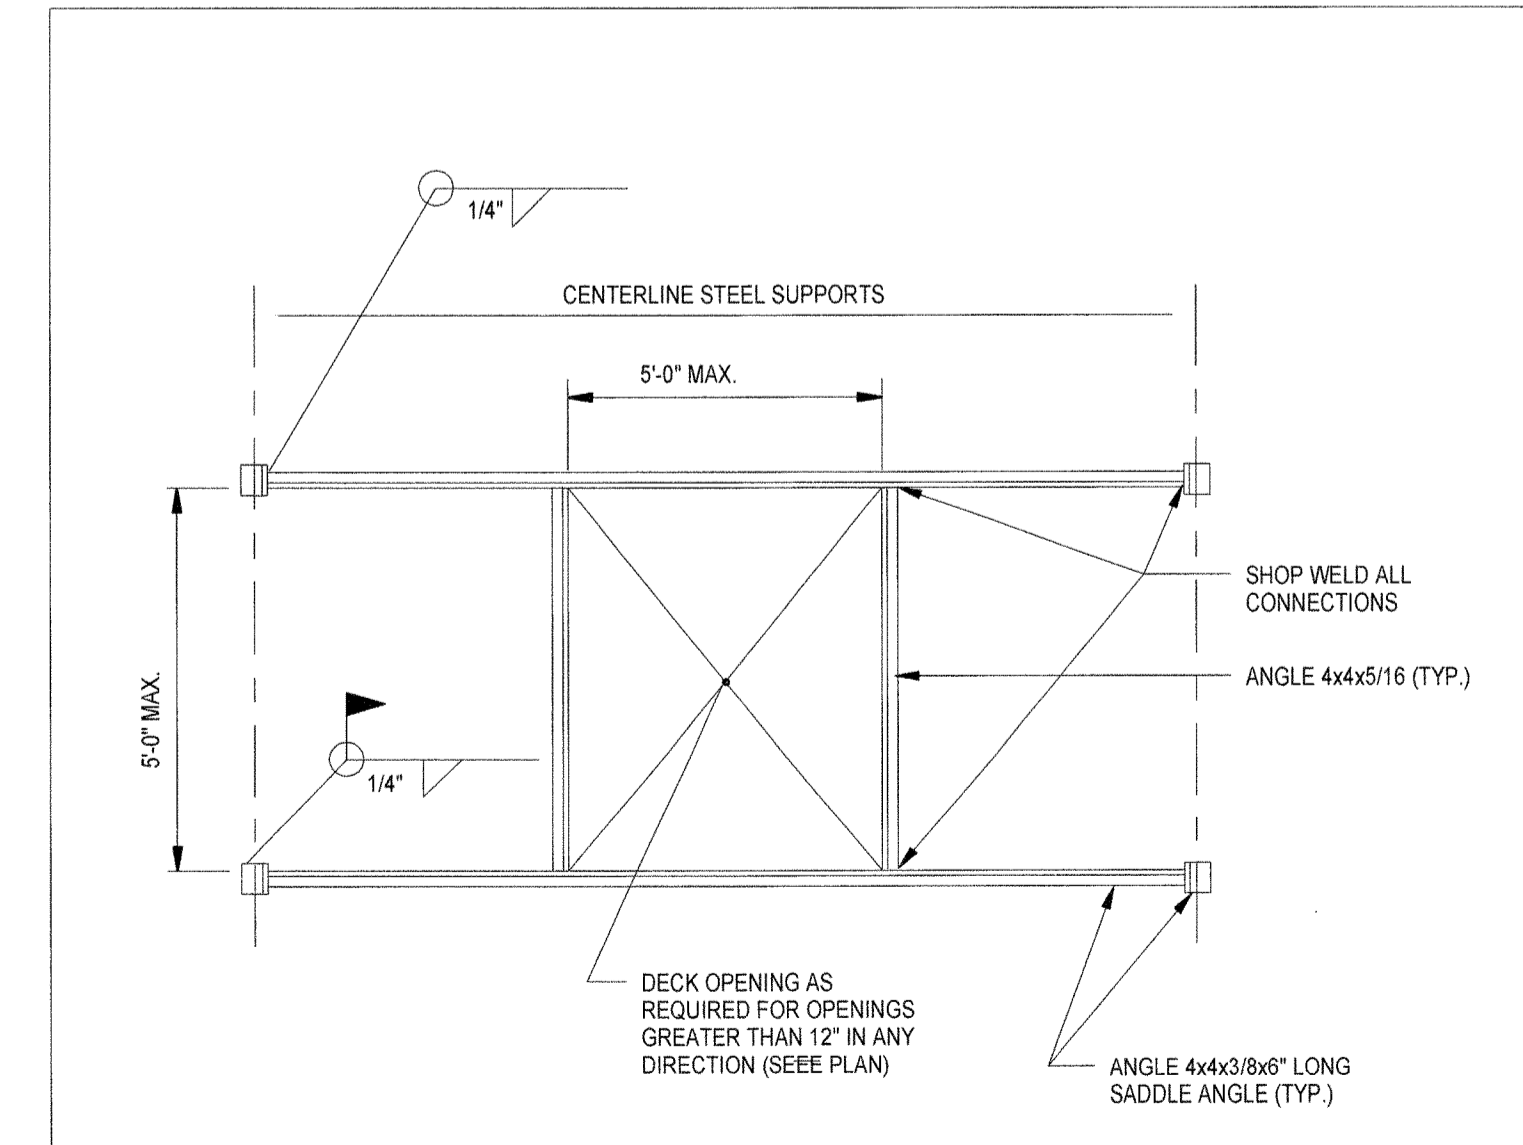

③ TYPICAL OPENING IN DECK  
3/4" = 1'-0"

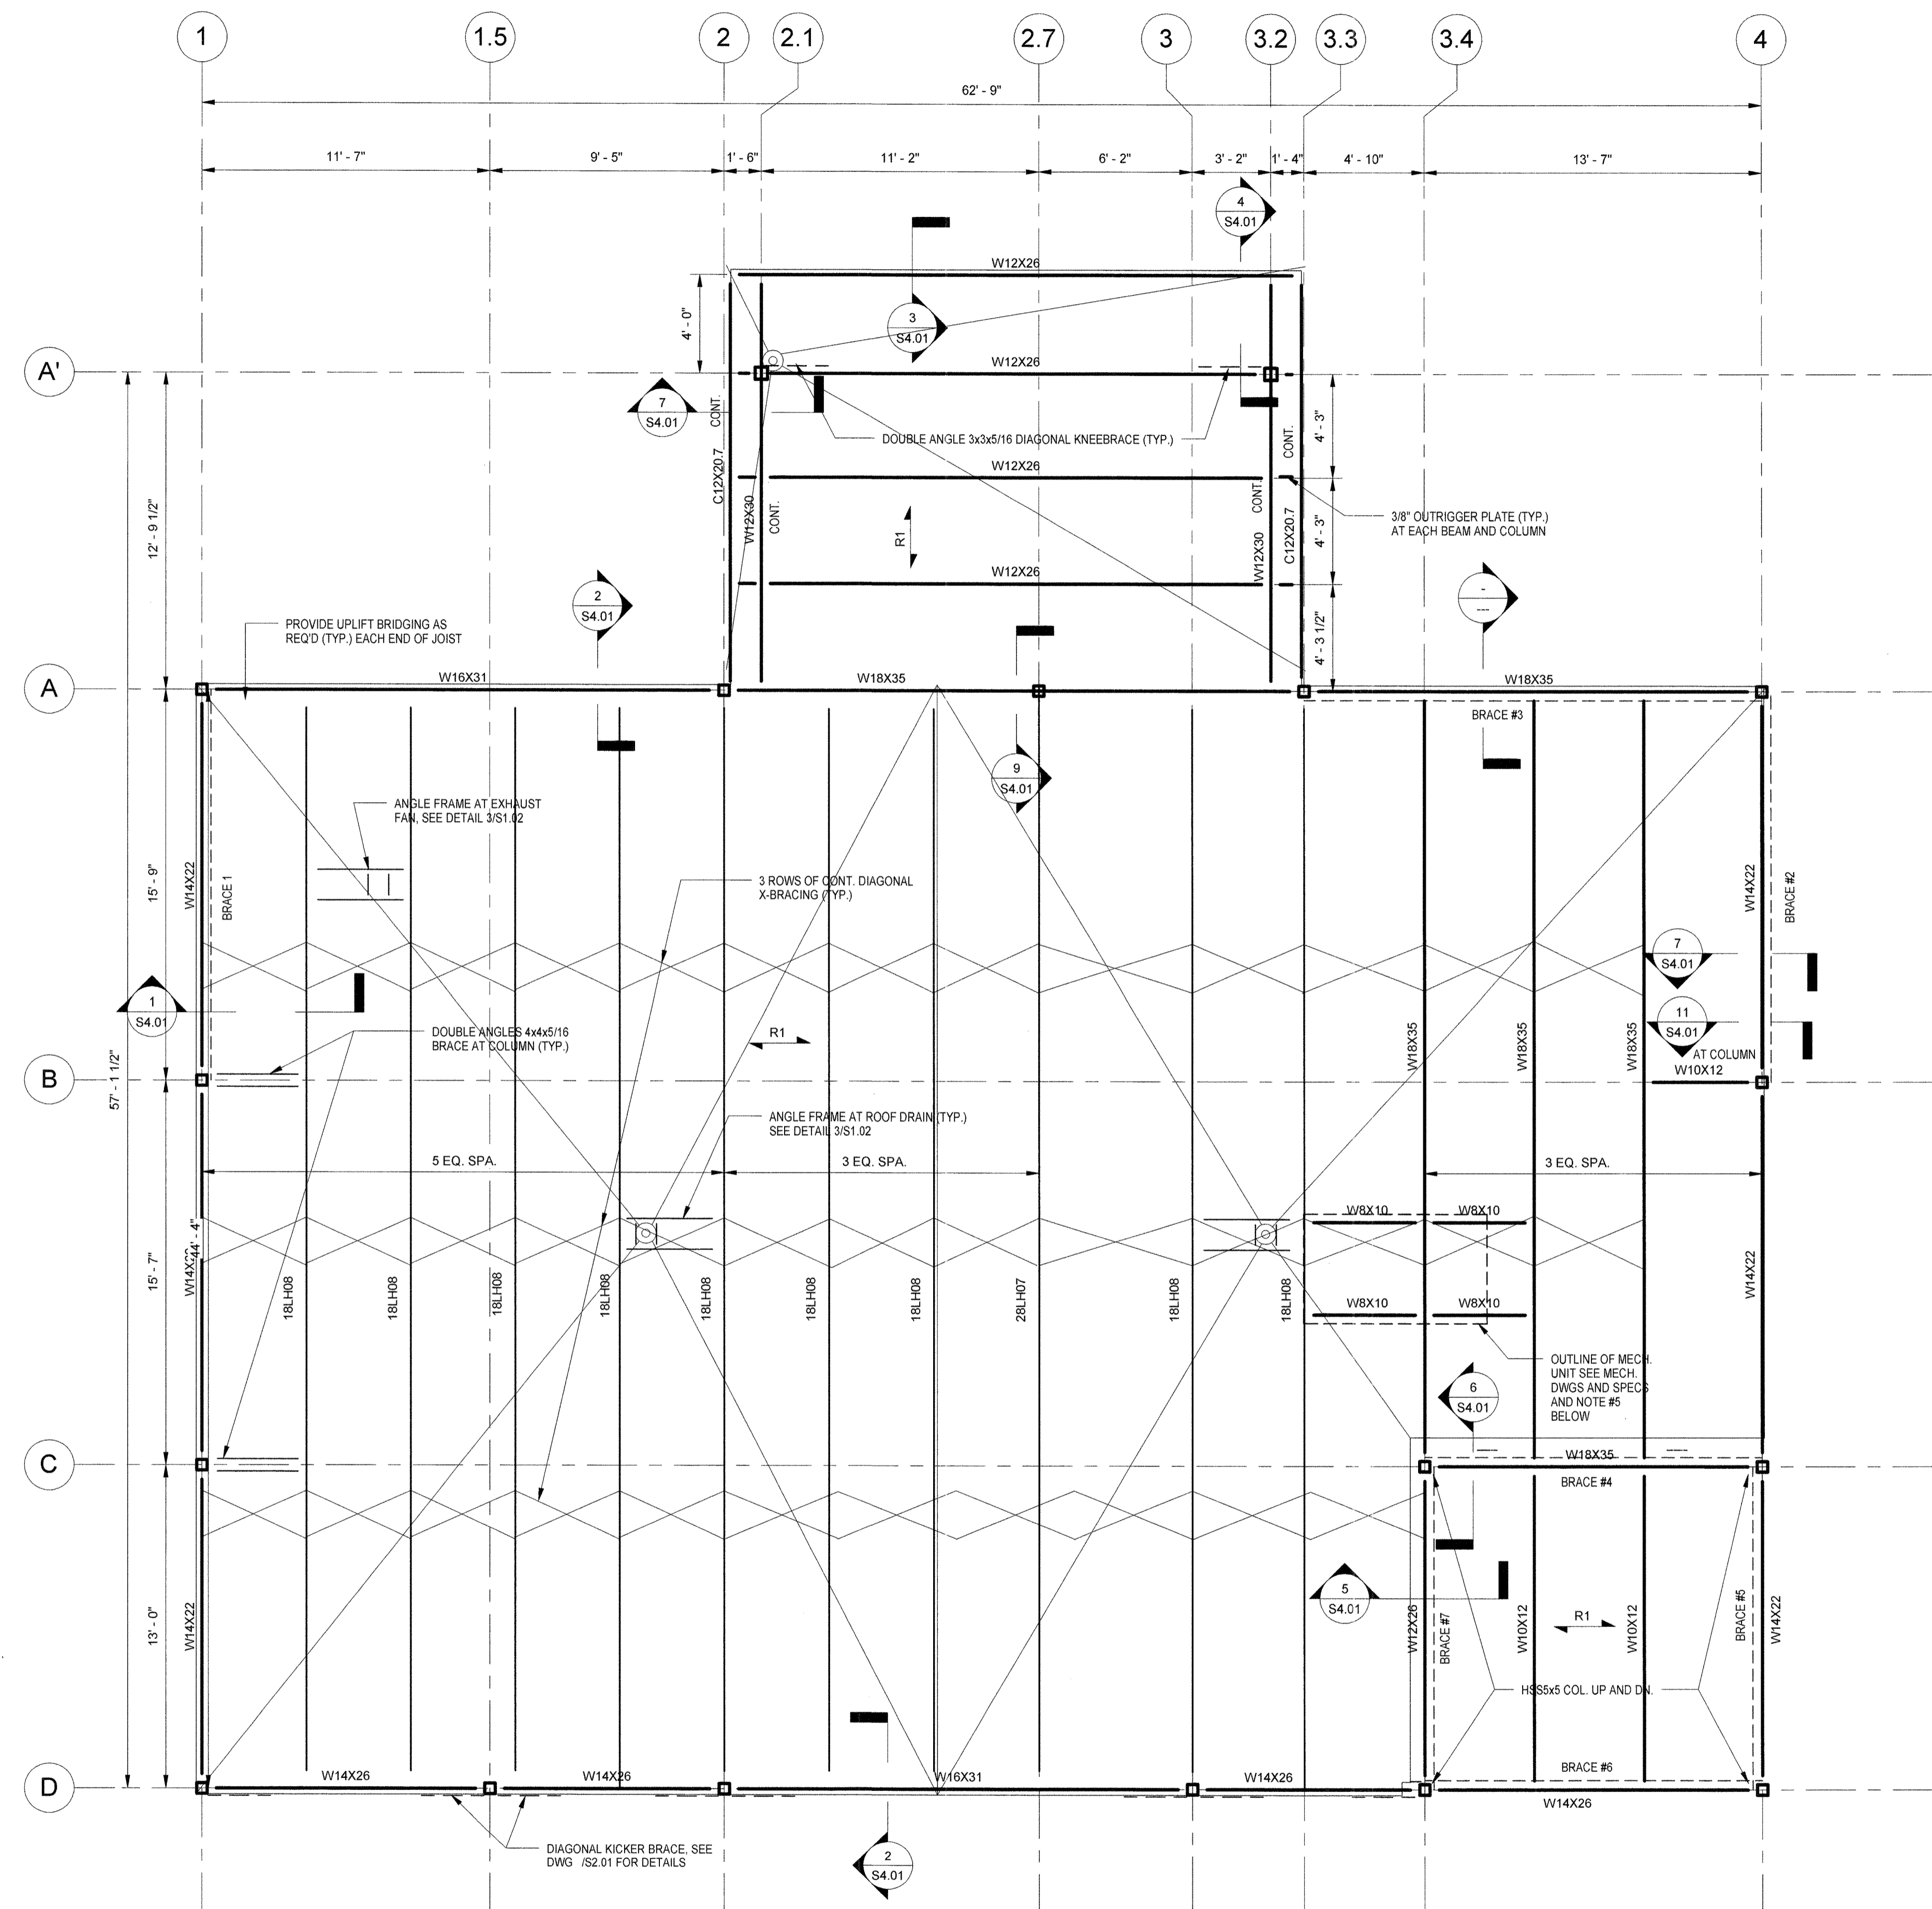

**NOTES:**  
1. TOP OF STEEL EL. = 114'-0" UNLESS OTHERWISE NOTED THUS (±0'-0").  
2. → R1 INDICATES SPAN DIRECTION OF 1 1/2"x20 GAGE WIDE RIB GALV. METAL ROOF DECK.  
3. --- INDICATES BRACED FRAME LOCATION. SEE DWG. S2.01 FOR DETAILS.  
4. ——— INDICATES FIELD WELDED MOMENT CONNECTION.  
5. THE GENERAL CONTRACTOR, MECHANICAL SUB-CONTRACTOR, AND THE STRUCTURAL STEEL FABRICATOR AND ERECTOR, SHALL COORDINATE THE SIZE AND LOCATION OF ALL ROOFTOP EQUIPMENT AND OPENINGS WITH THE MECHANICAL DRAWINGS AND THE MECHANICAL UNIT VENDOR (TYP.). THE OPENINGS SHOWN ON THE STRUCTURAL ROOF PLANS ARE SCHEMATIC ONLY AND ARE NOT INTENDED TO BE ALL INCLUSIVE WITH RESPECT TO SIZE, LOCATION AND QUANTITY. FOR THE PURPOSE OF ESTIMATING AND PRICING THE WORK INVOLVED WITH ROOF PENETRATIONS, THE QUANTITY AND SIZE OF ALL ROOFTOP PENETRATIONS SHALL BE DETERMINED FROM THE MECHANICAL AND ARCHITECTURAL DRAWINGS AND ALL ADDENDA, WORKING WITH DETAILS AND

① ROOF FRAMING PLAN  
1/4" = 1'-0"