

All code section references to be IBC unless noted otherwise

A. USE GROUP CLASSIFICATION

1. Building Use:

2 Use group (Section 304.0)

B. CONSTRUCTION CLASSIFICATION

1. Type of Construction:

a. New Construction: 5B Unprotected

The building is equipped throughout with an automatic sprinkler system

C. BUILDING DIMENSIONS AND FLOOR AREA

1. Main Floor Area 3,000 SQ FT 2. Maximumm Building Height 27'

D. <u>EGRESS REQUIREMENTS</u>

1. Occupant load:
(1004.0)

Business

Calculated

a. Maximum sq. ft. per Occupant
(Table 1004.1.2)
b. Maximum number of Occupants

30

2. Egress Width:
Egress width per occupant (table 1005.1)

EGRESS WIDTH: (for doors)

With sprinkler system

0.2 inches at stairways
0.15 inches at doors, ramps and corridors

EGRESS WIDTH: (for stairs)

Occupancy 1

Business

Total Egr. Width Occup. required

 3. Number of Exits Required:
 Occupancy Load
 Minimum No. Exit

 (Table 1018.1)
 1 - 500
 2

 501 - 1,000
 3

 More than 1,000
 4

Occupancy:

Business 2 exits required 2 exits provided

a. Maximum Length of Exit Access Travel (feet)
With sprinkler system (Table 1015.1) 300

b. Minimum Exit Separation Distance 1/2 of diagonal

4. Dead End Corridor:

Maximum Dead-End Corridor Length (1016.3) =

5. Egress Passageway:
Minimum Egress Passage/Corridor Width
(1020.2)

30

36

50 ft with sprinkler system

7. Exit Doors: (1008.1.1)
a. Door leaf
Minimum Width: 32" clear, Maximum Width: 48"
All exit doors to be a minimum of 36" wide.

b. Door shall swing in the direction of egress travel for occupant load of 50 or more.
Exit doorways to have out swinging doors.

c. Panic hardware Required for doors serving area with occupant load of 100 or more. **Exit doors to have panic hardware.**

E. FIRE PROTECTION

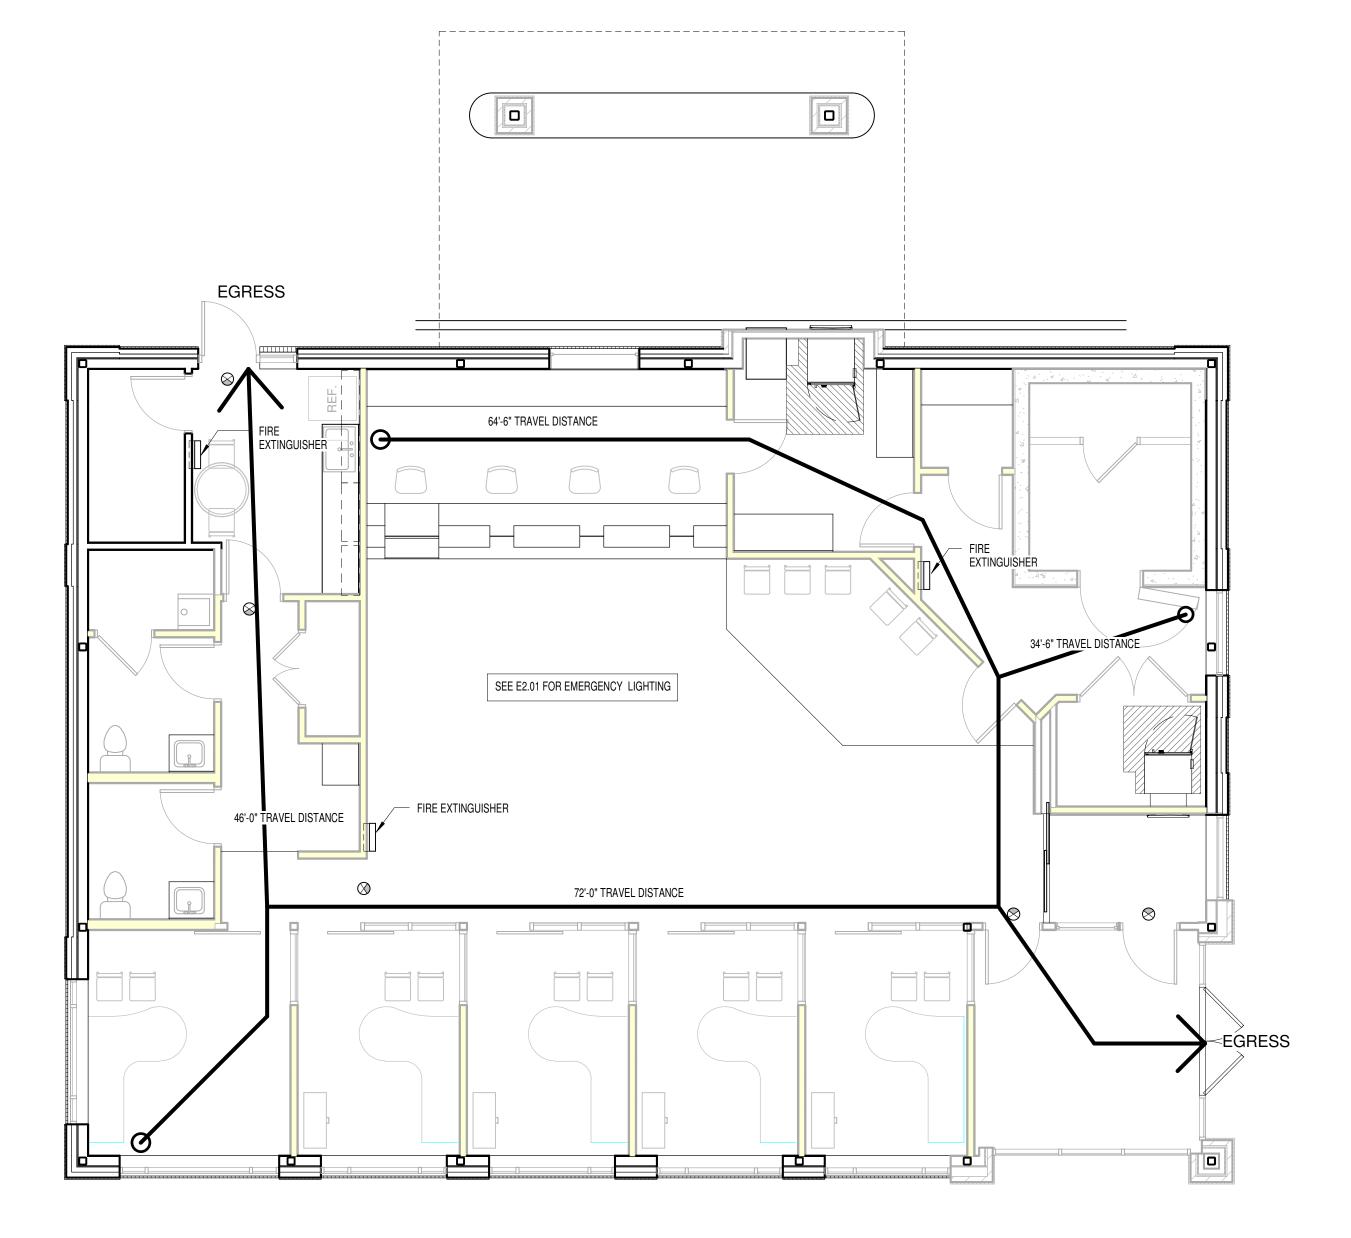
- 1. Fire Detection, Alarm, and Communication Systems (NFPA 101 9.6):
 Systems and their components shall be listed and approved for the purpose for which they are installed.
 Fire alarm system shall be installed in accordance with NFPA 70, NFPA 72 and NFPA 101)
- Portable Fire Extinguishers (NFPA 101 9.7.4):
 Portable fire extinguishers shall be provided in occupancies and locations as required by NFPA 10

 Automatic Sprinklers (NFPA 101 9.7)
 Automatic sprinkler system shall be provided and installed in accordance with NFPA 13

F. PLUMBING FIXTURES

1.	Minimum Fixtures (Table 2902.1)	Occupancy Business	_	
	Water Closets - Male	1 per	2	25
	Water Closets - Female	1 per	2	25
	Urinals (419.2)	1 per	NA	
	Lavatories	1 per	4	10
	Drinking Fountains	1 per	10	00

2. Separate facilities shall be provided for each sex (IPC 2902.2) a. Exceptions: Separate employee facilities shall not be required in occupancies in which 15 or less people are employed



 $1) \frac{\text{LIFE SAFETY PLAN}}{3/16" = 1'-0"}$



1000 Massachusetts Avenue Cambridge, Massachusetts 02138 617.547.5400 Fax 617.354.5758

OWNER REVIEW	
NAME	Date

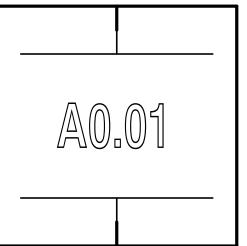
	5/30/08	ISSUE FOR BID				
O.	DATE	DESCRIPTION				
SUE LO	G					
= CLOUDED CHANGE						
Banknorth						

1410 Congress Street Portland, ME 04101

CODE SUMMARY & LIFE SAFETY PLAN

SCALE	3/16" = 1
DRAWN BY	
CHECK BY	
PROJ.ARCH./ENGR.	
PROJ. MRG.	P
JOB NO.	07133.

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