


PROPOSED GENERATOR CHAIN LINK FENCE PLAN

SCALE: N.T.S.


1
EC-2

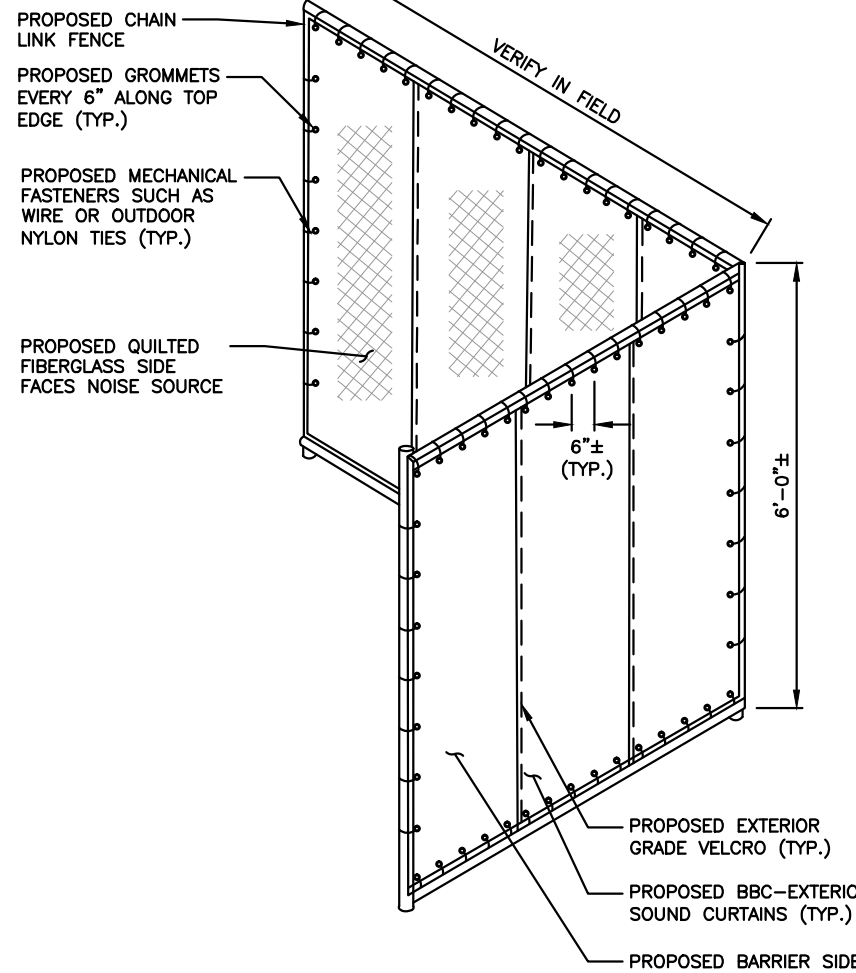

ACOUSTIC FENCE NOISE BARRIER ISOMETRIC DETAIL

SCALE: N.T.S.


2
EC-2

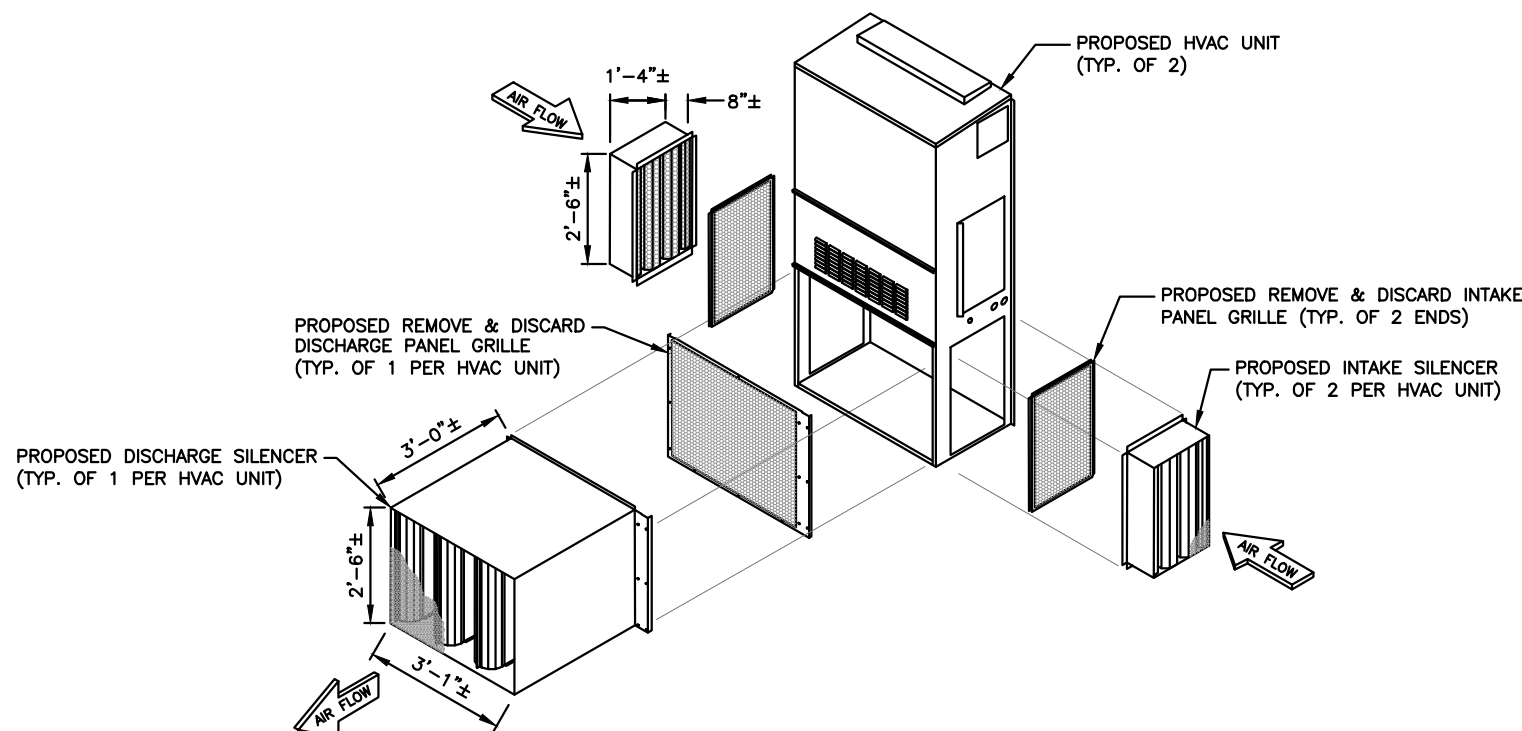

AEROACOUSTIC HVAC NOISE BARRIER ISOMETRIC DETAIL

SCALE: N.T.S.

3
EC-2

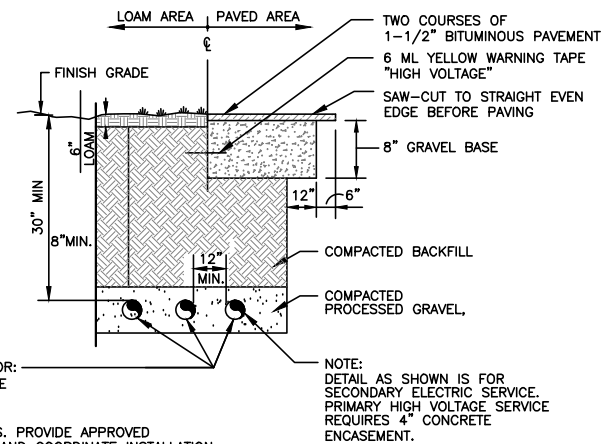

(3) 4" SCH. 40 CONDUIT FOR:
 (1) NEW ELECTRICAL SERVICE
 (1) TELEPHONE SERVICE
 (1) NEW FIBER RUN
 SEE UTILITY AND SITE PLANS. PROVIDE APPROVED PULL BOXES AS REQUIRED, AND COORDINATE INSTALLATION W/ ALL UTILITY COMPANIES FOR INTERFACING AT TERMINATION POINTS. PROVIDE FULL LENGTH PULL ROPES (TYP.)

NOTE:
 DETAIL AS SHOWN IS FOR SECONDARY ELECTRIC SERVICE. PRIMARY HIGH VOLTAGE SERVICE REQUIRES 4" CONCRETE ENCASEMENT.

BURIED CONDUIT DETAIL

SCALE: N.T.S.


4
EC-2



482 CONGRESS STREET, SUITE 100
 PORTLAND, ME 04101



1600 OSGOOD STREET
 BLD 20 N, SUITE 3090
 N. ANDOVER, MA 01845
 TEL: (978)-557-5553
 FAX: (978)-336-5586

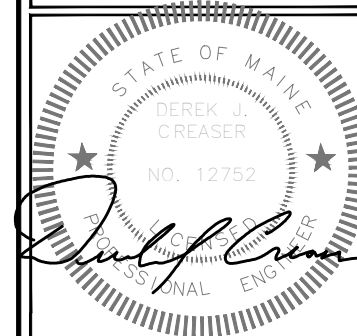

LICENSED ENGINEER DATE

REVISIONS

REV. #	DATE	DESCRIPTION
1	04/04/16	ISSUED FOR PERMITTING
0	03/02/16	ISSUED FOR REVIEW

PROJECT NO.	DESIGNED BY: RP	SCALE:
	DRAWN BY: VP	AS SHOWN
	CHECKED BY: DPH	

SITE NAME:
**MFC
 PORTLAND**

SITE ADDRESS:
 9 WESTLAND AVENUE
 PORTLAND, ME 04101

SHEET TITLE:
**SOUND ATTENUATION
 DETAILS**

SHEET NO:
EC-2