


68 CARIBOU STREET, PORTLAND, MAINE ASSESSOR'S MAP 196, BLOCK B, PARCELS 10-12 & ASSESSOR'S MAP 197, BLOCK F, PARCELS 12-14 PLAN BOOK 14, PAGE 61, LOTS 64-69 DEED BOOK 22420, PAGE 256 (CUMBERLAND COUNTY REGISTRY OF DEEDS)

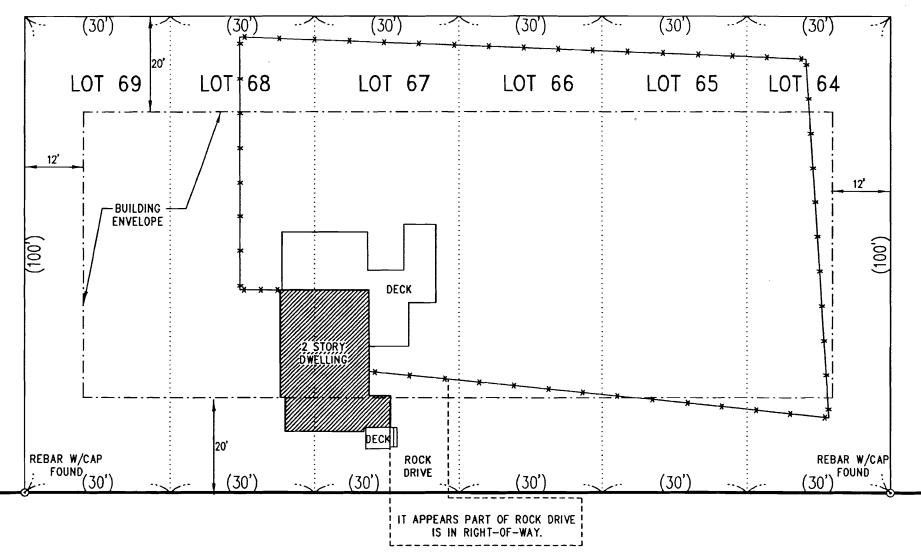

CARIBOU

STREET

### ZONE\_R-5 REQUIREMENTS:

FRONT SETBACK: SIDE SETBACK: 12' REAR SETBACK: 20'

THIS IS NOT A BOUNDARY SURVEY. BOUNDARY LINES ARE APPROXIMATE. DWELLING LOCATION IS BASED ON EXISTING MONUMENTATION. THIS PLAN EXCEPTS CHAPTER 90, PART 2, SECTION 4 THROUGH 8 OF THE MAINE BOARD OF LICENSURE FOR PROFESSIONAL LAND SURVEYORS' RULES.

## EXISTING CONDITION PLAN OF LAND

# **PORTLAND** MAINE

SCALE: 1"=20'

SEPTEMBER 14, 2006

PREPARED FOR: CUSTOM CONCEPTS

636 U.S. ROUTE 1, BOX 6 SCARBOROUGH, MAINE 04074


JOB NUMBER: 29409


ACAD FILE: 29409.DWG




153 US ROUTE 1, SCARBOROUGH, MAINE 04074 tel: (207) 883-1000 or (800) 882-2227 fax: (207) 8831001


e-mail: info@northeastcivilsolutions.com

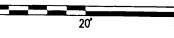


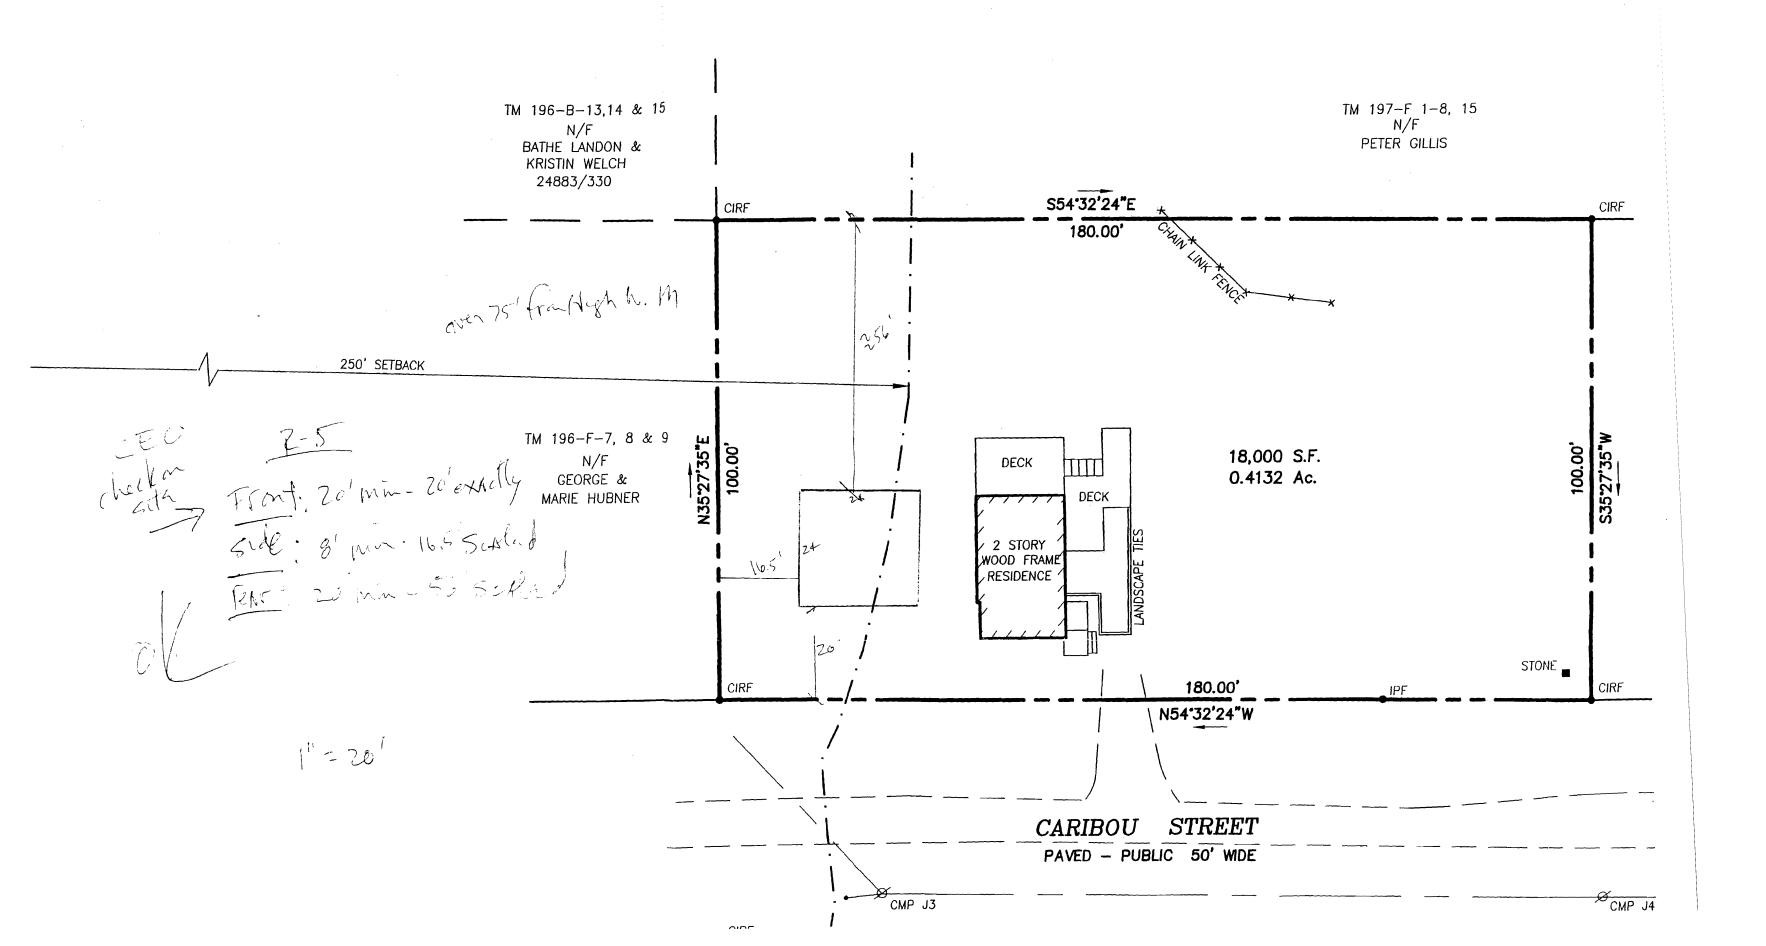

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#### GARAGE NOTES:

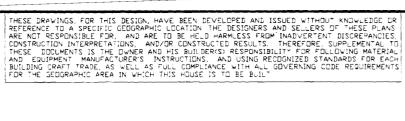- UNINSULATED GARAGE WALLS ARE 2X4 STUDS @ 6' O.C. UNLESS OTHERWISE INDICATED
- FLOOR 4" CONC SLAB ON GRADE TO SLOPE DOWN TO OVER HEAD DOORS
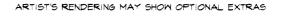
#### FOR ATTACHED GARAGES-

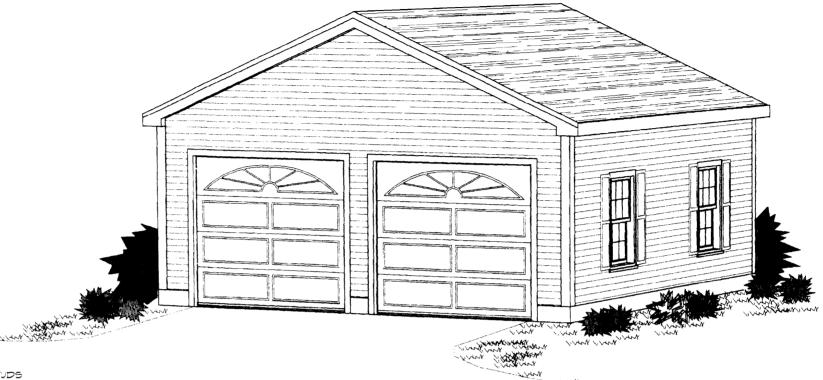-INSULATE WALL ADJACENT TO HOUSE APPLY FIRE-RATED GYP BD ON GARAGE SIDE -CEILINGS FINISHED W/FIRE RATED GYP BD -DOOR'S) BETWEEN GARAGE AND LIVING SPACE TO BE B-LABEL METAL CLAD


### 2 BAY GARAGE~GABLE END DOORS PLAN NO. G2-241-A

#### CONSTRUCTION NOTES AND DESIGN DATA

#### CONCRETE AND FOUNDATIONS:

- ALL SLABS ON GRADE SHALL BE 3000 PS! (28-COMPRESSIVE STRENGTH CONCRETE.) UNLESS NOTED OTHERWISE.
- ADD REINFORCING MESH AND REBAR WHEN SETTLING OR EARTHQUAKE HAZARD
- 5 A PROBLEM OR WHERE REQUIRED BY LOCAL CODE

   ALL SLABS ON GRADE SHALL BEAR ON COMPACTED FILL OR GRAVEL.
  PROVIDE PROPER EXPANSION AND CONTROL JOINTS PER LOCAL REQUIREMENTS. - FOUNDATION 1/2" ANCHOR BOLTS 6' O.C. EMBEDDED IN CONC MALL
- TO BE CONNECTED TO PRESSURE TREATED SILL AND SILL SEALER PLATE DO NOT BACK FILL FOUNDATION WALLS UNTI
- ROOF STRUCTURE IS IN PLACE.
- DEPTH OF FOOTINGS TO BE 4'-0" (MIN.) BELOW GRADE."

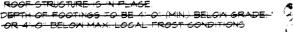

#### MISC. NOTES

- ALL MATERIALS, SUPPLIES, AND EQUIPMENT TO BE INSTALLED AS PER
- MANUFACTURER SPECIFICATIONS AND AS PER LOCAL CODES AND REQUIREMENTS. - 1/2" MOISTURE RESISTANT GYP BOARD AROUND SHOWERS, TUBS AND WHIRLPOOLS
- 1/2" GYP BOARD ON INTERIOR WALLS AND CEILINGS.
- WHEN GARAGES ARE ATTACHED TO LIVING SPACES-APPLY 5/8" TYPE "X" FIRE CODE SYP BOARD ON GARAGE MALLS AND CEILINGS - WINDOWS ARE CALLED OUT BY GLASS SIZE AND SYMBOL.
- AND ASSUMED TO BE HURD UNLESS OTHERWISE DESIGNATED

#### FRAMING:

- ALL EXTER OR MALL DIMENSIONS TO OUTSIDE OF WALL STUD.
   ALL INTERIOR WALL DIMENSIONS FROM CENTERLINE TO CENTERLINE OF WALL.
   CALCULATED DIMENSIONS TAKE PRECEDENCE OVER SCALED DIMENSIONS.
- ALL ANGLED MALLS ON FLOOR PLANS ARE AT 45 DEGREE ANGLE UNLESS
- NOTED OTHERWISE. - ALL EXTERIOR OPENINGS USE 2/2X8 FRAMING LUMBER UNLESS NOTED OTHERWISE.
- NLESS NOTED CTHERN SE, ALL FRAMING LUMBER TO BE HEM-FIR #2 OR BETTER I ROW OF SOLID BLOCKING OR ACCEPTABLE CROSS BRIDGING ON ALL
- SPANS OVER 8 -0' AND 2 ROWS ON ALL SPANS OVER 16-0"
- WIND BRACING TO BE INSTALLED ON ALL EXTERIOR WALLS IN LOCALES SUBJECTED TO HIGH WINDS OR WHEN REQUIRED BY CODE~ BRACING AS CLOSE TO 45 DEGREES AS POSSIBLE. - DOUBLE BOX JOINTS INSTALLED OVER BULKHEAD(S) AND MINDOW OPENINGS.
- SUB FLOOR TO BE GLUED AND NAILED TO FLOOR JOISTS WITH CEMENT COATED RING NAILS (OR EQUIVALENT)
- TYVEK OR ROSIN PAPER AND CHALKING APPLIED BEFORE WINDOWS AND DOORS ARE NSTALLED.
- ALL WALLS ARE 8'-0" HIGH UNLESS NOTED OTHERWISE.
- ALL TRUSSES (IF USED) TO BE ENGINEERED BY TRUSS MANUFACTURER ACCORDING TO THE LOADING REFLECTED ON THIS PLAN AND BY LOCAL CODES AND CONDITIONS.
- COLLAR TIES TO BE SPACED 4"-0" O.C. ANY HIP OR VALLEY RAFTER OVER A 28"-0" SPAN ARE TO BE LAMINATED VENEER LUMBER (L.V.L.)
- ALL PURLING AND KICKERS TO BE 2X6 UNLESS NOTED OTHERWISE.

MECH. MECHANICAL

TOW TOP OF WALL

ON CENTER

TELEPHONE

PRESSURE TREATED

OPNG OPENING

TEL

GARAGE ABBR. DESCRIPTION ABOVE FINISHED FLOOR BEAM COL COLUMN CENTER LINE CONC CONCRETE BAYDRAIN PROJECT

2 BA

SHEET NAME

COVE DN DOWN EAST FIN FINISH(ED) FIREPLACE HDR HEADER ISTS JOISTS

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ADSmith

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