


PROJECT


MARINO RESIDENCE

PORTLAND, MAINE

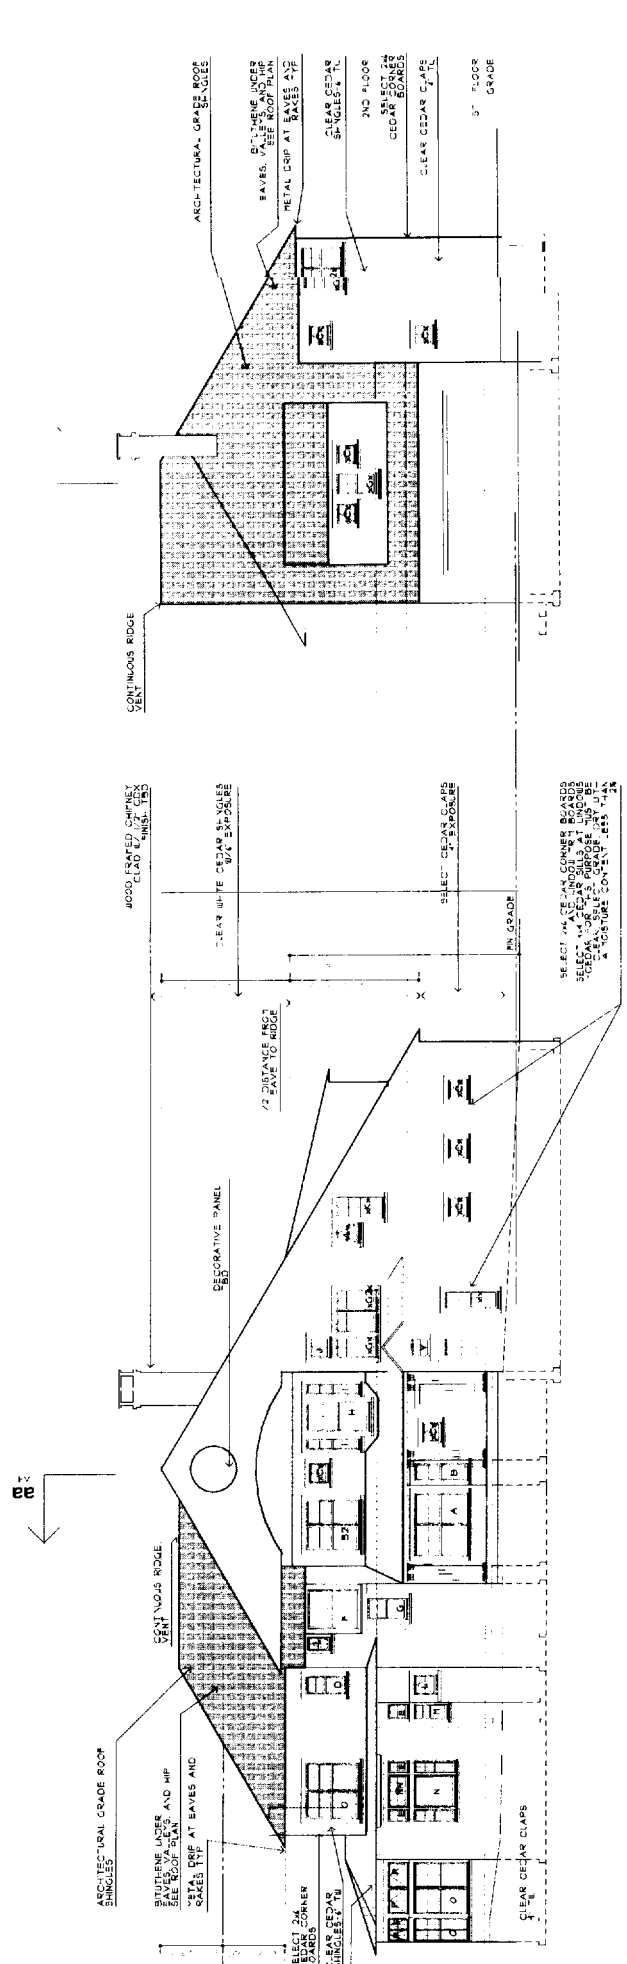

FRONT ELEVATION

RIGHT SIDE ELEVATION

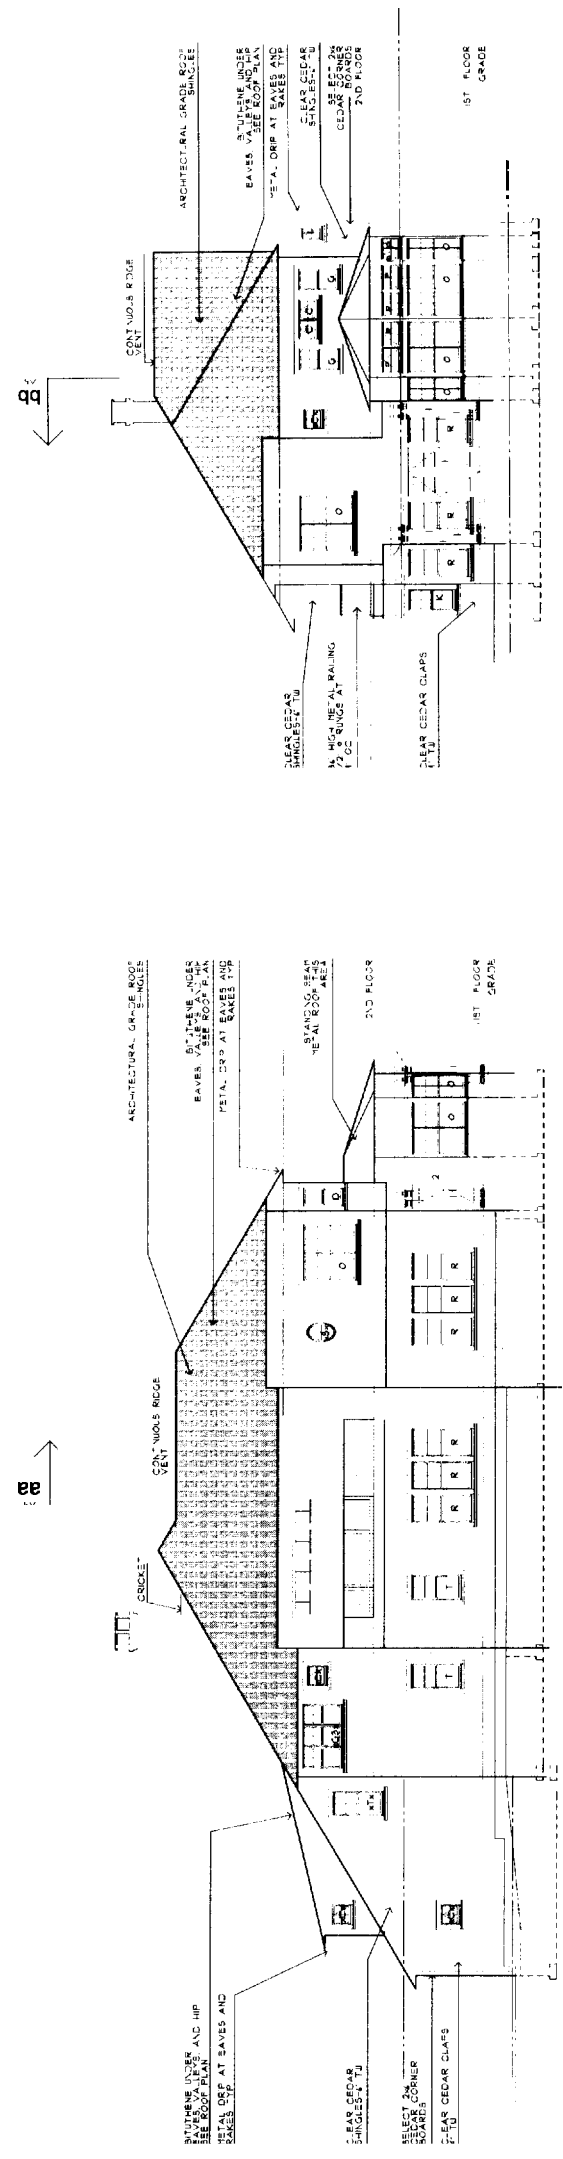

REAR ELEVATION

LEFT ELEVATION

GTA 2 ARCHITECTS
 44 OAK STREET
 PORTLAND, MAINE 04107
 207-777-5441 | 877-774-0846


DATE
 05/05
 MAY 2005

ELEVATIONS


SCALE
 AS NOTED
 DRAWN BY
 SMT

PROJECT NUMBER
 02208


SHEET NUMBER
A 3

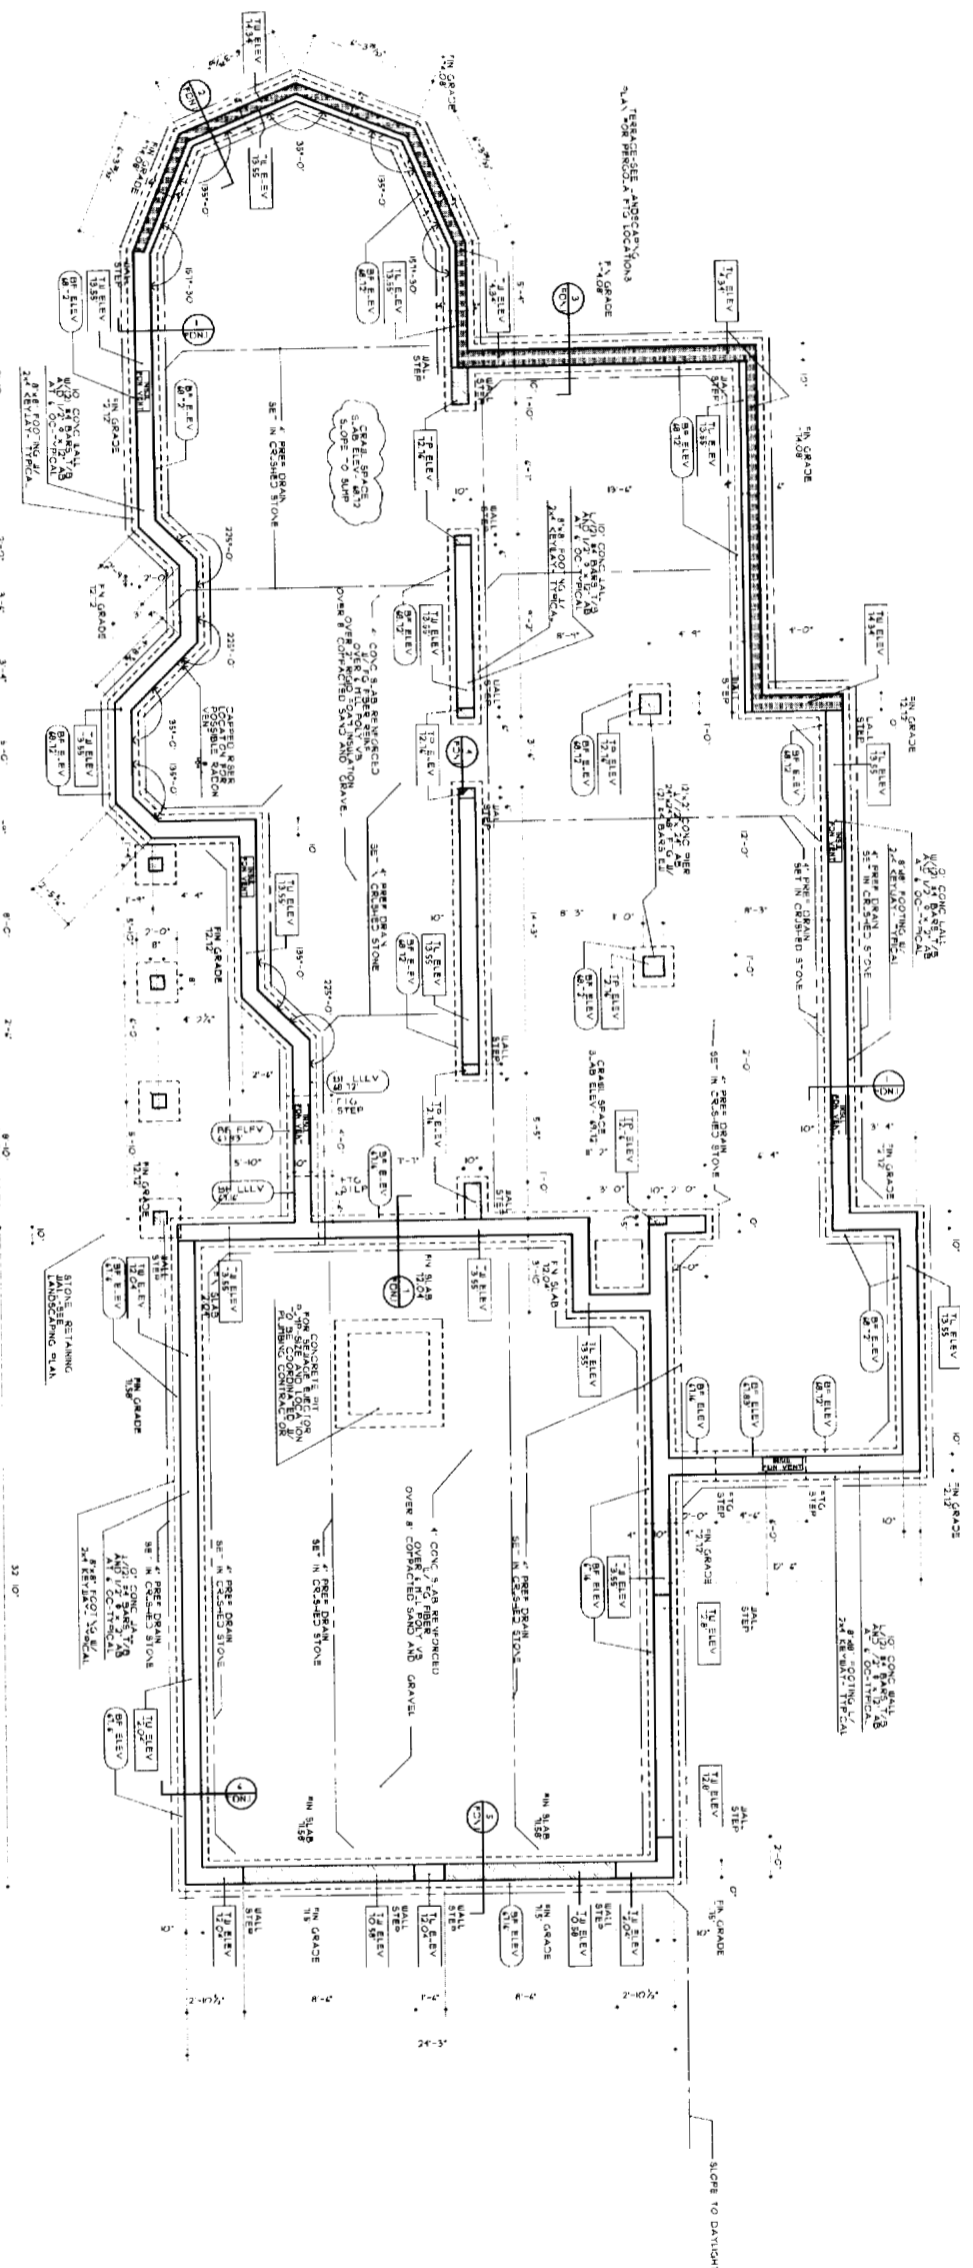


SCALE: 1/4"=1'-0"

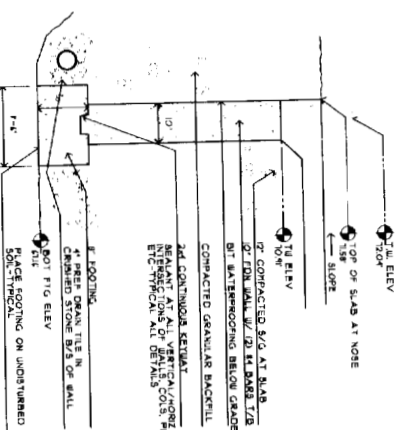


5 FOUNDATION WALL DETAIL
 FDN/ SCALE 3/4"=1'-0"

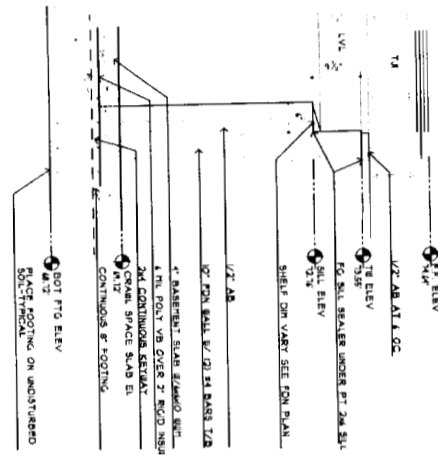


4 FOUNDATION WALL DETAIL
 FDN/ SCALE 3/4"=1'-0"

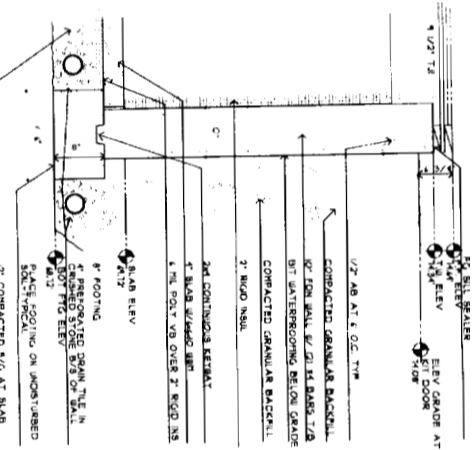

3 FOUNDATION WALL DETAIL
 FDN/ SCALE 3/4"=1'-0"

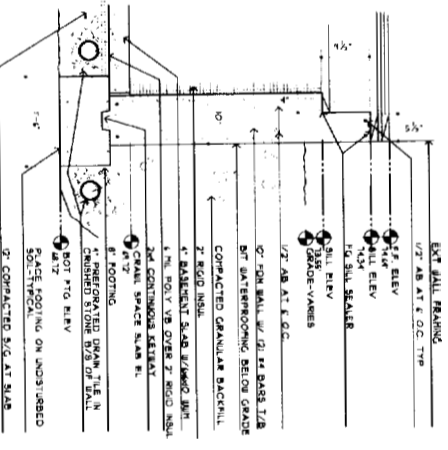

2 FOUNDATION WALL DETAIL
 FDN/ SCALE 3/4"=1'-0"

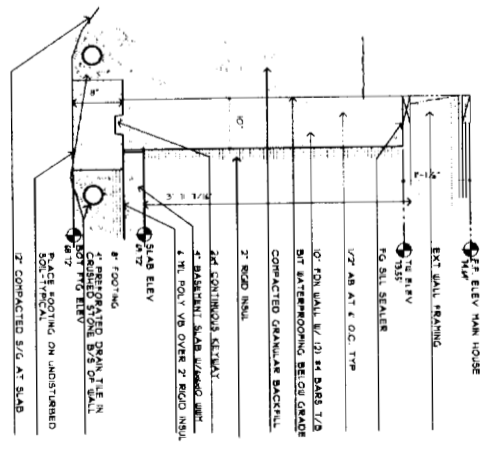

1 FOUNDATION WALL DETAIL
 FDN/ SCALE 3/4"=1'-0"

DATE		MAY 2015
DRAWN BY		SMT
PROJECT NUMBER		0208
AS NOTED		
FOUNDED		
DATE		
DRAWN BY		
PROJECT NUMBER		
FOUNDED		

DATE: MAY 2015
 DRAWN BY: SMT
 PROJECT NUMBER: 0208




MARINO RESIDENCE

PORTLAND, MAINE

DATE: 8-29-05

SITE PLAN

C-1

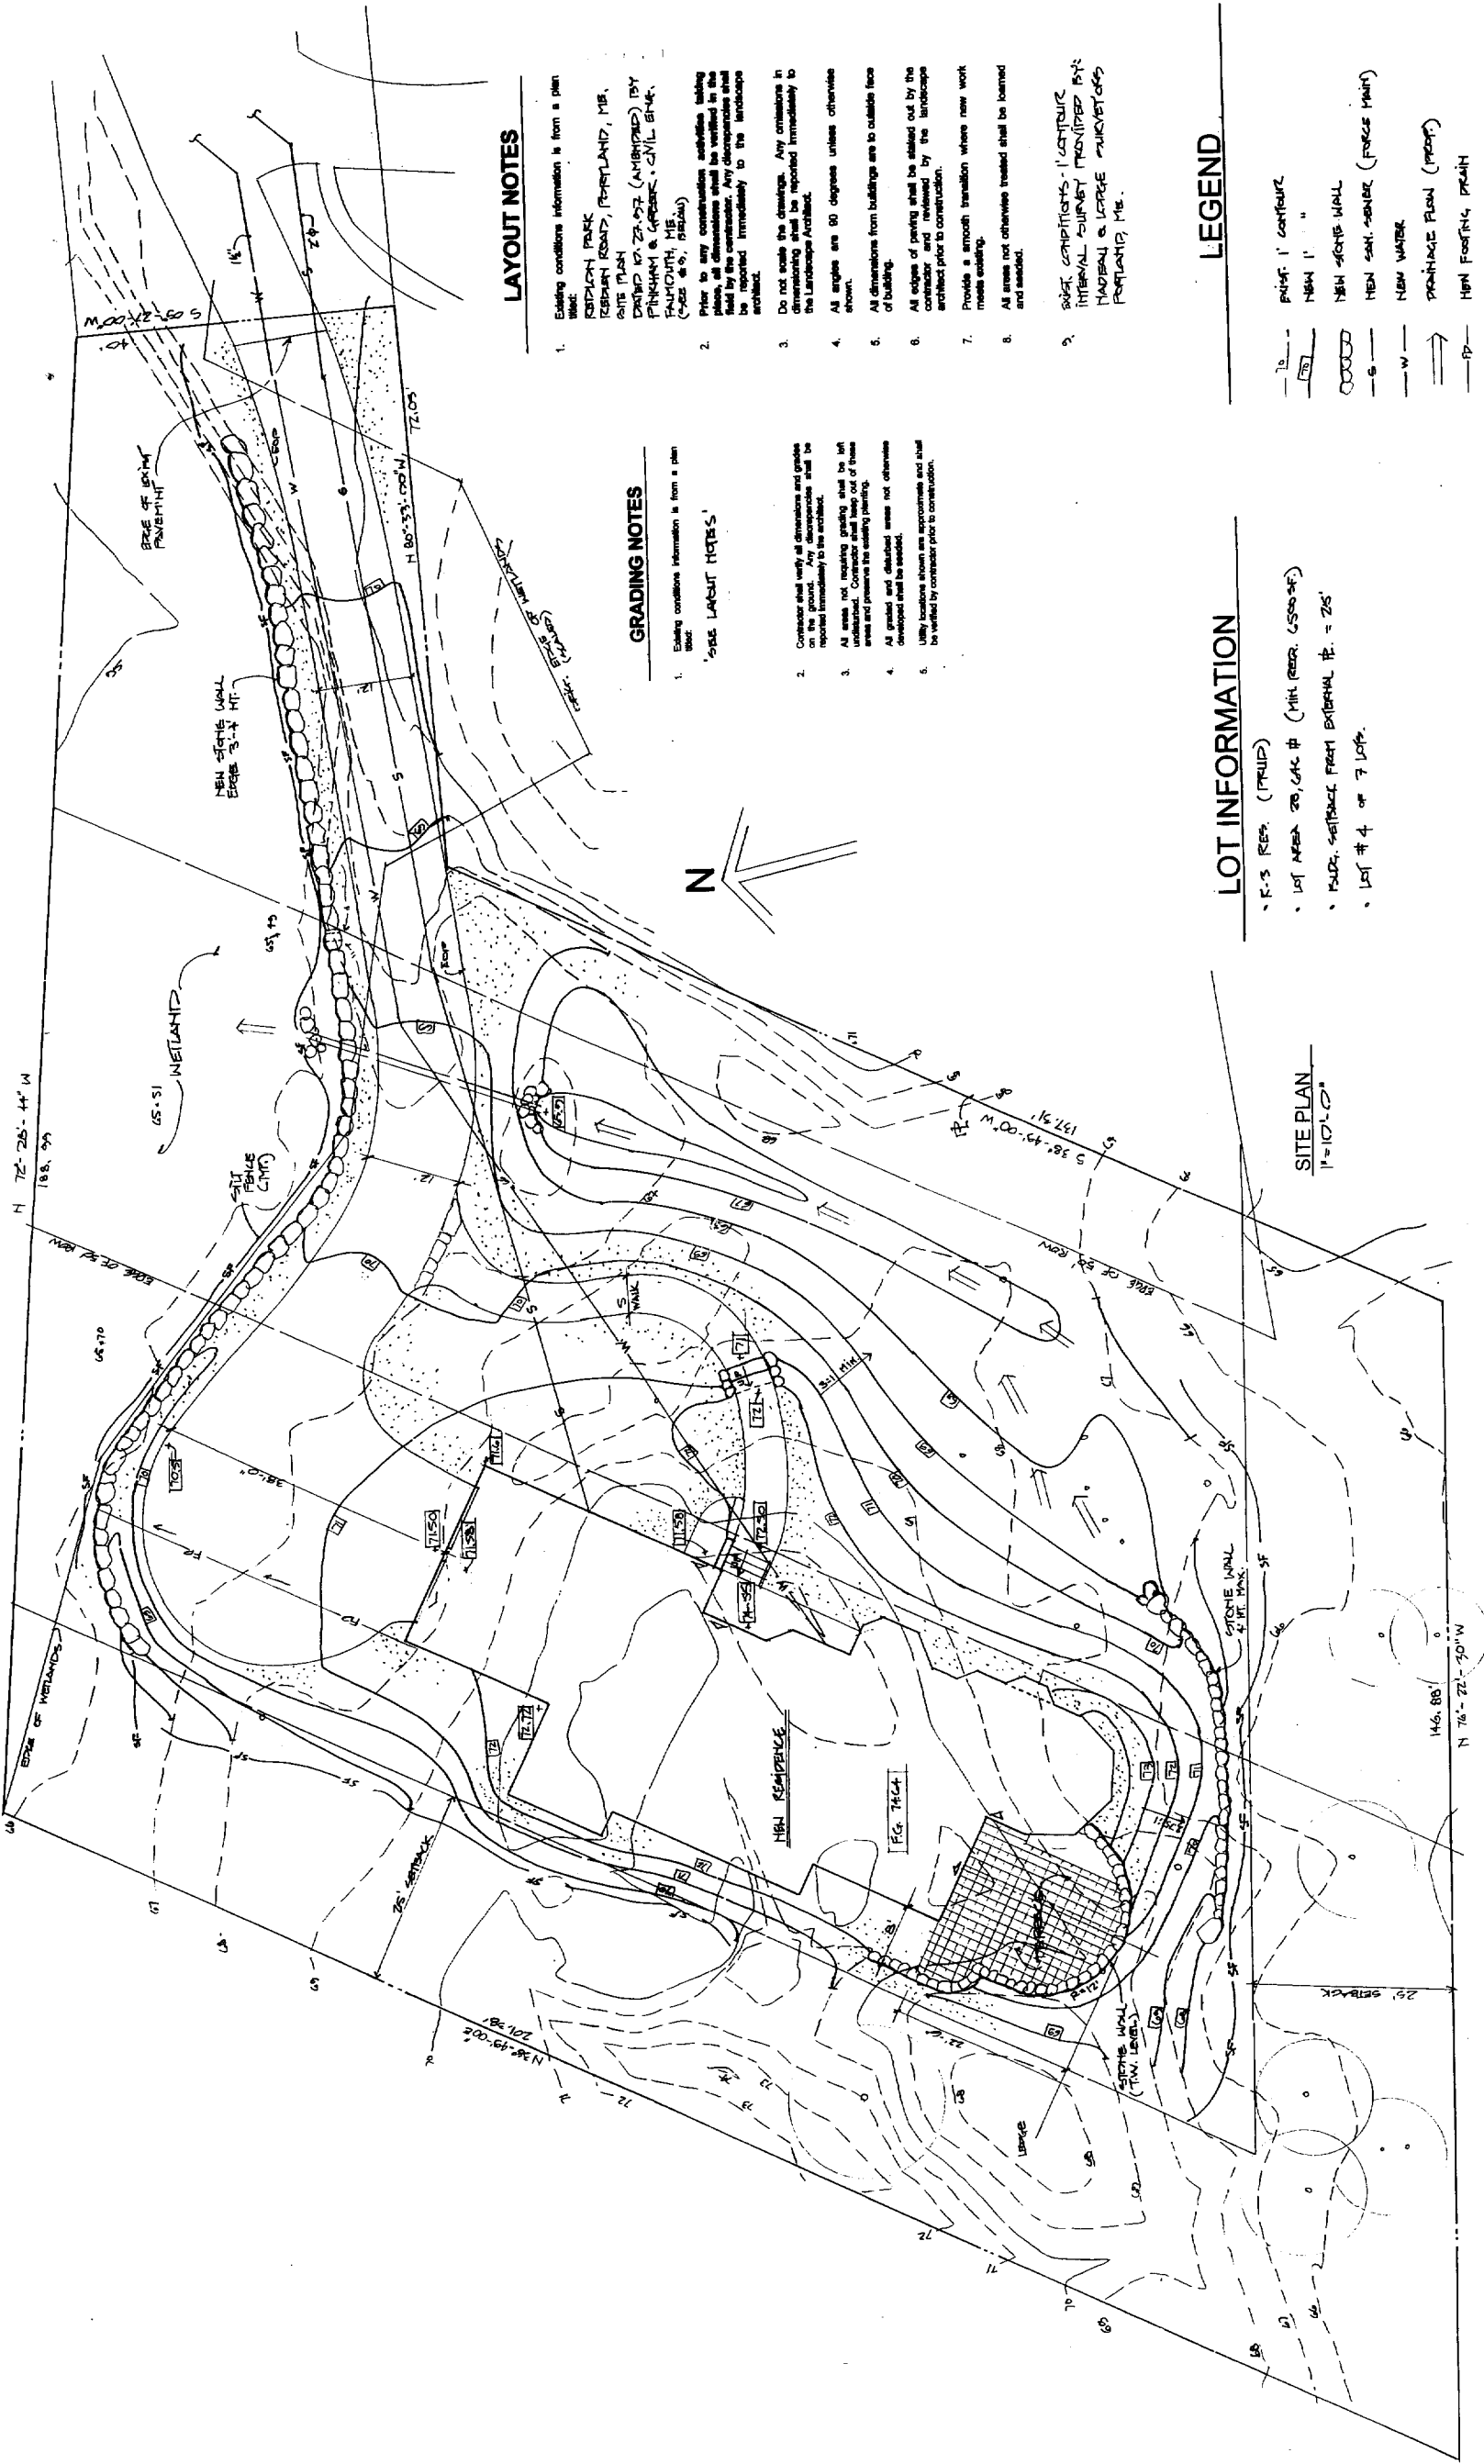

LAYOUT NOTES

- Existing conditions information is from a plan sheet:
ROBINSON PARK
RESIDENT ROAD, PORTLAND, ME.
SITE PLAN
DRAWN BY ZS-57 (AMBER) BY
PITCHAM & GREENE, CIVIL ENGR.
PORTLAND, ME.
(SHEET # 6, 7/20/04)
- Prior to any construction activities taking place, all dimensions shall be verified in the field by the contractor. Any discrepancies shall be reported immediately to the landscape architect.
- Do not scale the drawings. Any omissions in dimensioning shall be reported immediately to the Landscape Architect.
- All angles are 90 degrees unless otherwise shown.
- All dimensions from buildings are to outside face of building.
- All edges of paving shall be related out by the contractor and reviewed by the landscape architect prior to construction.
- Provide a smooth transition where new work meets existing.
- All areas not otherwise treated shall be loamed and seeded.
- SOFT CONDITIONS - 1' CONTOUR INTERVAL CURVE PROVIDED BY MADRASK & LOPEL MAINTENANCE PORTLAND, ME.

GRADING NOTES

- Existing conditions information is from a plan sheet:
'SITE LAYOUT NOTES'
- Contractor shall verify all dimensions and grades on the ground. Any discrepancies shall be reported immediately to the architect.
- All areas not requiring grading shall be left undisturbed. Contractor shall keep out of these areas and preserve the existing planting.
- All graded and disturbed areas not otherwise developed shall be seeded.
- Utility locations shown are approximate and shall be verified by contractor prior to construction.


LEGEND

- 1" CONTOUR
- NEW 1" "
- NEW DRIVE WALL
- NEW SIDE WALK (PAGES MAIN)
- NEW WALK
- DRAINAGE PLAN (PAGES)
- NEW FOOTING, PILEH

LOT INFORMATION


- P-5 REPS (TRUMP)
- LOT AREA 28,040.40 (MIL REAR, 4500-SF)
- ROAD SETBACK FROM EXTERNAL FE = 25'
- LOT # 4 OF 7 LOTS

SITE PLAN
1" = 10' x 10'

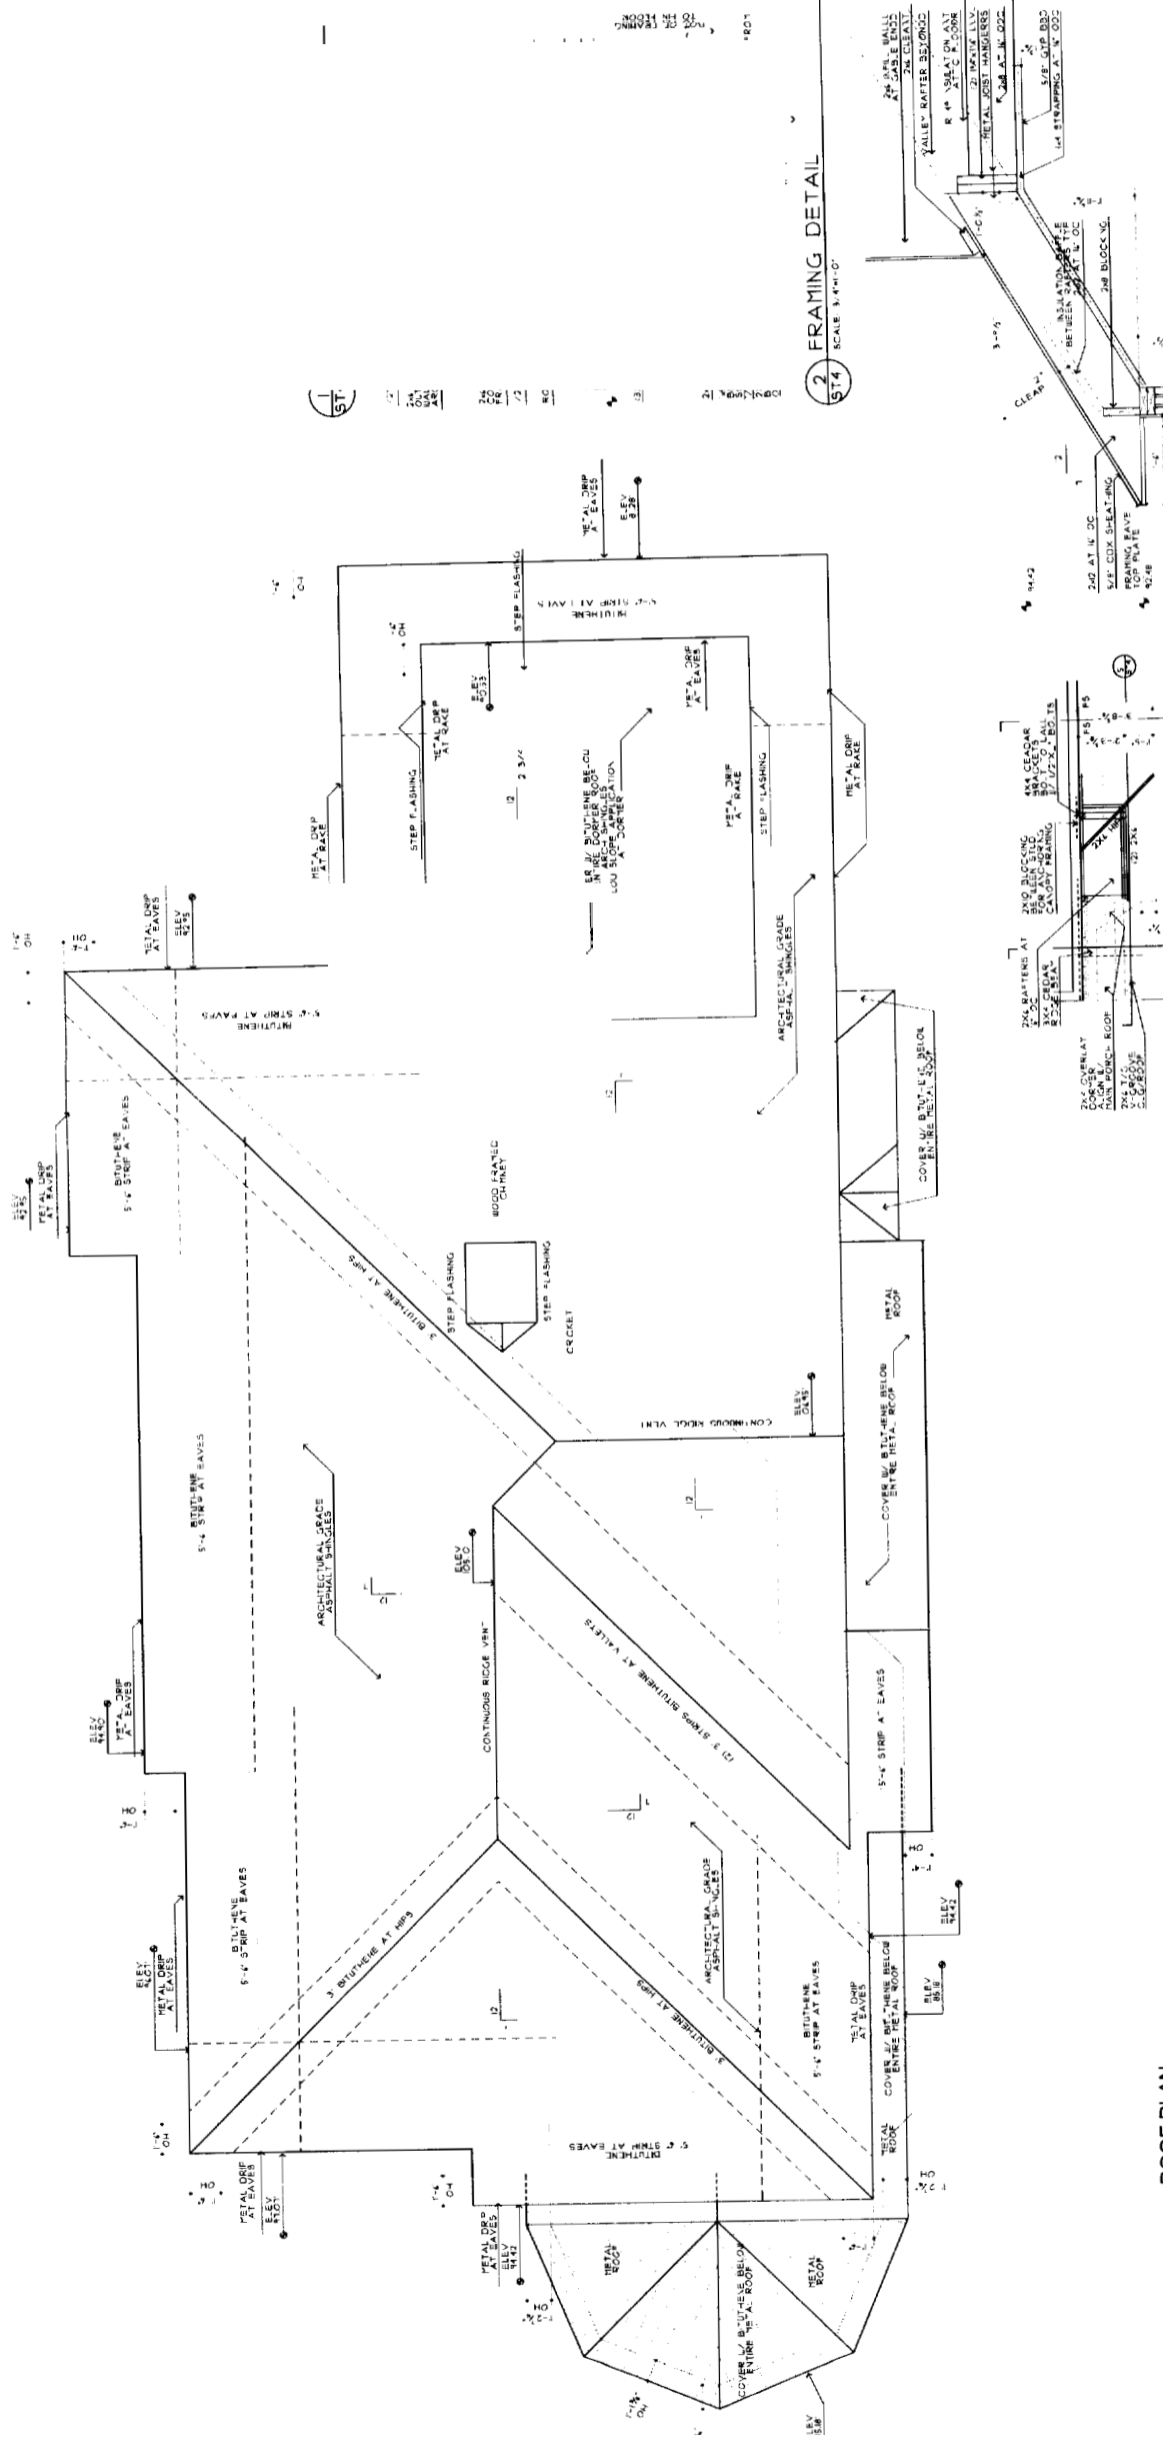


ROOF PLAN
SCALE: 1/4" = 1'-0"


2 FRAMING DETAIL
SCALE: 3/4" = 1'-0"

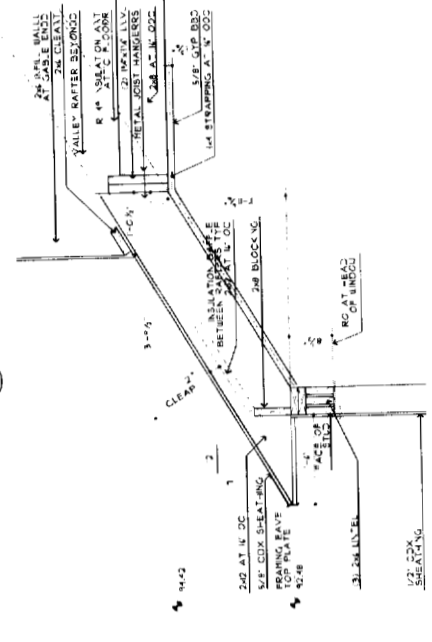


3 FRAMING DETAIL
SCALE: 3/4" = 1'-0"

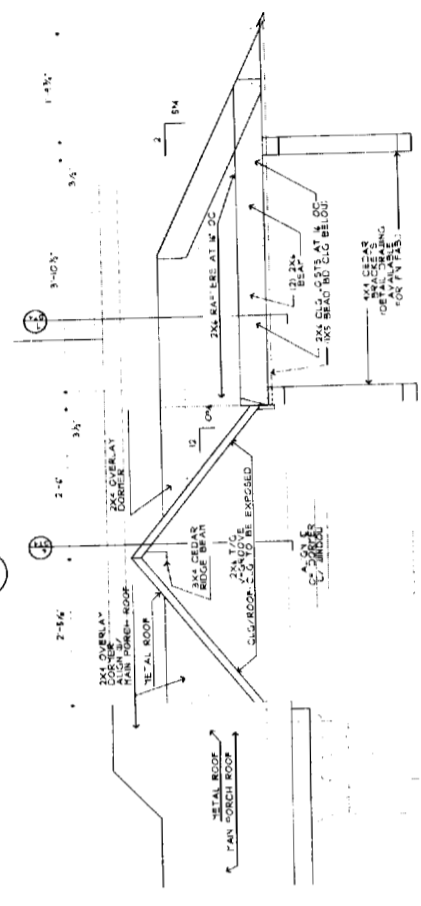


4 FRAMING PLAN AT CANOPY
SCALE: 1/4" = 1'-0"

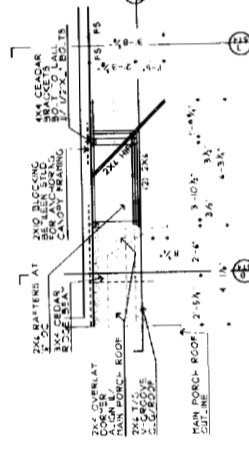


7 FRAMING DETAIL AT CANOPY
SCALE: 3/4" = 1'-0"

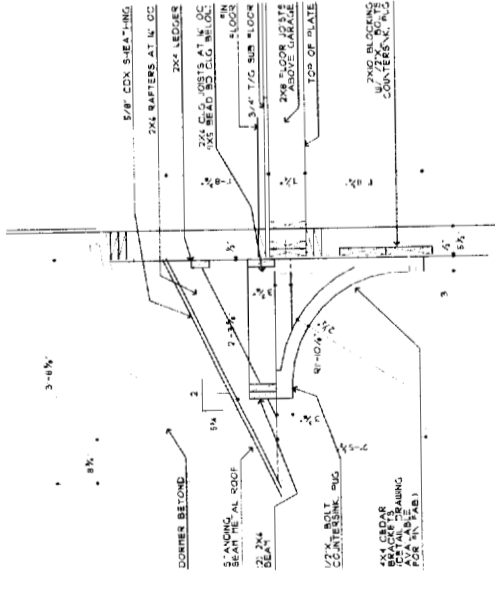

6 FRAMING DETAIL AT CANOPY
SCALE: 3/4" = 1'-0"

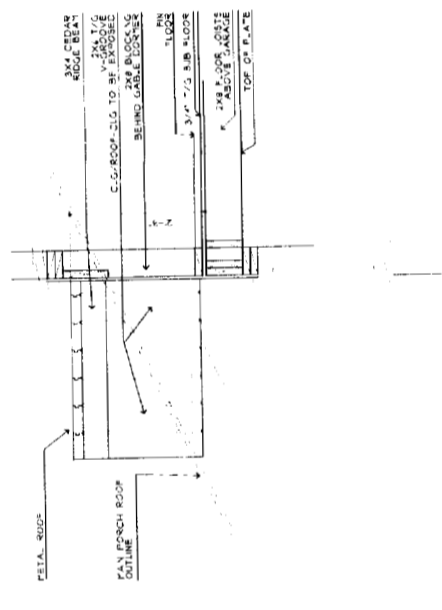

5 FRAMING DETAIL AT CANOPY
SCALE: 3/4" = 1'-0"

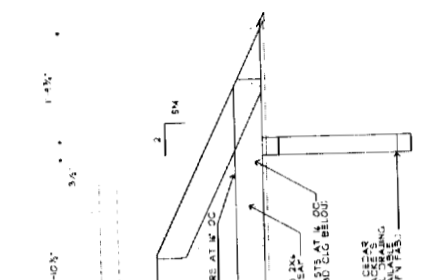

DTA 7 8/17/2004
 PORTLAND, MAINE 04101
 207-771-5881 FAX 774-0848


SHEET NO. 1
MAY 2005
ROOF PLAN
 DRAWN BY
 PROJECT NUMBER
 0208
 SHEET NUMBER
ST4

PROJECT: 1104
MARINO RESIDENCE
 PORTLAND, OR

1. ACTION: RE-ROOF
 2. BAND JOIST
 3. INSULATION
 4. SHEATHING
 5. FLASHING
 6. DRAINAGE

DATE: MAY 2005
 DRAWN BY: SMT
 PROJECT NUMBER: 0208
 SHEET NUMBER: ST 3


ROOF FRAMING PLAN

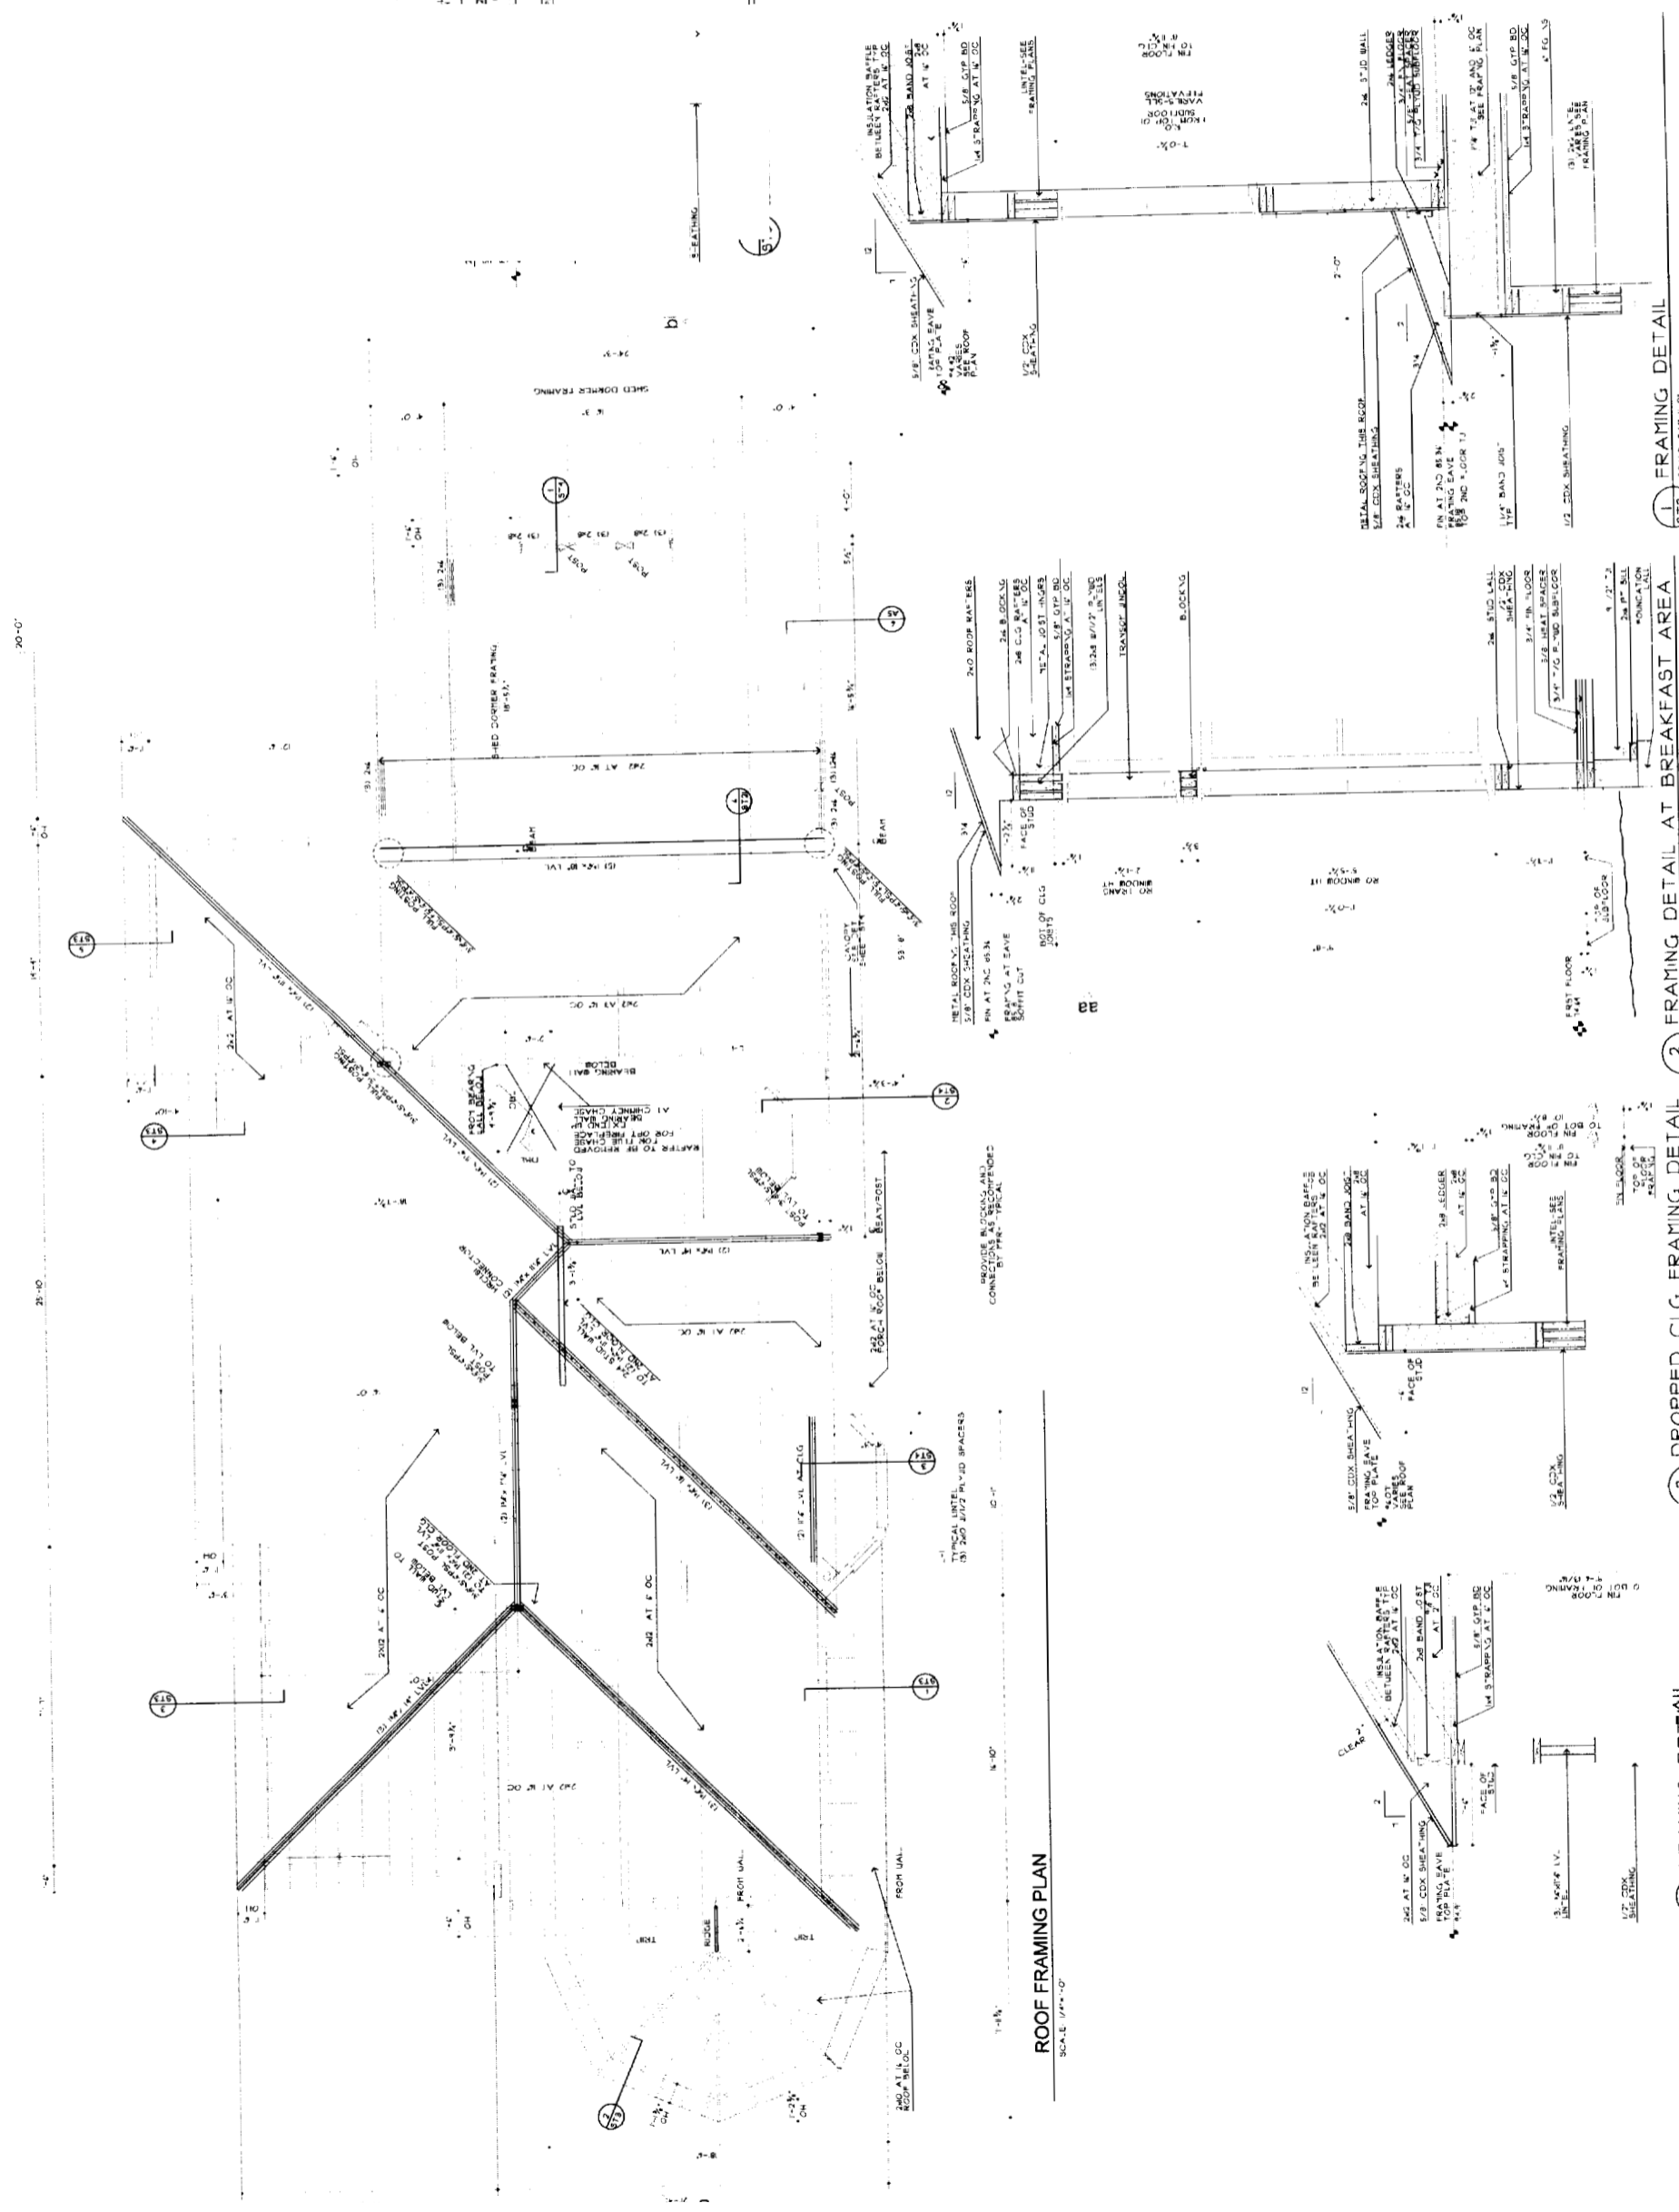

ED A MIN/C DETAIL

ED A MIN/C DETAIL

ED A MIN/C DETAIL

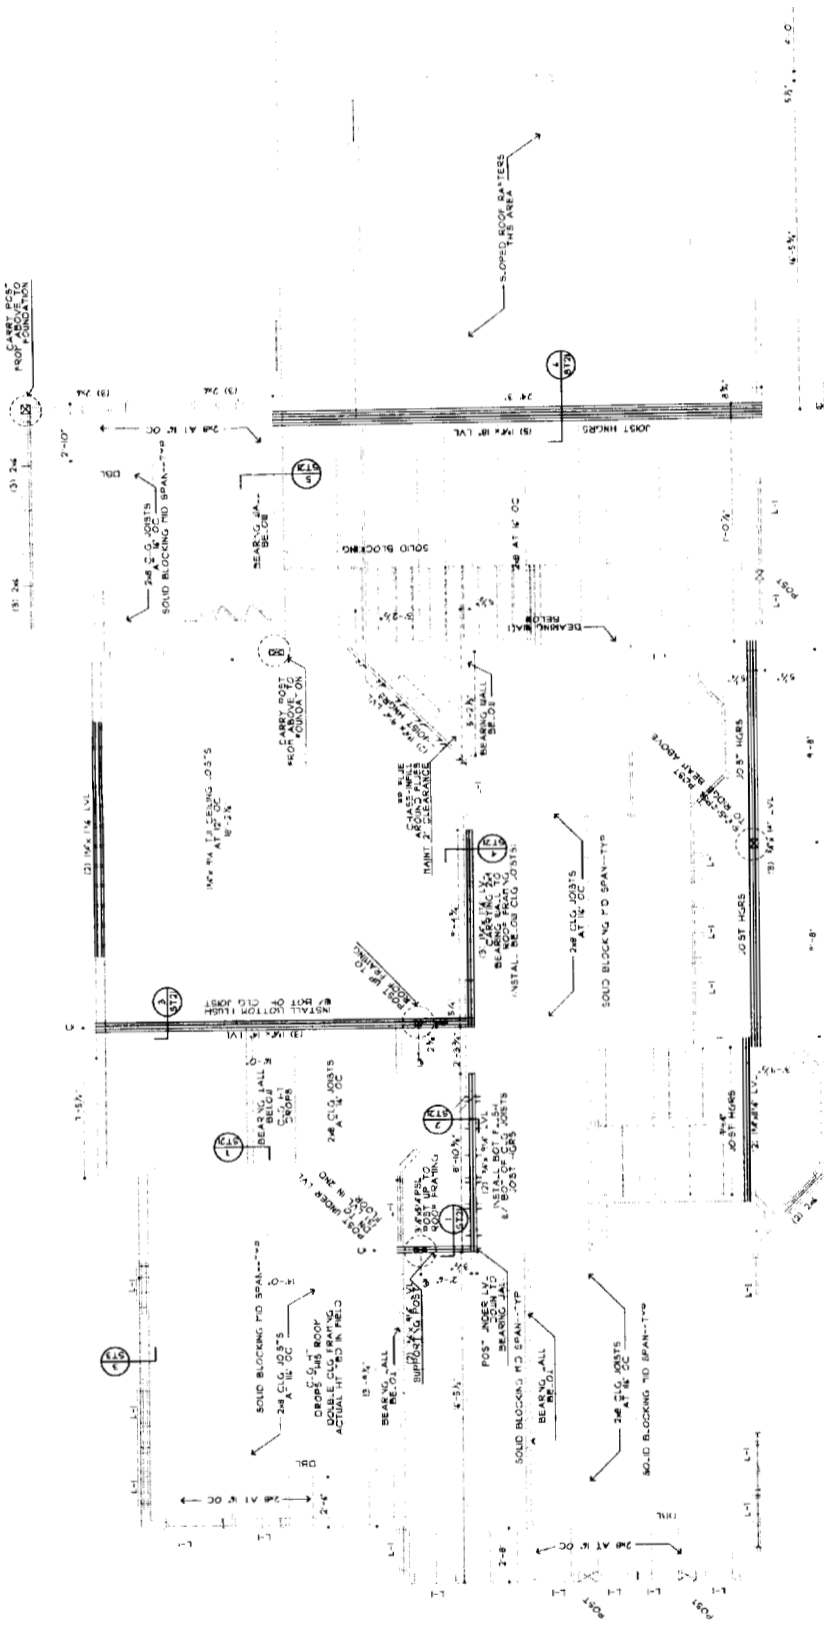


GTA2 projects
 44 241 STREET
 PORTLAND, OREGON 97107
 503-771-5461 fax: 774-0846


W/RS/SM
 DATE
 MAY, 2005

2ND FLOOR CLG FRAMING


SCALE
 AS NOTED
 DRAWN BY
 SMT
 PROJECT NUMBER
 0208

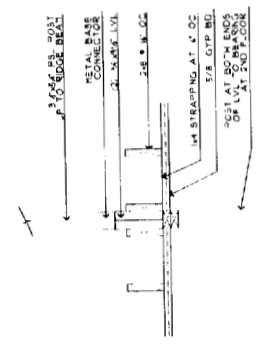


1 FRAMING DETAIL
 SCALE 3/4"=1'-0"

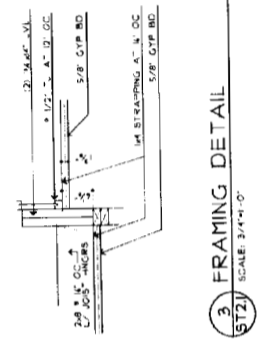

2 FRAMING DETAIL
 SCALE 3/4"=1'-0"

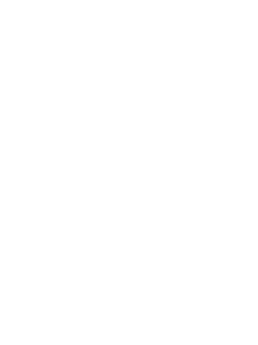

3 FRAMING DETAIL
 SCALE 3/4"=1'-0"

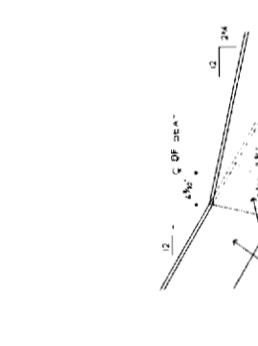

4 FRAMING DETAIL
 SCALE 3/4"=1'-0"



5 FRAMING DETAIL
 SCALE 3/4"=1'-0"




6 FRAMING DETAIL
 SCALE 3/4"=1'-0"



7 FRAMING DETAIL
 SCALE 3/4"=1'-0"

SUB TO BE OVER GARAGE

G7A 2 bedrooms
 44 004 8196
 PORTLAND, MAINE 04107
 207.771.5401 / 774.2646

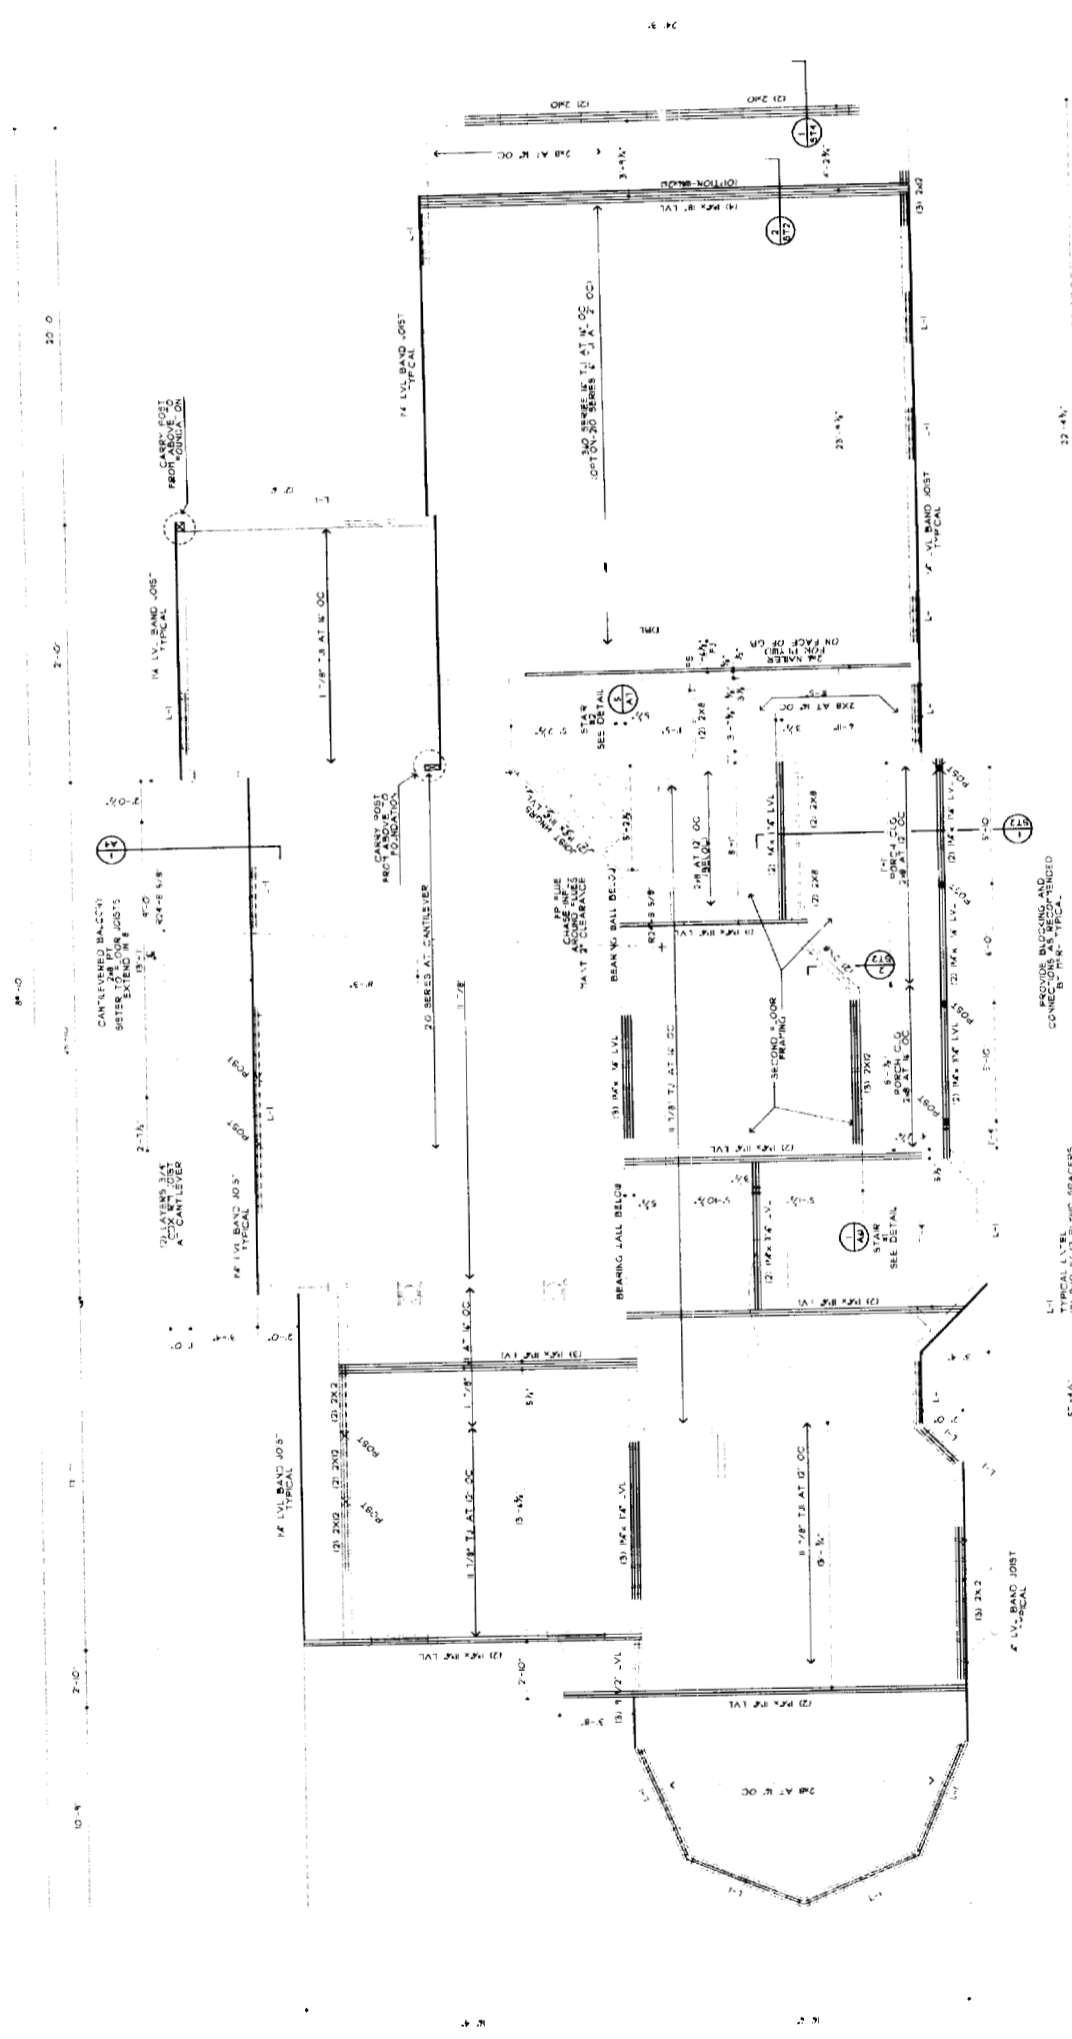



REVISIONS

NO	DATE	DESCRIPTION
200	MAY 2005	CONSTRUCTION

SECOND FLOOR FRAMING PLAN

DATE: MAY 2005
 DRAWN BY: SMT
 PROJECT NUMBER: 0208
 SHEET NUMBER: ST2


RAMING P1

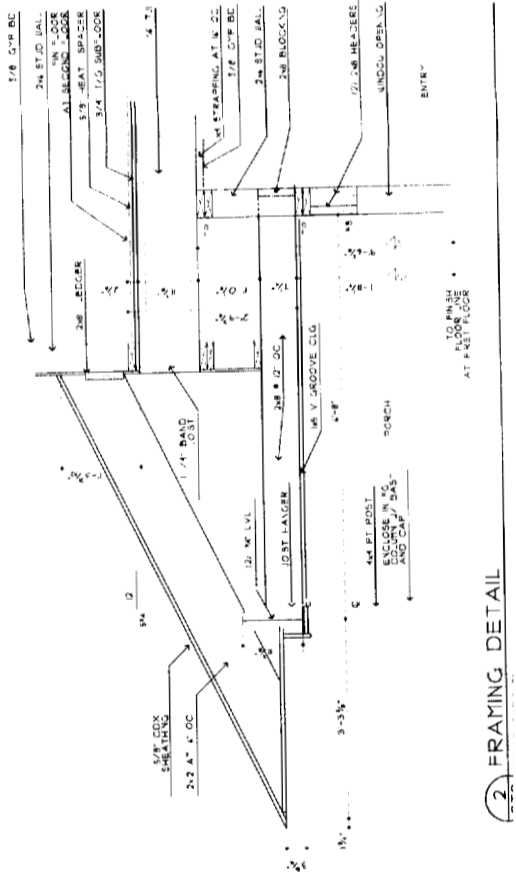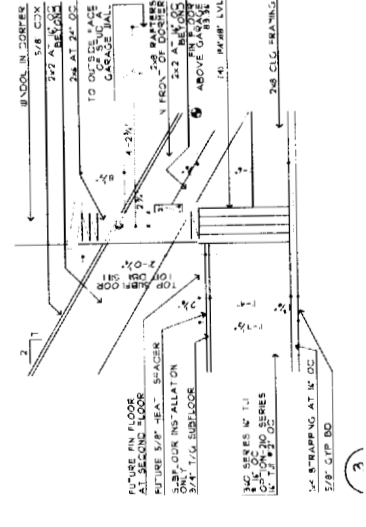

1) FRAMING DETAIL
 SCALE 3/4"=1'-0"


2) FRAMING DETAIL
 SCALE 3/4"=1'-0"

SCALE

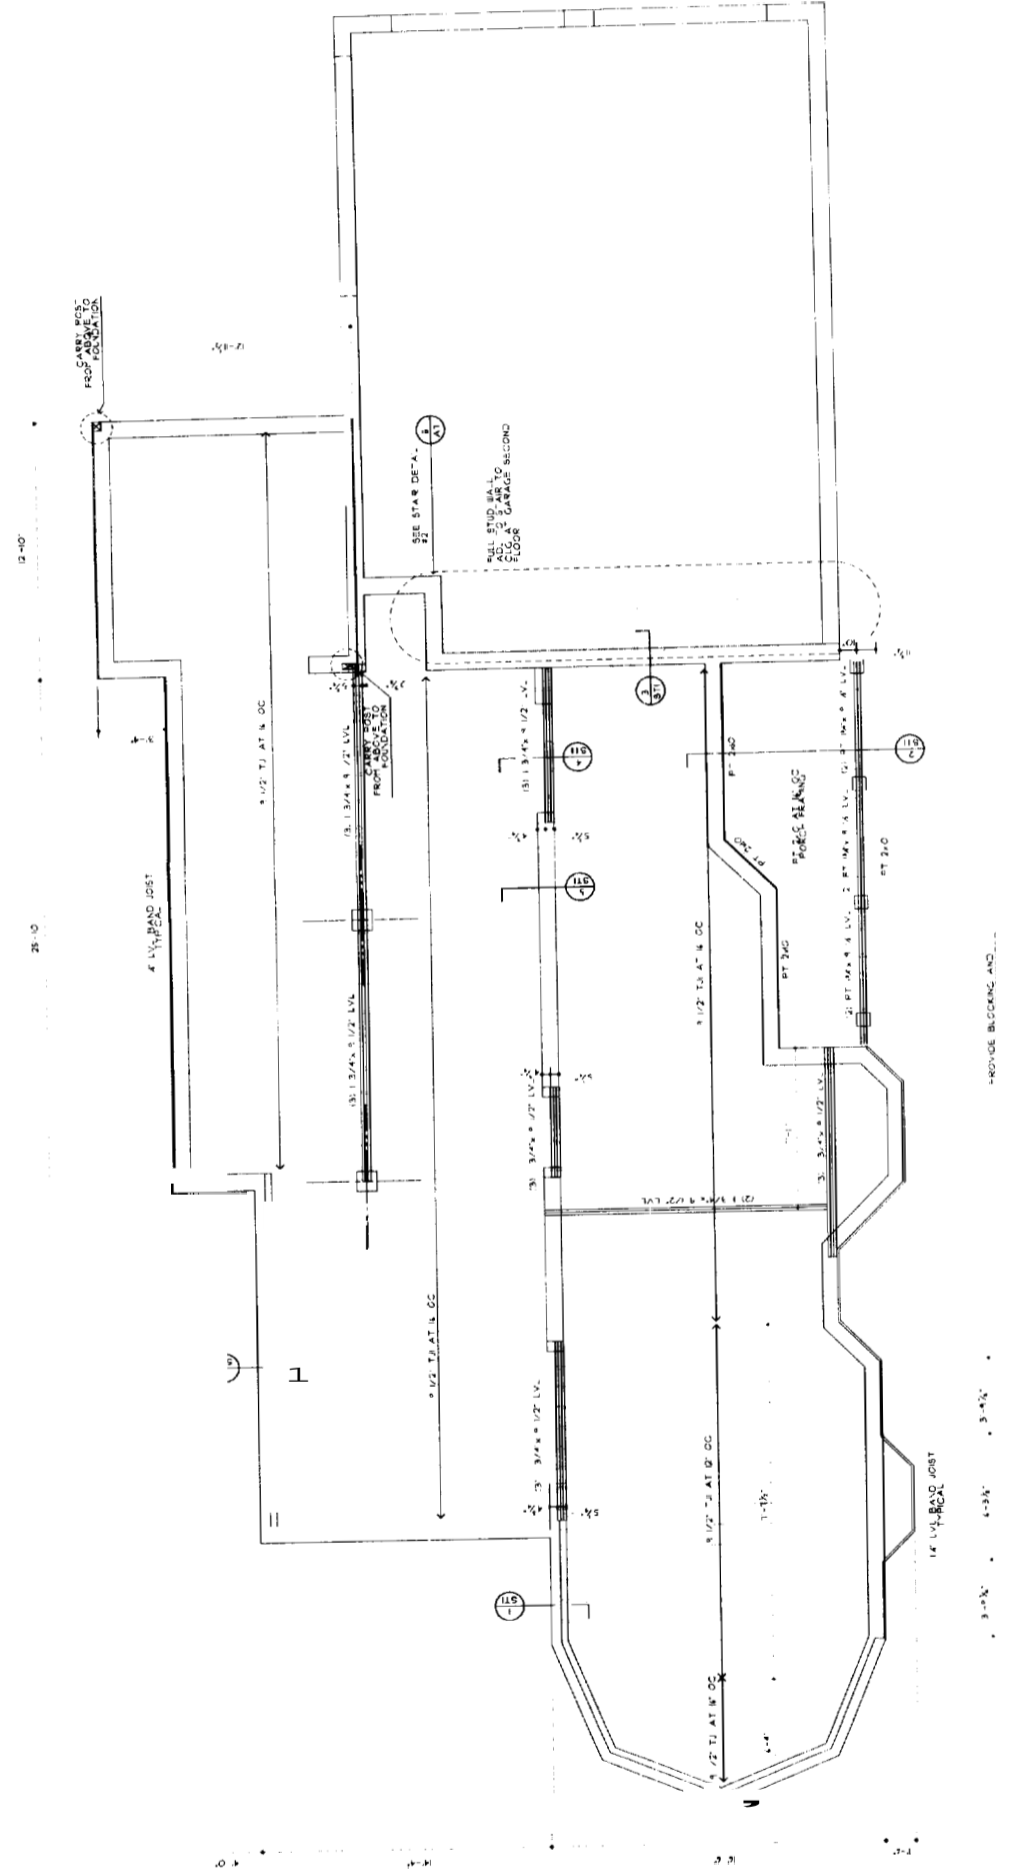


GTA 2 MID WEST
 44 Oak Street
 Portland, Maine 04101
 207-771-6461 fax: 774-6246


DATE	MAY 20 5
BY	SMT
PROJECT NUMBER	0208
SCALE	AS NOTED
DRAWN BY	SMT
PROJECT NUMBER	0208
FRAME NUMBER	ST 1

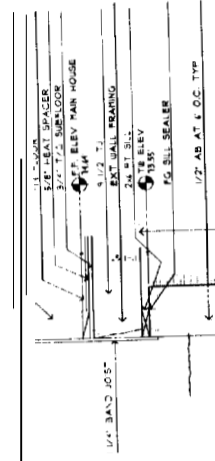

1 FRAMING DETAIL
 SCALE: 3/4"=1'-0"

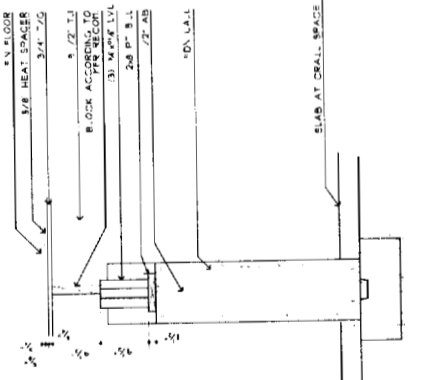


2 FRAMING DETAIL
 SCALE: 3/4"=1'-0"

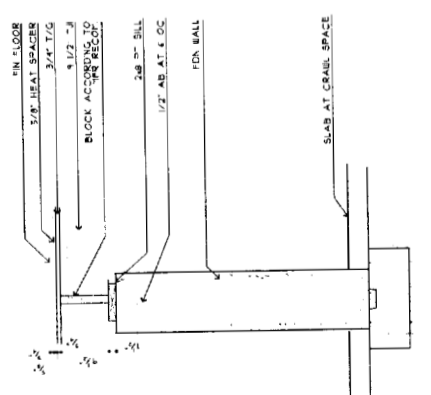

3 FRAMING DETAIL
 SCALE: 3/4"=1'-0"



4 FRAMING DETAIL
 SCALE: 3/4"=1'-0"



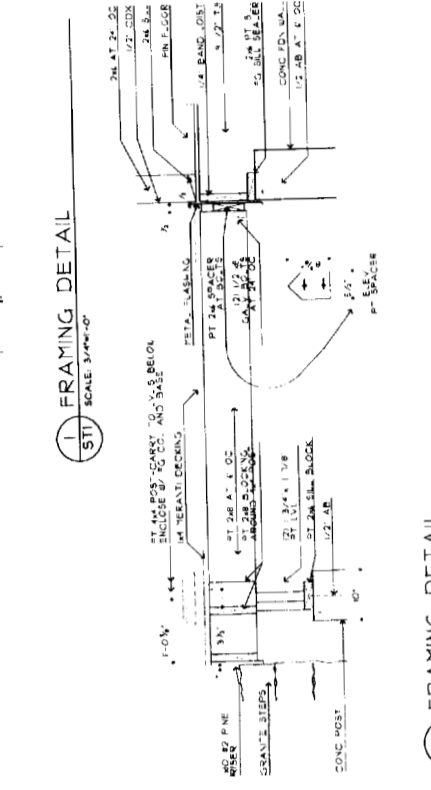


5 FRAMING DETAIL
 SCALE: 3/4"=1'-0"

RA




PROVIDE BLOCKING AND...

PORTLAND, MAINE

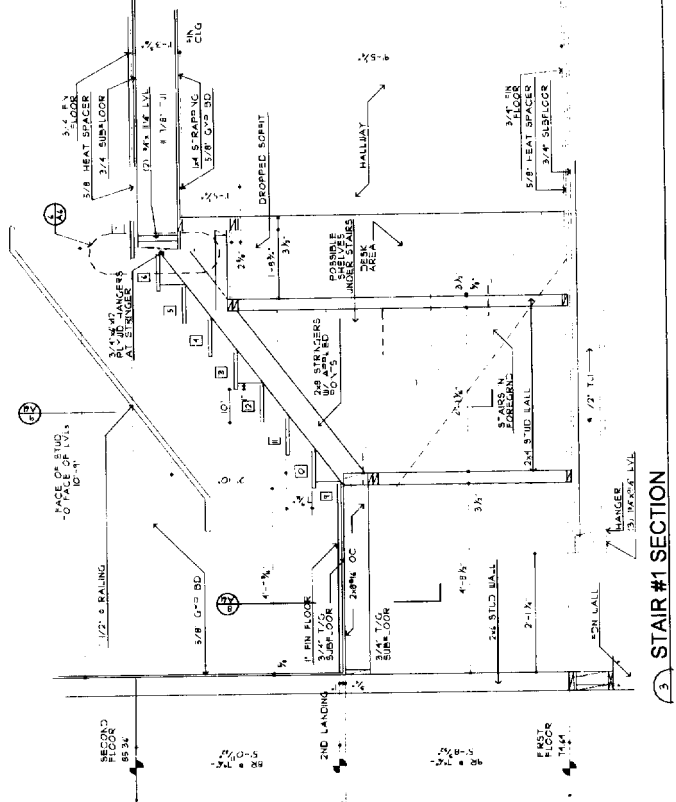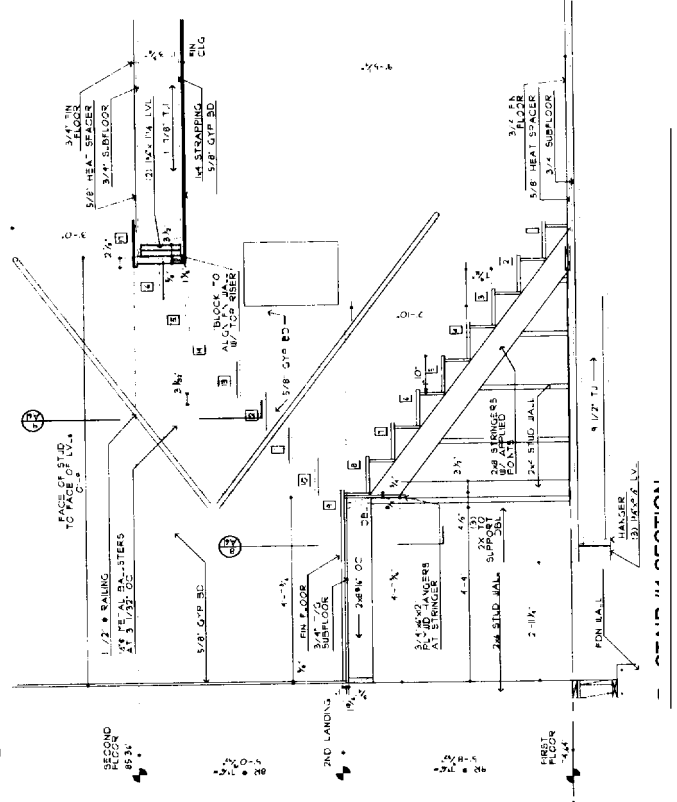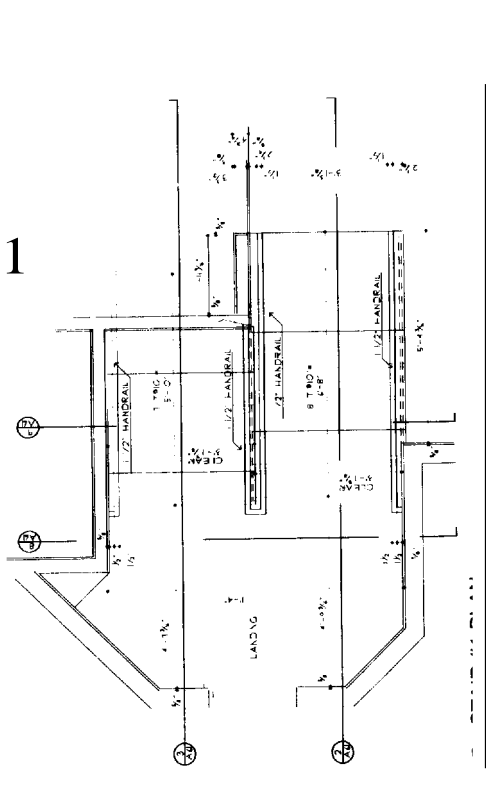



1 STAIR #1 SECTION

2 STAIR #1 DETAIL

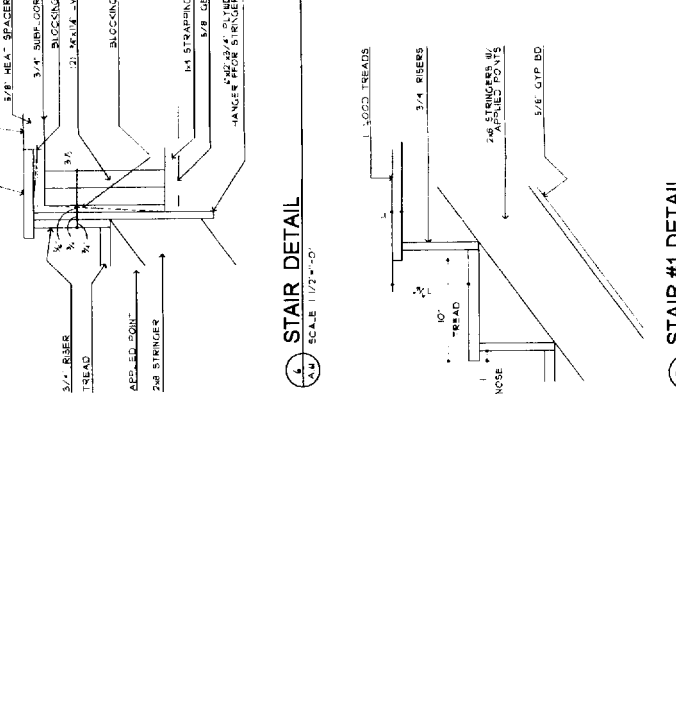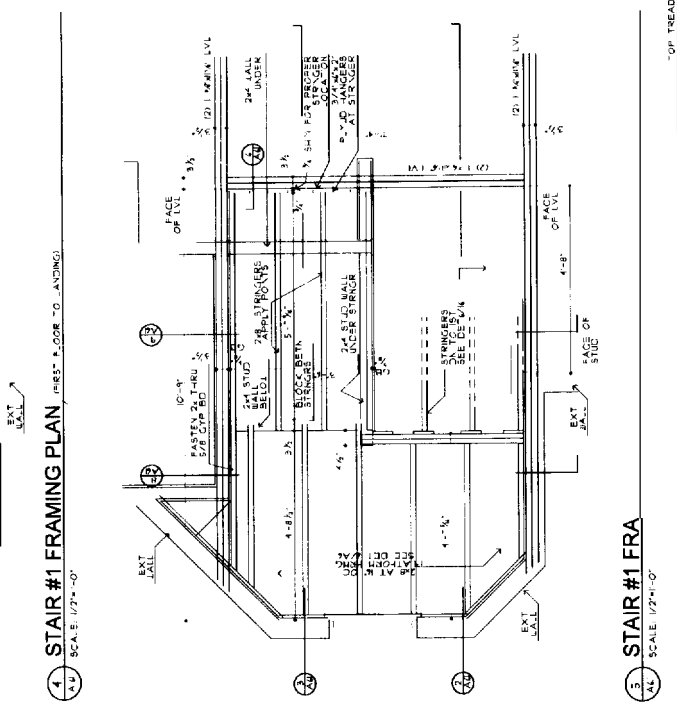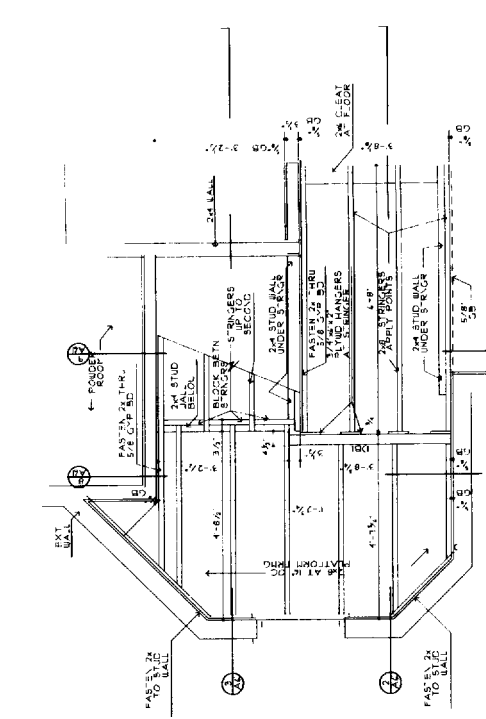


3 STAIR #1 SECTION

4 STAIR #1 DETAIL

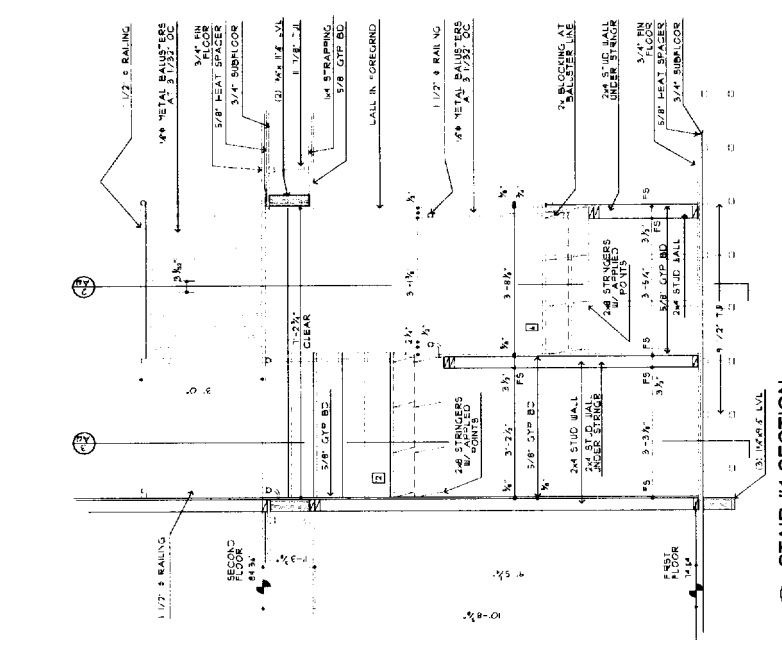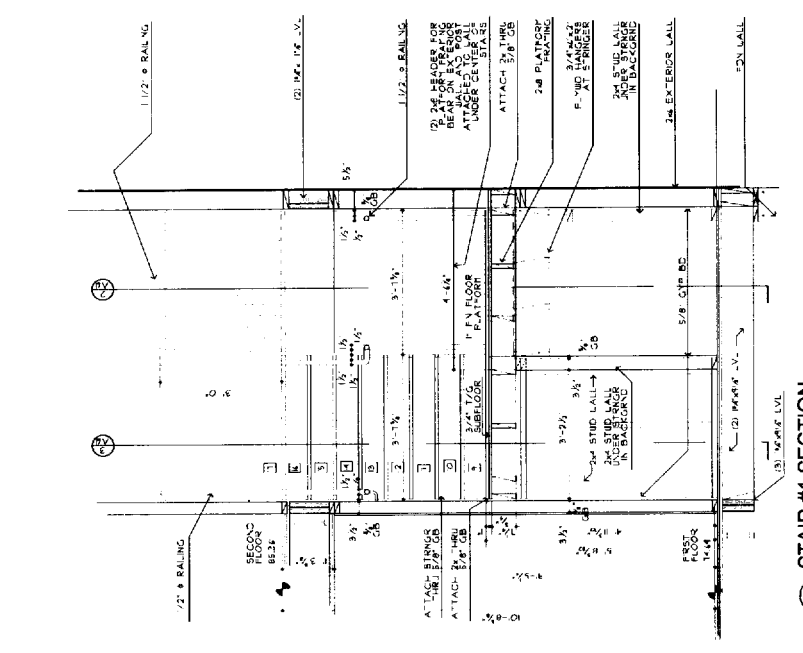


5 STAIR #1 SECTION


6 STAIR #1 DETAIL

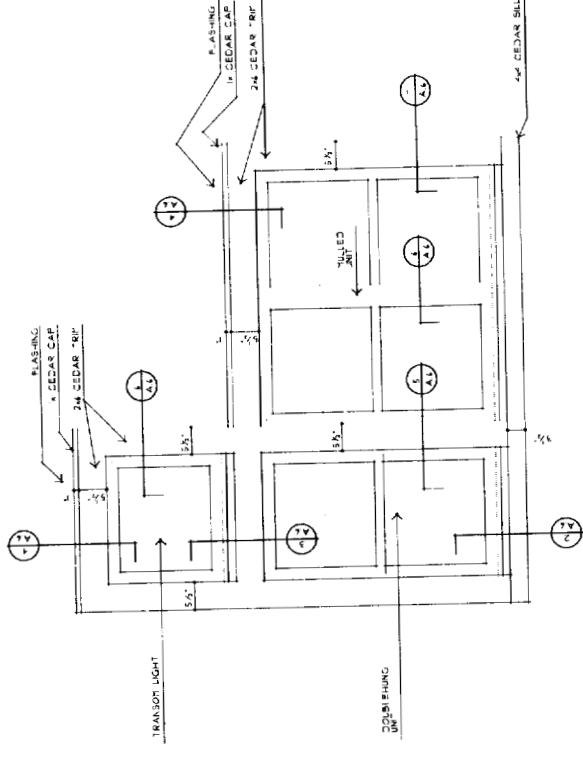


1 WINDOW TRIM DETAIL
 SCALE: 3/4"=1'-0"

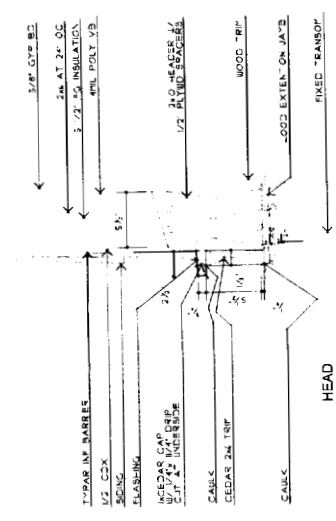


4 WINDOW DETAIL AT HEAD
 SCALE: 1/2"=1'-0"

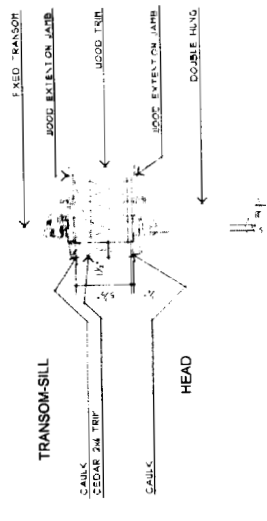


3 WINDOW DETAIL AT TRANSOM SILL
 SCALE: 1/2"=1'-0"

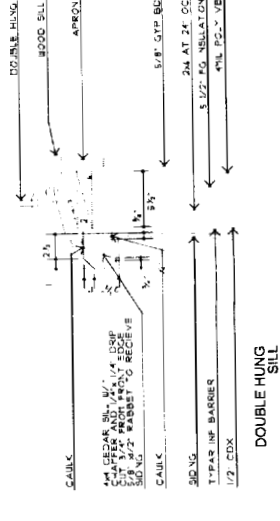


2 WINDOW SILL DETAIL
 SCALE: 1/2"=1'-0"

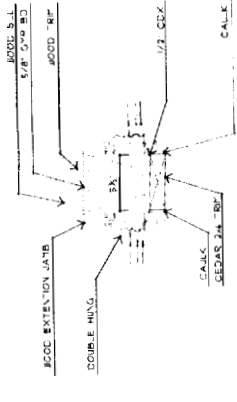

5 MULLION DETAIL AT POST
 SCALE: 7/8"=1'-0"

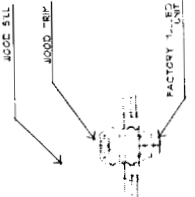

6 FACTORY MULLION DETAIL
 SCALE: 1/2"=1'-0"

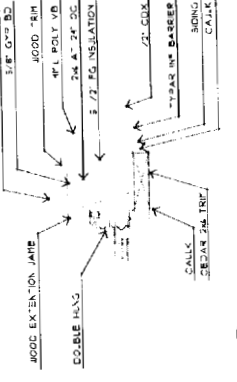

7 WINDOW DETAIL AT JAMB
 SCALE: 7/8"=1'-0"


OWNER: STAN & ROBINSON
 44 2nd STREET
 PORTLAND, OREGON 97201
 503-771-5461 FAX 774-0946

DATE: MAY 2005
 DRAWN BY: SMT
 PROJECT: MARINO RESIDENCE

NOTES:
 AS NOTED
 SMT
 PROJECT: MARINO RESIDENCE


A6

TOP EDGE AT RAFTING
 0'-0" 1/8"
 BOTTOM
 0'-0" 1/8"
 TOP OF ROOF AT RAFTING

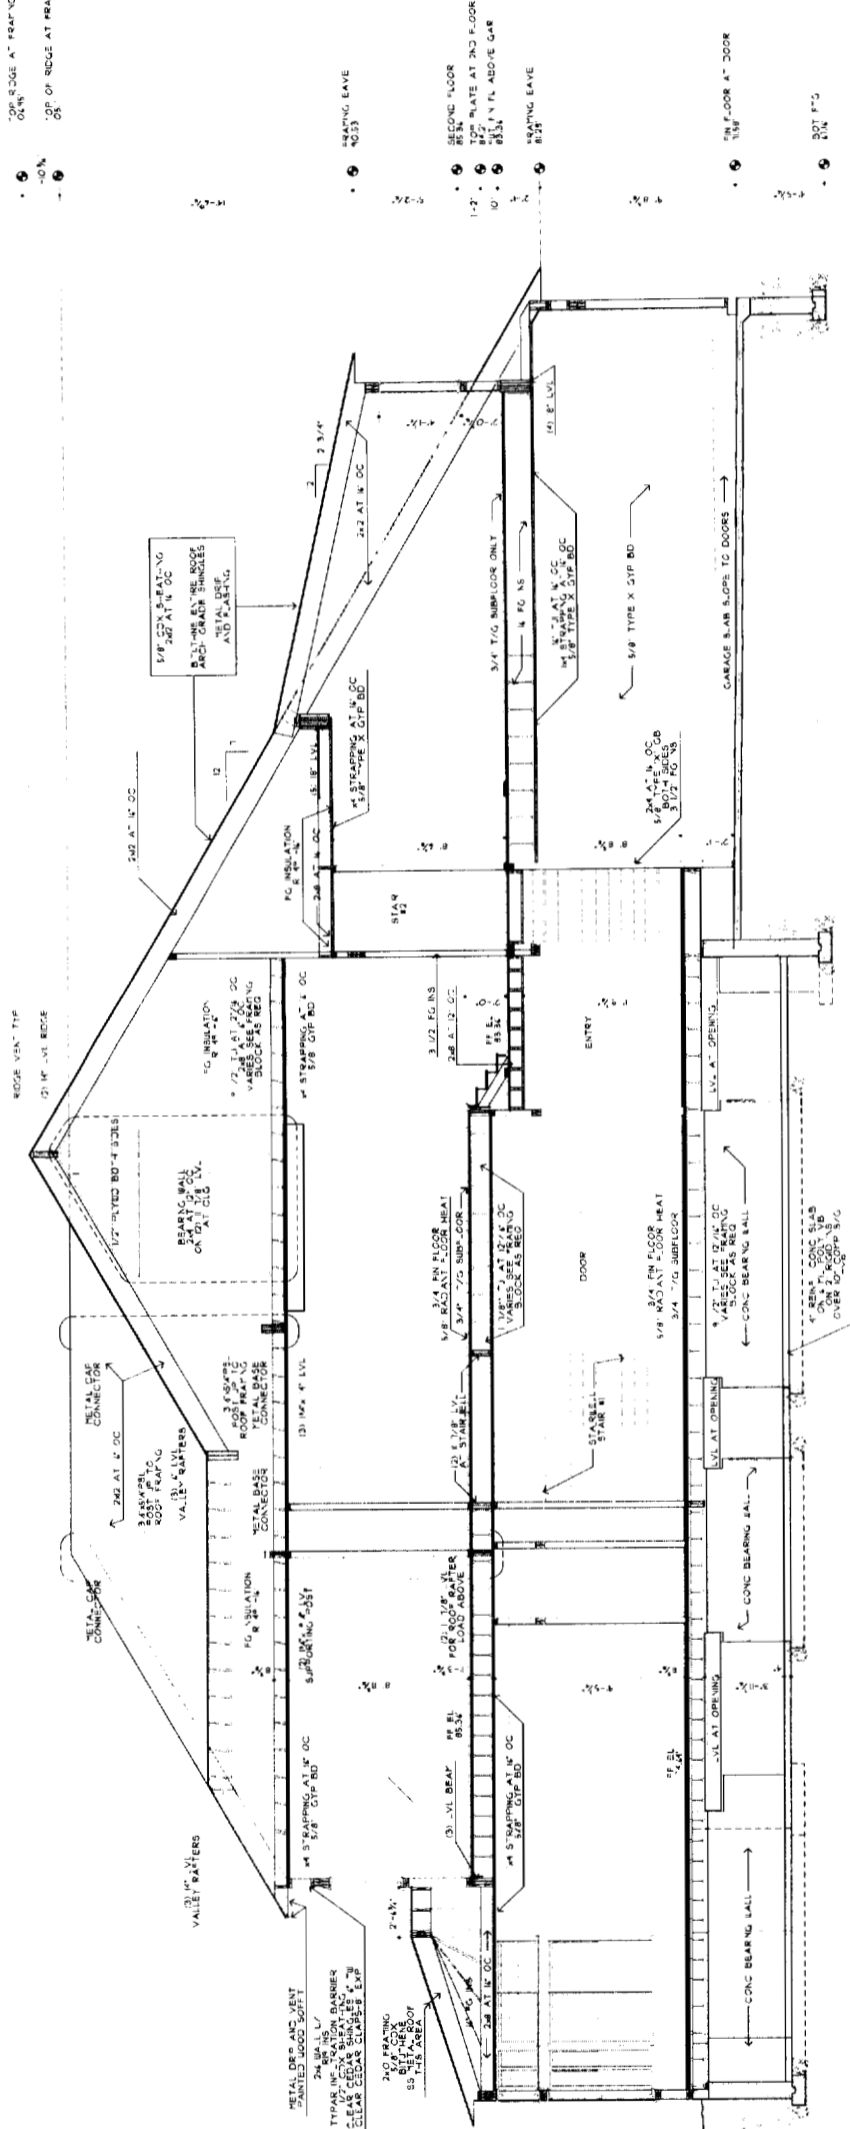


HEATING LEAVE
 TOP PLATE
 SECOND FLOOR
 FIRST FLOOR
 1ST FLOOR
 2ND FLOOR

NOTE:
 CEDAR SIDING TO BE USED OVER
 SHEATHING. SEE DETAIL FOR
 SPEC. GRADE 3/4" X 1/2" X 1/2" TYP.

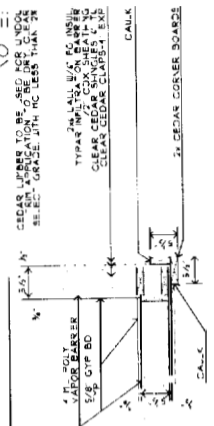


3 TYPICAL OUTSIDE CORNER DETAIL
 SCALE: 3/4" = 1'-0"

NOTE:
 CEDAR SIDING TO BE USED OVER
 SHEATHING. SEE DETAIL FOR
 SPEC. GRADE 3/4" X 1/2" X 1/2" TYP.

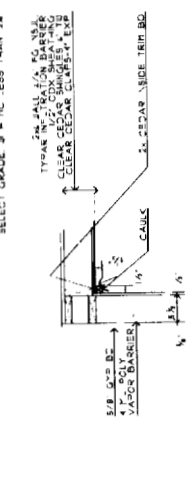


4 TYPICAL INSIDE CORNER DETAIL
 SCALE: 3/4" = 1'-0"

SECTION 44 TUBI BUI DINIC

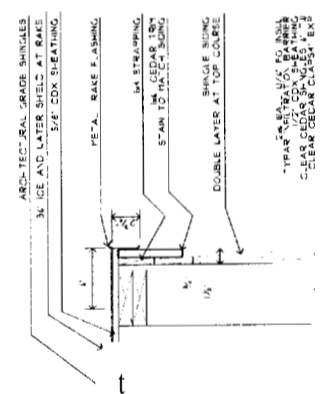


5
 A5


DATE	DATE
DESIGN	DATE
MAY, 2005	BLDG SECTION
BY	BY
SMT	AS NOTED
0208	PROJECT NUMBER
	0208
	DATE PLOTTED
	A5

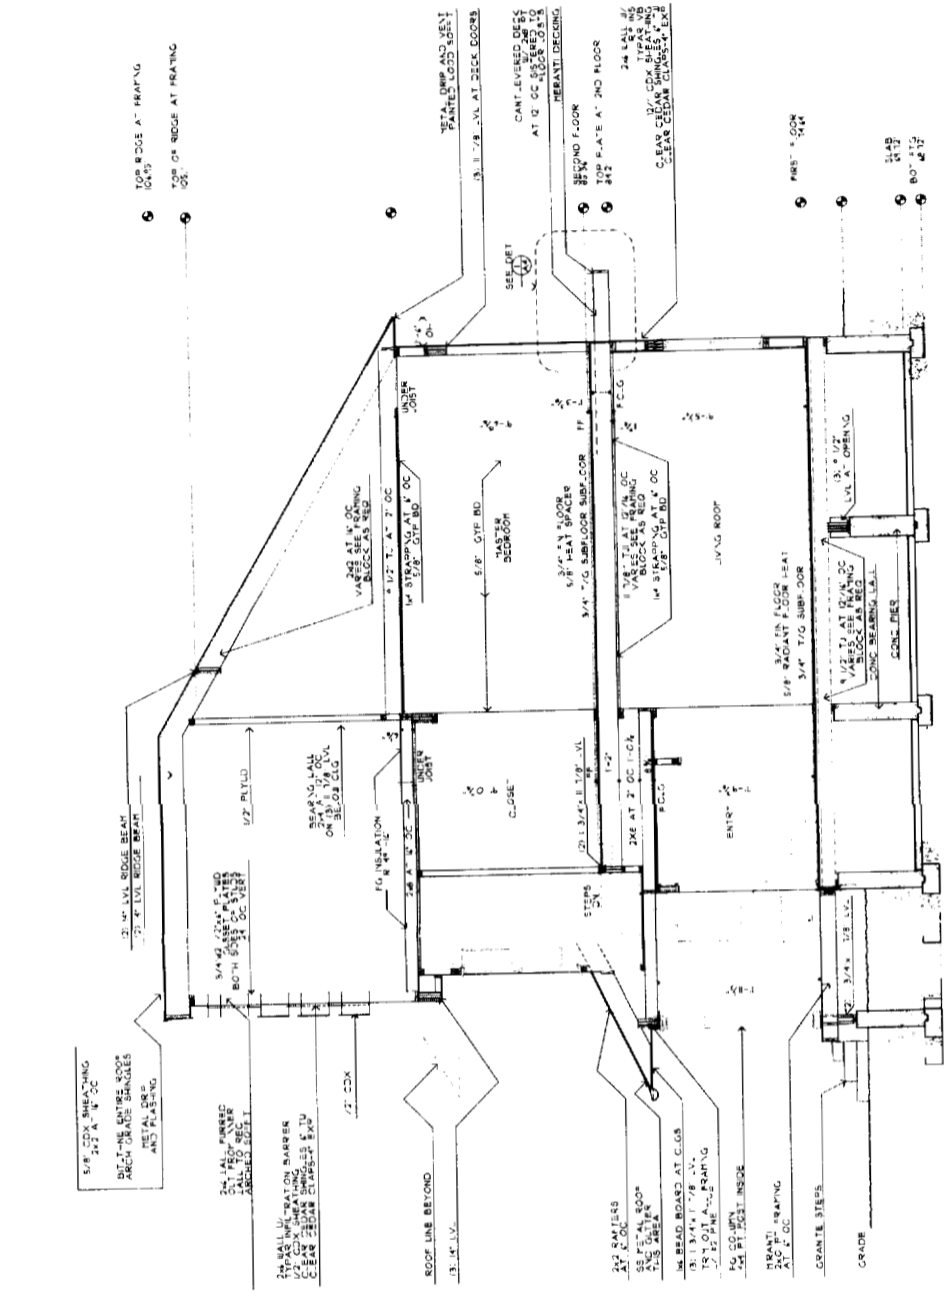


SECTION aa THRU BUILDING
 SCALE: 1/4" = 1'-0"

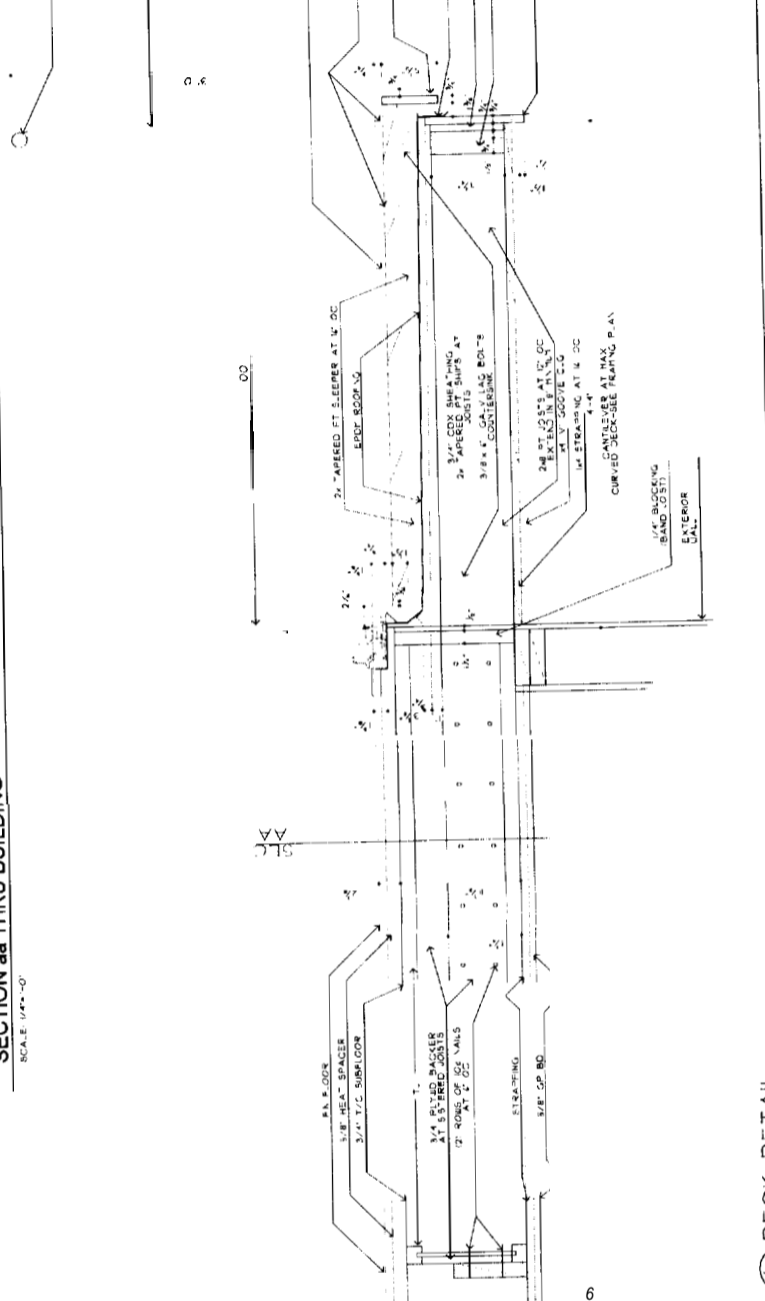

DECK DETAIL
 SCALE: 1/2" = 1'-0"

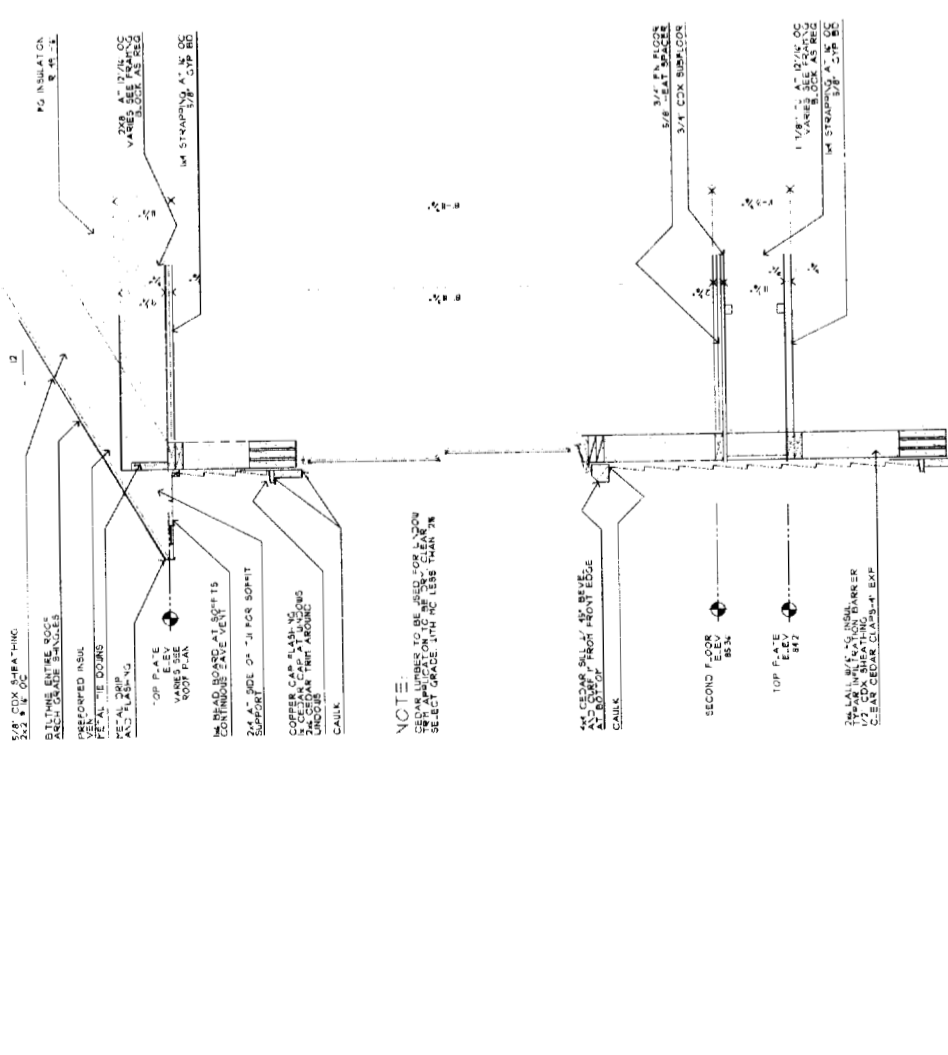

EXTERIOR WALL SECTION
 SCALE: 1/4" = 1'-0"

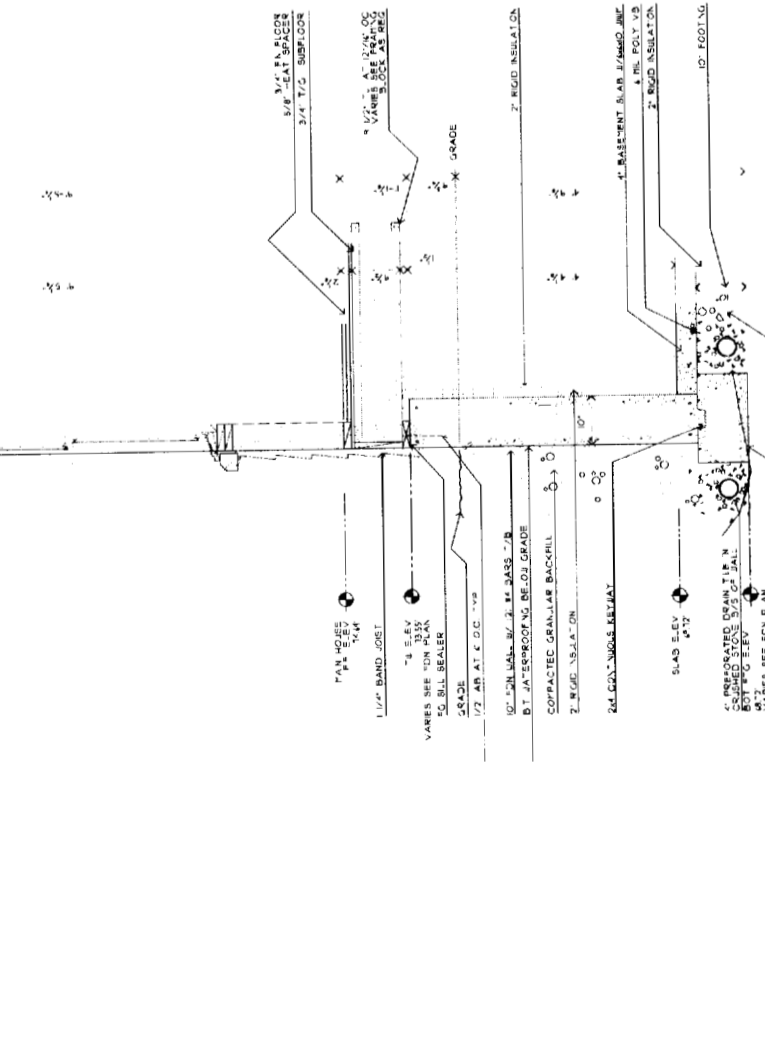

EXTERIOR WALL SECTION
 SCALE: 1/4" = 1'-0"

DATE: 01/28/05	PROJECT: MARINO RESIDENCE
ARCHITECT: A. 2005	CLIENT: [REDACTED]
SCALE: AS NOTED	DATE: 01/28/05
BLDG SECTION	
DRAWN BY: [REDACTED]	
CHECKED BY: [REDACTED]	
DATE: 01/28/05	
A4	

PROJECT: 1504

MARINO
RESIDENCE

PORTLAND, MAINE

GT/A2 ARCHITECTS
44 GARDEN STREET
PORTLAND, MAINE 04101
207-771-5461 FAX: 774-6846

REVISIONS

DATE
MAY, 2005


SHEET SIZE
1ST FLOOR PLAN


SCALE
AS NOTED
DRAWN BY
SMT

PROJECT NUMBER
0208


SHEET NUMBER

A1

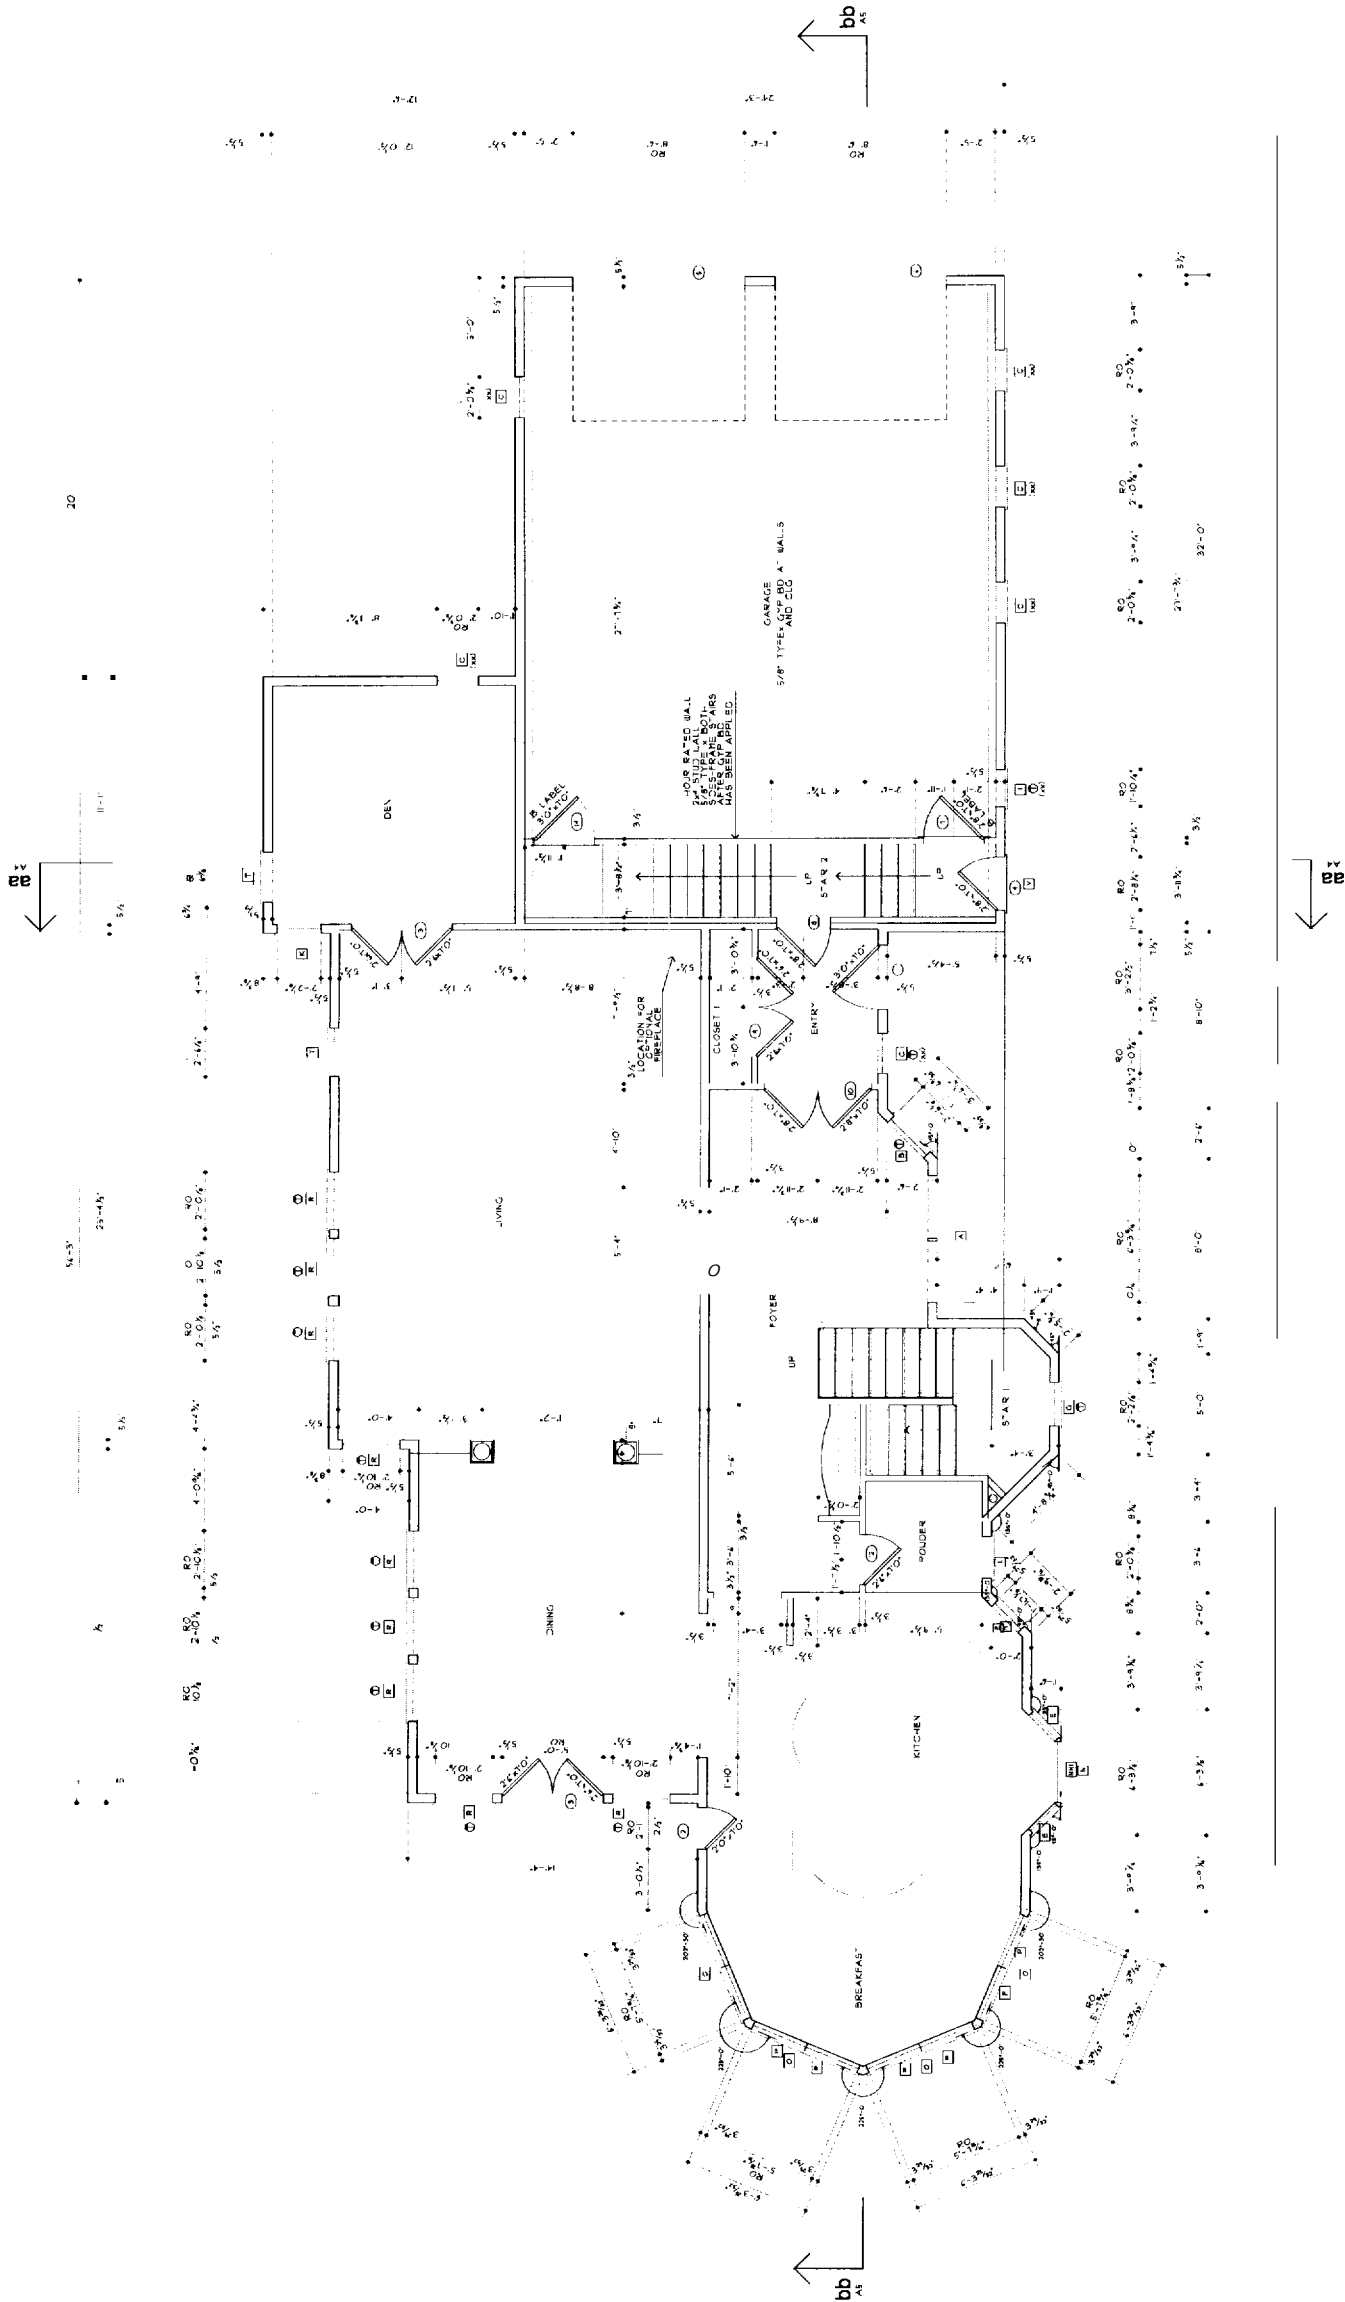


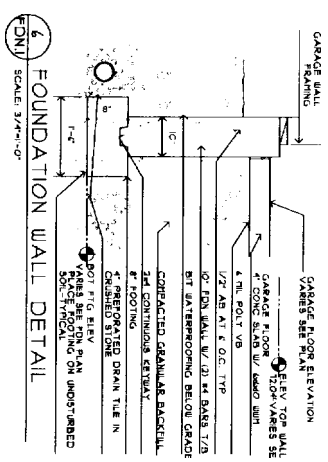

6 FOUNDATION WALL DETAIL
 FDN/ SCALE: 3/4\"/>

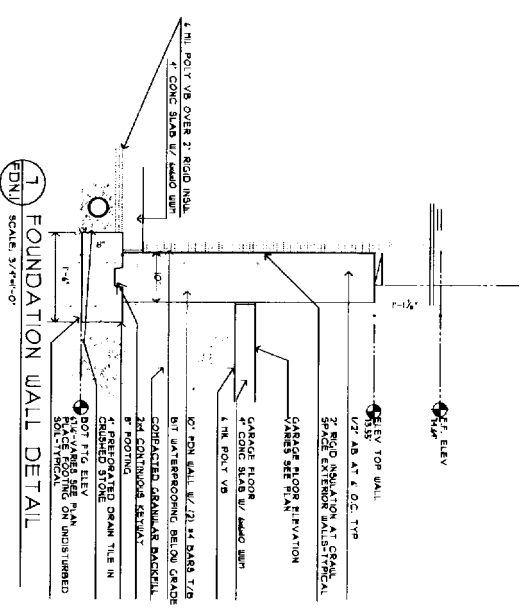

7 FOUNDATION WALL DETAIL
 FDN/ SCALE: 3/4\"/>

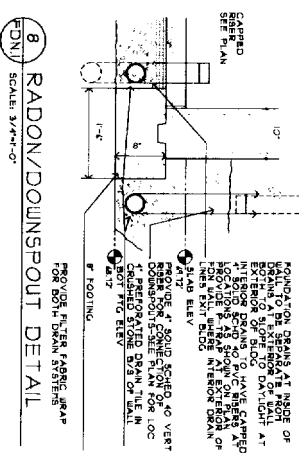

8 RADON/DOWNSPOUT DETAIL
 FDN/ SCALE: 3/4\"/>

GTA2 architects
 44 OR BLDG
 PORTLAND, ME 04101
 207.771.5481 fax: 774.0948

DESIGNER
 DATE
 MAY 2005
 PROJECT
 FOUNDATION DETAILS

SCALE
 AS NOTED
 DRAWN BY
 SMT
 PROJECT NUMBER
 0208

PROJECT USE
FDN 2