



REPLY TO ATTENTION OF

DEPARTMENT OF THE ARMY
NEW ENGLAND DISTRICT, CORPS OF ENGINEERS
696 VIRGINIA ROAD
CONCORD, MASSACHUSETTS 01742-2751

MAINE GENERAL PERMIT (GP)
AUTHORIZATION LETTER AND SCREENING SUMMARY

City of Portland Department of Public Services
c/o Nathaniel Smith Project Manager
55 Portland Street
Portland, ME 04101

CORPS PERMIT # NAE-2014-00383 re-issued
CORPS PGP ID# 15-461
STATE ID# L-26292-TF-A-N

DESCRIPTION OF WORK:

DOA permit issued 2- July 2014 previously authorized placement of fill in 107,700 SF (2.47 acres) of wetland and waterway in conjunction with mechanical excavation of cattails and sediments to increase open water habitat and enhance the perimeter of the pond by reconstructing it to shrub scrub wetlands. The project will also includes 1.02 acres of riparian wetland creation around the edge of the pond. See additional Description of work and Attached Conditions:

LAT/LONG COORDINATES : 43.666305 N 70.30778 W USGS QUAD: ME- Portland West

I. CORPS DETERMINATION:

Based on our review of the information you provided, we have determined that your project will have only minimal individual and cumulative impacts on waters and wetlands of the United States. Your work is therefore authorized by the U.S. Army Corps of Engineers under the enclosed Federal Permit, the Maine General Permit (GP). Accordingly, we do not plan to take any further action on this project.

You must perform the activity authorized herein in compliance with all the terms and conditions of the GP [including any attached Additional Conditions and any conditions placed on the State 401 Water Quality Certification including any required mitigation]. Please review the enclosed GP carefully, including the GP conditions beginning on page 5, to familiarize yourself with its contents. You are responsible for complying with all of the GP requirements; therefore you should be certain that whoever does the work fully understands all of the conditions. You may wish to discuss the conditions of this authorization with your contractor to ensure the contractor can accomplish the work in a manner that conforms to all requirements.

If you change the plans or construction methods for work within our jurisdiction, please contact us immediately to discuss modification of this authorization. This office must approve any changes before you undertake them.

Condition 41 of the GP (page 18) provides one year for completion of work that has commenced or is under contract to commence prior to the expiration of the GP on October 12, 2015. You will need to apply for reauthorization for any work within Corps jurisdiction that is not completed by October 12, 2016.

This authorization presumes the work shown on your plans noted above is in waters of the U.S. Should you desire to appeal our jurisdiction, please submit a request for an approved jurisdictional determination in writing to the undersigned.

No work may be started unless and until all other required local, State and Federal licenses and permits have been obtained. This includes but is not limited to a Flood Hazard Development Permit issued by the town if necessary.

II. STATE ACTIONS: PENDING [ X ], ISSUED[ ], DENIED [ ] DATE:

APPLICATION TYPE: PBR: TIER 1: TIER 2: TIER 3: X LURC: DMR LEASE: NA:

III. FEDERAL ACTIONS:

JOINT PROCESSING MEETING: N/A LEVEL OF REVIEW: CATEGORY 1: CATEGORY 2: X

AUTHORITY (Based on a review of plans and/or State/Federal applications): SEC 10, 404 X 10/404, 103

EXCLUSIONS: The exclusionary criteria identified in the general permit do not apply to this project.

FEDERAL RESOURCE AGENCY OBJECTIONS: EPA\_NO, USF&WS\_NO, NMFS\_NO

If you have any questions on this matter, please contact my staff at 207-623-8367 at our Manchester, Maine Project Office. In order for us to better serve you, we would appreciate your completing our Customer Service Survey located at http://per2.nwp.usace.army.mil/survey.html

Rodney A. Howe
RODNEY A. HOWE
SENIOR PROJECT MANAGER
MAINE PROJECT OFFICE

Frank J. Del Giudice
FRANK J. DEL GIUDICE
CHIEF, PERMITS & ENFORCEMENT BRANCH
REGULATORY DIVISION
DATE 2-1-2016



**US Army Corps  
of Engineers** ®  
New England District

**DESCRIPTION OF WORK CONTINUED  
DEPARTMENT OF THE ARMY  
GENERAL PERMIT  
NO. NAE-2014-00383 re-issued**

**(Description continued):**

The permit is hereby re-issued to include the placement of additional fill and removal of cattails in 1,300 SF (.03 acres) of the Rockland Avenue outfall stream channel at the inlet to Capsic Pond as shown on enclosed plans entitled "Rockland Avenue Outfall Stream Channel Extension City of Portland, Maine by Woodard & Curran 41 Hutchins Drive Portland, Maine in 2 sheets dated November 2015. The total cumulative impact is 2.50 acres.

The 2.7 acres of riparian scrub-shrub wetland will be planted with native wetland species in an effort to enhance and diversify the Inland Water bird and Waterfowl Habitat and help eliminate cattails. The remaining 8,500 CY's of excavated sediment will be dewatered on site and disposed of at a State approved upland disposal area. During construction a cofferdam will be installed at the head of the pond to divert flows to an existing 120" concrete storm drain that runs parallel to the pond and outlets downstream at the pond dam. The work is shown on the attached plans entitled "Capsic Pond Enhancements City of Portland, Maine by Woodard & Curran 41 Hutchins Drive Portland, Maine" in 10 sheets dated December 2013 revised April 1, 2014.

**SEE ATTACHED CONDITIONS:**



**US Army Corps  
of Engineers** ®  
New England District

**PLEASE NOTE THE FOLLOWING GENERAL CONDITIONS FOR  
DEPARTMENT OF THE ARMY  
GENERAL PERMIT  
NO. NAE-2014-00383**

1. The permittee shall assure that a copy of this permit is at the work site whenever work is being performed and that all personnel performing work at the site of the work authorized by this permit are fully aware of the terms and conditions of the permit. This permit, including its drawings and any appendices and other attachments, shall be made a part of any and all contracts and sub-contracts for work which affects areas of Corps of Engineers' jurisdiction at the site of the work authorized by this permit. This shall be done by including the entire permit in the specifications for the work. If the permit is issued after construction specifications but before receipt of bids or quotes, the entire permit shall be included as an addendum to the specifications. The term "entire permit" includes permit amendments. Although the permittee may assign various aspects of the work to different contractors or sub-contractors, all contractors and sub-contractors shall be obligated by contract to comply with all environmental protection provisions of the entire permit, and no contract or sub-contract shall require or allow unauthorized work in areas of Corps of Engineers jurisdiction.
2. This authorization requires you to 1) notify us before beginning work so we may inspect the project, and 2) submit a Compliance Certification Form. You must complete and return the enclosed Work Start Notification Form(s) to this office at least two weeks before the anticipated starting date. You must complete and return the enclosed Compliance Certification Form within one month following the completion of the authorized work.
3. Please note General Condition 21. Sedimentation and Erosion Control on page 11 of the attached Programmatic General Permit.
4. Dewatering of the pond shall occur during the month of May in consultation with the Maine Department of Inland Fisheries and Wildlife Region A wildlife biologist Cory Stearns and species specialist Derek Yorks to (a. Provide adequate time to trap and temporarily relocate turtles and (b. Provide additional drying time of the pond sediments prior to excavation.
5. Clearing of vegetation and excavation activities shall limited to August 15 thru November 1 to protect nesting birds and their young.
6. The permittee shall insure that their contractor hires a qualified wetland biologist to develop a 'wildlife impact mitigation and management plan' for implementation before and during construction. The contractor must receive written approval of the plan from the Maine Department of Inland Fisheries and Wildlife Regional Biologist prior to construction. The wetland biologist shall provide onsite consultation services and recommendations throughout all aspects of the mitigation and construction efforts to insure compliance with plan including all permit conditions.
7. The permittee shall implement all terms and conditions contained in the attached water quality certification from the Maine Department of Environmental Protection dated "23 May 2014". Copies of all required submittals shall also be provided to the Corps.
8. Upon completion of construction the permittee shall implement the attached "Capisic Pond Enhancement Project – Portland, Maine Monitoring and Management Plan" dated February 2014. Monitoring and remedial measures shall occur for a period of 5 years commencing with the first growing season after construction is completed as described in the monitoring plan.

**NRPA PERMIT BY RULE NOTIFICATION FORM**

(For use with DEP Regulation, Natural Resources Protection Act-Permit by Rule Standards, Chapter 305)

PLEASE TYPE OR PRINT IN **BLACK INK ONLY**

<b>Name of Applicant (owner)</b>	City of Portland, Department of Public Services, c/o Nathaniel Smith, Project Manager	<b>Name of Agent:</b>	Woodard & Curran, c/o Lauren Swett, PE		
<b>Applicant Mailing Address:</b>	55 Portland Street	<b>Agent Phone # (include area code):</b>	207-558-3763		
<b>Town/City:</b>	Portland	<b>PROJECT Information Name of Town/City:</b>	Portland		
<b>State and Zip code:</b>	Maine 04101	<b>Name of Wetland or Waterbody:</b>	Un-named Stream & Capisic Pond		
<b>Daytime Phone # (include area code):</b>	207-874-8801	<b>Map #:</b>	224A	<b>Lot #:</b>	X001
<b>Detailed Directions to Site:</b>	From the Southern Maine Regional Office, head southwest on Canco Road, and turn left onto Read Street, right onto Ocean Street, left onto Forest Avenue, right onto Woodford Street, left onto Colonial Road, and right onto Rockland Avenue to the entrance to the Capisic Pond Park.				
		<b>UTM Northing (if known)</b>		<b>UTM Easting (if known)</b>	
<b>Description of Project:</b>	Improvements include the stabilization of the channel downstream of the pedestrian bridge using natural rounded river stone and gravel to match upstream channel, and the removal and disposal of cattails.				
<b>Part of a larger project? (check one) →</b>	<input checked="" type="checkbox"/> Yes <input type="checkbox"/> No	<b>After the Fact? (check one) →</b>	<input type="checkbox"/> Yes <input checked="" type="checkbox"/> No	<b>Check one →</b> This project <input type="checkbox"/> does (or) <input checked="" type="checkbox"/> does not involve work below mean low water (average low water).	

**NRPA PERMIT BY RULE (PBR) SECTIONS: (Check at least one)**

I am filing notice of my intent to carry out work which meets the requirements for Permit By Rule (PBR) under DEP Rules, Chapter 305. I and my agents, if any, **have read** and will comply with all of the standards in the Sections checked below.


- |   |  |   |
|---|--|---|
| <input type="checkbox"/> Sec. (2) Act. Adj. to Protected Natural Res. | <input type="checkbox"/> Sec. (10) Stream Crossing   | <input type="checkbox"/> Sec. (17) Transfers/Permit Extension   |
| <input type="checkbox"/> Sec. (3) Intake Pipes                        | <input type="checkbox"/> Sec. (11) State Transportation Facil.                               | <input type="checkbox"/> Sec. (18) Maintenance Dredging   |
| <input type="checkbox"/> Sec. (4) Replacement of Structures           | <input type="checkbox"/> Sec. (12) Restoration of Natural Areas                              | <input type="checkbox"/> Sec. (19) Activities in/on/over significant vernal pool habitat  |
| <input type="checkbox"/> Sec. (5) REPEALED                            | <input checked="" type="checkbox"/> Sec. (13) F&W Creation/Enhance/Water Quality Improvement | <input checked="" type="checkbox"/> Sec. (20) Activities located in/on/over high or moderate value inland water-fowl & wading bird habitat or shore-bird feeding & roosting areas |
| <input type="checkbox"/> Sec. (6) Movement of Rocks or Vegetation     | <input type="checkbox"/> Sec. (14) REPEALED  |   |
| <input type="checkbox"/> Sec. (7) Outfall Pipes                       | <input type="checkbox"/> Sec. (15) Public Boat Ramps   |   |
| <input type="checkbox"/> Sec. (8) Shoreline stabilization             | <input type="checkbox"/> Sec. (16) Coastal Sand Dune Projects                                |   |
| <input type="checkbox"/> Sec. (9) Utility Crossing                    |  |   |

**NOTIFICATION FORMS CANNOT BE ACCEPTED WITHOUT THE NECESSARY ATTACHMENTS:**

- Attach** a check for the correct fee, payable to: "Treasurer, State of Maine". The current fee for NRPA PBR Notifications can be found at the Department's website: <http://www.maine.gov/dep/feesched.pdf>
- Attach** a U.S.G.S. topo map or Maine Atlas & Gazetteer map with the project site clearly marked.
- N/A  **Attach** Proof of Legal Name if applicant is a corporation, LLC, or other legal entity. Provide a copy of Secretary of State's registration information (available at <http://icrs.informe.org/nei-sos-icrs/ICRS?MainPage=x>). Individuals and municipalities are **not** required to provide any proof of identity,
- Attach** photos of the proposed site where activity will take place as required in PBR Sections checked above.
- Attach** all other required submissions as outlined in the PBR Sections checked above.

I authorize staff of the Departments of Environmental Protection, Inland Fisheries & Wildlife, and Marine Resources to access the project site for the purpose of determining compliance with the rules. I also understand that **this permit is not valid until approved by the Department or 14 days after receipt by the Department, whichever is less.**


By signing this Notification Form, I represent that the project meets all applicability requirements and standards in the rule and that the applicant has sufficient title, right, or interest in the property where the activity takes place.
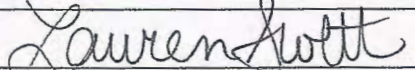
<b>Signature of Agent or Applicant:</b>		<b>Date:</b>	11/9/15
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**Keep a copy as a record of permit.** Send the form with attachments via certified mail or hand deliver to the Maine Dept. of Environmental Protection at the appropriate regional office listed below. The DEP will send a copy to the Town Office as evidence of the DEP's receipt of notification. No further authorization by DEP will be issued after receipt of notice. Permits are valid for two years. **Work carried out in violation of any standard is subject to enforcement action.**

- |  |   |   |   |
|--|---|---|---|
| AUGUSTA DEP<br>17 STATE HOUSE STATION<br>AUGUSTA, ME 04333-0017<br>(207)287-3901 | PORTLAND DEP<br>312 CANCO ROAD<br>PORTLAND, ME 04103<br>(207)822-6300 | BANGOR DEP<br>106 HOGAN ROAD<br>BANGOR, ME 04401<br>(207)941-4570 | PRESQUE ISLE DEP<br>1235 CENTRAL DRIVE<br>PRESQUE ISLE, ME 04769<br>(207)764-0477 |
|--|---|---|---|

OFFICE USE ONLY	Ck.#	Date	Staff	Staff	
PBR #	FP		Acc. Date	Def. Date	After Photos

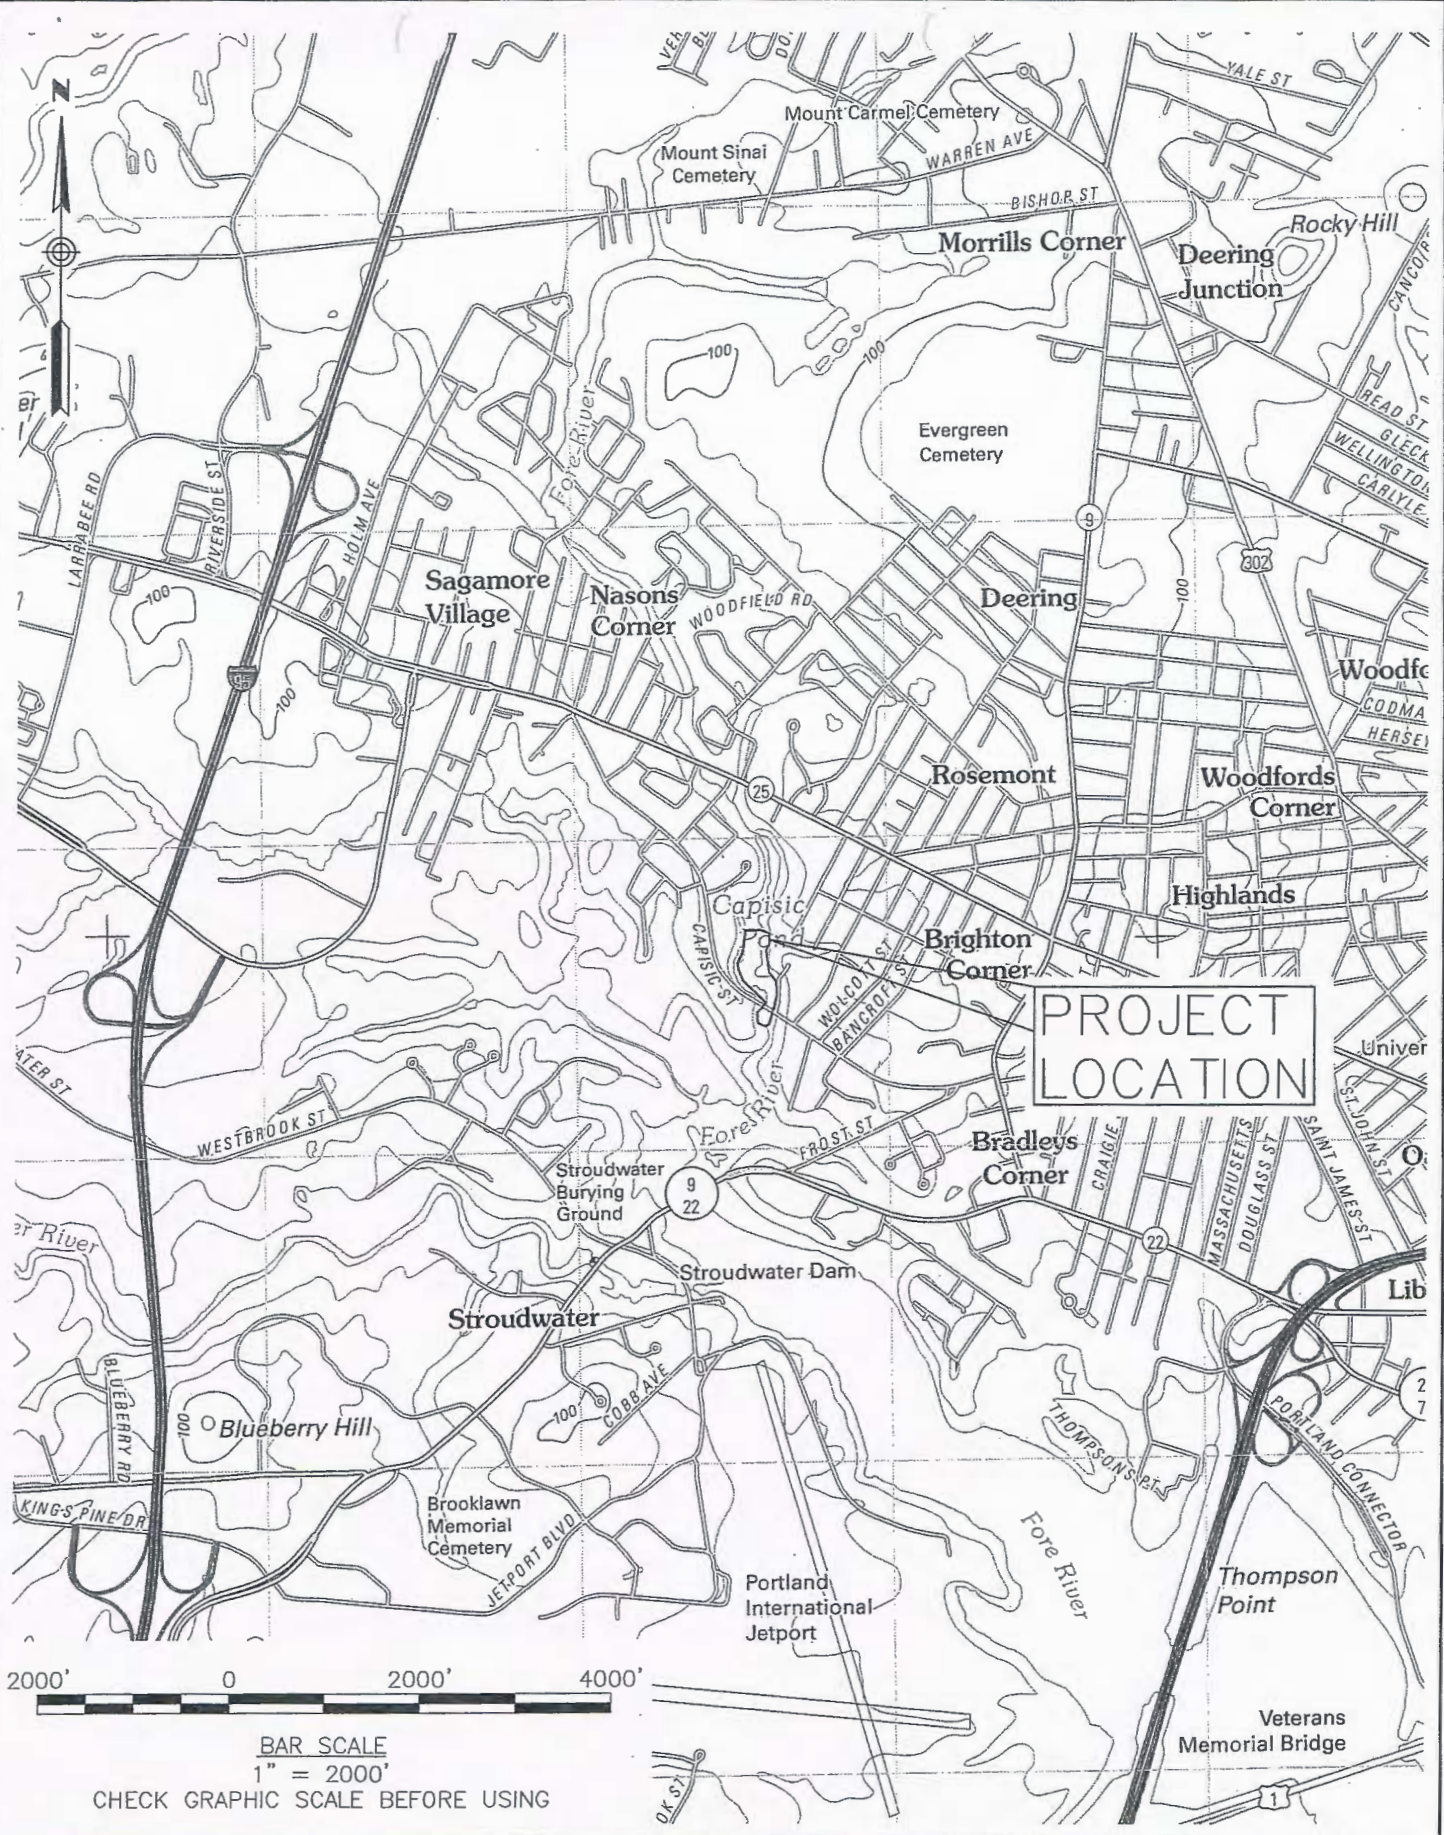


41 Hutchins Drive  
 Portland, Maine 04102  
 800.426.4262 | www.woodardcurran.com

COMMITMENT & INTEGRITY DRIVE RESULTS

**PROJECT LOCATION MAP**

DESIGNED BY: N/A	CHECKED BY: LJS
DRAWN BY: BCM	225672.77 SITE LOCATION.dwg

CITY OF PORTLAND  
 PORTLAND, MAINE

CAPISIC POND ENHANCEMENTS

JOB NO: 225672.77  
 DATE: NOVEMBER 2013  
 SCALE: 1"=2000'

**FIG. 3**

EXISTING MANHOLE  
STRUCTURE FOR 120"  
STORM DRAIN

OUTFALL STABILIZATION WORK  
COMPLETED IN 2014 PERMITTED  
UNDER NRPA PBR JAN. 2014  
ACOE NAE-2011-02437

ROCKLAND AVENUE OUTFALL  
LOCATED ABOVE

EXISTING 60"  
HDPP COMBINED  
SEWER

PROTECT EXISTING  
BRIDGE DURING  
CONSTRUCTION

CAPISIC BROOK

STABILIZE CHANNEL WITH NATURAL  
RIVER STONE AND GRAVEL TO MATCH  
CHANNEL UPSTREAM OF BRIDGE, IN  
ACCORDANCE WITH SPECIFICATIONS

REMOVE & DISPOSE OF  
CATTAILS

ACTION REQUESTED  
UNDER THIS PBR

PROTECT EXISTING 120"SD  
& 60"HDPP

EXISTING 120"  
STORM DRAIN

FUTURE POND ENHANCEMENT  
WORK, PERMITTED UNDER NRPA  
DEP #L-26292-TF-A-N/  
L-26292-1W-B-N  
ACOE NAE-2014-00383

# ROCKLAND OUTFALL STREAM CHANNEL EXTENSION


SCALE: 1"=40'

NOTE: SEE CAPISIC POND  
ENHANCEMENT PLANS FOR COMPLETE  
PROJECT AREA.



BAR SCALE  
1" = 40'

CHECK GRAPHIC SCALE BEFORE USING

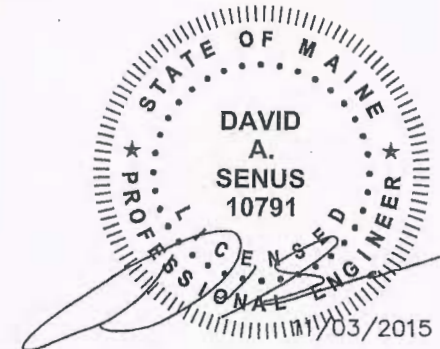

JOB NO: 225672.77  
DATE: NOVEMBER 2015  
SCALE: SCALE

Fig. 1

CITY OF PORTLAND  
PORTLAND, MAINE

ROCKLAND AVE.  
OUTFALL IMPROVEMENTS


ROCKLAND AVENUE OUTFALL  
STREAM CHANNEL EXTENSION

DESIGNED BY: LJS  
CHECKED BY: DAS  
DRAWN BY: BCM  
225672.77\_C10x.dwg

41 Huchins Drive  
Portland, Maine 04112  
800.426.4262 | www.woodardcurran.com

COMMITMENT & INTEGRITY DRIVE RESULTS




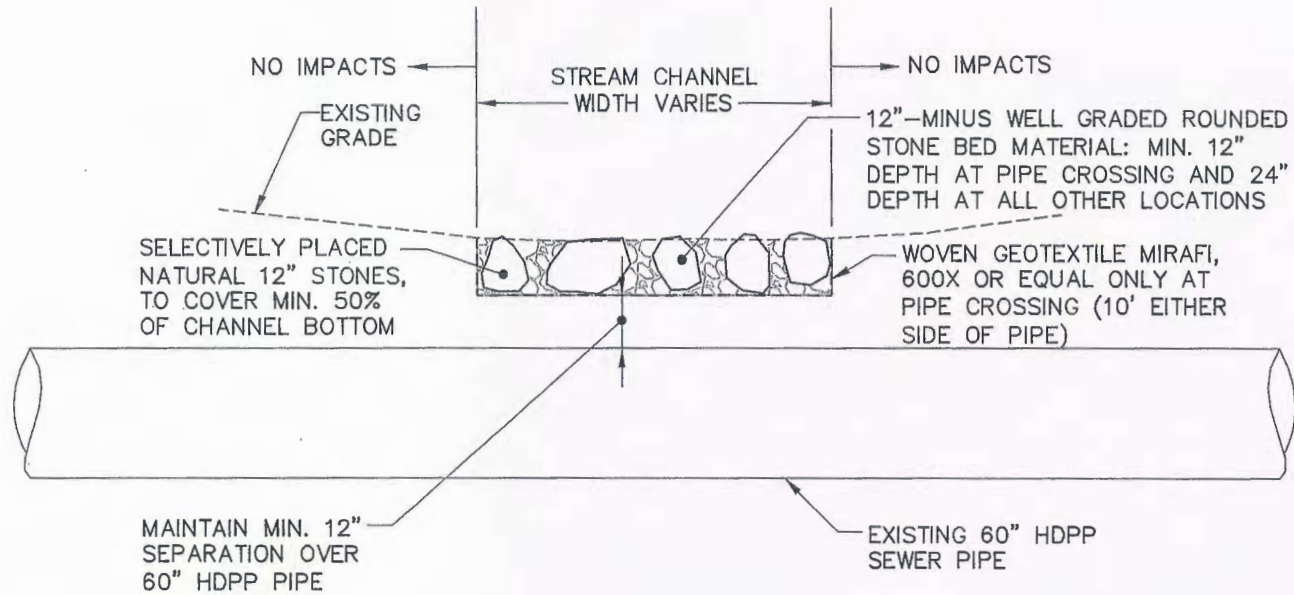

# ROCKLAND AVE. OUTFALL STREAM CHANNEL DETAIL

N.T.S.

NOTE: SEE CAPSIC POND ENHANCEMENT PLANS FOR COMPLETE PROJECT AREA.

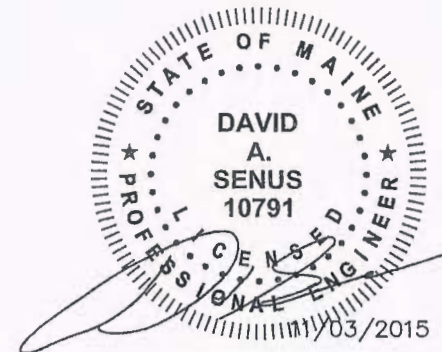

JOB NO. 225572.77  
 DATE: NOVEMBER 2015  
 SCALE: SCALE

Fig. 2

CITY OF PORTLAND  
 PORTLAND, MAINE


ROCKLAND AVE.  
 OUTFALL IMPROVEMENTS

ROCKLAND AVENUE OUTFALL  
 STREAM CHANNEL EXTENSION  
 DETAIL

DESIGNED BY: LJS  
 DRAWN BY: BCM  
 CHECKED BY: DAS  
 225572.77 CDR.dwg

41 Hutchins Drive  
 Portland, Maine 04102  
 800.426.4262 | www.woodardcurran.com  
 COMMITMENT & INTEGRITY DRIVE RESULTS



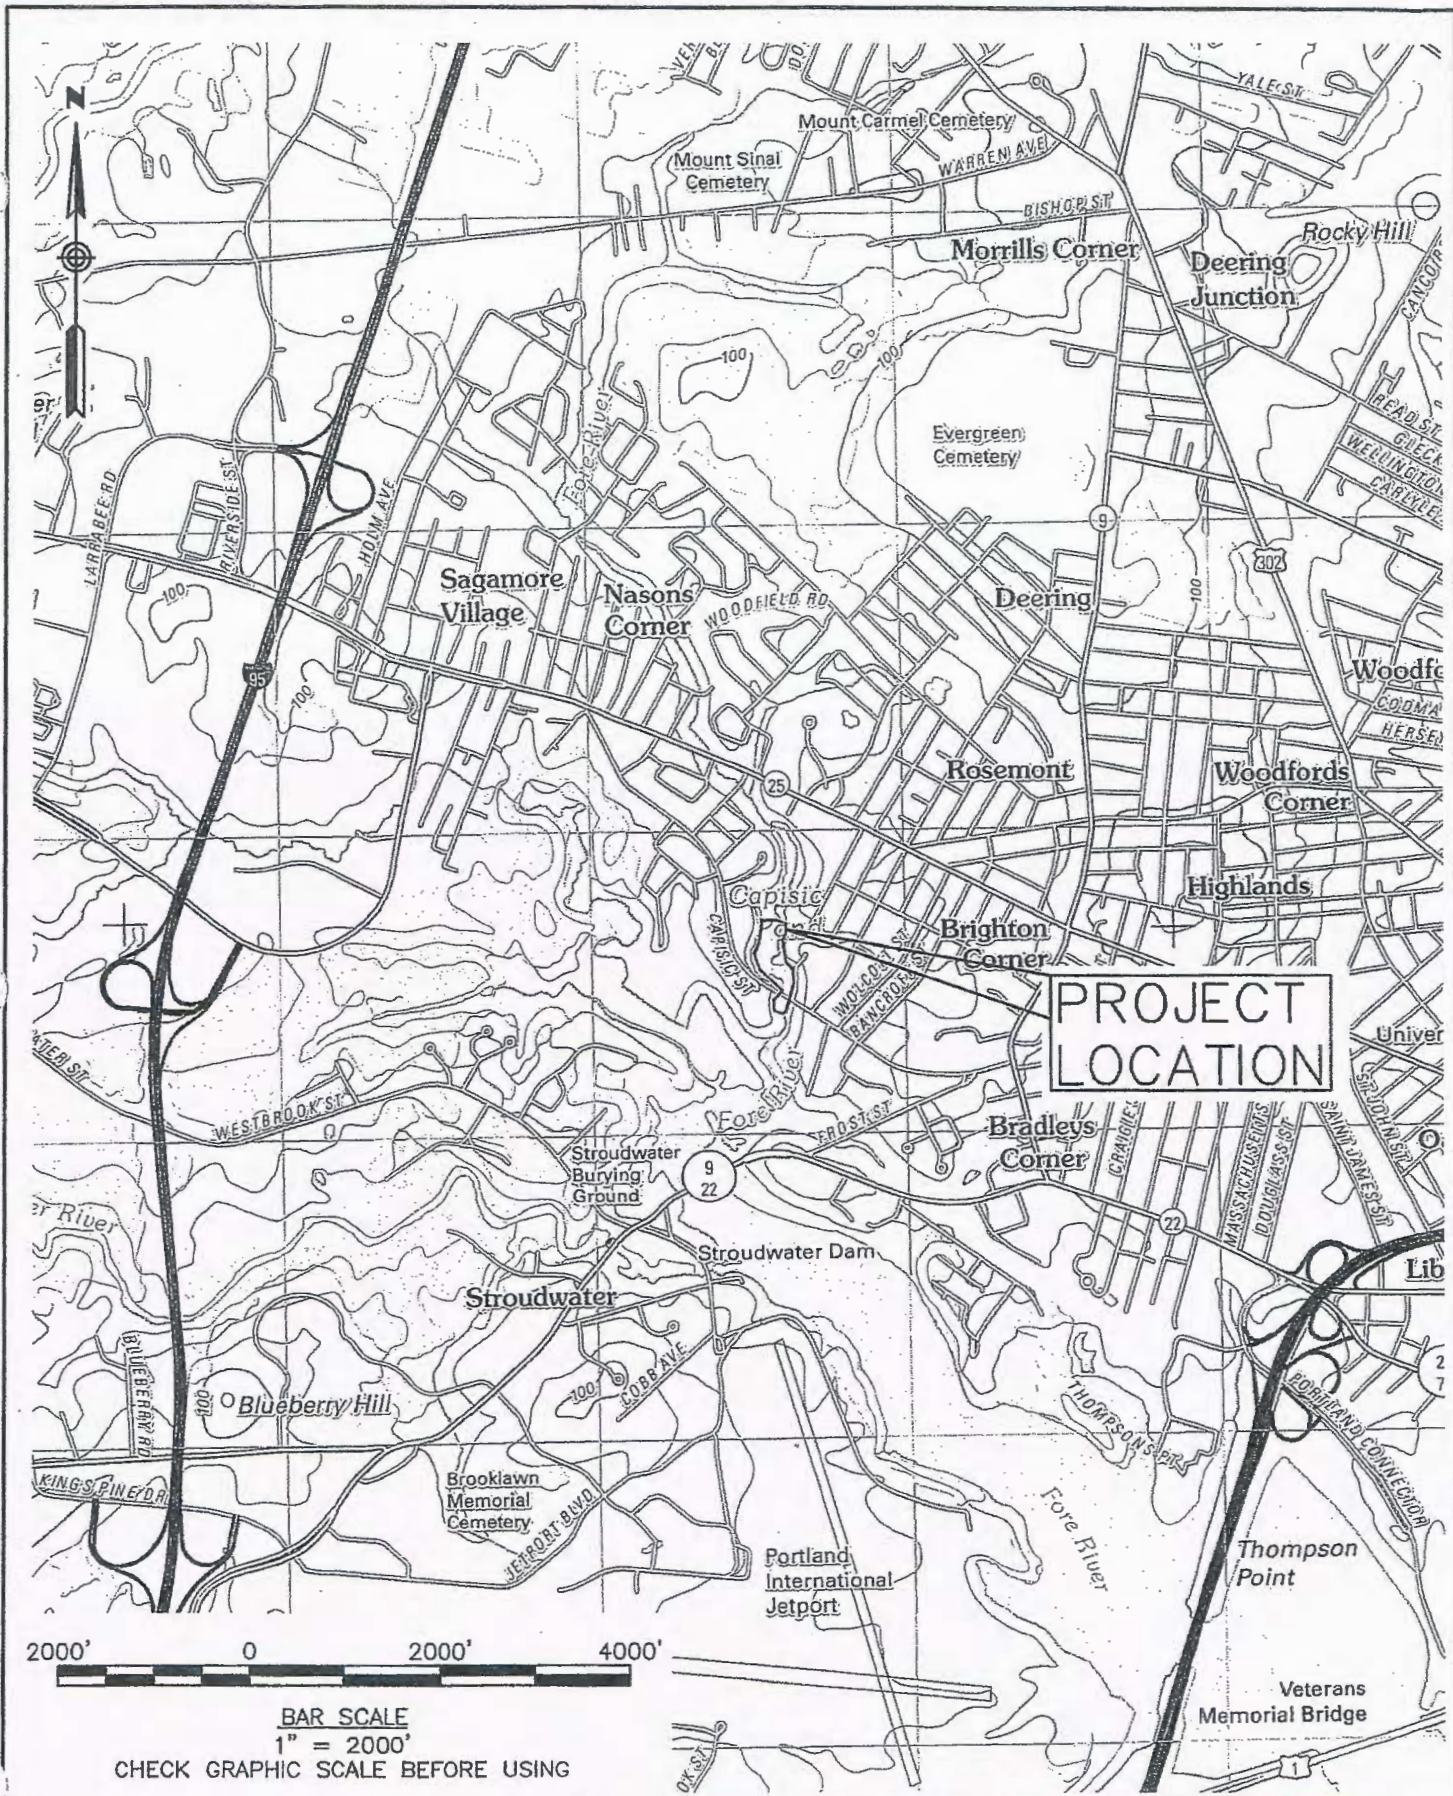


41 Hutchins Drive  
Portland, Maine 04102  
800.426.4282 | www.woodardcurran.com

COMMITMENT & INTEGRITY DRIVE RESULTS

**PROJECT LOCATION MAP**

DESIGNED BY: N/A	CHECKED BY: LJS
DRAWN BY: BCM	225672.77 SITE LOCATION*.dwg

CITY OF PORTLAND  
PORTLAND, MAINE

CAPISIC POND ENHANCEMENTS

JOB NO: 225672.77  
DATE: NOVEMBER 2013  
SCALE: 1"=2000'

**FIG. 1**



# CAPISIC POND ENHANCEMENTS


## CITY OF PORTLAND

### PORTLAND, MAINE

DECEMBER 2013



DRAWING INDEX		
Sheet Number	Sheet Title	Sheet Description
1	COVER	
2	C-001	GENERAL NOTES, LEGEND & ABBREVIATIONS
3	C-002	GENERAL CONDITIONS
4	C-003	CONSTRUCTION PLAN
5	C-004	POND CRANE SECTION - 1
6	C-005	POND CRANE SECTION - 2
7	C-006	LANDSCAPE PLAN POND ENHANCEMENTS
8	C-007	LANDSCAPE DETAILS
9	C-008	SEE DETAIL - 1
10	C-009	SEE DETAIL - 2

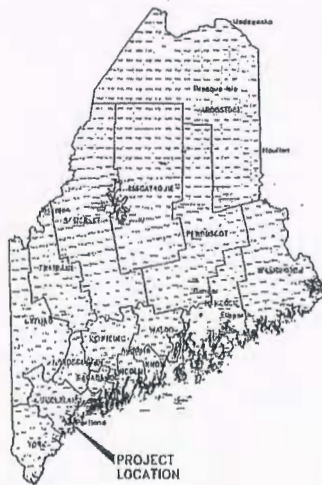

PROJECT LOCATION MAP  
DATE

## PERMIT REVIEW SET

### NOT FOR CONSTRUCTION




41 Hutchins Drive  
Portland, Maine 04102  
800.426.4262 | www.woodardcurran.com

COMMITMENT & INTEGRITY DRIVE RESULTS



SITE LOCATION MAP

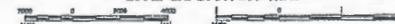



DATE OF ISSUE	NO. OF SHEETS
DATE OF REVISION	NO. OF SHEETS
DATE OF REVISION	NO. OF SHEETS
DATE OF REVISION	NO. OF SHEETS

EXISTING CONDITIONS

PROJECT NO.	DATE
PROJECT NAME	DATE
PROJECT LOCATION	DATE
PROJECT DESCRIPTION	DATE



WOODARD & CURRIAN, INC.  
 PROFESSIONAL ENGINEERS  
 10000  
 STATE OF MARYLAND  
 LICENSE NO. 10000  
 10000  
 10000




PERMIT REVIEW SET - NOT FOR CONSTRUCTION



DATE: 10/15/11	SCALE: 1"=20' VERT. 1"=10'
DATE: 10/15/11	SCALE: 1"=20' VERT. 1"=10'
DATE: 10/15/11	SCALE: 1"=20' VERT. 1"=10'
DATE: 10/15/11	SCALE: 1"=20' VERT. 1"=10'

POND CROSS SECTIONS - 1

WOODWARD CLARK & CURRAN  
 ENGINEERS & ARCHITECTS  
 4110 15th Street  
 Denver, CO 80202  
 (303) 733-1100  
 www.woodwardclark.com

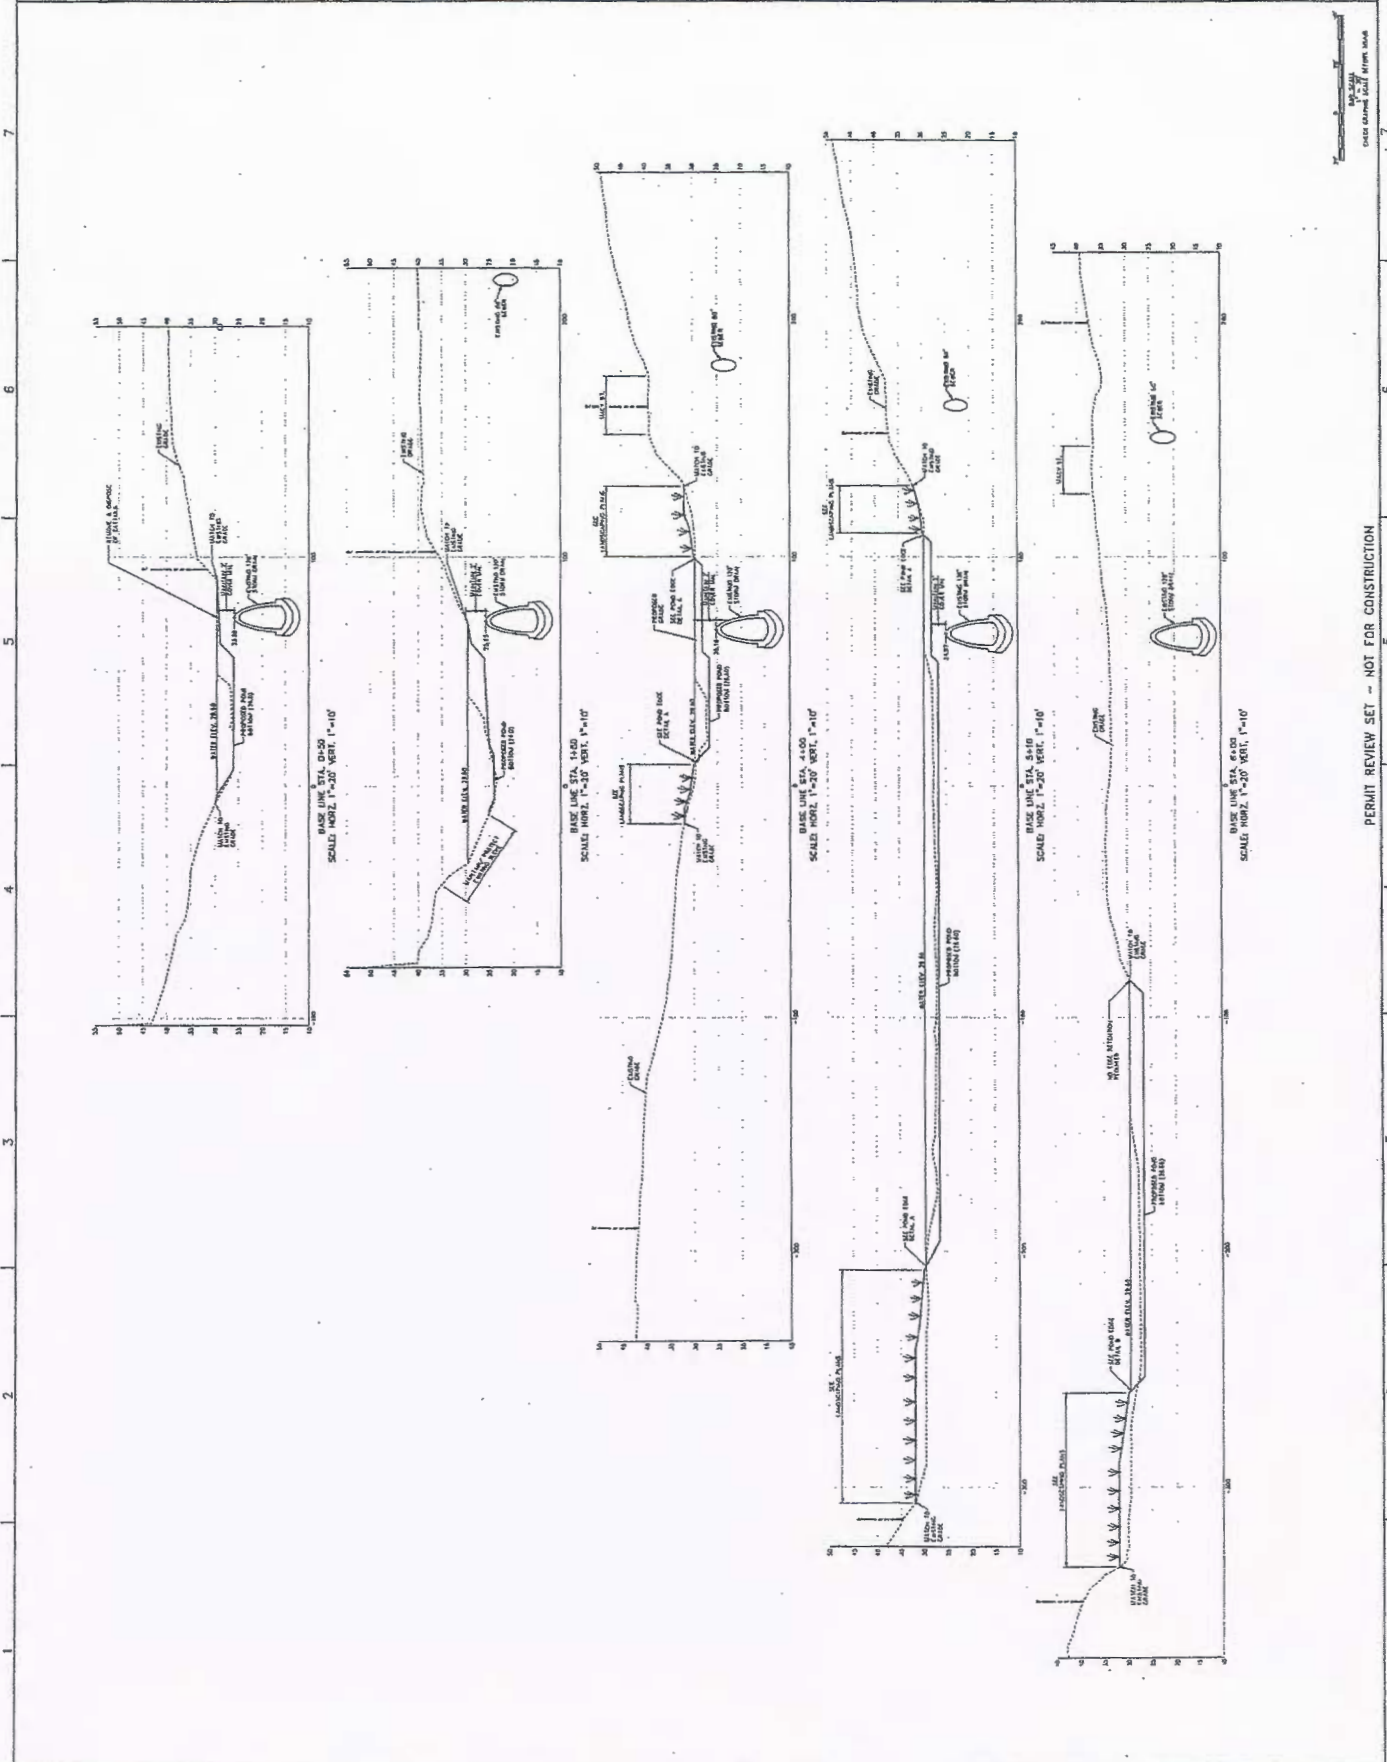

PERMIT REVIEW SET - NOT FOR CONSTRUCTION

DATE: 10/15/11  
 SCALE: 1"=20' VERT. 1"=10'





NO.	DESCRIPTION	DATE	BY	CHKD.
1	ISSUED FOR PERMIT	12/15/2023	JSM	WJC
2	REVISED PER PLAN CHANGES	12/15/2023	JSM	WJC
3	REVISED PER PLAN CHANGES	12/15/2023	JSM	WJC
4	REVISED PER PLAN CHANGES	12/15/2023	JSM	WJC
5	REVISED PER PLAN CHANGES	12/15/2023	JSM	WJC
6	REVISED PER PLAN CHANGES	12/15/2023	JSM	WJC
7	REVISED PER PLAN CHANGES	12/15/2023	JSM	WJC
8	REVISED PER PLAN CHANGES	12/15/2023	JSM	WJC
9	REVISED PER PLAN CHANGES	12/15/2023	JSM	WJC
10	REVISED PER PLAN CHANGES	12/15/2023	JSM	WJC

PERMIT REVIEW SET - NOT FOR CONSTRUCTION











**US Army Corps  
of Engineers**®  
New England District

Minimum Notice: Permittee must sign and return notification  
within one month of the completion of work.)

**COMPLIANCE CERTIFICATION FORM**

Corps of Engineers Permit No: NAE-2014-00383

Name of Permittee: City of Portland Department of Public Services

Permit Issuance Date: \_\_\_\_\_

Please sign this certification and return it to the following address upon completion of the activity and any mitigation required by the permit. You must submit this after the mitigation is complete, but not the mitigation monitoring, which requires separate submittals.

\*\*\*\*\*

\* MAIL TO: U.S. Army Corps of Engineers, New England District \*  
\* Policy Analysis/Technical Support Branch, ATTN: PAS\*  
\* Regulatory Division \*  
\* 696 Virginia Road \*  
\* Concord, Massachusetts 01742-2751 \*

\*\*\*\*\*

Please note that your permitted activity is subject to a compliance inspection by an U.S. Army Corps of Engineers representative. If you fail to comply with this permit you are subject to permit suspension, modification, or revocation.

**I hereby certify that the work authorized by the above referenced permit was completed in accordance with the terms and conditions of the above referenced permit, and any required mitigation was completed in accordance with the permit conditions.**

\_\_\_\_\_  
*Signature of Permittee*

\_\_\_\_\_  
*Date*

\_\_\_\_\_  
Printed Name

\_\_\_\_\_  
Date of Work Completion

( ) ( ) \_\_\_\_\_

*Telephone Number Telephone Number*



**US Army Corps  
of Engineers®**  
New England District

**WORK-START NOTIFICATION FORM**  
(Minimum Notice: Two weeks before work begins)

\*\*\*\*\*  
 \* MAIL TO: U.S. Army Corps of Engineers, New England District \*  
 \* Policy Analysis/Technical Support Branch \*  
 \* Regulatory Division \*  
 \* 696 Virginia Road \*  
 \* Concord, Massachusetts 01742-2751 \*  
 \*\*\*\*\*

Corps of Engineers Permit No. NAE-2014-00383 was issued to the City of Portland Department of Public Services. The permit authorized the permittee to excavate approximately 16,000 cy's of sediment and cattails from 304,800 SF (7.0 acres) and 52,500 SF(1.2 acres) of upland in and adjacent to Capisic Pond to a depth of 29.60 NGVD (-3') in conjunction with enhancing/restoring the open water area of Capisic Pond. The work also includes placing approximately 7,500 cy's of dredged material in 115,600 SF (2.65 acres) of wetland/waterway and 44,600SF (1.02 acres) of excavated upland area around the edge of the pond to create approximately 2.7 acres of riparian scrub-shrub wetland around the reestablished 4.5 acres of open water. The 2.7 acres of riparian scrub-shrub wetland will be planted with native wetland species in an effort to enhance and diversify the Inland Waterbird and Waterfowl Habitat and help eliminate cattails. The permit is re-issued to include the placement of additional fill and removal of cattails in 1,300 SF (.03 acres) of the Rockland Avenue outfall stream channel at the inlet to Capsic Pond as shown on enclosed plans entitled ¿Rockland Avenue Outfall Stream Channel Extension City of Portland, Maine by Woodard & Curran 41 Hutchins Drive Portland, Maine in 2 sheets dated November 2015. The total cumulative impact is 2.50 acres The people (e.g., contractor) listed below will do the work, and they understand the permit's conditions and limitations.

**PLEASE PRINT OR TYPE**

**Name of Person/Firm:** \_\_\_\_\_

**Business Address:** \_\_\_\_\_  
 \_\_\_\_\_

**Telephone Numbers:** ( ) \_\_\_\_\_ ( ) \_\_\_\_\_

**Proposed Work Dates:** Start \_\_\_\_\_ Finish \_\_\_\_\_

**Permittee's Signature:** \_\_\_\_\_ **Date:** \_\_\_\_\_

**Printed Name:** \_\_\_\_\_ **Title:** \_\_\_\_\_

\*\*\*\*\*

**FOR USE BY THE CORPS OF ENGINEERS**

**PM:** Howe **Submittals Required:** \_\_\_\_\_

**Inspection Recommendation:** \_\_\_\_\_