THE SAO RESIDENCE PORTLAND, MAINE

<u>Drawing List</u>

<u>Building Information</u>

A1 COVER SHEET / GENERAL NOTES A2 FLOOR PLANS A3 BUILDING ELEVATIONS

A4 SECTIONS AND DETAILS

768 sq ft First Floor Second Floor (GARAGE) 768 sq ft Total 1,536 sq ft

Building Height 24'-0"

Code Requirements

R301.2.3 Snow Loads The ground and roof snow load for this region is 60#/sf&42#/sf.

R301.2.4 floodplain Construction The site of this building is not located in a floodplain

R301.5 Live Load The building has been designed to support the live loads from table 301.5

R301.6 Roof Load This building has been designed to support the snow loads of 42#/sf

R310 Emergency Escape and Rescue Openings Every living room and sleeping room in this residence has been designed with an emergency escape window or door as required.

Chapter 10 Fire Supression Uponer Residential Sprinkler System By G.C. R311 Means of Egress

The means of egress for this residence have been designed to meet the requirements of this

R311.2.2 Under Stair Protection

The accessible space beneath the stairs will be sheathed with min $\frac{1}{2}$ " GWB.

R311.3 Hallways Hallways area a min. 36" wide

R311.5 Stairways Stairways are a min. 36" wide Headroom is a min. 6'-8"Riser heights are a max. 7-3/4" Treads are a min. 10" wide The landing width is at least as wide as the stairway and is a min. 36" wide in the direction of travel.

R311.3.6 H<u>andrails</u>

Handrails will be installed on a least one wall of each stairway and shall be 34" to 38" high as measured above the nosing.

R312 Guards

Guards at porches, open sides of stairs and balconies shall be 42" high and no opening in the rail are more than 4"

R502 Wood Floor and Roof Trusses By: Aroostook trusses or Similar

Refer to table R602.3 for wood fastener requirements

<u>R313 Smoke Alarms</u>

Smoke alarms shall be installed: in each sleeping room outside each sleeping area On each additional story, including the basement Carbon Monoxide monitors shall be installed in ea. area giving access to bedrooms. Alarms shall be installed per NFPA 72

R315 Flame Spread and Smoke Density

Finishes shall have a flame spread classification of no greater than 200 and a smoke-developed index of no greater than 450.

Chapter 11 Energy Efficiency

Roofs shall have a min. rating of R-38 (R60 ACTUAL) Exterior walls shall have a min. rating of R-21(R-34)Floors above garage spaces shall have a min. rating of R-21(R-54)

Floors above basement spaces shall have a min. rating Windows shall have a U-facor of 0.35 (0.21)

ASPHALT -SHINGLES -1X VINYL TRIM - VINYL SIDING OR PER BUILDER FINISH GRADE PROPERTY OF THE P

PROPERTY OF

SAO RESIDENCE PORTLAND, MAINE

SHE COVER

TOWN: PORTLAND DATE: 10-12-2017

SCALE: AS NOTED

DESIGNED: SSA

DRAWN: SSA

COVER SHEET

TITLE:

SHEET: A1



FRONT ELEVATION SCALE: 1/4"=1'-0"



REAR ELEVATION

SCALE: 1/4"=1'-0"



RIGHT SIDE ELEVATION SCALE: 1/4"=1'-0"



LEFT SIDE ELEVATION SCALE: 1/4"=1'-0"

PROPERTY OF

Stephen S. Andrews 23 Panther Pond Pines Rd. Raymond, Maine 04071 1-207-415-5605

SAO RESIDENCE PORTLAND, MAINE

ELEVATIONS BUILDING

TOWN: PORTLAND DATE: 10-12-2017


SCALE: AS NOTED


DESIGNED: SSA

DRAWN: SSA TITLE:


BUILDING ELEVATIONS

SHEET: A2

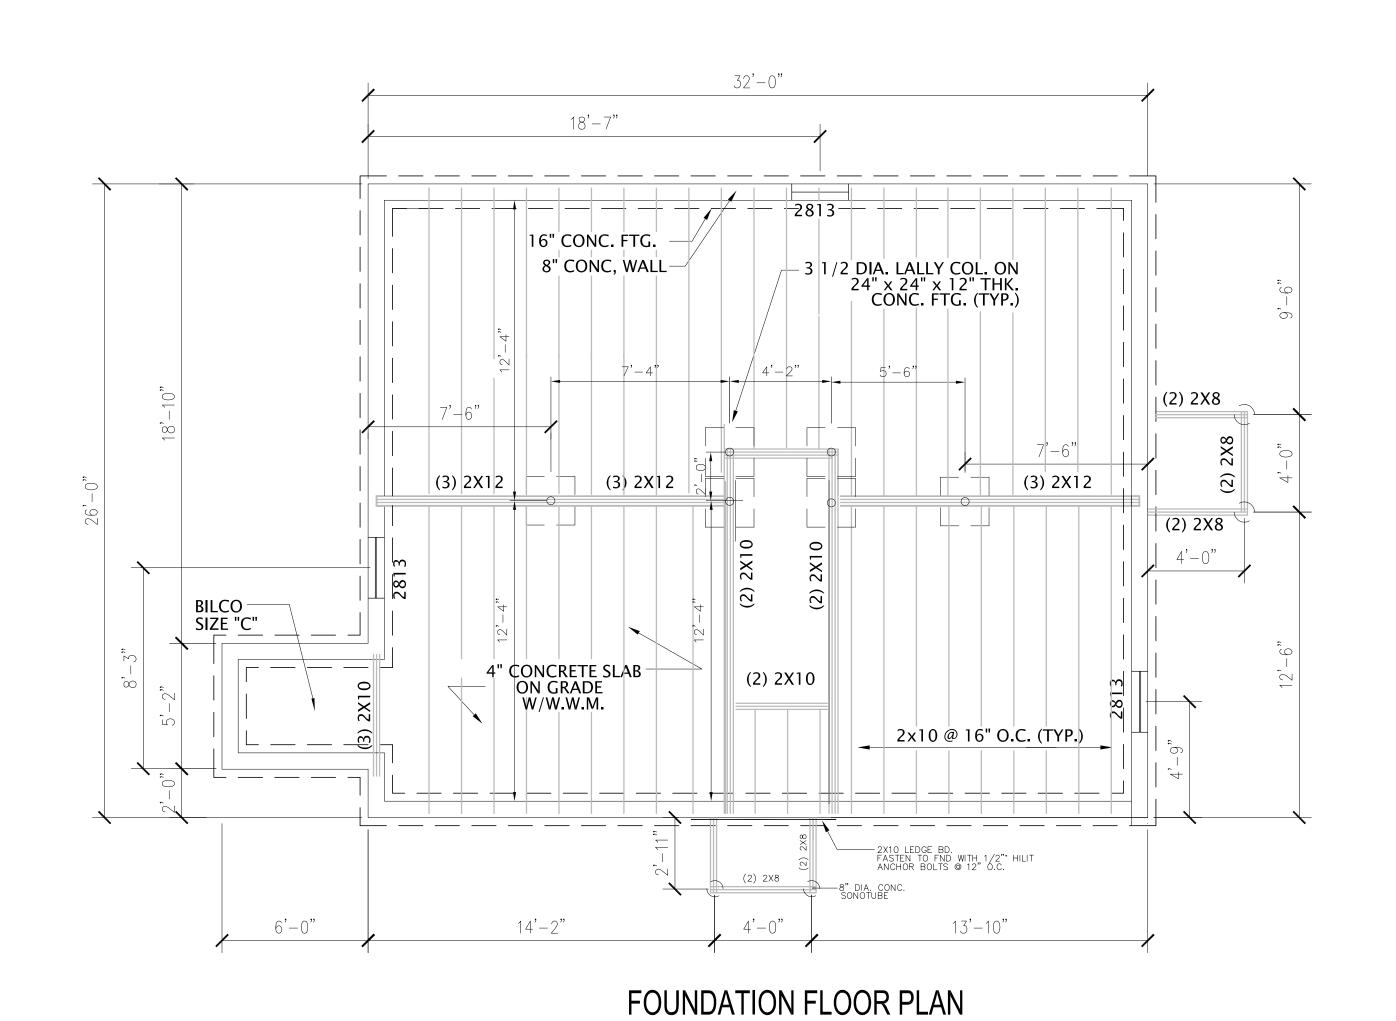

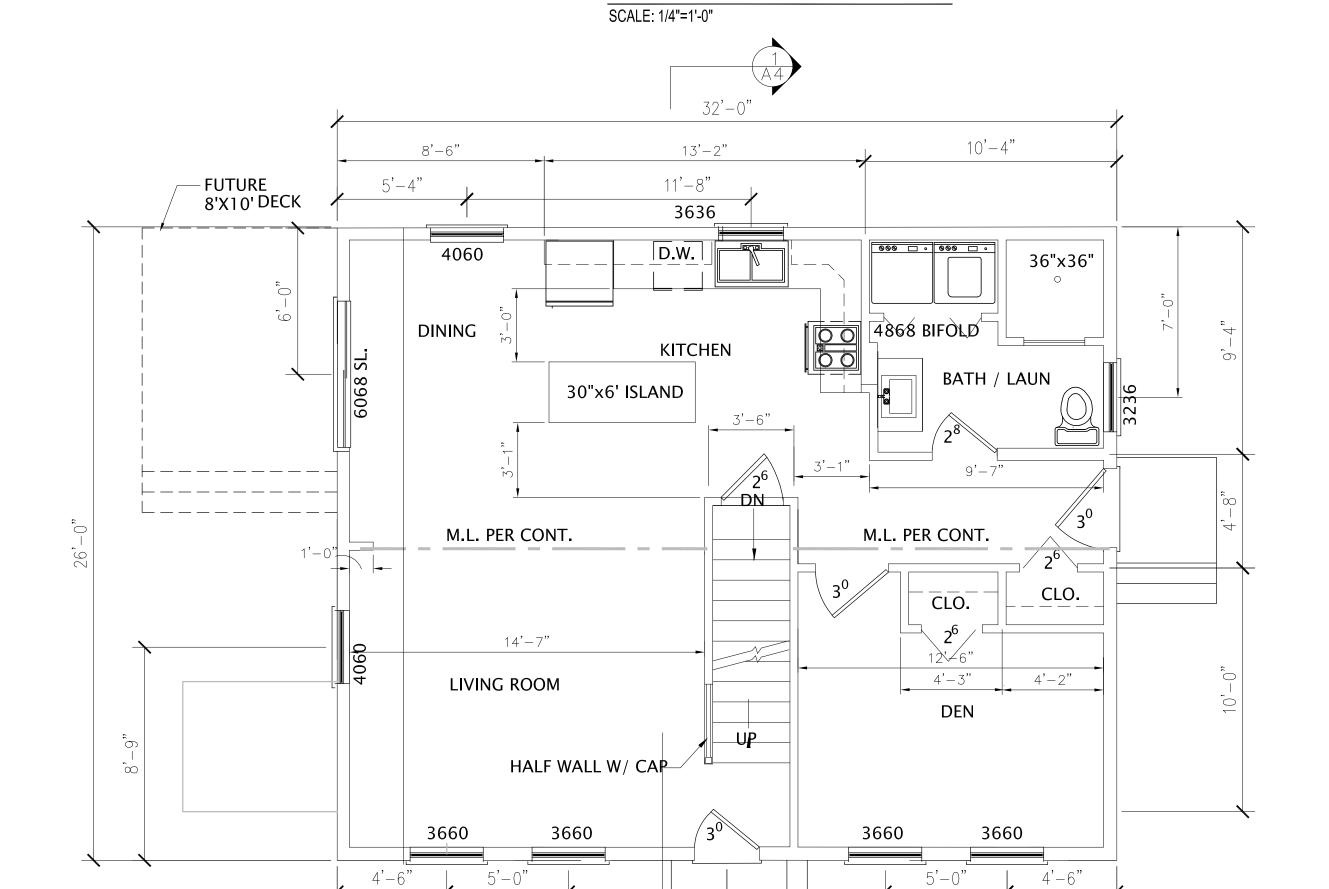

1ST FLOOR PLAN

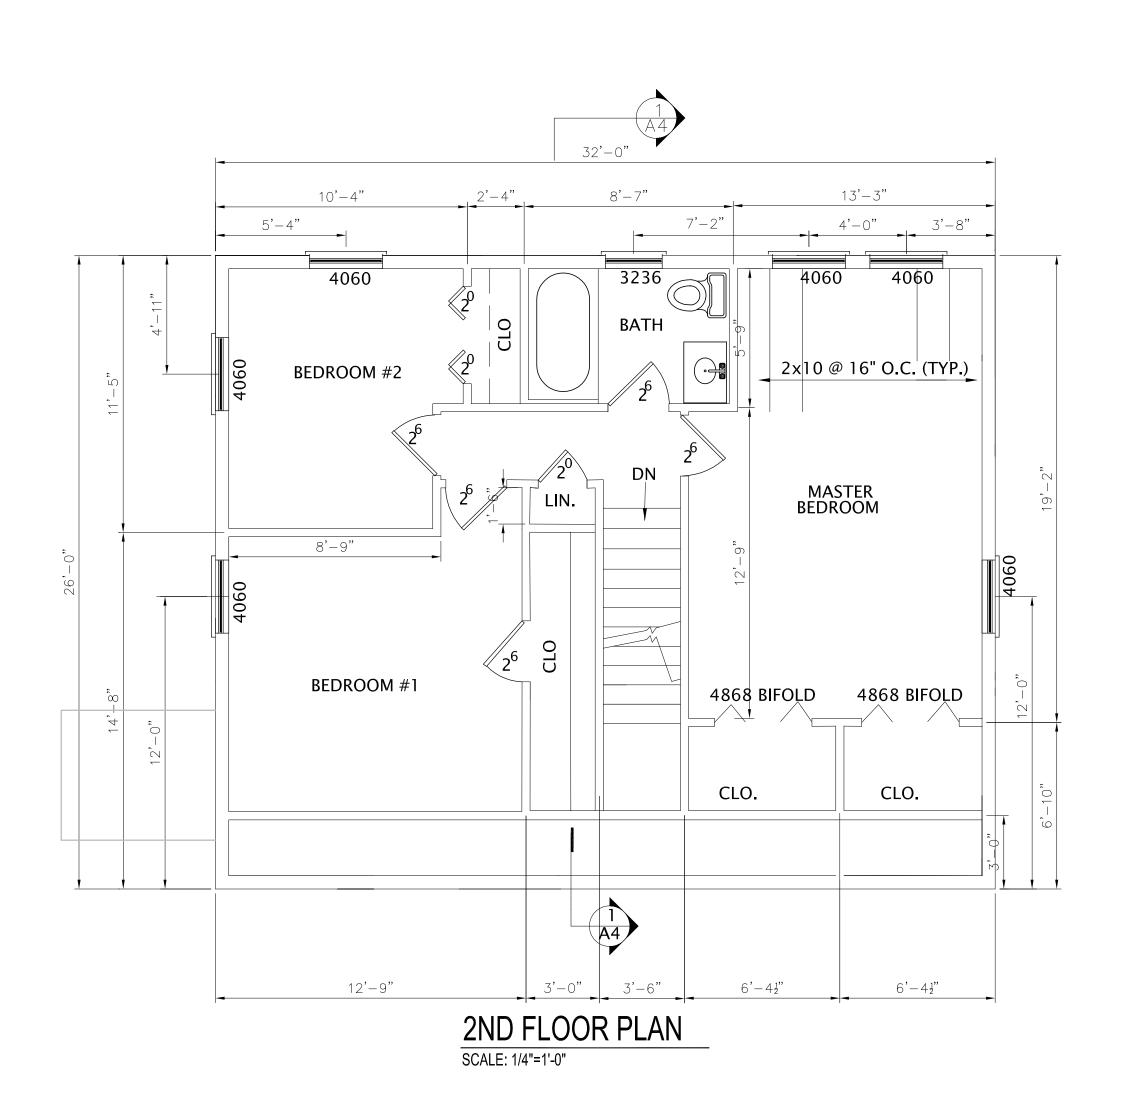

PROPERTY OF SAO RESIDENCE PORTLAND, MAINE BUILDING REVS: CODE: TOWN: PORTLAND DATE: 10-12-2017 SCALE: AS NOTED DESIGNED: SSA DRAWN: SSA TITLE:

1st Floor Plan

SHEET: A3

