



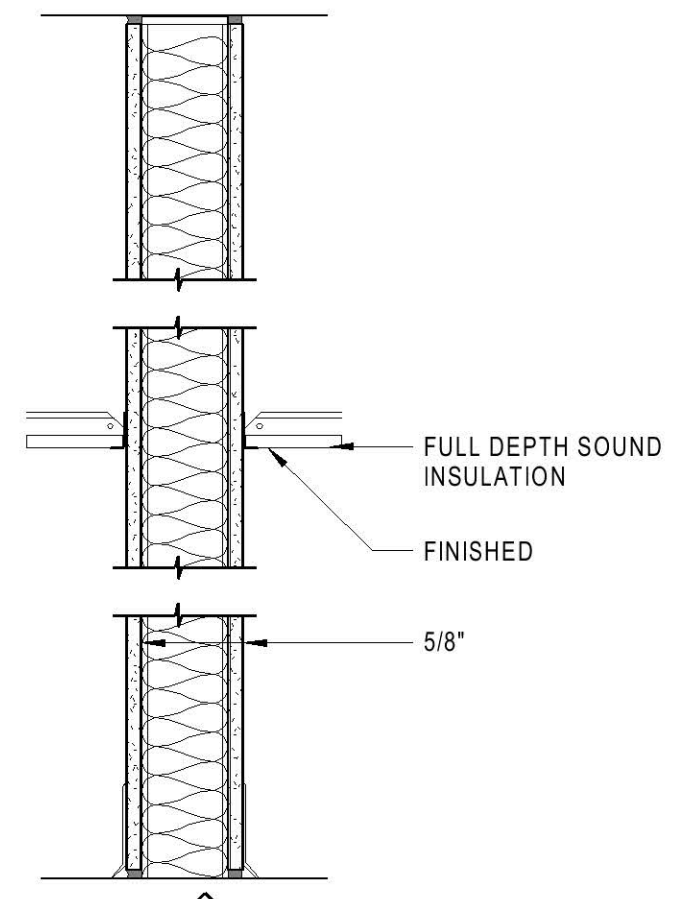


**ABBREVIATIONS:**

AB	ANCHOR BOLT	L	ANGLE / LENGTH
A/C	AIR CONDITIONING	LF	LEFT
ACCU	AIR CONDITIONING CONDENSER UNIT	LNO	SHEET LINOLEUM
ACPLAS	ACOUSTICAL PLASTER	LL	LIVE LOAD
ACT	ACOUSTIC CEILING TILE	LLH	LONG LEG HORIZONTAL
AF	ABOVE FINISH FLOOR	LLV	LONG LEG VERTICAL
AGG	AGGREGATE	LP	LIGHTING PANEL / LIQUIFIED PROPANE
ALT	ALTERNATE	MAX	MAXIMUM
AP	ACCESS PANEL	MB	MARKER BOARD
APPROX	APPROXIMATE	MDO	MEDIUM DENSITY OVERLAY
ARCH	ARCHITECTURAL	MECH	MECHANICAL
BCX	BOTTOM CORD EXTENSION BOARD	MFR	MANUFACTURER
BD	BITUMINOUS	MIN	MINIMUM
BLDG	BUILDING	MISC	MISCELLANEOUS
BLP	BORROWED LIGHT PANEL	MO	MASONRY OPENING
BO	BOTTOM OF	MR	MOISTURE-RESISTANT
BOF	BOTTOM OF FOOTING	MUA	MAKE-UP AIR
BOS	BOTTOM OF STEEL	N	NOSE
BOT	BOTTOM	NCB	NEW CATCH BASIN
BRDG	BRIDGING	NDMH	NEW DRAIN MANHOLE
BRG	BEARING	NFM	NEW FORCE MAIN
BS	BOTH SIDES	NIC	NOT IN CONTRACT
BSE	BRICK SHELF ELEVATION	NS	NEAR SIDE
C	CHANNEL	NSD	NEW STORM DRAIN LINE
CB	CATCH BASIN / CHALKBOARD	NSS	NEW SANITARY SEWER LINE
CEM BD	CEMENTITIOUS BACKER BOARD	NTS	NOT TO SCALE
CFM	CUBIC FEET PER MINUTE	NW	NEW WATER LINE
CIP	CAST IN PLACE	OC	ON CENTER
CJ	CONTROL JOINT / CONSTRUCTION JOINT	OF	OUTSIDE FACE
CL	CENTER LINE	OH	OVERHEAD
CLR	CLEAR	PA	PUBLIC ADDRESS
CMU	CONCRETE MASONRY UNIT	PAF	POWER-ACTUATED FASTENER
COL	COLUMN	PDU	POOL DEHUMIDIFICATION UNIT
CONC	CONCRETE	PL	PLATE / PROPERTY LINE
CONT	CONTINUOUS	PLAM	PLASTIC LAMINATE
CT	CERAMIC TILE	PLF	POUNDS PER LINEAR FOOT
CUH	CABINET UNIT HEATER	PP	POWER PANEL
D	DIAMETER	PSF	POUNDS PER SQUARE FOOT
DBL	DOUBLE	PSI	POUNDS PER SQUARE INCH
DL	DEAD LOAD	PT	PRESSURE-TREATED
DR	DISPLAY RAIL	PVC	POLYVINYL CHLORIDE
DTL	DETAIL	PVMT	PAVEMENT
DW	DISHWASHER	R	RISER / RADIUS
DWG	DRAWING	RB	RESILIENT BASE
EA	EACH	RD	ROOF DRAIN
EF	EXHAUST FAN / EACH FACE	REINF	REINFORCED
EJ	EXPANSION JOINT	REQD	REQUIRED
EL	ELEVATION	RT	RIGHT
ELEC	ELECTRICAL	RO	ROUGH OPENING
EOP	EDGE OF PAVEMENT	ROW	RIGHT OF WAY
EPDM	ETHYLENE PROPYLENE DIENE MONOMER	RR	RUB-RAIL
EQ	EQUAL	RTU	ROOF TOP UNIT (HVAC)
EW	EACH WAY	SACT	SUSPENDED ACOUSTIC TILE CEILING
EWC	ELECTRIC WATER COOLER	SC	SOLID CORE
EXIST	EXISTING	SF	SQUARE FOOT / SUPPLY FAN
EXT	EXTERIOR	SFRM	SPRAYED FIRE-RESISTIVE MATERIAL
FB	FLAT BAR	SHT	SHEET
FBO	FURNISHED BY OTHERS	SIM	SIMILAR
FCO	FLOOR CLEA-OUT	SK	SHEAR KEY
FD	FLOOR DRAIN	SN	SANITARY NAPKIN (DISPENSER)
FE	FIRE EXTINGUISHER	SP	SPECIAL
FEC	FIRE EXTINGUISHER CABINET	SS	STAINLESS STEEL
FF	FINISH FLOOR / FAR FACE	STA	STATION
FFE	FINISH FLOOR ELEVATION	STL	STEEL
FO	FRAMED OPENING	STRUC	STRUCTURAL
FRP	FIBER REINFORCED PLASTIC	T	TREAD
FS	FAR SIDE	TB	TACKBOARD
FTG	FOOTING	T&B	TOP AND BOTTOM
GA	GAUGE	TBM	TEMPORARY BENCHMARK
GALV	GALVANIZED	TCE	TOP CHORD EXTENSION
GB	GRAB BAR	TJ	TIE JOINT
GC	GENERAL CONTRACTOR	TO	TOP OF
GDT	GYP SUM DROP-IN TILE	TOC	TOP OF CONCRETE
GV	GRAVITY VENT	TOF	TOP OF FOOTING
GWB	GYP SUM WALL BOARD	TOM	TOP OF MASONRY
H	HORIZONTAL	TOP	TOP OF PIER
HC	HANDICAPPED / HOLLOW CORE	TOS	TOP OF STEEL
HORIZ	HORIZONTAL	TOW	TOP OF WALL
HM	HOLLOW METAL	TP	TOILET PAPER (DISPENSER) / TEST PIT
HRU	HEAT RECOVERY UNIT	TS	TUBE STEEL
H&V	HEATING AND VENTILATING	TYP	TYPICAL
HVAC	HEATING, VENTILATING AND AIR CONDITIONING	UH	UNIT HEATER
I	INCLUDED ANGLE	UNO	UNLESS NOTED OTHERWISE
ID	INSIDE DIAMETER	V	VENT PIPE / VERTICAL
IF	INSIDE FACE	VB	VAPOR BARRIER
IJ	ISOLATION JOINT	VCT	VINYL COMPOSITION TILE
IMP	IMPACT RESISTANT	VERT	VERTICAL
INS	INSULATED	VP	VISION PANEL
INV	INVERT	VTR	VENT THROUGH THE ROOF
JS	JOINT SUBSTITUTE	W/	WITH
K	KIPS	WC	WATER CLOSET
		WD	WOOD
		WF	WIDE FLANGE
		WH	WATER HEATER
		W/O	WITH OUT
		WP	WORKING POINT
		WS	WEB STIFFENER
		WWF	WELDED WIRE FABRIC


**SYMBOL**

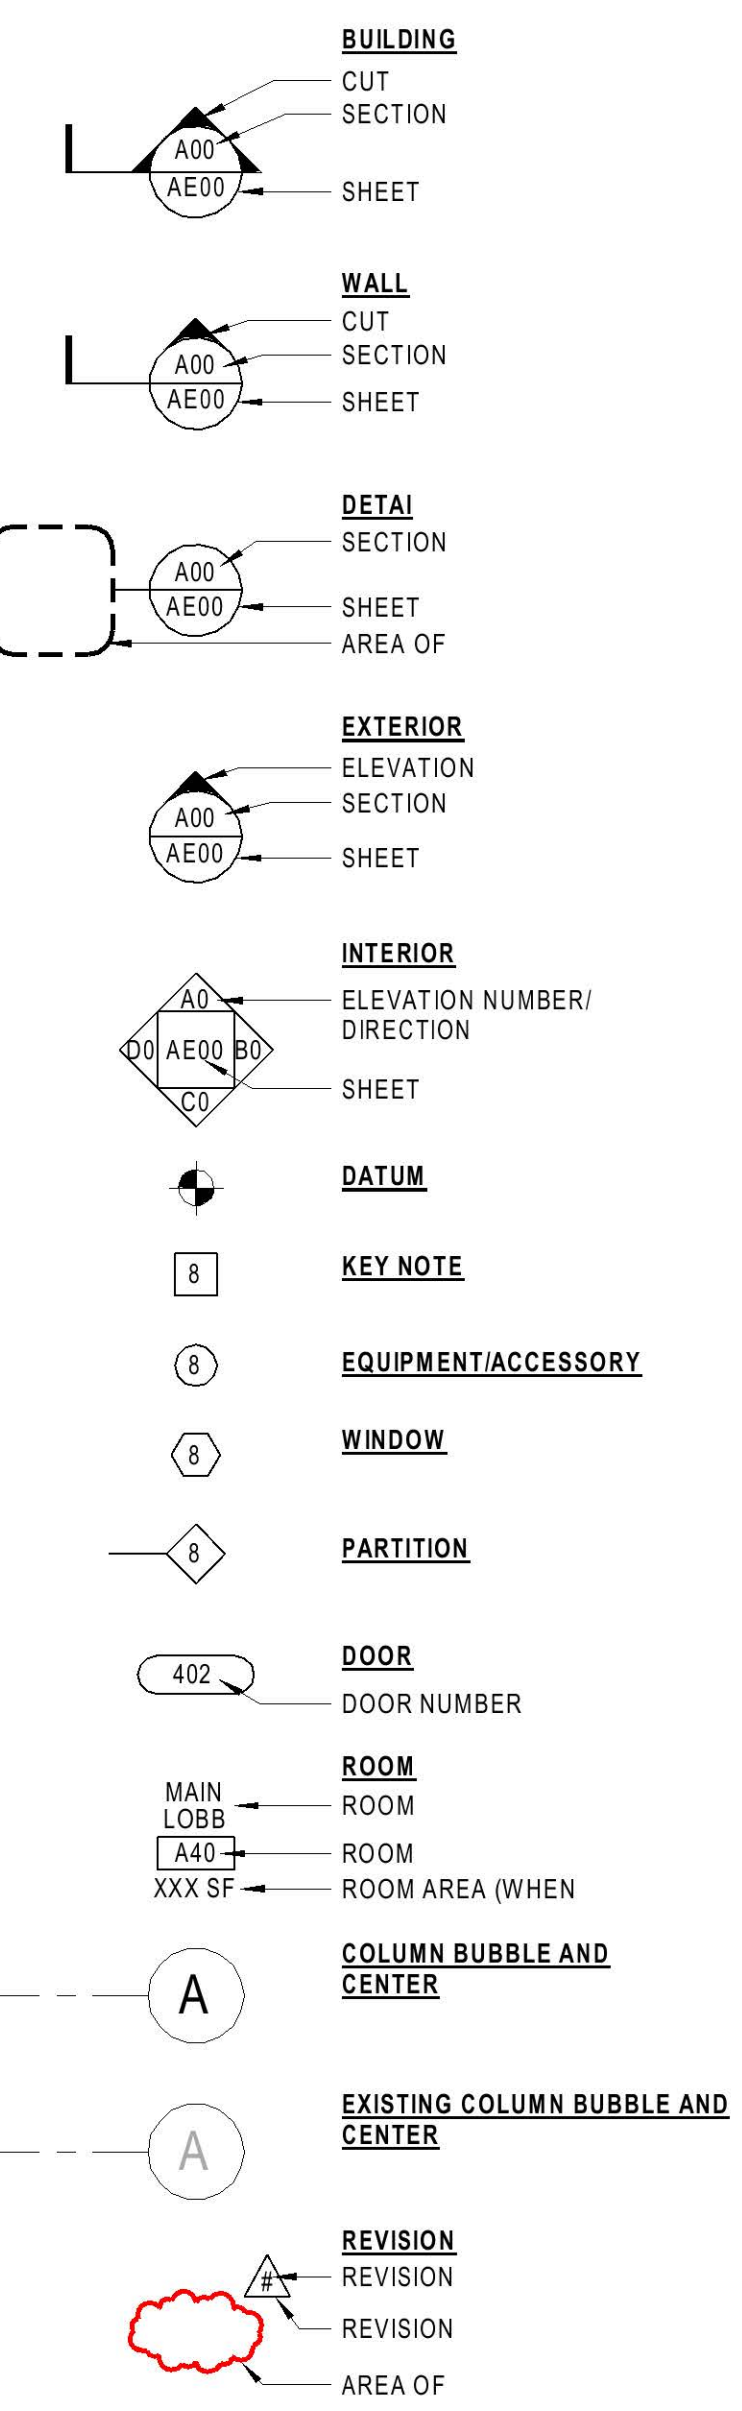


**TYPICAL PARTITION TYPE S3a NON-RATED**  
 (STC 45) ONE LAYER 5/8" GWB EACH SIDE OF 3 5/8" METAL STUDS.  
 1 1/2" = 1'-0" G7

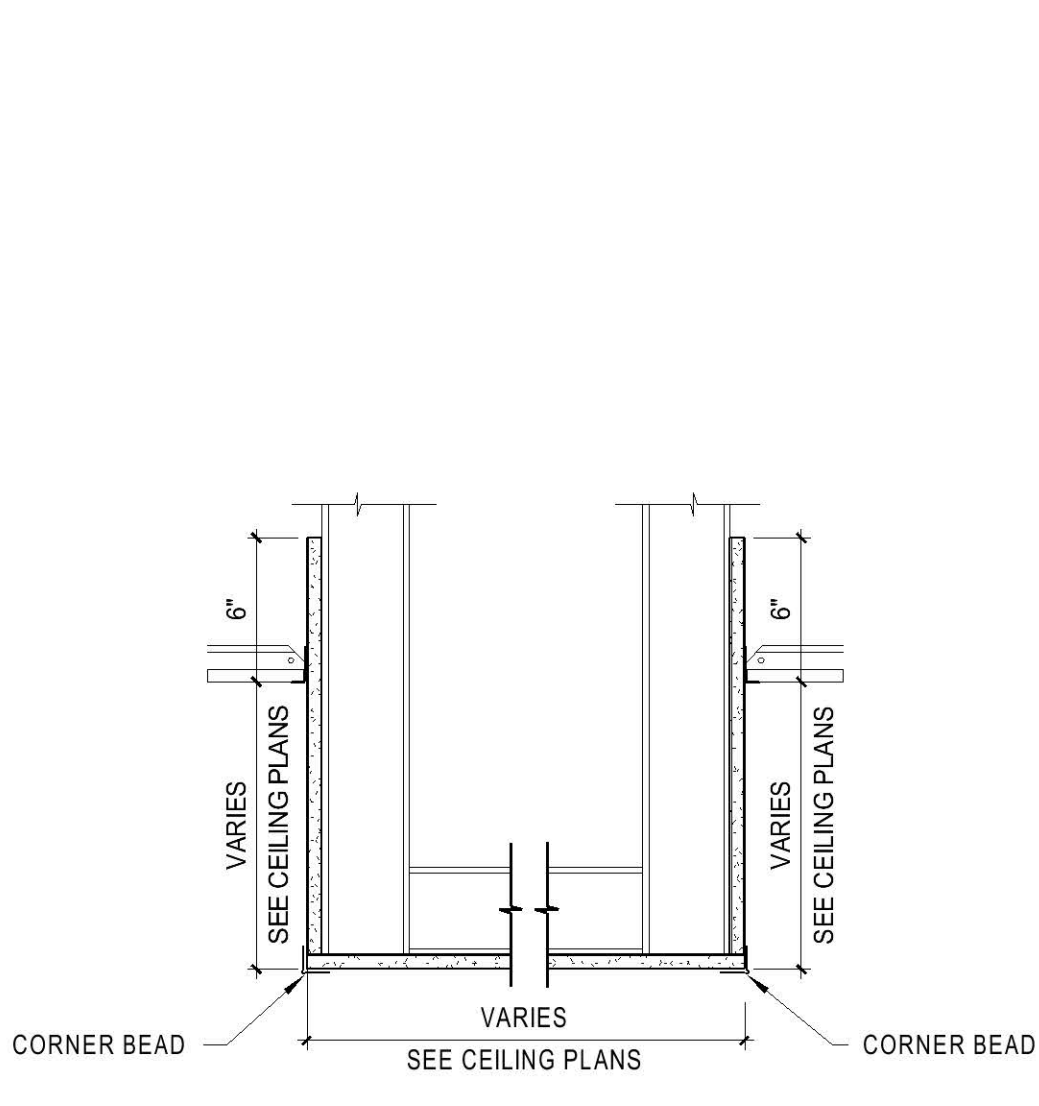

**SOFFIT DETAIL 1**  
 1 1/2" = 1'-0" G7


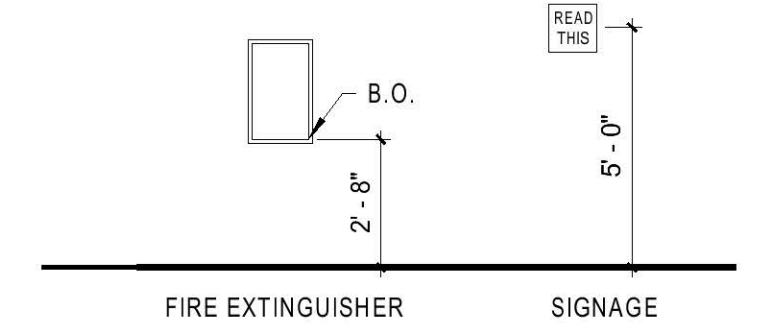


**TYP. MOUNTING HEIGHTS J5**  
 1/4" = 1'-0"

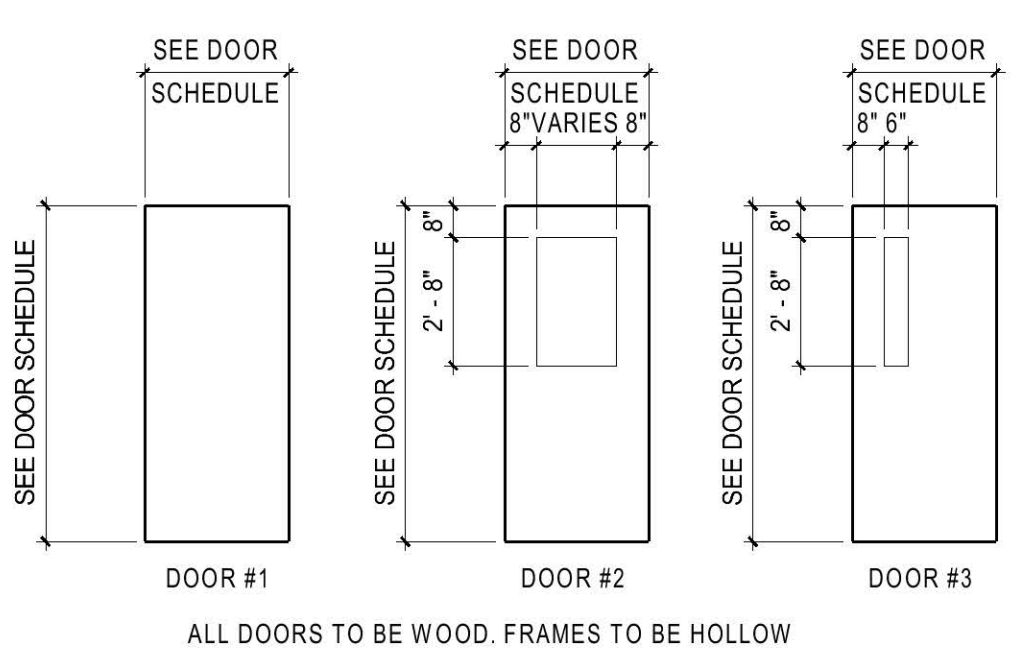

**DOOR LEAF TYPES G4**  
 1/4" = 1'-0"

**LOCATION MAP:**

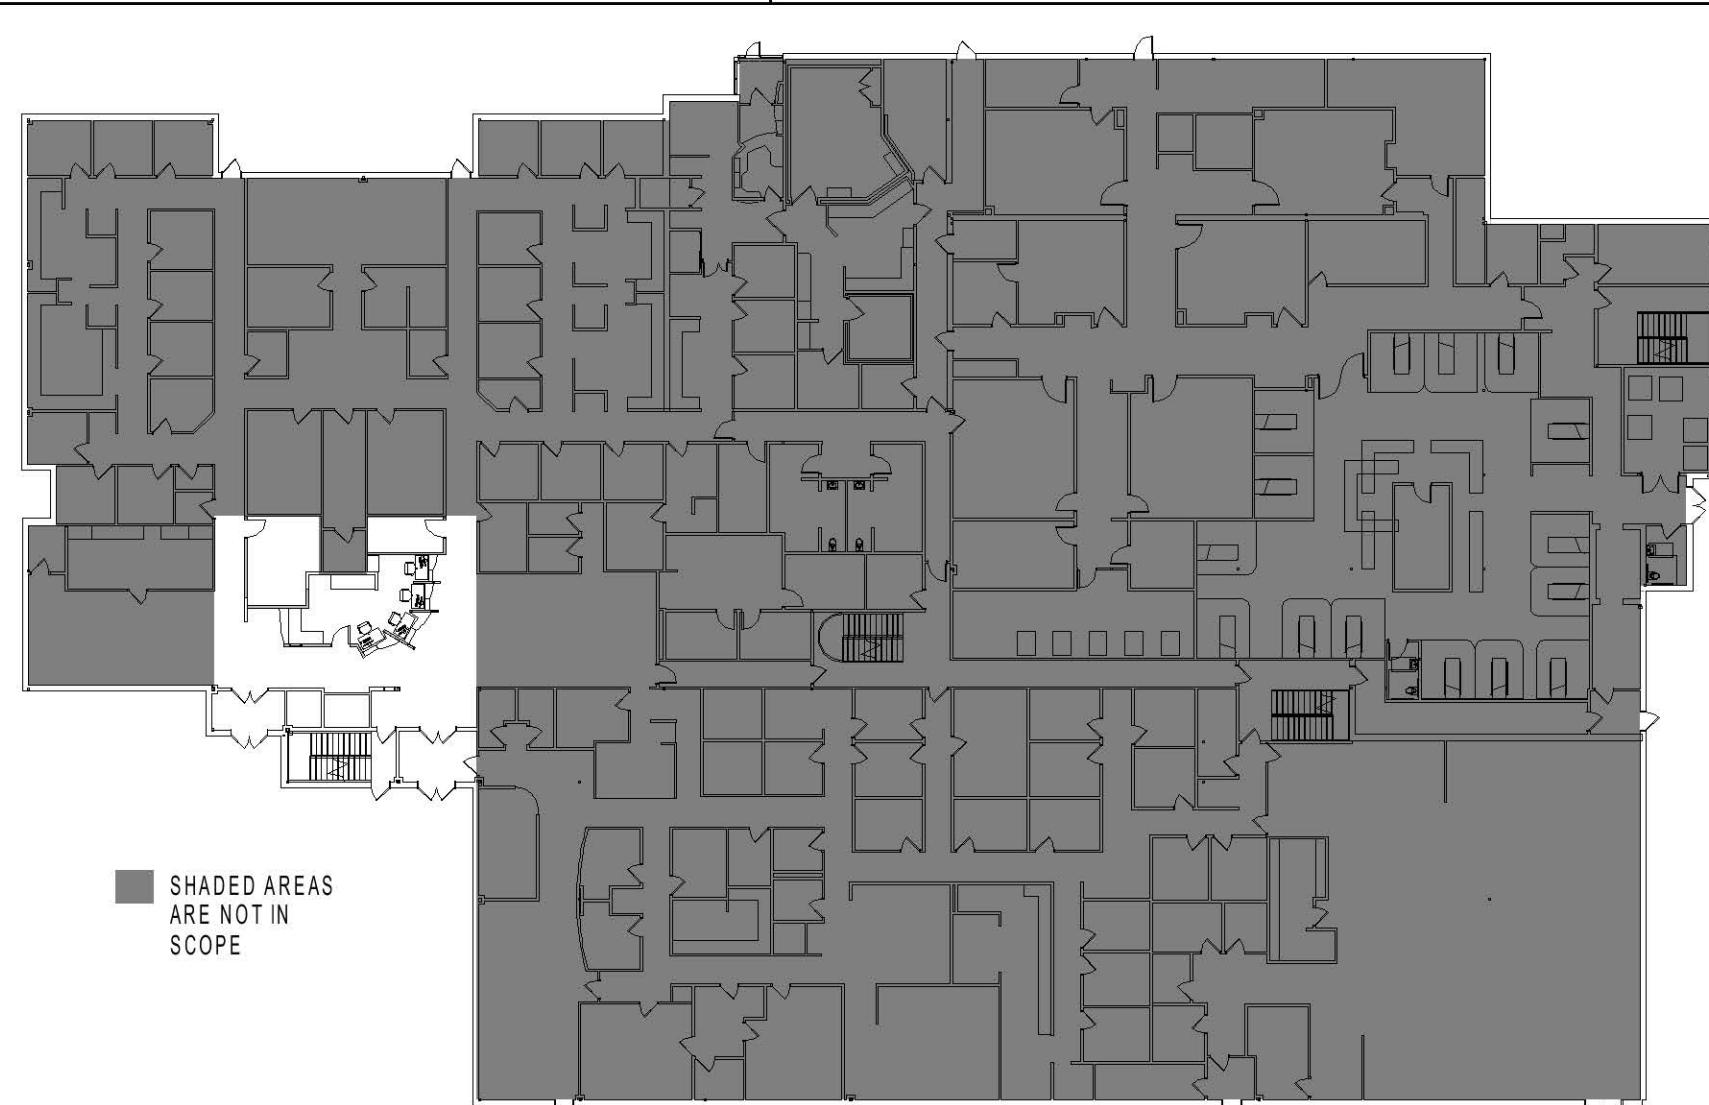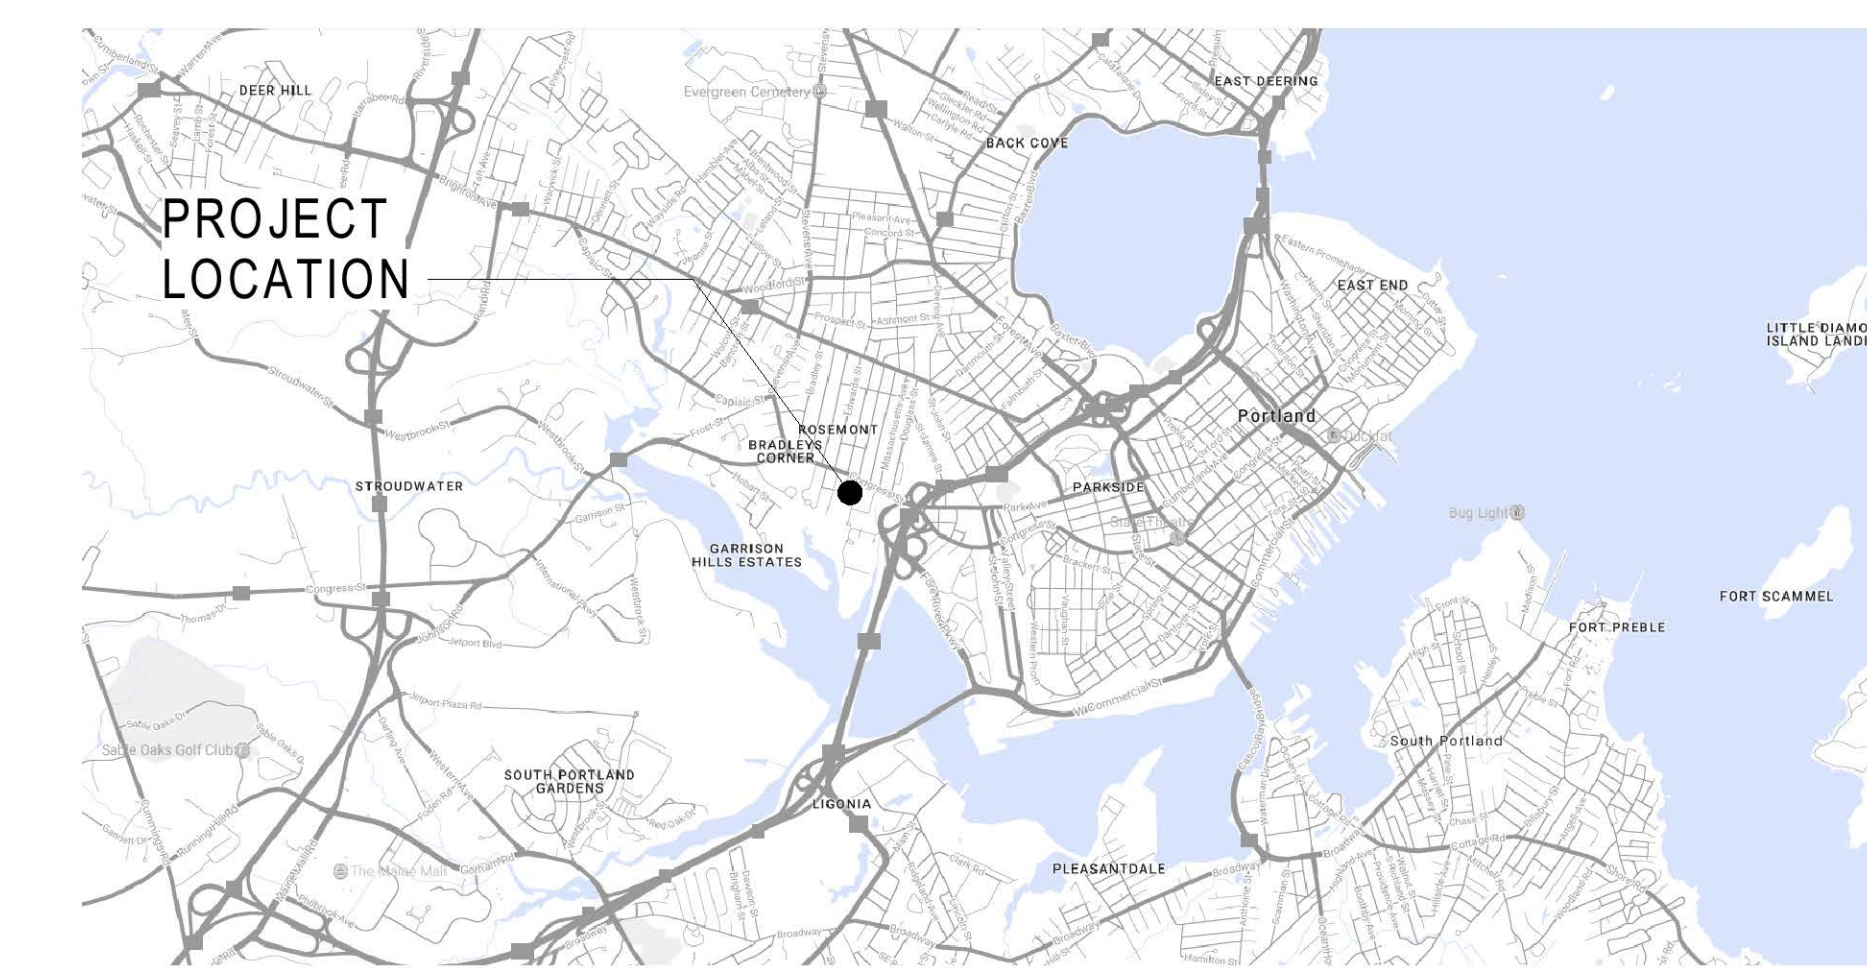

**CODE COMPLIANCE PLAN A6**  
 1/32" = 1'-0"

**DRAWING LIST:**

- GENERAL**  
 G1001 COVER SHEET, GENERAL INFO, AND CODE COMPLIANCE
- ARCHITECTURAL**  
 AE100 DEMOLITION PLAN, FLOOR PLAN, REFLECTED CEILING PLAN, AND ELEVATIONS
- INTERIORS**  
 ID100 FLOOR AND WALL FINISH PLAN  
 MECHANICAL, ELECTRICAL & PLUMBING BY OTHERS
- CODE COMPLIANCE SUMMARY:**  
**USE & OCCUPANCY:** BUILDING: BUSINESS & HEALTHCARE, MIXED USE, SEPARATED.  
**AREA OF WORK: BUSINESS (EXISTING)**  
**TYPE OF CONSTRUCTION: TYPE IIB, UNPROTECTED**  
 SEE PLAN. ADJACENT: SHADED AREAS ARE NOT IN SCOPE.
- THIS RENOVATION / REPAIR AT THE RECEPTION AREA DOES NOT CHANGE ANY OF THE EXISTING CORRIDORS, ENTRIES OR MEANS OF EGRESS BEYOND THE DOORS TO INDIVIDUAL OFFICE SPACES. ANY WORK EXTENDING INTO SHADED AREAS SHALL BE LIMITED TO FINISHES REPAIR AND REPLACEMENT.
- LIFE SAFETY PLANS, IF REQUIRED TO BE FIELD VERIFIED AND SUBMITTED BY THE DESIGN-BUILD SUB-CONTRACTOR.
- APPLICABLE CODES & REGULATIONS:**  
 MUBEC/IBC 2015  
 PORTLAND FIRE CODE CH. 10/NFPA 1, NFPA 101 2009  
 ADA 2010

**GENERAL NOTES:**

- FIELD VERIFY ALL DIMENSIONS AND LAYOUT PRIOR TO PROCEEDING WITH WORK. NOTIFY ARCHITECT IN WRITING OF ANY DISCREPANCIES OR INCONSISTENCIES. FAILURE TO REPORT ANY DISCREPANCIES WITHIN THESE CONSTRUCTION DOCUMENTS TO THE ARCHITECT WILL NOT BE GROUNDS FOR ADDITIONAL COST OR CHANGE ORDERS.
- CONTRACTOR SHALL BE RESPONSIBLE FOR PROVIDING ALL MATERIALS (UNLESS NOTED OTHERWISE), AND WORKMANSHIP IN ACCORDANCE WITH FEDERAL, STATE, CITY, AND LOCAL BUILDING CODES AND THEIR REQUIREMENTS.
- CONTRACTOR AND ALL TRADES SHALL NOTE REQUIREMENTS OF "GENERAL NOTES" ON ALL SHEETS.
- EACH TRADE TO PROVIDE SMOKE OR FIRE SEALANT AT PENETRATIONS AS REQUIRED FOR WALL TYPE (UNLESS NOTED OTHERWISE). ALL SEALANT, FIRE STOPPING AND SMOKE STOPPING ASSEMBLIES SHALL BE U.L. RATED.
- REFER TO ALL CONSTRUCTION DOCUMENTS FOR REQUIREMENTS WHICH MAY AFFECT THE WORK IN ANOTHER AREA AND/OR DISCIPLINE AND COORDINATE.
- PROVIDE BLOCKING IN WALLS AS NECESSARY WHERE CASEWORK, FURNITURE, SHELVES, HANDRAILS, AND/OR OTHER MISC. EQUIPMENT IS LOCATED.
- REFER TO G-002 SHEETS FOR GENERAL MOUNTING HEIGHTS.
- DO NOT SCALE CONSTRUCTION DOCUMENTS.
- PROVIDE MEANS "FURNISH AND INSTALL".

ALTERNATES:  
 #1 & #2: PRICE SEPARATELY TO REPLACE FLOORING IN THESE AREAS.  
 #3: PROVIDE PRICING & SCHEDULE IMPLICATIONS TO FABRICATE LOW WALLS AND DIVIDER WALLS AT CHECK-IN DESK AS MILLWORK IN LIEU OF GWB PARTITIONS.

REV	DESCRIPTION	DATE

ISSUED FOR PERMIT  
 10-12-18

CURRENT ISSUE STATUS:


SMRT Architects and Engineers  
 144 Fore Street/P.O. Box 618  
 Portland, Maine 04104

ARCHITECTURE | ENGINEERING | PLANNING | INTERIORS | ENERGY **SMRT**

**ORTHOASSOCIATES PT**  
**OA PORTLAND RECEPTION**

PORTLAND, ME  
**COVER SHEET, LEGEND AND ABBREVIATIONS**

SHEET TITLE:

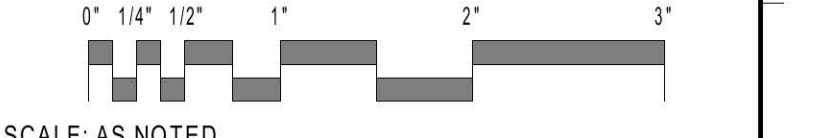

SCALE: AS NOTED

PROJECT MANAGER: RAC	PROJECT NO: 18164
A/E OF RECORD: RAC	
JOB CAPTAIN:	
DRAWN BY: JCH	<b>G1001</b>
SMRT FILE: G1001-18164	SHEET No. <b>G1001</b>

NOT FOR CONSTRUCTION

