


GENERAL CEILING NOTES:

1. WHERE NEW CEILINGS REPLACE EXISTING CEILINGS, PLACE NEW CEILING HEIGHT AT HEIGHT OF EXISTING.
2. WHERE NEW CEILING ABUTS EXISTING CEILING, PLACE NEW CEILING AT SAME HEIGHT AS EXISTING CEILING.
3. WHERE CEILING GRIDS DO NOT ALIGN AT CHANGES IN DIRECTION, PROVIDE GWB TRANSITION SOFFIT AT LOCATIONS SHOWN.

LEGEND

- 8'-0" ACOUST CEILING HEIGHT
CEILING MATERIAL
- 2'-0" x 4'-0" SUSPENDED ACOUSTICAL CEILING TILE
- 2'-0" x 2'-0" SUSPENDED ACOUSTICAL CEILING TILE
- RECESSED 2'-0" x 4'-0" FLUORESCENT LIGHT FIXTURE (REFER TO ELECTRICAL DRAWINGS)
- RECESSED 2'-0" x 2'-0" FLUORESCENT LIGHT FIXTURE (REFER TO ELECTRICAL DRAWINGS)
- WALL-MOUNTED FIXTURE MATCH EXISTING CORRIDOR FIXTURE FOR NEW OFFICE AREAS
- WALL-MOUNTED OVER SINK AT LOCATIONS SHOWN. FIXTURE TO MATCH EXISTING MIRROR FIXTURE (REFER TO ELECTRICAL DRAWINGS)
- RECESSED DOWNLIGHT (REFER TO ELECTRICAL DRAWINGS)
- STEM MOUNTED FIXTURE ON SLOPED GWB CEILING (REFER TO ELECTRICAL DRAWINGS)
- MECHANICAL DIFFUSER (REFER TO MECHANICAL DRAWINGS)
- MECHANICAL RETURN AIR OR EXHAUST GRILL (REFER TO MECHANICAL DRAWINGS)
- MECHANICAL LINEAR SLOT DIFFUSER (REFER TO MECHANICAL DRAWINGS)
- GWB SOFFIT OR CEILING
NOTE: GWB CEILINGS IN SHOWER ROOMS ARE TO BE MR TYPE GWB
- RECESSED DOWN LIGHT IN GWB SOFFIT OR CEILING. (REFER TO ELECTRICAL DRAWINGS)
- STEM OR PENDANT MOUNTED TRACK LIGHT FIXTURE FOR USE IN EXISTING CEILING LIGHT TRACK ON SLOPED GWB CEILING

SPACE WHERE EXISTING CEILING TO BE ENLARGED OR REDUCED. NEW CEILING TO BE INTEGRATED WITH EXISTING IN-PLACE CEILING SYSTEM.

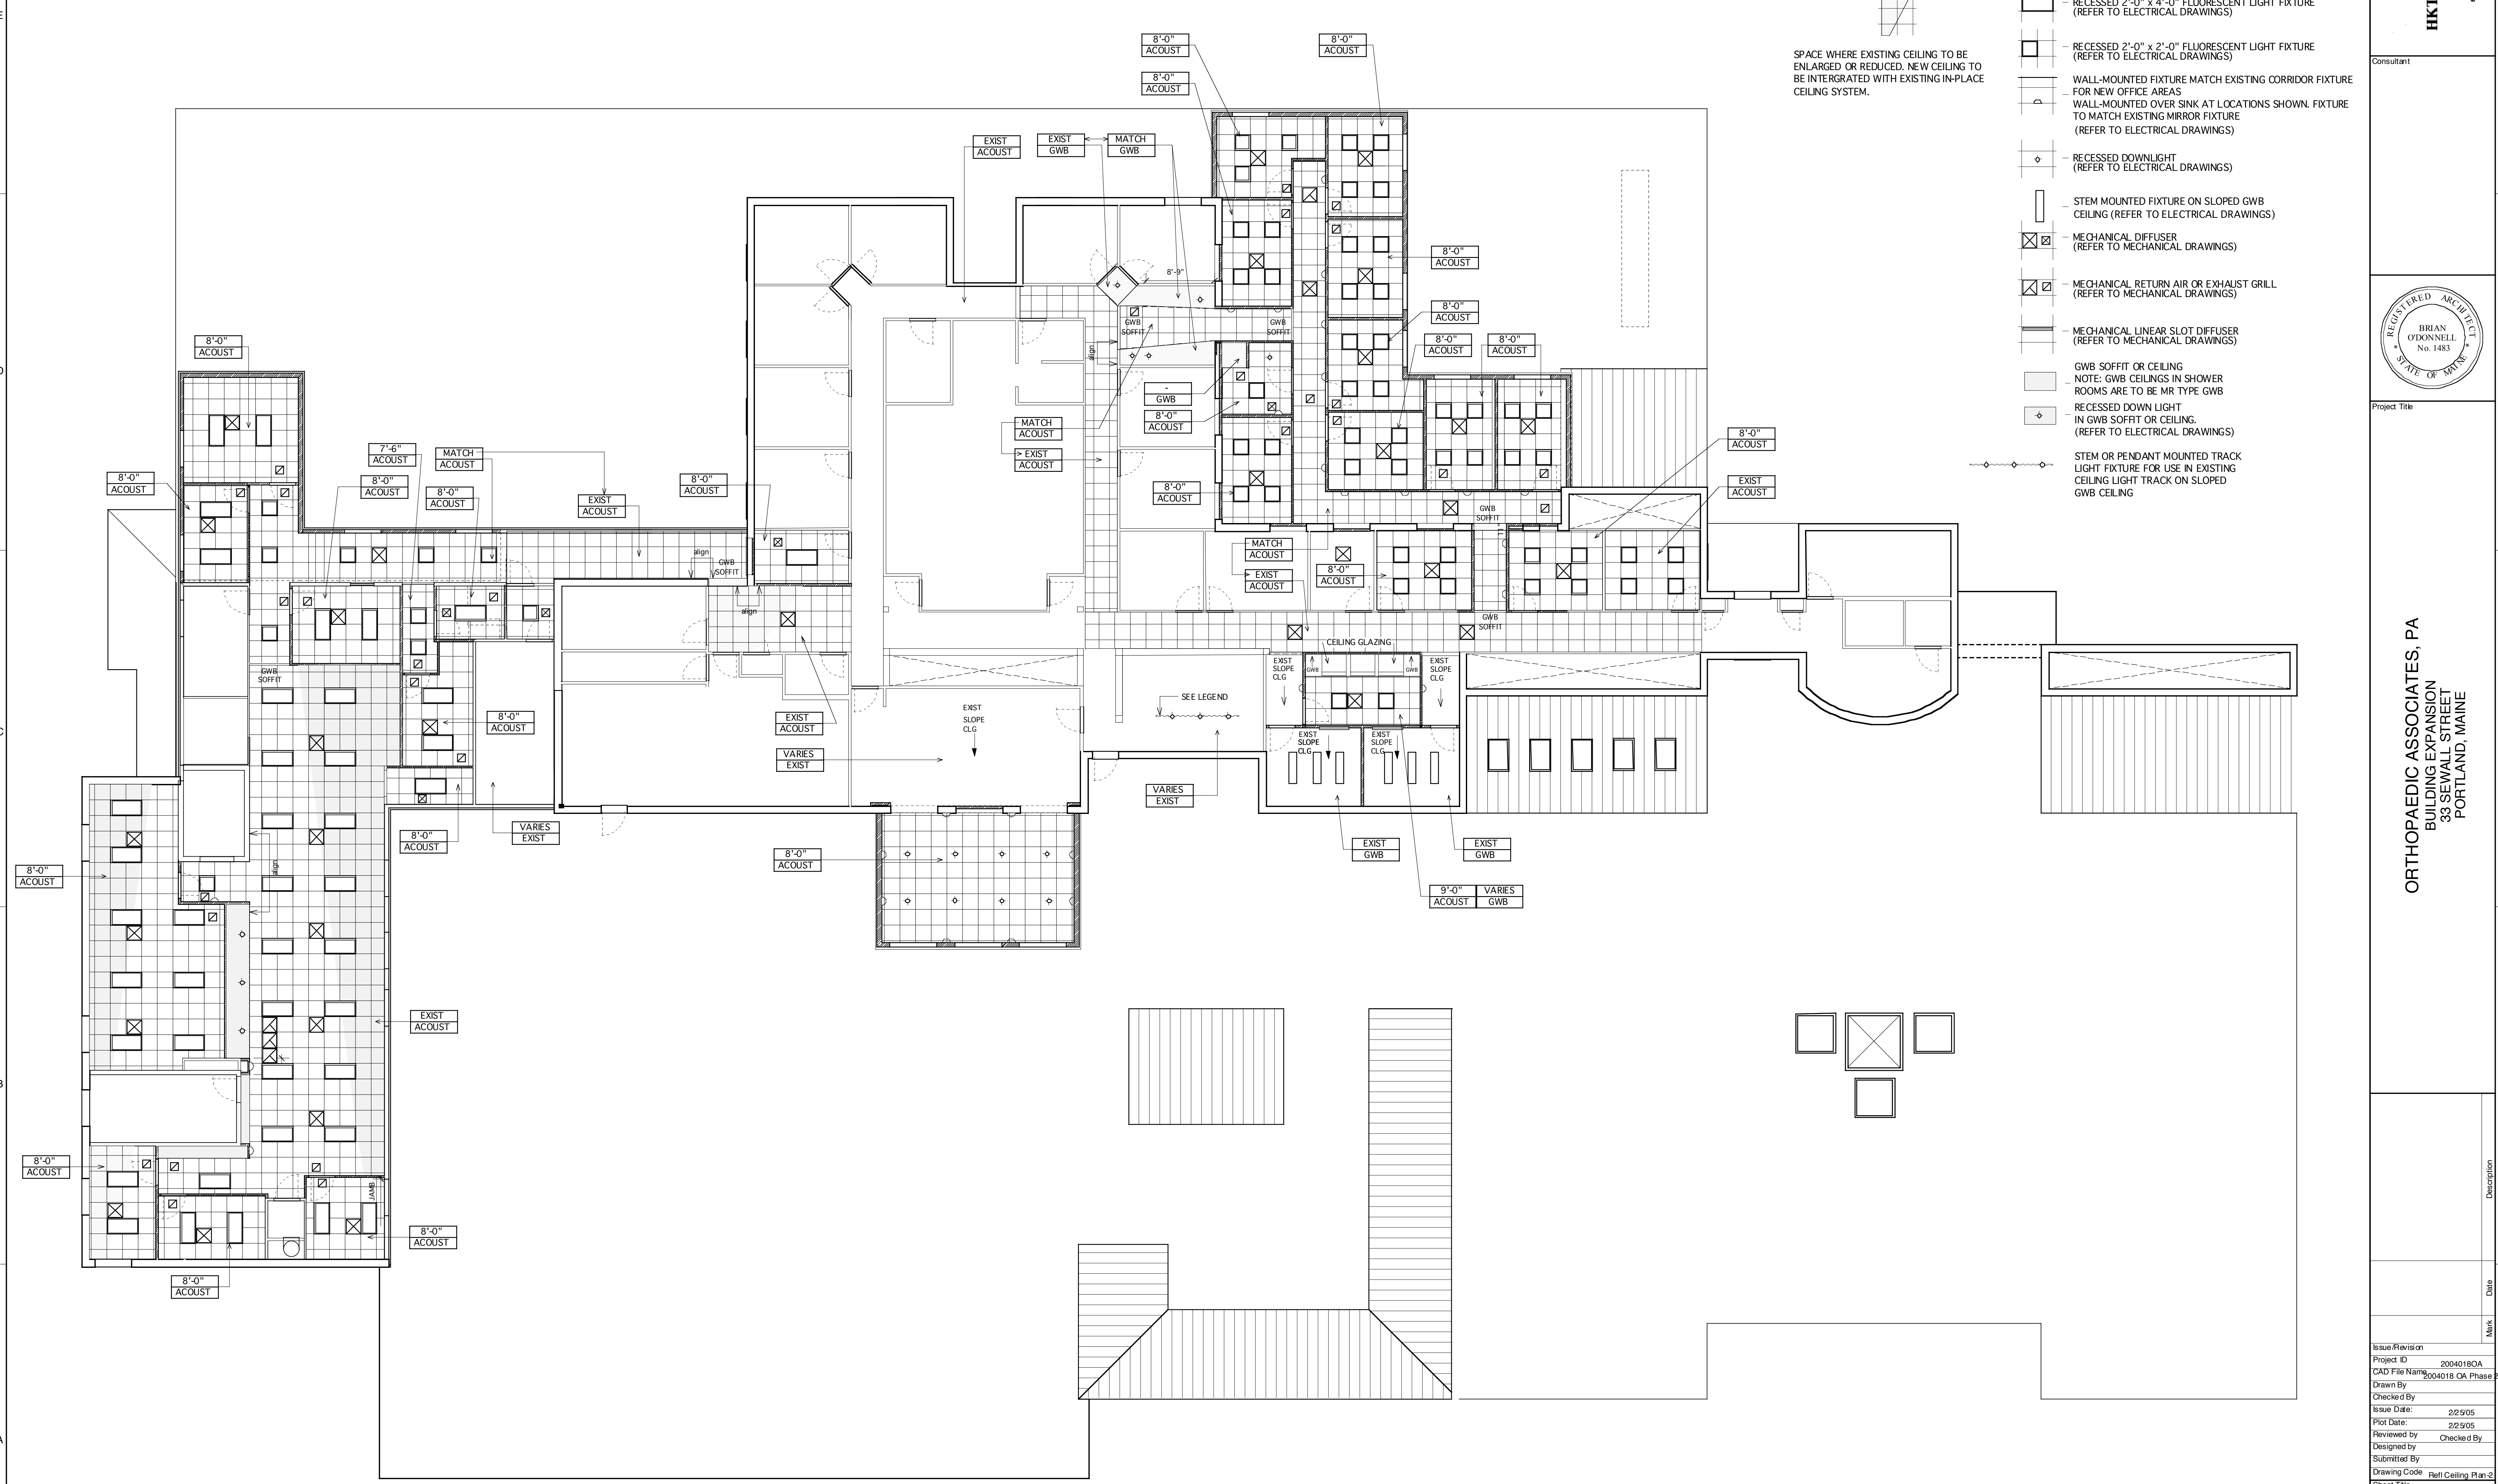

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Project Title
ORTHOPAEDIC ASSOCIATES, PA
BUILDING EXPANSION
33 SEAWALL STREET
PORTLAND, MAINE

Issue/Revision	Date	Mark	Description
Project ID: 20040180A			
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Submitted by:			
Drawing Code: Refl Ceiling Plan-2			
Sheet Title:			

Refl Ceiling Plan-2
 Phase 2
 Drawing No.
A-105
 of

SECOND FLOOR REFLECTED CEILING PLAN
 Scale: 1/8" = 1'-0"
 A104