



- NOTES:
- ADDITIONAL SUBBASE GRAVEL AND/OR GEOTEXTILES MAY BE REQUIRED DURING CONSTRUCTION IF SOIL CONDITIONS WARRANT.
 - GRAVEL SUB-BASE AND BASE MATERIAL TO BE COMPACTED TO 95% OF MAXIMUM DENSITY AT OPTIMUM MOISTURE. INSTALL GRAVEL BASE IN 6" MAX. LIFTS.

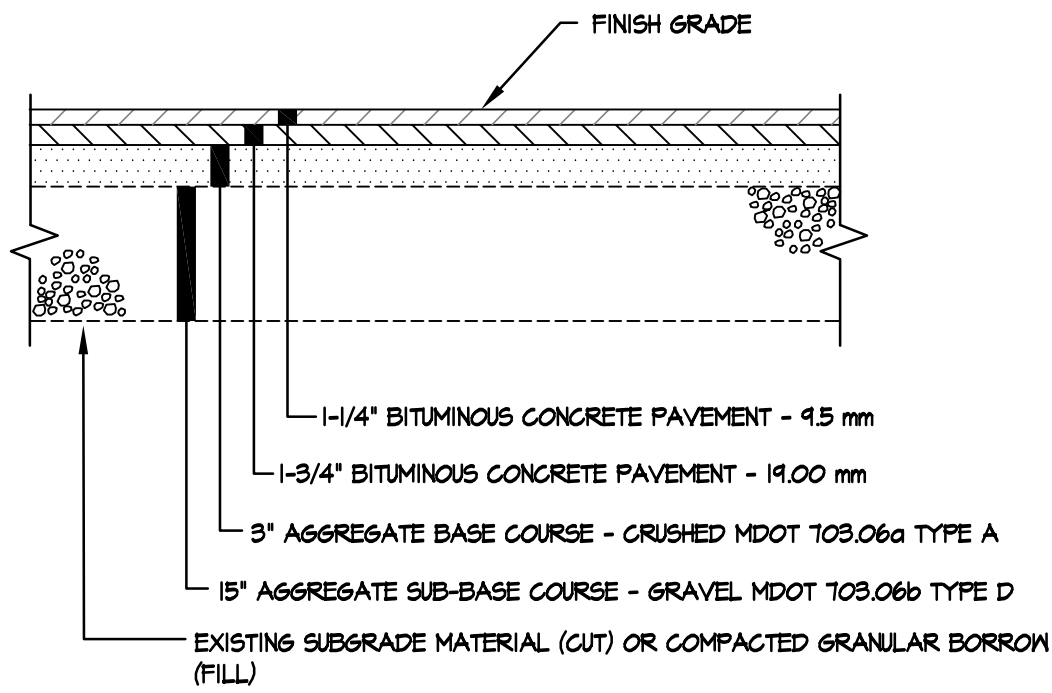


1 DRIVEWAY BUILD-UP

- NOTES:
- ALL PAVERS SHALL BE SAW CUT ONLY. NO FRAGMENT SHALL BE SMALLER THAN 2". FINAL SURFACE SHALL FIT TO DRAIN PER GRADING PLAN.
 - CONCRETE UNIT PAVERS SHALL BE AS SPECIFIED ON C-103 LANDSCAPE PLAN.
 - POLYMERIC SAND TO BE R6+ AS MANUFACTURED BY TECHNISEAL AND DISTRIBUTED BY MADANASKA HARDSCAPE OR APPROVED EQUIVALENT.
 - GRAVEL SUB-BASE AND BASE MATERIAL TO BE COMPACTED TO 95% OF MAXIMUM DENSITY AT OPTIMUM MOISTURE. INSTALL GRAVEL BASE IN 6" MAX. LIFTS.

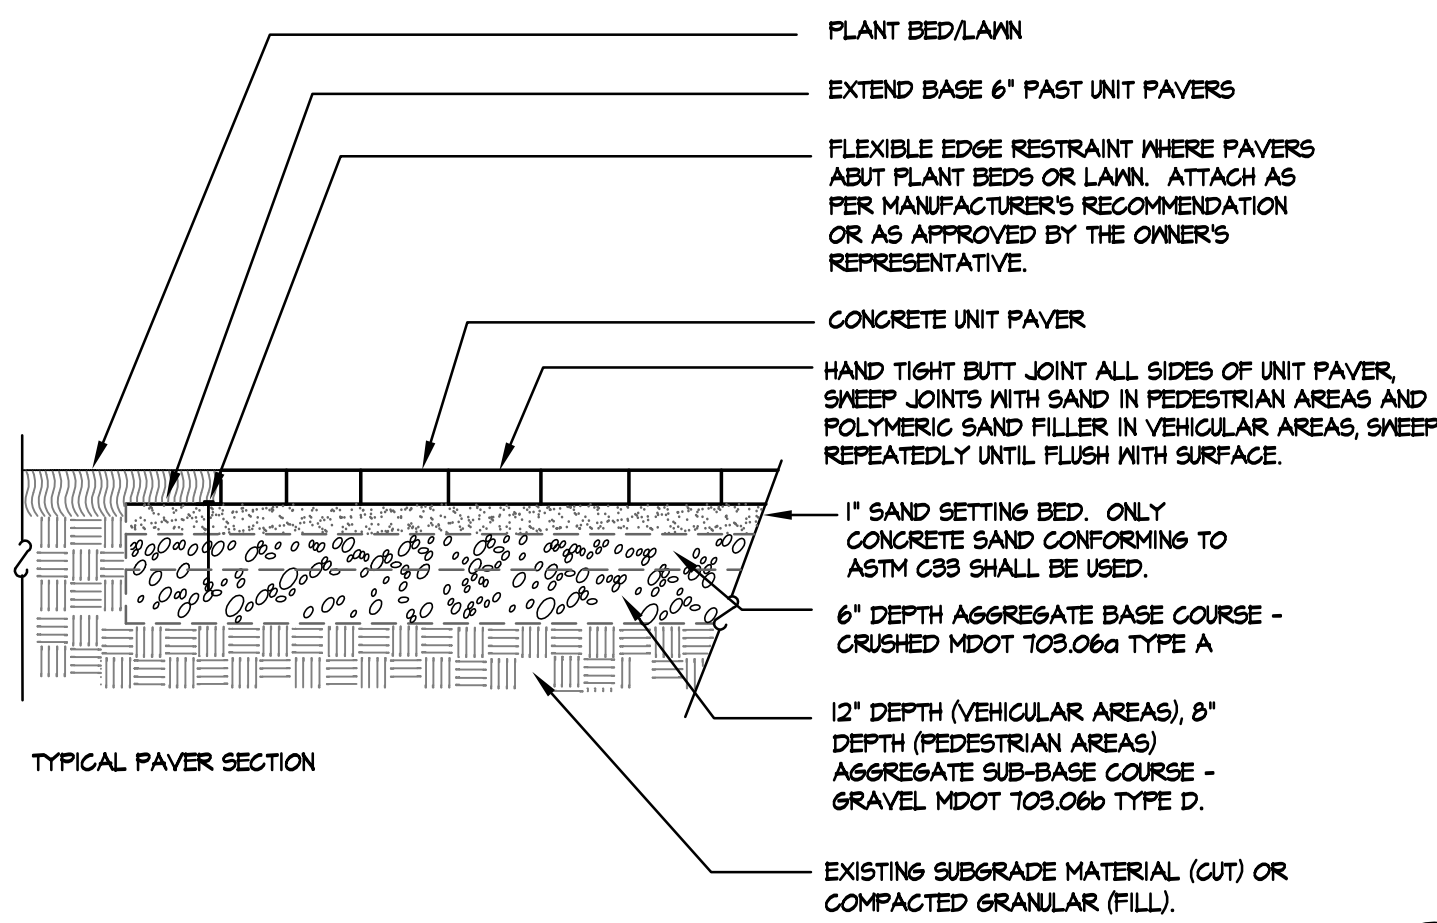


2 CONCRETE UNIT PAVER

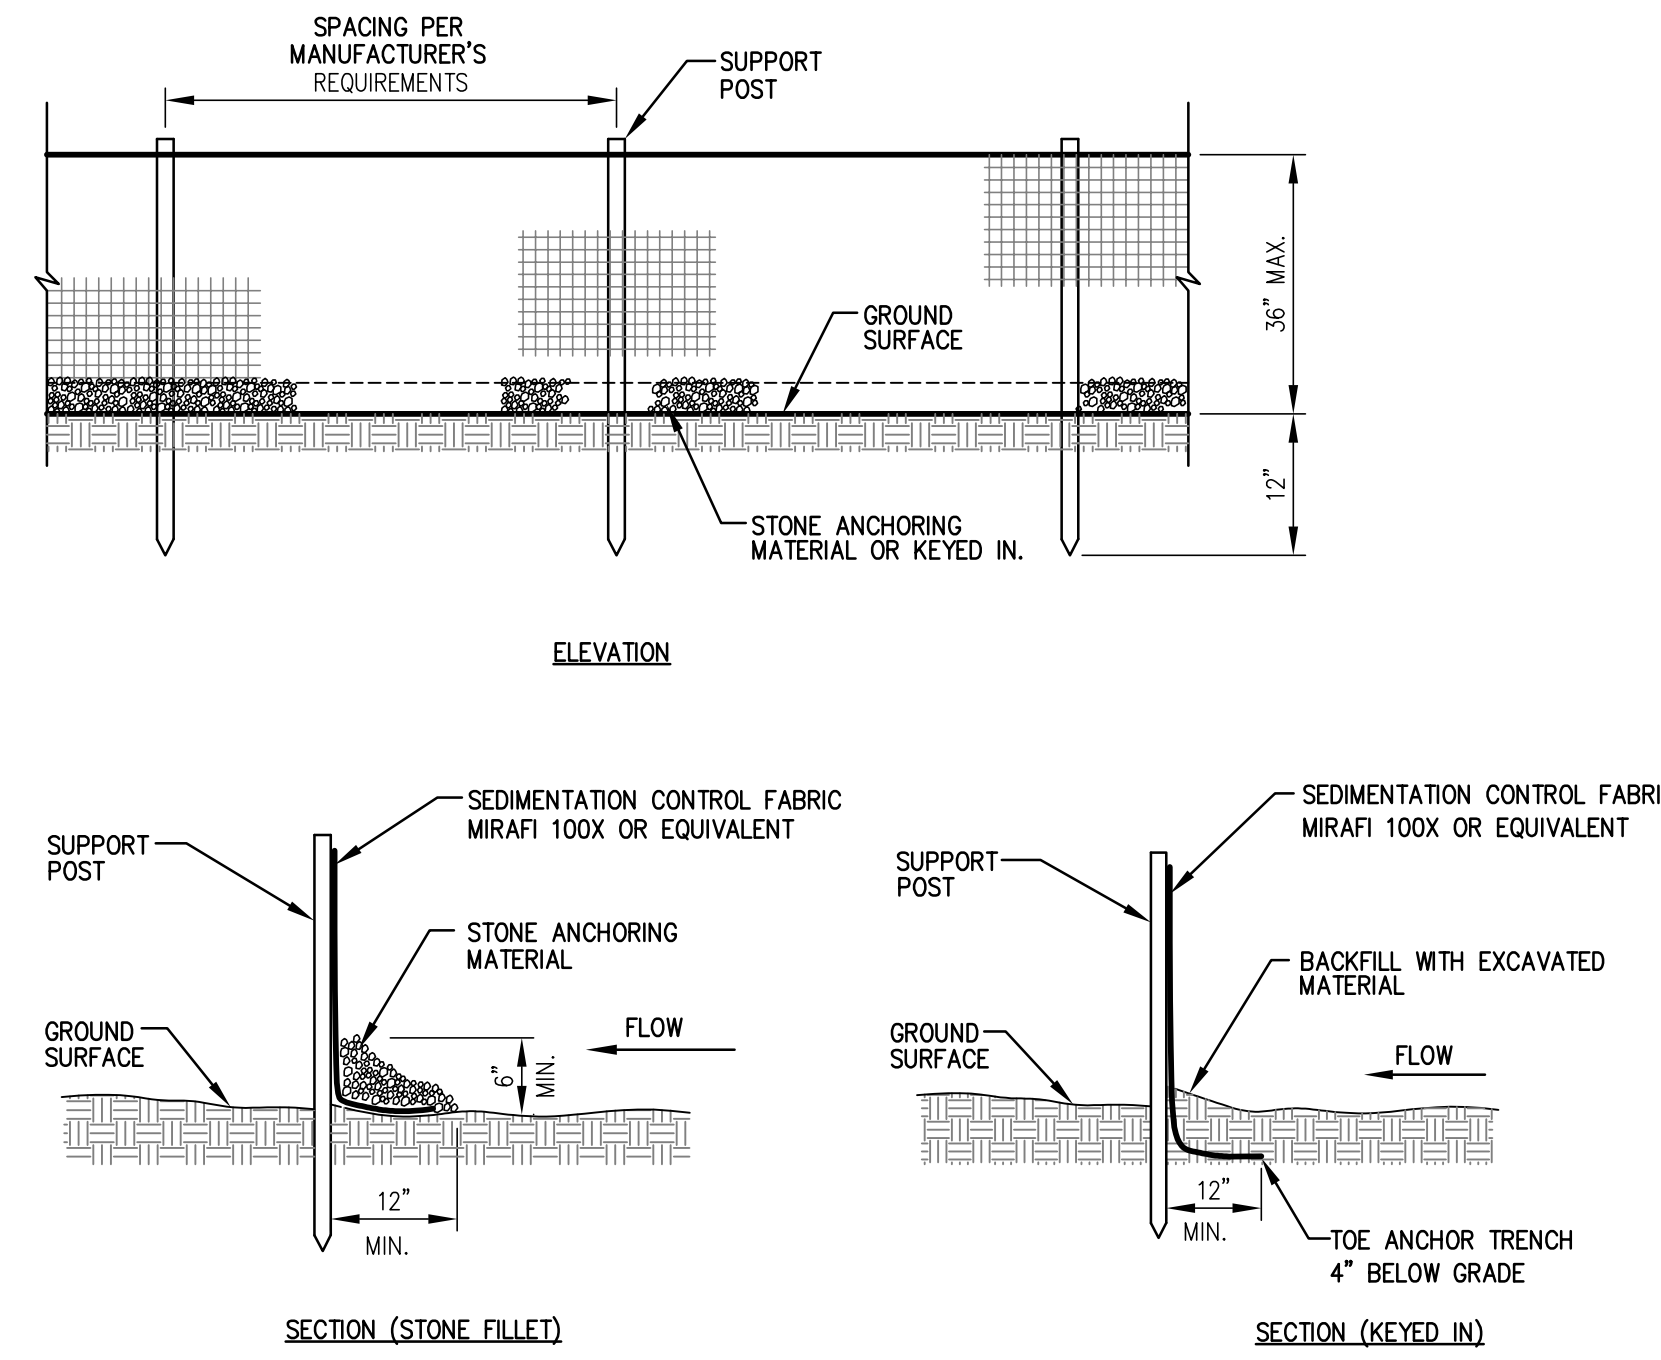


3 SILTATION FENCE
SCALE: N.T.S.


- NOTES:
- THE CONTRACTOR SHALL EXTEND THE WIDTH OF THE DRIP STRIP AT BUILDING JOBS AND BUMP OUTS AS REQUIRED TO CATCH ALL ROOF RUN OFF. CONTRACTOR SHALL PROVIDE THE OWNER'S REPRESENTATIVE WITH A SHOP DRAWING OF ANY PROPOSED MODIFICATION TO THE DRIP EDGE FOR APPROVAL.
 - INSTALL CLEANOUTS AT UNDERDRAIN CORNERS - SEE PERIMETER FOUNDATION UNDERDRAIN CLEANOUT DETAIL THIS SHEET.

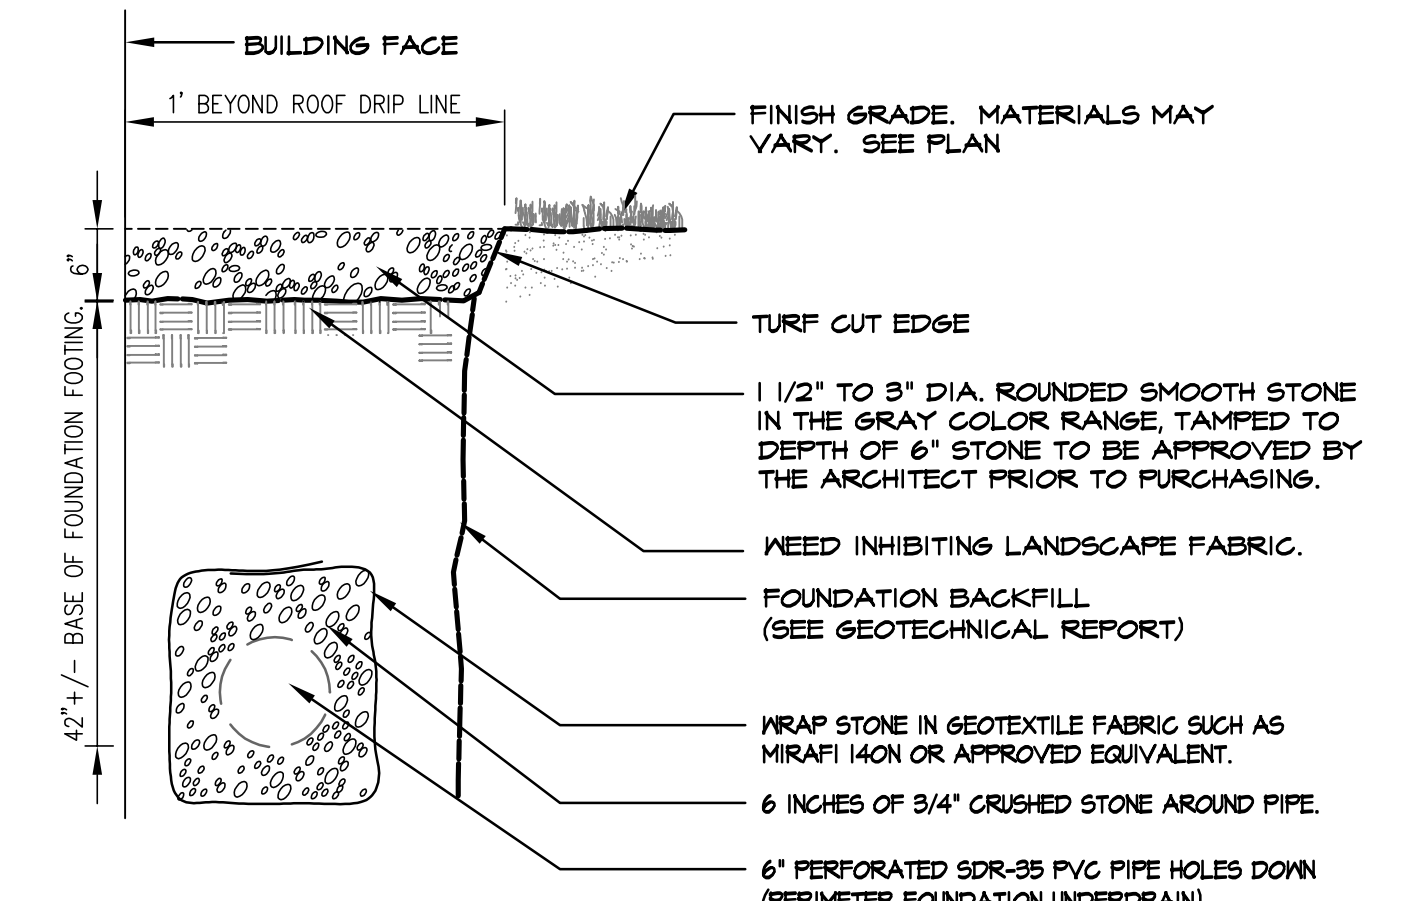


4 DRIP EDGE & PERIMETER DRAIN
SCALE: N.T.S.

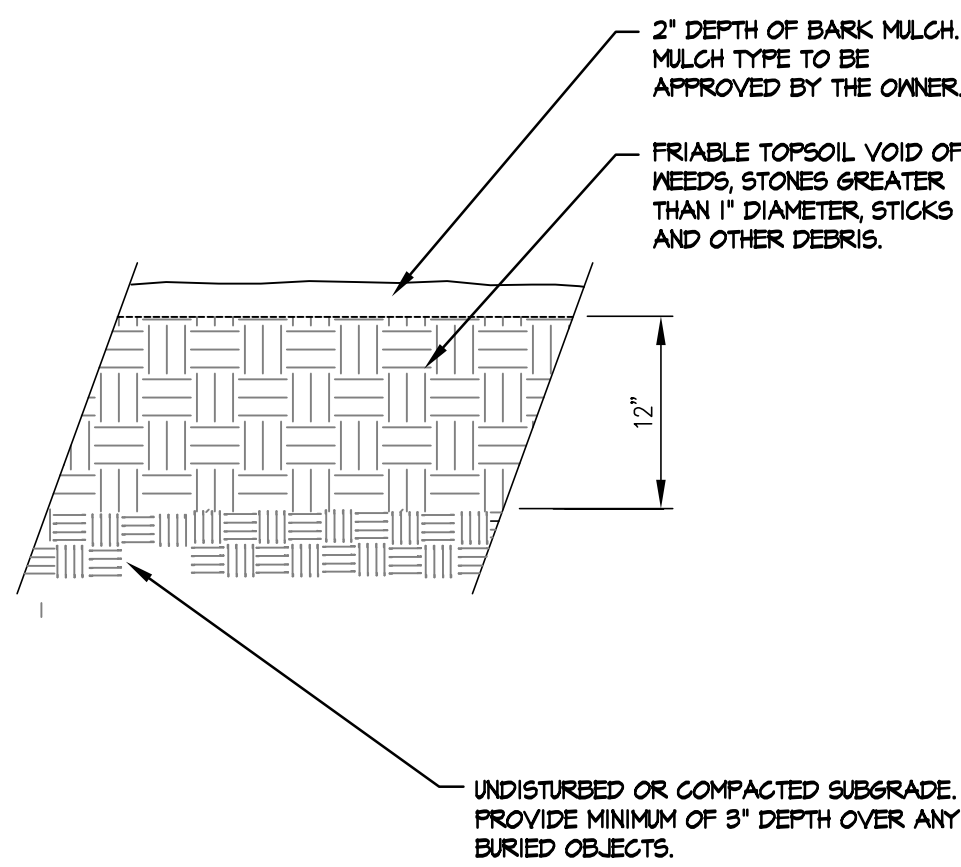


5 PLANT BED
SCALE: N.T.S.

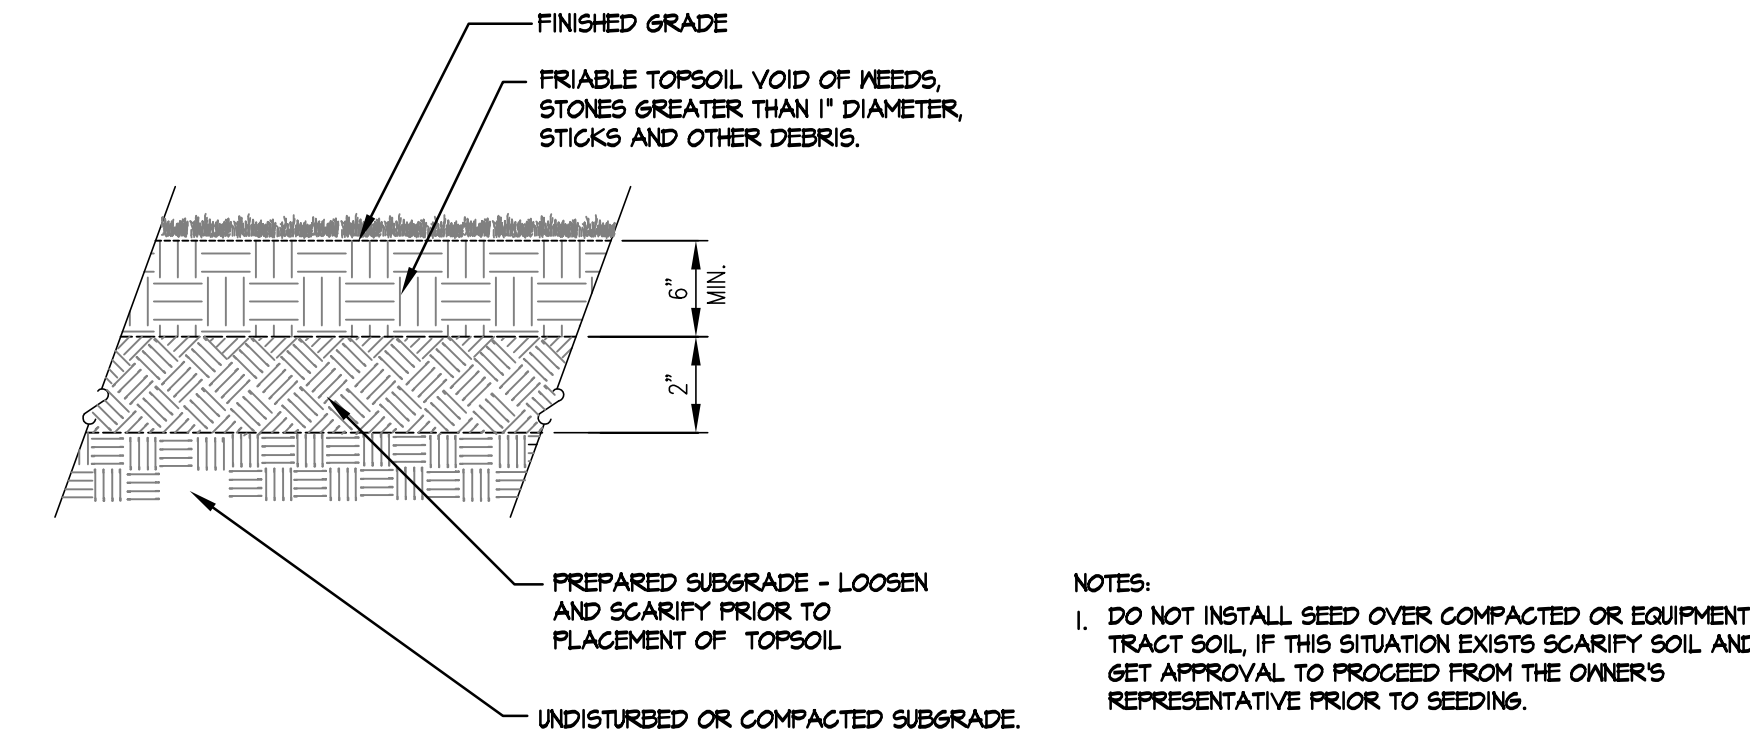


6 LAWN INSTALLATION (SEED)
SCALE: N.T.S.

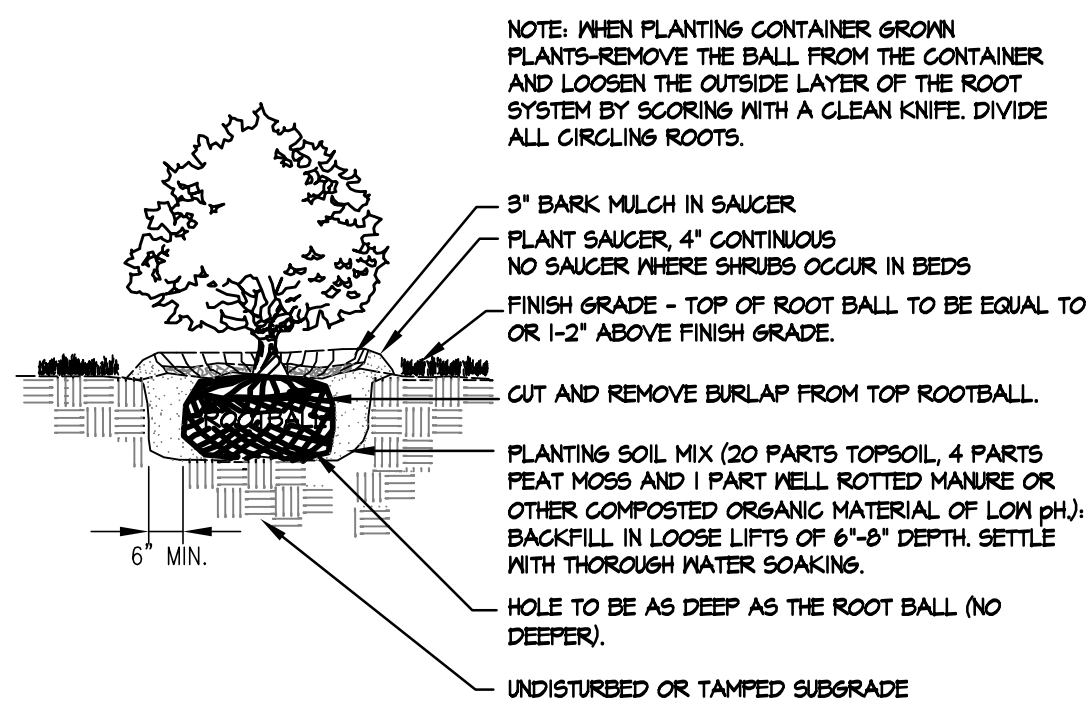


7 SHRUB PLANTING DETAIL
SCALE: N.T.S.

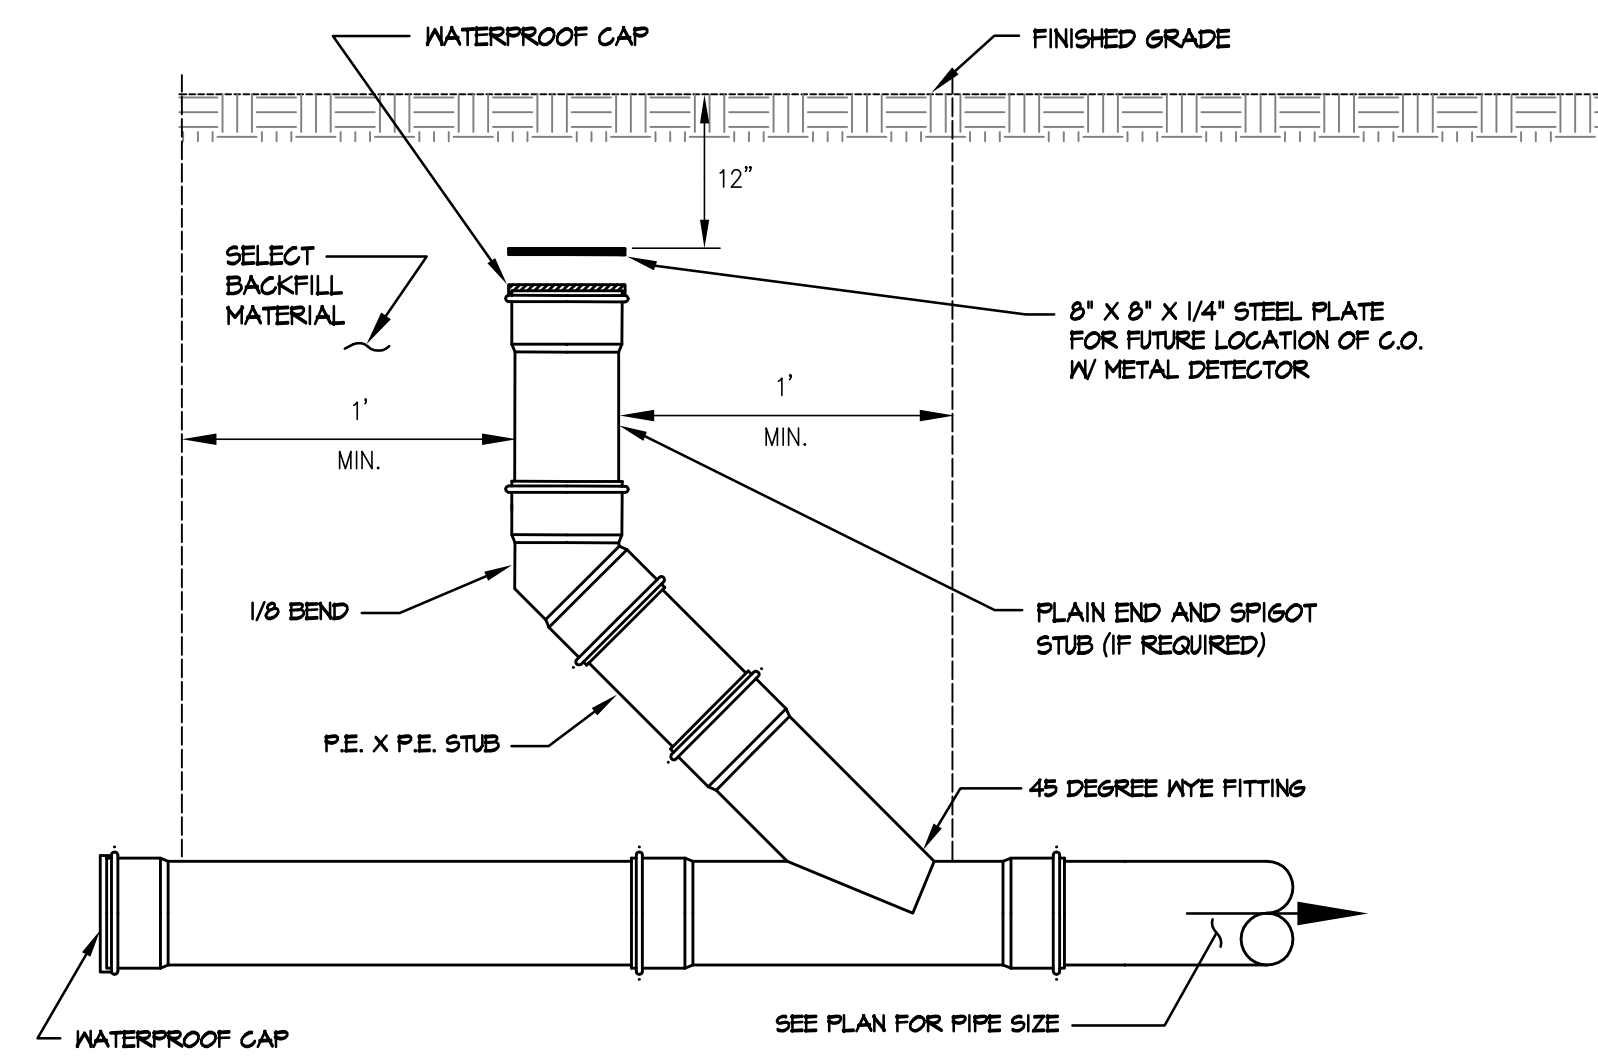

8 PERIMETER FOUNDATION UNDERDRAIN CLEANOUT
SCALE: N.T.S.

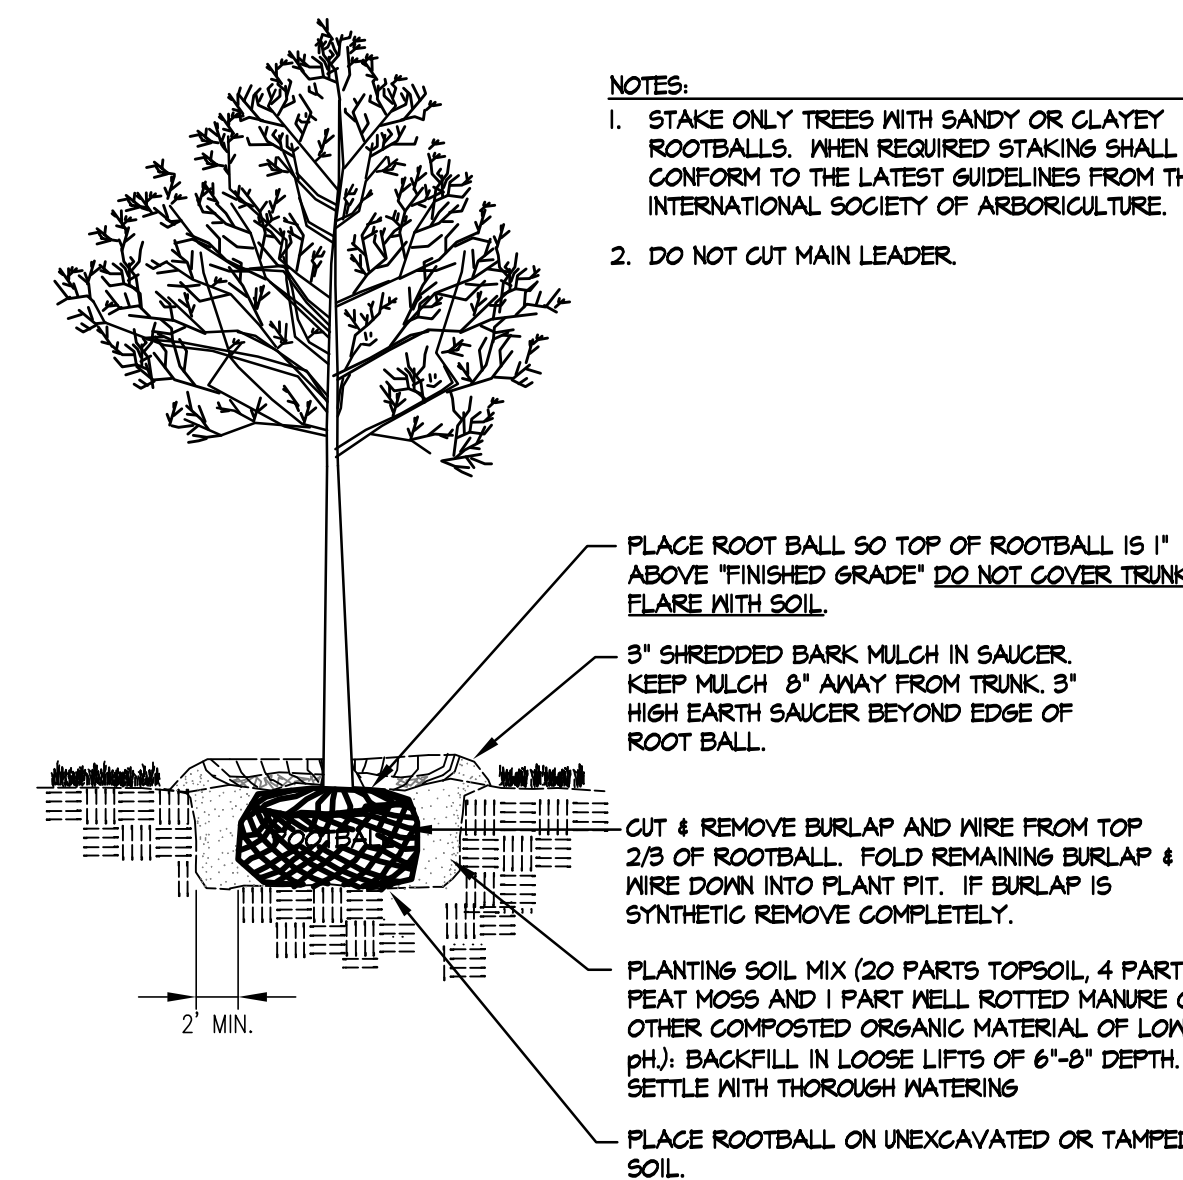

9 DECIDUOUS TREE PLANTING
SCALE: N.T.S.

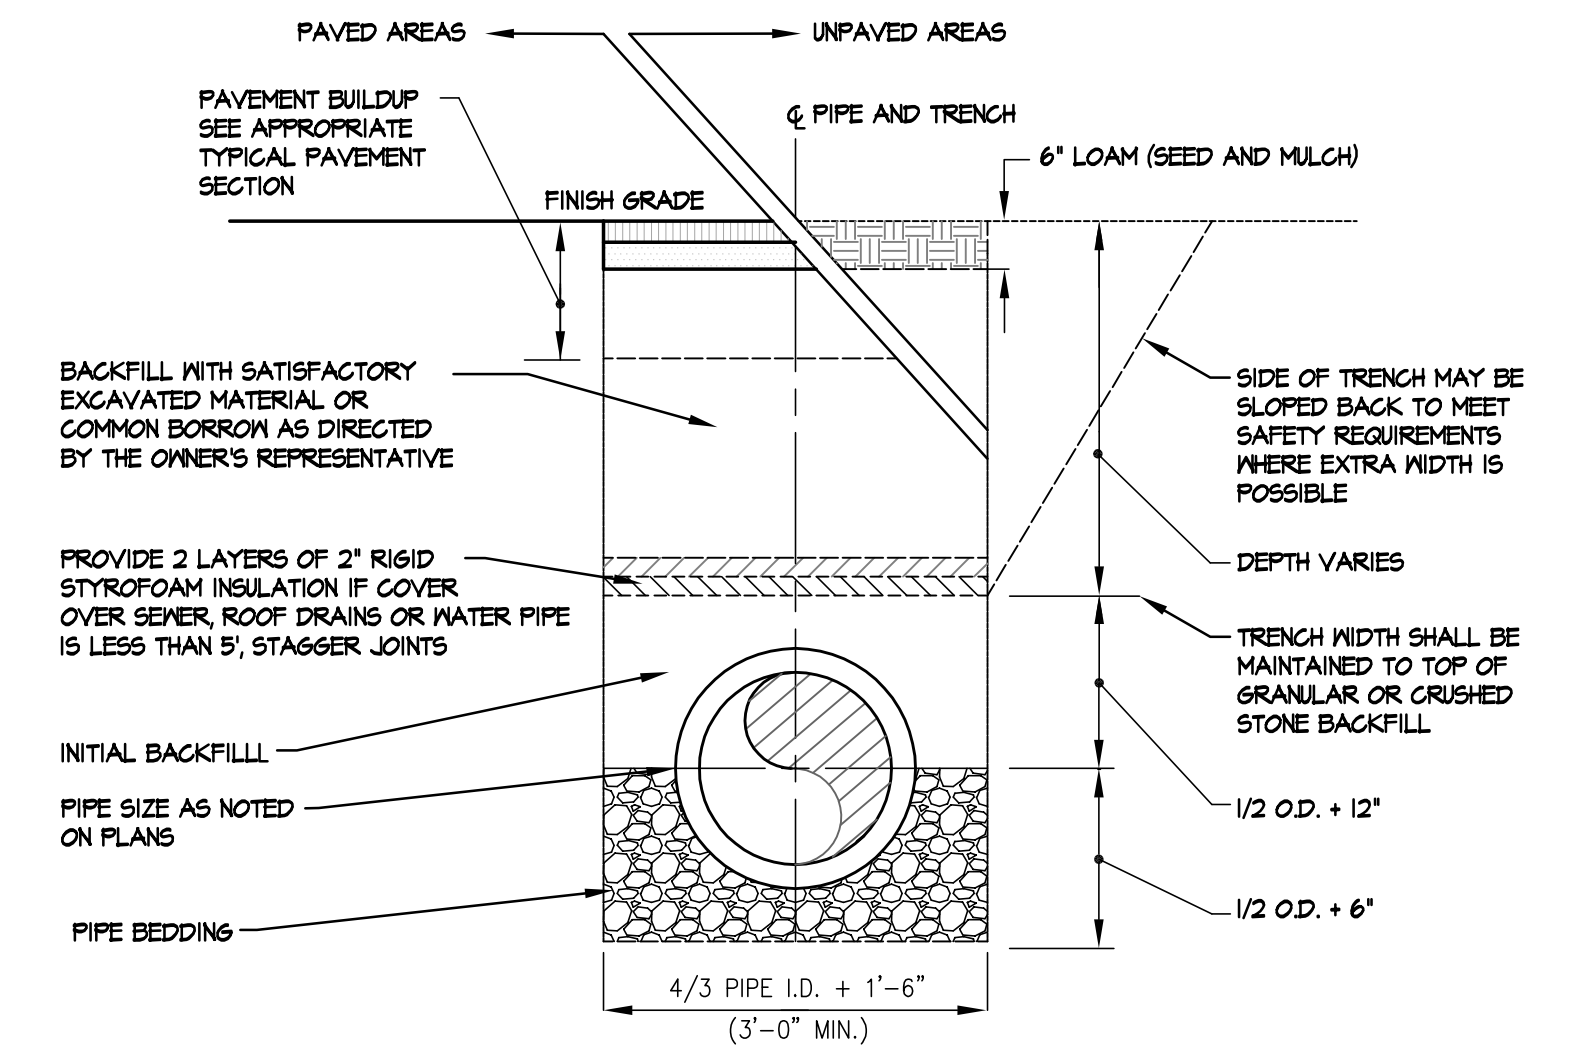

TRENCH BACKFILL SCHEDULE


PIPE MATERIAL	PIPE BEDDING	INITIAL BACKFILL	BACKFILL
HDPE	3/4" CRUSHED STONE	3/4" CRUSHED STONE	**EXCAVATED MATERIAL OR GRANULAR BORROM
PVC	3/4" CRUSHED STONE	3/4" CRUSHED STONE	**EXCAVATED MATERIAL OR GRANULAR BORROM
DUCTILE IRON	GRANULAR MATERIAL	GRANULAR MATERIAL	**EXCAVATED MATERIAL OR GRANULAR BORROM
COPPER	SAND	SAND	**EXCAVATED MATERIAL OR GRANULAR BORROM

** EXCAVATED MATERIAL MUST BE REVIEWED AND APPROVED BY THE OWNER'S REPRESENTATIVE PRIOR TO INSTALLATION.
GRANULAR MATERIAL TO BE SAND OR GRAVEL.

10 TYPICAL TRENCH SECTION
SCALE: N.T.S.

Drawing Name: 03 Westminister Home Home Design Details Final Date: 03/01/13 1:24 PM

REV.	DATE	STATUS	BY	CHKD.	APPD.	REV.	DATE	STATUS	BY	CHKD.	APPD.
1	03/01/13	ISSUED FOR CONSTRUCTION	DEPT.	PBB	PBB						

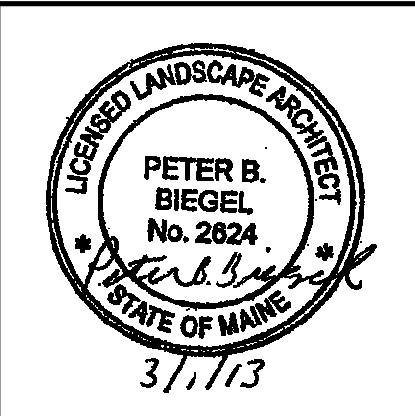

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CLIENT: **BILD ARCHITECTURE**
P.O. BOX 8235, PORTLAND, MAINE

DESIGN: PBB
DRAWN: DEPT.
CHKD: PBB
DATE: JANUARY 2013
SCALE: N.T.S.
PROJ. NO.
DWG. NO.
REV. 1
C-301

GMS, WESTMINSTER HOME
WESTMINSTER AVENUE, PORTLAND, MAINE
SITE DETAILS