

918 Brighton Avenue I Portland, Maine 04102

January 3, 2013

Ms. Nell Donaldson Planning Department Portland City Hall 389 Congress Street Portland, Maine 04101

RE: Response to City Review Comments
Level I Site Plan Development Review Application

Motley Street Extension, Portland, Maine

Dear Ms. Donaldson:

Thank you for forwarding review comments from the City of Portland regarding the Level I Site Plan application for the Motley Street Extension in Portland. Please find our response to the City's comments below:

## **Zoning**

Based on Ms. Schmuckal's comment, the request for a waiver from the street frontage requirement for zone R-3 per section 14-90(c) is withdrawn, as the proposed development meets the requirements of section 14-403.

## **Transportation Standards**

Please see the additional waiver criteria shown below in **bold text** for the request that the requirement to construct a sidewalk and install curb along all frontages, per section 14-526(a)2.c(i) of the City of Portland Code of Ordinances, be waived. The site meets waiver requirements per section 14-506(b) by the following:

#### 1. Sidewalks

- a. 14-506(b)(Sidewalks)3: A safe alternative-walking route is reasonably and safely available, for example, by way of a sidewalk on the other side of the street that is lightly traveled.
  - Currently, Motley Street is improved for approximately 456 feet from the intersection of Brighton Avenue. The current construction does not include sidewalk or curbing. As the street is and will likely remain a dead end local street serving only residential properties, the traffic volume is not expected to significantly increase from the existing condition. In addition, the street is not located within a designated school walking route. Therefore, the safety of pedestrians utilizing Motley Street will not be affected by the development.

- b. 14-506(b)(Sidewalks)6: Strict adherence to the sidewalk requirement would result in the loss of significant site features related to landscaping or topography that are deemed to be of a greater public value.
  - Strict adherence to the sidewalk requirement would result in the loss of significant site features related to landscaping and topography that are deemed to be of greater public value. These site features include the additional vegetation, ledge, and existing lot lawn area that would be required to be removed in order to install the sidewalk to Brighton Avenue.

# 2. Curbing

- a. 14-506(b)(Curbing)4: Strict adherence to the curb requirement would result in the loss of significant site features related to landscaping or topography that are deemed to be of a greater public value.
  - Strict adherence to the curb requirement would result in the loss of significant site features related to landscaping and topography that are deemed to be of greater public value. These site features include the additional vegetation, ledge, and existing lot lawn areas that would be required to be removed in order to install the curb to Brighton Avenue. The increase in elevation at the edge of the road due to curb installation would also require significant regrading of the existing lots to maintain drainage from the lots toward to road.
- b. 14-506(b)(Curbing)6: The cost to construct the curbing, including any applicable street opening fees, is in excess of 5% of the overall project cost.
  - Installation of curbing and sidewalk along the new 90' section of roadway would be impractical unless sidewalk and curb were also installed along the currently improved section of Motley Street. The cost of retrofitting of curb and sidewalk along the existing section of Motley Street would exceed 5% of the overall project cost.

## **Environmental Quality Standards**

Catch basin inlet protection provisions have been added to the site plans. A symbol and leader note have been added to sheet C2.1 and the appropriate detail has been added to sheet C3.2 (detail #7).

The project data sheet has been revised to indicate the existing and proposed impervious area associated with the roadway construction area only. The existing impervious area within the roadway construction area is 4,323 square feet, which includes existing gravel, pavement, and exposed ledge. The total paved area is 3,390 square feet. As all of the proposed paved area will be constructed over existing impervious area, there will be no net increase in impervious area as a result of the development.

# **Public Infrastructure and Community Safety Standards**

In regards to Captain Pirone's comments, additional information has been obtained from the Portland Water District (see enclosed Ability to Serve letter), which indicates that the existing water line under Motley Street is an 8" ductile iron line with a static pressure of 81 psi. In telephone discussions with Captain Pirone, the larger diameter water line and high pressure in the water line has relieved his concerns for flow requirements for the project. In addition, the sprinkler systems for the houses will be designed by a professional sprinkler designer who will determine if the necessary pressure and flow requirements for the sprinkler systems are met.

Walsh Engineering Associates, Inc. has reviewed section 3.7 of the City's Technical Manual and has added a note to sheets C.2.0, C2.1, and C3.0 that a blasting permit and all associated submittals will be required for a "large blast" operation (removal of greater than 300 c.y. of rock material).

As requested, enclosed you will find one (1) complete paper set of the final plans and the updated Project Data sheet. Also enclosed is a copy of the Portland Water District Ability to Serve Letter for the two residential lots.

I trust you will find this information provided sufficient for the site plan approval. We look forward to working with you as the project progresses.

Respectfully,

William R. Walsh, III, PE

Walsh Engineering Associates, Inc.

William Thebshill

Enc. Site Plans and Details – Rev. 2 dated January 3, 2013

Project Data Sheet

Portland Water District Ability to Serve Letter

cc. Mr. Scott Lalumiere, Milk Street Capital, LLC

I hereby certify that I am the Owner of record of the named property, or that the owner of record authorizes the proposed work and that I have been authorized by the owner to make this application as his/her authorized agent. I agree to conform to all applicable laws of this jurisdiction. In addition, if a permit for work described in this application is issued, I certify that the Planning Authority and Code Enforcement's authorized representative shall have the authority to enter all areas covered by this permit at any reasonable hour to enforce the provisions of the codes applicable to this permit.

This application is for a Site Plan review only, a Performance Guarantee, Inspection Fee, Building Permit Application and associated fees will be required prior to construction.

Please refer to Article V, Site Plan of the City of Portland Land Use Code for detailed information concerning the City's site plan review process, thresholds and standards. Should you have any questions regarding the submittal requirements or any other aspect of the site plan review process, please contact the Planning Division.

# **PROJECT DATA**

The following information is required where applicable, in order complete the application

		sq. ft.
Total Site Area		
Proposed Total Disturbed Area of the Site		sq. ft.
IMPERVIOUS SURFACE AREA		
Proposed Total Paved Area	3,390	sq. ft.
Existing Total Impervious Area	4,323	sq. ft.
Proposed Total Impervious Area	4,323	sq. ft.
Proposed Impervious Net Change	0	sq. ft.
PARKING SPACES		
Existing Number of Parking Spaces	0	
Proposed Number of Parking Spaces	0	
TOTAL Number of Parking Spaces	0	

General Submittal Requirements – Level I Site Alteration						
Applicant Checklist	Planner Checklist	Number of Paper Copies	Submittal Requirement			
X		1	Completed application form.			
×		1	Application fees.			
X		1	Written description of project.			
X		1	Evidence of right, title and interest.			
_ □ N/A		1	Copies of required state and/or federal permits.			
N		1	Written assessment of proposed project's compliance with applicable zoning, requirements.			
$\mathbb{X}$		1	Written description of existing and proposed easements or other burdens.			
$\overline{\mathbb{X}}$		1	Written requests for waivers from individual site plan and/or technical standards.			
X		1	Evidence of financial and technical capacity.			



TRUM SEBAGO LAKE IO CASCO

December 10, 2012

Walsh Engineering Associates, Inc. 918 Brighton Avenue Portland, ME 04102

Attn: Silas Canavan, P.E.

Re: Motley Street, Portland

Ability to Serve with PWD Water

Dear Mr. Canavan:

The Portland Water District has received your request for an Ability to Serve determination for the noted site submitted on December 6, 2012. Based on the information provided, we can confirm that the District will be able to serve the proposed project as further described in this letter.

Please note that this letter does not constitute approval of this project from the District. Please review this letter for any special conditions specified by the District and to determine the appropriate next steps to take to move your project through the submittal and approval process.

# **Existing Site Service**

According to District records, the project site does not currently have existing water service.

## Water System Characteristics

According to District records, there is an 8-inch diameter ductile iron water main on the west side of Motley Street and a public fire hydrant located 165-feet from the site.

Please see attached map showing all available hydrant flow tests near the project site. The current data from the nearest hydrant with flow test information is as follows:

Hydrant Location: Motley Street 200' south of Brighton Avenue

Hydrant Number: POD-HYD01819

Last Tested: 4/16/2003 Static Pressure: 81 psi

Residual Pressure: Not Measured

Flow: Not Measured

## **Public Fire Protection**

It is anticipated that this project will not include the installation of new public hydrants to be accepted into the District water system. The decision to require new hydrants and to determine their locations is solely that of the local fire department. It is your responsibility to contact the Portland Fire Department to ensure that this project is adequately served by existing and/or proposed hydrants.

## **Domestic Water Needs**

The data noted above indicates there should be adequate pressure and volume of water to serve the domestic water needs of the two proposed single family homes. Based on the high water pressure in this area, we recommend that you consider the installation of pressure reducing devices that comply with state plumbing codes.

## Private Fire Protection Water Needs

You have indicated that this project will require water service to provide private fire protection to the site. Please note that the District does not guarantee any quantity of water or pressure through a fire protection service. Please share these results with your sprinkler system designer so that they can design the fire protection system to best fit the noted conditions. If the data is out of date or insufficient for their needs, please contact the MEANS Division to request a hydrant flow test and we will work with you to get more complete data.

## Conditions of Service

Each lot should have a water service line that connects to the main in Motley Street, the service should enter through each lots' own frontage. Please maintain all minimum separation requirements as follows:

- Property lines 10-feet
- Gas mains 6-feet face to face
- Underground electric and telephone 6-feet face to face
- Sanitary sewer 5-feet; if sanitary sewer is laid 18-inches below water service, then an 18-inch horizontal separation is allowable

The District can confirm that the main in Motley Street will provide adequate flow and pressure for domestic needs, as noted above the District does not guarantee any quantity of water or pressure through a fire protection service. A single line may be installed to provide both fire and domestic water. The required diameter of a combined service line must be determined by the sprinkler system designer. The split for the sprinkler service must be located after the water meter and must include a non-testable backflow prevention device. The meter must be appropriately sized by the sprinkler system designer to accommodate the necessary flows for fire protection. Prior to activation of the water service, the sprinkler system designer must provide documentation that shows the appropriate meter size.

If the District can be of further assistance in this matter, please let us know.

Sincerely,


Portland Water District


Glissen Havu, E.I. Design Engineer

#### GENERAL NOTES: I. THE BASIS OF BEARING FOR THIS SURVEY IS TRUE NORTH. STATE PLANE MAINE WEST ZONE, NAD83. THE CONTRACTOR SHALL BE RESPONSIBLE FOR NOTIFYING "DIG SAFE" AND LOCAL UTILITY COMPANIES AT LEAST THREE (3) BUSINESS DAYS, BUT NOT MORE THAN 30 CALENDAR DAYS, 2. DEED AND PLAN BOOK REFERENCES ARE TO THE CUMBERLAND COUNTY REGISTRY OF DEEDS. PRIOR TO THE COMMENCEMENT OF ANY EXCAVATION, IN ACCORDANCE WITH MAINE STATE LAW. "DIG SAFE" TELEPHONE NUMBER IS 1-888-344-7233. 3. REFERENCE IS MADE TO THE FOLLOWING PLANS: THE CONTRACTOR SHALL BE SOLELY RESPONSIBLE FOR ANY AND ALL MEANS, METHODS, AND A. "STANDARD BOUNDARY SURVEY MADE FOR FACILITY SERVICES", BY TITCOMB ASSOCIATES DATED TECHNIQUES EMPLOYED TO PERFORM THE WORK SHOWN ON THE PLANS. 4. THE EXTERIOR BOUNDARY SHOWN HEREON IS BASED ON THE PLAN REFERENCED IN NOTE 3.A. ABOVE. 3. ANY DAMAGE TO EXISTING UTILITIES AND/OR SITE FEATURES AS A RESULT OF CONTRACTOR ACTIVITIES SHALL BE REPAIRED TO THE CONDITION IMMEDIATELY BEFORE DAMAGE OCCURRED AT 5. ELEVATIONS AND CONTOURS ARE BASED ON NAVD88 DATUM. SEE PLAN FOR TBM DESCRIPTION. THE CONTRACTOR'S EXPENSE. CAROLINE STREET (PAPER, UNACCEPTED AND CONTINUED) 4. ALL WORK SHALL COMPLY WITH ALL LOCAL, STATE, AND FEDERAL REGULATIONS INCLUDING ALL LEGEND SAFETY REGULATIONS (OSHA). 527°00'42"W "TITCOMB | 273" S27°00'42"W 50.00' 5. ALL WORK SHALL BE IN CONFORMANCE WITH THE CITY OF PORTLAND AND MAINE DEP REQUIREMENTS. PROPERTY LINE 6. THE CONTRACTOR SHALL SECURE ALL NECESSARY PERMITS FOR THE WORK SHOWN ON THESE INTERNAL LOT LINE PLANS PRIOR TO CONSTRUCTION. PROPERTY HOOK ABUTTER LOT LINE \_\_\_\_\_ 7. ALL EROSION CONTROL MEASURES SHALL BE INSTALLED PRIOR TO ANY SITE EXCAVATION OR PROPERTY LINE SETBACK REGRADING. ZONE LINE 8. CONTRACTOR SHALL VERIFY ALL EXISTING CONDITIONS SHOWN ON THE DRAWINGS. IF ANY NATURAL GAS LINE DISCREPANCIES ARE FOUND, THE OWNER OR OWNER'S REPRESENTATIVE SHALL BE NOTIFIED SEWER LINE 9. THE SUBJECT PROPERTY IS NOT LOCATED WITHIN THE 100-YEAR FLOOD PLAIN AS DEPICTED ON OVERHEAD UTILITY LINE THE FEMA FIRM FLOOD INSURANCE RATE MAPS. EDGE OF GRAVEL DAVID FENTON **EXISTING UTILITY NOTES:** 18609/189 4983/315 CONTOUR LINE CITY OF PORTLAND MAP + 77 MAP 177 16607/283\ LEDGE THE UNDERGROUND UTILITIES SHOWN HAVE BEEN LOCATED FROM FIELD SURVEY INFORMATION AND LOT F020 EXISTING DRAWINGS. KIMBALL SURVEY # DESIGN, INC. (THE SURVEYOR) LOCATED ALL SUCH UTILITIES IN EDGE OF BUILDING THE AREA, EITHER IN SERVICE OR ABANDONED. THE SURVEYOR AND WALSH ENGINEERING ASSOCIATES, INC. FURTHER DO NOT WARRANT THAT THE UNDERGROUND UTILITIES SHOWN ARE IN THE EXACT LOCATION SEWER MANHOLE INDICATED ALTHOUGH THEY DO BELIEVE THAT THEY ARE LOCATED AS ACCURATELY AS POSSIBLE FROM INFORMATION AVAILABLE. THE SURVEYOR HAS NOT PHYSICALLY LOCATED THE UNDERGROUND UTILITIES. CATCH BASIN CALL 1-888-DIGSAFE AT LEAST THREE BUSINESS DAYS BEFORE PERFORMING ANY CONSTRUCTION. GILLESPIE WATER VALVE MICHAEL F. & JENNIFER F THE LOCATION OF THE EXISTING 4" GAS LINE BEYOND THE SOUTHERLY END OF PAVEMENT WAS NOT 27355/66 HYDRANT SURVEYED. A MAP PROVIDED BY UNITIL INDICATED THAT THE GAS MAIN CONTINUES BEYOND THE EDGE OF PAVEMENT TO SERVE THE GILLESPIE PROPERTY, HOWEVER, THE EXACT LOCATION OF THE MAIN WAS NOT DETERMINED. IT IS ASSUMED THAT THE GAS MAIN BENDS AROUND THE EXISTING LEDGE AT THE END GAS VALVE OF THE EXISTING PAVEMENT AND CONTINUES UNDER THE EXISTING GRAVEL ROAD. THE CONTRACTOR SHALL VERIFY THE LOCATION OF THE EXISTING GAS MAIN BY CALLING I-888-DIGSAFE AT LEAST THREE UTILITY POLE BUSINESS DAYS BEFORE PERFORMING ANY CONSTRUCTION. REBAR W/ CA PROPERTY LINE MONUMENTATION ZONING STANDARDS: I. RESIDENTIAL: SIXTY-FIVE HUNDRED (6,500) SQUARE FEET PARCEL DATA (B) MINIMUM LOT AREA PER DWELLING UNIT: (All Lots Identified on Tax Map 177) PRUD: SIXTY-FIVE HUNDRED (6,500) SQUARE FEET OF NET LAND AREA AREA (SQ. FT.) GILLESPIE MAP 177 MICHAEL F. & JENNIFER F. (C) MINIMUM STREET FRONTAGE: FIFTY (50) FEET, EXCEPT THAT LOTS LOCATED IN A SUBDIVISION LOT FO12 APPROVED AFTER THE EFFECTIVE DATE OF ORD. NO. 165-97 PURSUANT TO SECTION 14-497.5 SHALL 5,000 F 012 MEET THE STREET FRONTAGE REQUIREMENTS APPROVED AS PART OF THE SUBDIVISION PLAN UNDER THE TERMS OF THAT SECTION. 17944/193 STEPHEN E. GRANEY III (D) MINIMUM YARD DIMENSIONS: 17983/294 MAP 177 24,583 (0.56 ACRES I. FRONT YARD: PRINCIPAL OR ACCESSORY STRUCTURES: TWENTY-FIVE (25) FEET. LOT FOII 2. REAR YARD: TWENTY-FIVE (25) FEET. 3. SIDE YARD: HEIGHT OF STRUCTURE REQUIRED SIDE YARD I STORY . . . . . . . 8 FEET I I/2 STORIES . . . . . 8 FEET . . . . . . . . . . . 14 FEET 2 STORIES . . 2 1/2 STORIES . . . . . . . 16 FEET (E) MAXIMUM LOT COVERAGE: THIRTY-FIVE (35) PERCENT OF LOT AREA. RIM = 74.70INV. IN = 67.20(F) MINIMUM LOT WIDTH: SIXTY-FIVE (G5) FEET. INV. OUT = 67.10(G) MAXIMUM STRUCTURE HEIGHT: THIRTY-FIVE (35) FEET. RIM = 70.53INV. IN = 62.934" GAS LINE INV. OUT = 62.93 R-5 DIMENSIONAL REQUIREMENTS TITCOMB 12 (A) MINIMUM LOT SIZE: I . RESIDENTIAL: SIXTY-FIVE HUNDRED (6,000) SQUARE FEET (B) MINIMUM LOT AREA PER DWELLING UNIT: PRUD: SIXTY-FIVE HUNDRED (3,000) SQUARE FEET OF NET LAND AREA (C) MINIMUM STREET FRONTAGE: FIFTY (50) FEET MOTLEY STREET (D) MINIMUM YARD DIMENSIONS: I. FRONT YARD: PRINCIPAL OR ACCESSORY STRUCTURES: TWENTY (20) FEET. (ACCEPTED AND CONTINUED) 2. REAR YARD: TWENTY (20) FEET. 3. SIDE YARD: TO BRIGHTON AVE HEIGHT OF STRUCTURE REQUIRED SIDE YARD I STORY. I I/2 STORIES . . . . . . . 8 FEET 2 STORIES . . . . . . . . . . . . 12 FEET 2 1/2 STORIES . . . . . . . 14 FEET (E) MAXIMUM LOT COVERAGE: FORTY (40) PERCENT OF LOT AREA. (F) MINIMUM LOT WIDTH: SIXTY (60) FEET. 8" WATER MAIN (G) MAXIMUM STRUCTURE HEIGHT: THIRTY-FIVE (35) FEET. ASSUMED LOCATION OF GAS LINE BEYOND VALVE (NOT SURVEYED). STEPHEN PUNSKEY BEE EXISTING UTILITY NOTE 2. 18368/343 LOT E022 MAP 177 LOT EO2 I \_\_\_\_\_\_ NAIL IN UTILITY POLE ELEV. = 77.81

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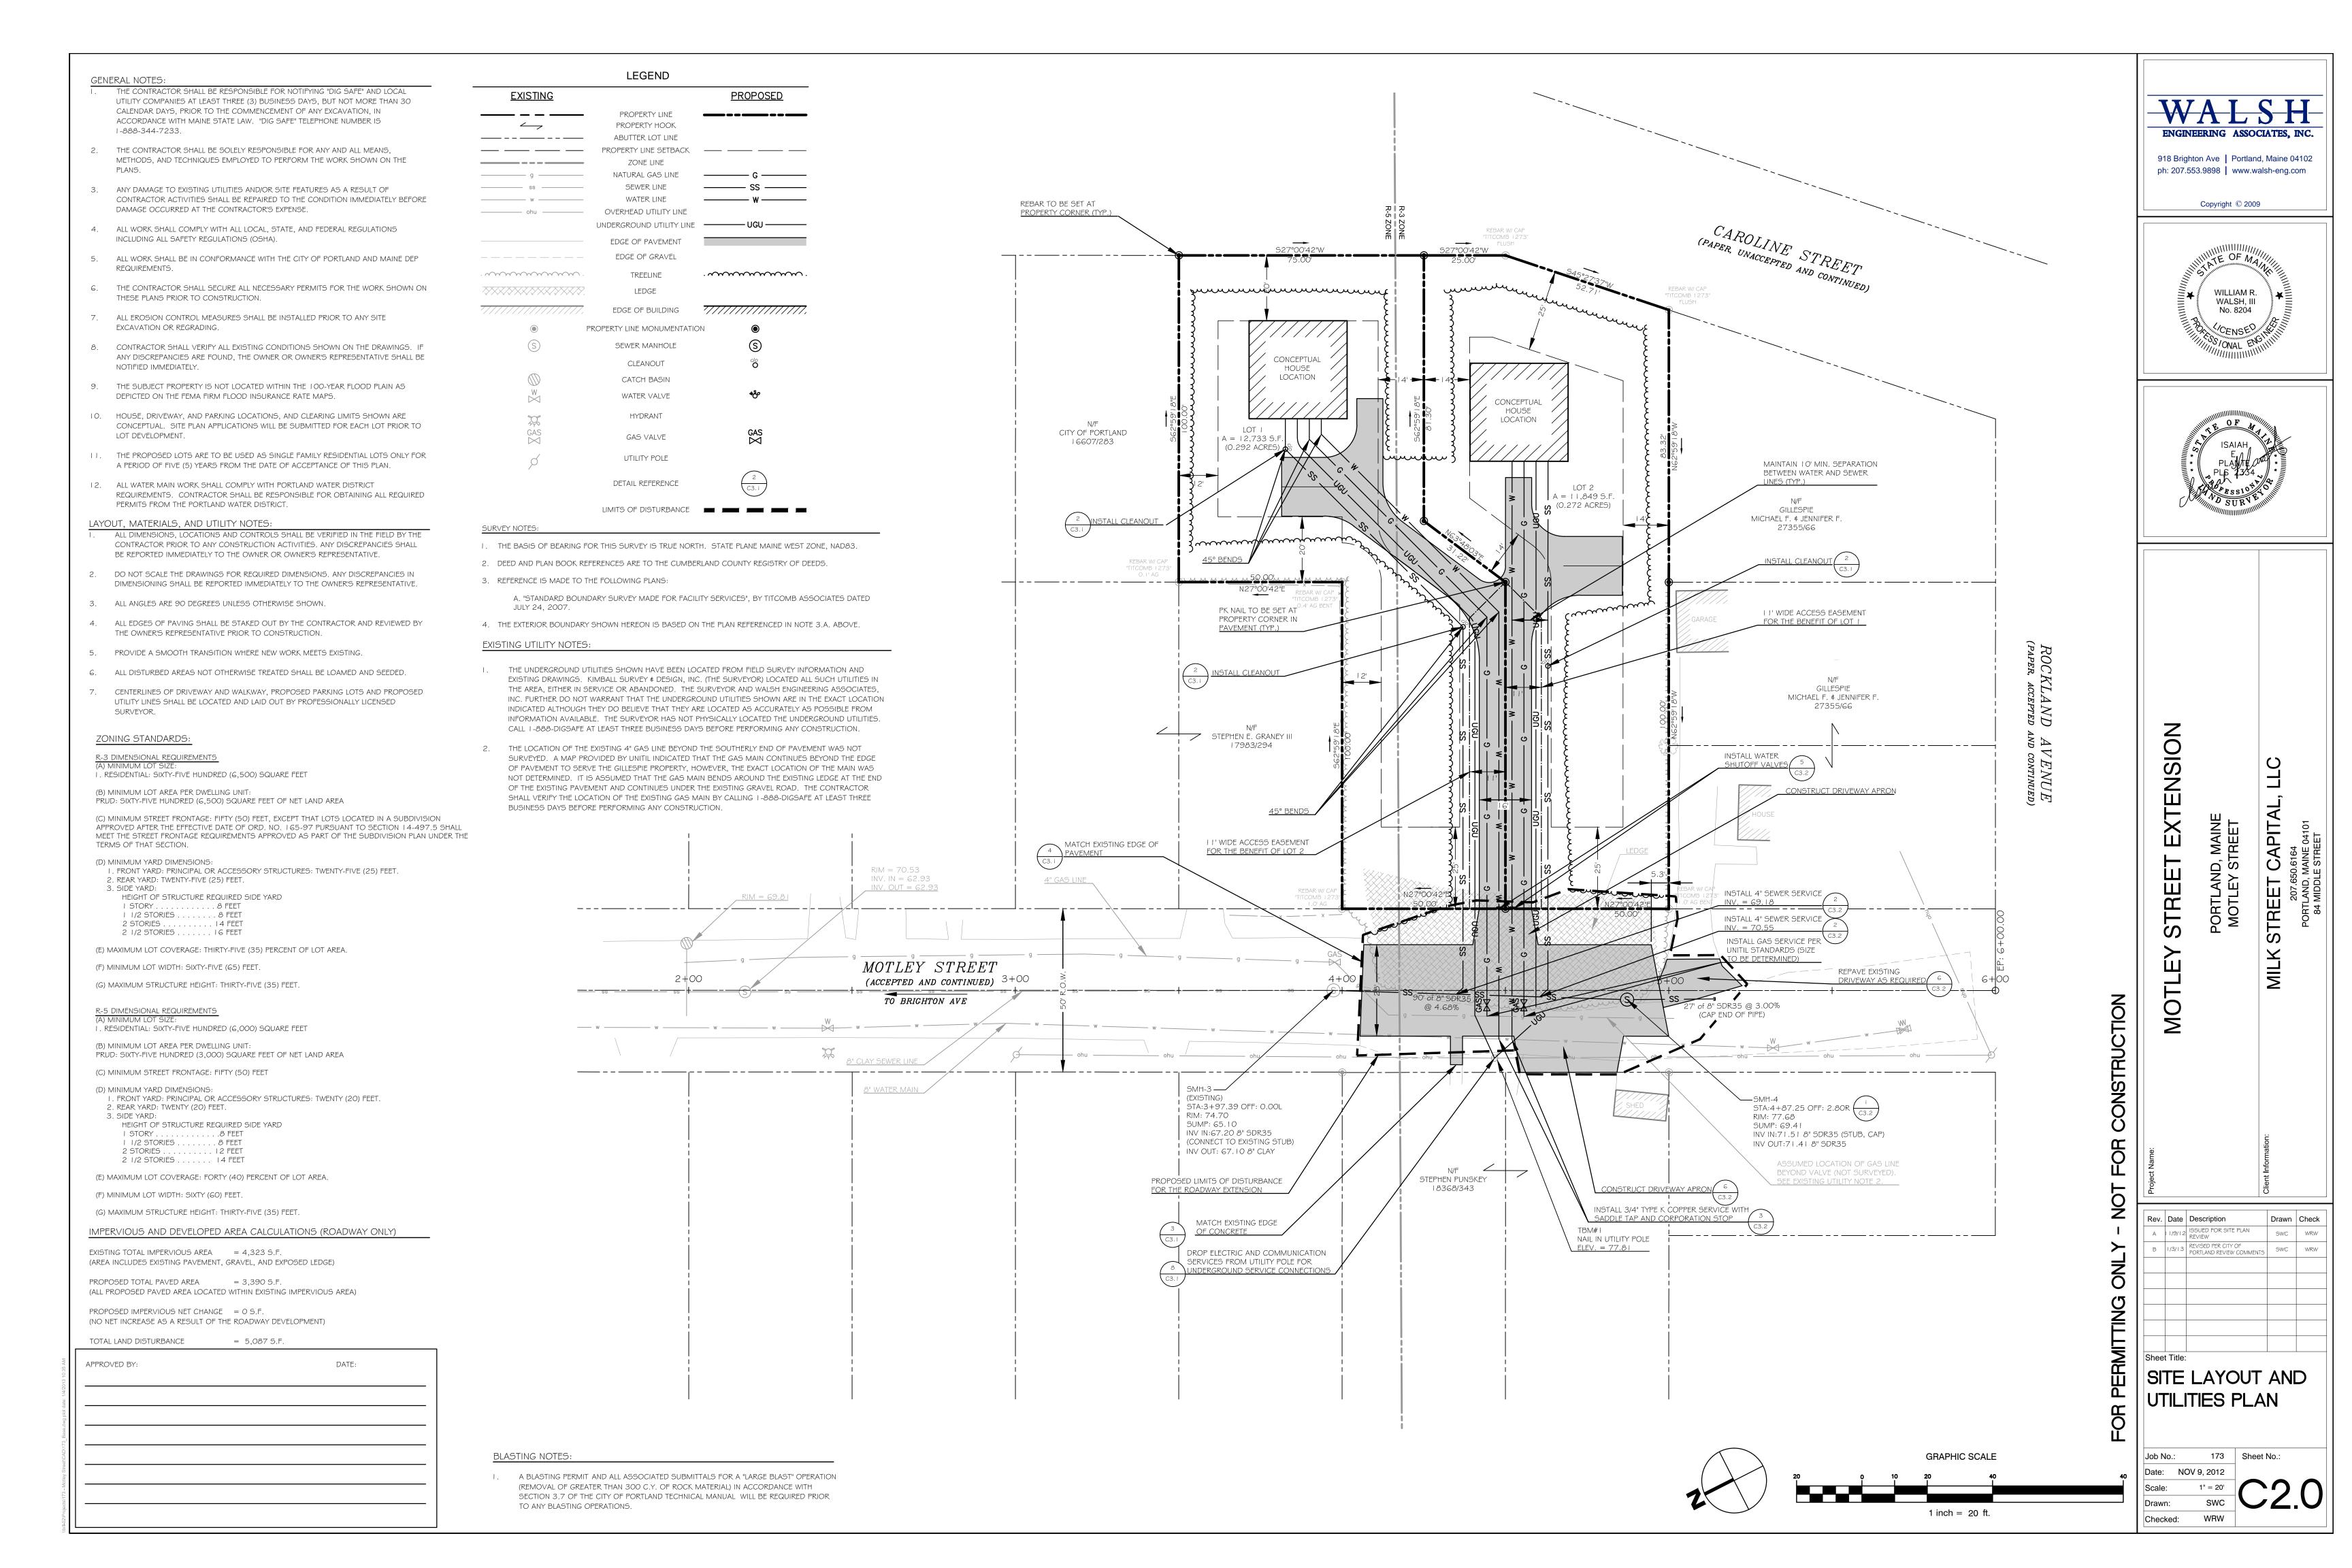


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Drawn Check A 11/9/12 ISSUED FOR SITE PLAN REVIEW B 1/3/13 REVISED PER CITY OF PORTLAND REVIEW COMMENTS

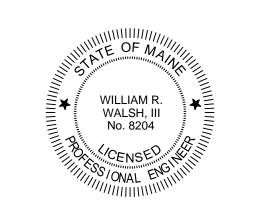
EXISTING CONDITIONS PLAN AND BOUNDARY SURVEY

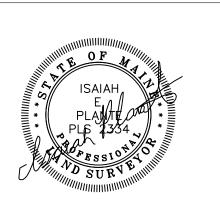173 Sheet No.: NOV 9, 2012 WRW Checked:



#### **EXISTING UTILITY NOTES:** THE CONTRACTOR SHALL BE RESPONSIBLE FOR NOTIFYING "DIG SAFE" AND LOCAL UTILITY COMPANIES AT LEAST THREE (3) BUSINESS DAYS, BUT NOT MORE THAN 30 CALENDAR I. THE UNDERGROUND UTILITIES SHOWN HAVE BEEN LOCATED FROM FIELD SURVEY INFORMATION AND DAYS. PRIOR TO THE COMMENCEMENT OF ANY EXCAVATION, IN ACCORDANCE WITH MAINE EXISTING DRAWINGS. KIMBALL SURVEY & DESIGN, INC. (THE SURVEYOR) LOCATED ALL SUCH UTILITIES IN STATE LAW. "DIG SAFE" TELEPHONE NUMBER IS 1-888-344-7233. THE AREA, EITHER IN SERVICE OR ABANDONED. THE SURVEYOR AND WALSH ENGINEERING ASSOCIATES, INC. FURTHER DO NOT WARRANT THAT THE UNDERGROUND UTILITIES SHOWN ARE IN THE EXACT LOCATION 2. THE CONTRACTOR SHALL BE SOLELY RESPONSIBLE FOR ANY AND ALL MEANS, METHODS, INDICATED ALTHOUGH THEY DO BELIEVE THAT THEY ARE LOCATED AS ACCURATELY AS POSSIBLE FROM AND TECHNIQUES EMPLOYED TO PERFORM THE WORK SHOWN ON THE PLANS. INFORMATION AVAILABLE. THE SURVEYOR HAS NOT PHYSICALLY LOCATED THE UNDERGROUND UTILITIES. CALL I-888-DIGSAFE AT LEAST THREE BUSINESS DAYS BEFORE PERFORMING ANY CONSTRUCTION. 3. ANY DAMAGE TO EXISTING UTILITIES AND/OR SITE FEATURES AS A RESULT OF CONTRACTOR ACTIVITIES SHALL BE REPAIRED TO THE CONDITION IMMEDIATELY BEFORE DAMAGE OCCURRED AT THE CONTRACTOR'S EXPENSE. 2. THE LOCATION OF THE EXISTING 4" GAS LINE BEYOND THE SOUTHERLY END OF PAVEMENT WAS NOT SURVEYED. A MAP PROVIDED BY UNITIL INDICATED THAT THE GAS MAIN CONTINUES BEYOND THE EDGE 4. ALL WORK SHALL COMPLY WITH ALL LOCAL, STATE, AND FEDERAL REGULATIONS INCLUDING OF PAVEMENT TO SERVE THE GILLESPIE PROPERTY, HOWEVER, THE EXACT LOCATION OF THE MAIN WAS ALL SAFETY REGULATIONS (OSHA). NOT DETERMINED. IT IS ASSUMED THAT THE GAS MAIN BENDS AROUND THE EXISTING LEDGE AT THE END CAROLINE STREET (PAPER, UNACCEPTED AND CONTINUED) OF THE EXISTING PAVEMENT AND CONTINUES UNDER THE EXISTING GRAVEL ROAD. THE CONTRACTOR 5. 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SITE PLAN APPLICATIONS WILL BE SUBMITTED FOR EACH LOT PRIOR TO LOT CONCEPTUAL LOT GRADING WILL BE PROVIDED DEVELOPMENT. HOUSE ON INDIVIDUAL SITE PLAN LÓCATION APPLICATIONS. SEE GENERAL I 2. THE PROPOSED LOTS ARE TO BE USED AS SINGLE FAMILY RESIDENTIAL LOTS ONLY FOR A CITY OF PORTLAND PERIOD OF FIVE (5) YEARS FROM THE DATE OF ACCEPTANCE OF THIS PLAN. A = 12,733 S.F.16607/283\ (0.292 ACRES) 13. ALL WATER MAIN WORK SHALL COMPLY WITH PORTLAND WATER DISTRICT REQUIREMENTS. CONTRACTOR SHALL BE RESPONSIBLE FOR OBTAINING ALL REQUIRED PERMITS FROM THE PORTLAND WATER DISTRICT. 14. SEE SURVEY NOTES ON SHEET C1.0 FOR PLAN REFERENCES A = 11,849 S.F. (0.272 ACRES) GILLESPIE LAYOUT, MATERIALS, AND UTILITY NOTES: MICHAEL F. & JENNIFER F. 27355/66 3 mmmmmmmmm ALL DIMENSIONS, LOCATIONS AND CONTROLS SHALL BE VERIFIED IN THE FIELD BY THE CONTRACTOR PRIOR TO ANY CONSTRUCTION ACTIVITIES. ANY DISCREPANCIES SHALL BE REPORTED IMMEDIATELY TO THE OWNER OR OWNER'S REPRESENTATIVE. 2. DO NOT SCALE THE DRAWINGS FOR REQUIRED DIMENSIONS. ANY DISCREPANCIES IN DIMENSIONING SHALL BE REPORTED IMMEDIATELY TO THE OWNER'S REPRESENTATIVE. months. 3. ALL ANGLES ARE 90 DEGREES UNLESS OTHERWISE SHOWN. 4. ALL EDGES OF PAVING SHALL BE STAKED OUT BY THE CONTRACTOR AND REVIEWED BY THE OWNER'S REPRESENTATIVE PRIOR TO CONSTRUCTION. 5. PROVIDE A SMOOTH TRANSITION WHERE NEW WORK MEETS EXISTING. 6. ALL DISTURBED AREAS NOT OTHERWISE TREATED SHALL BE LOAMED AND SEEDED. GILLESPIE 7. CENTERLINES OF DRIVEWAY AND WALKWAY, PROPOSED PARKING LOTS AND PROPOSED MICHAEL F. & JENNIFER F. UTILITY LINES SHALL BE LOCATED AND LAID OUT BY PROFESSIONALLY LICENSED 27355/66 SURVEYOR. STEPHEN E. GRANEY III 17983/294 **BLASTING NOTES:** A BLASTING PERMIT AND ALL ASSOCIATED SUBMITTALS FOR A "LARGE BLAST" OPERATION INSTALL STRAW MATTING (REMOVAL OF GREATER THAN 300 C.Y. OF ROCK MATERIAL) IN ACCORDANCE WITH ON SLOPES STEEPER THAN 3:1 (TYP.) SECTION 3.7 OF THE CITY OF PORTLAND TECHNICAL MANUAL WILL BE REQUIRED PRIOR TO ANY BLASTING OPERATIONS. INSTALL CATCH BASIN PROTECTION ON ALL EXISTING CATCH BASINS IN RIM = 74.70INV. IN = 67.20INV. OUT = 67.10LEGEND <u>PROPOSED</u> **EXISTING** SAWCUT AND REMOVE PAVEMENT PROPERTY LINE PROPERTY HOOK ABUTTER LOT LINE PROPERTY LINE SETBACK — — — — ZONE LINE MOTLEY STREET EDGE OF PAVEMENT (ACCEPTED AND CONTINUED) 3+00 2+00 EDGE OF GRAVEL TO BRIGHTON AVE CONTOUR LINE $\dots$ . ~~~~~~~~. TREELINE LEDGE EDGE OF BUILDING PROPERTY LINE MONUMENTATION SEWER MANHOLE FILL AREA WITH MDOT 703.06(a) TYPE A GRAVEL TO PROVIDE SMOOTH TRANSITION FROM PAVEMENT TO GRAVEL CATCH BASIN WATER VALVE MATCH EXISTING EDGE PROPOSED LIMITS OF DISTURBANCE HYDRANT GAS VALVE STEPHEN PUNSKEY INSTALL CONSTRUCTION UTILITY POLE 18368/343 SILT FENCE \_\_\_\_\_\_ NAIL IN UTILITY POLE ELEV. = 77.81 CONSTRUCTION ENTRANCE SPOT GRADE DETAIL REFERENCE CATCH BASIN INLET PROTECTION


LIMITS OF DISTURBANCE

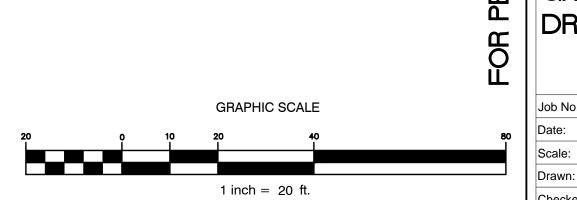

ENGINEERING ASSOCIATES, INC.

918 Brighton Ave | Portland, Maine 04102
ph: 207.553.9898 | www.walsh-eng.com

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TLEY STREET EXTENSIO

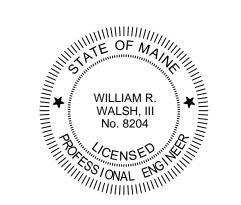MILK STREET CAF

MILK

Rev. Date Description Drawn Check

A 11/9/12 ISSUED FOR SITE PLAN REVIEW

B 1/3/13 REVISED PER CITY OF PORTLAND REVIEW COMMENTS SWC WRW

Sheet Title:

GRADING AND

DRAINAGE PLAN


Job No.: 173 Sheet No.:


Date: NOV 9, 2012


Scale: 1" = 20'

Drawn: SWC

Checked: WRW

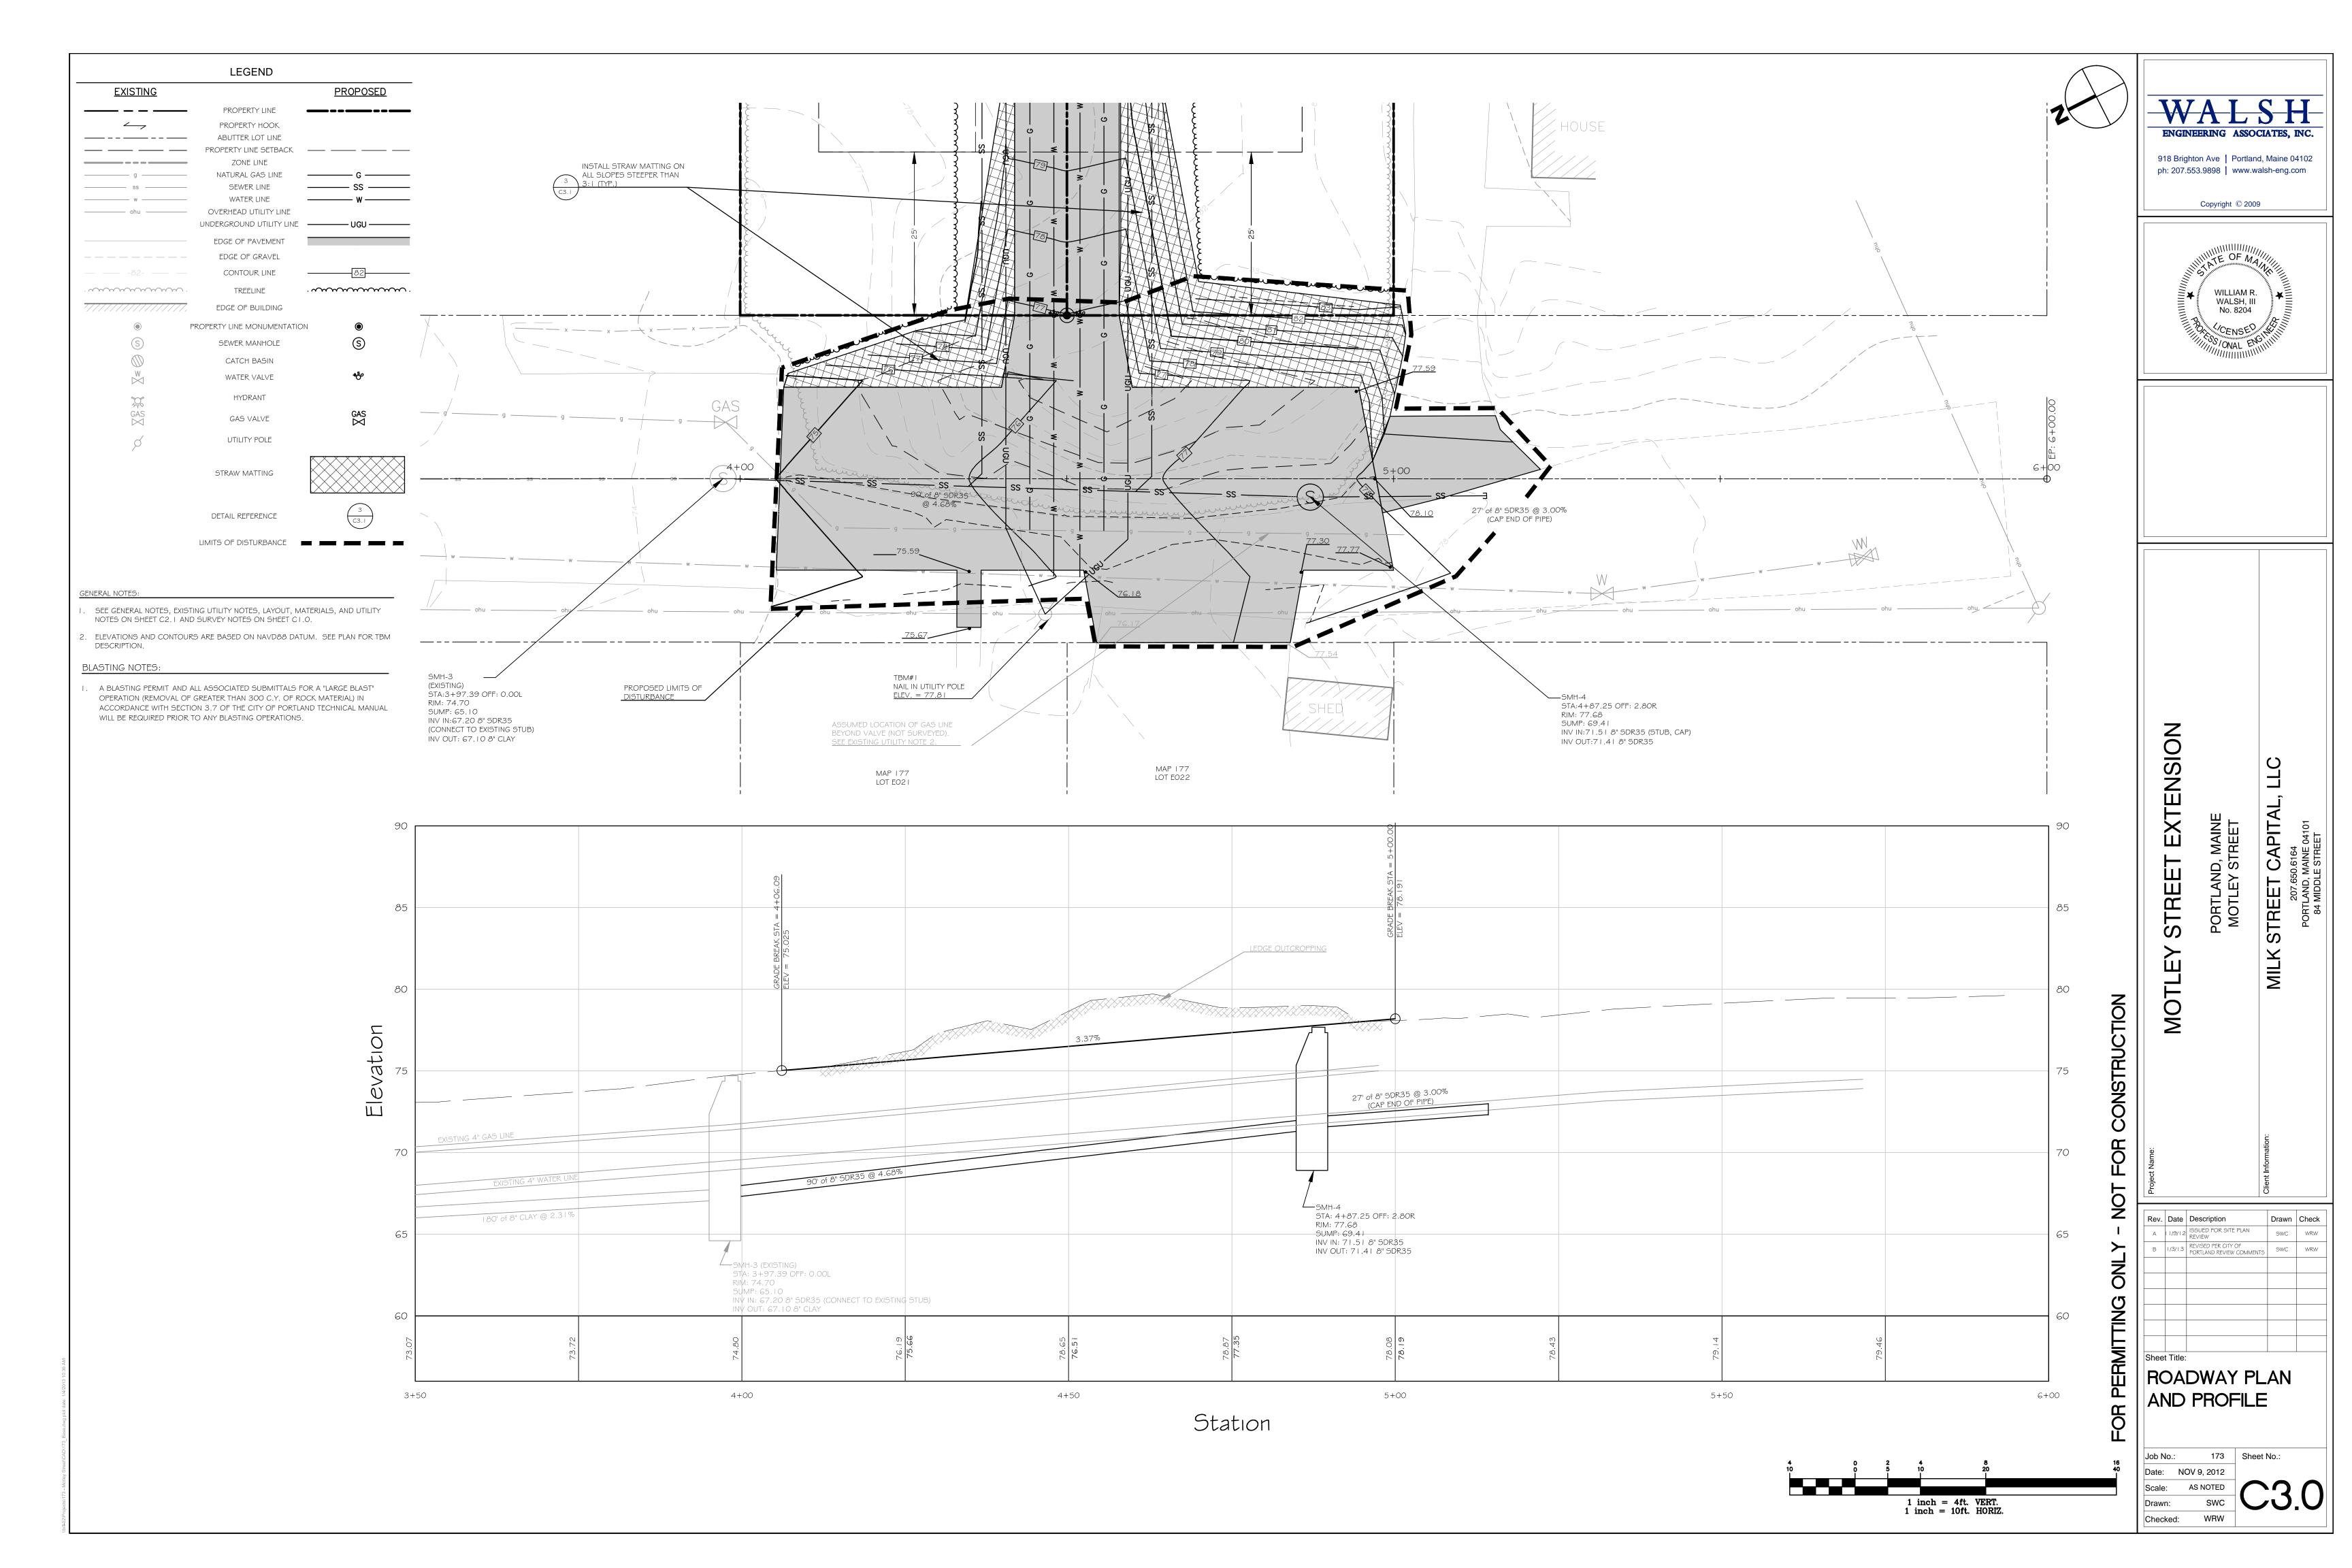


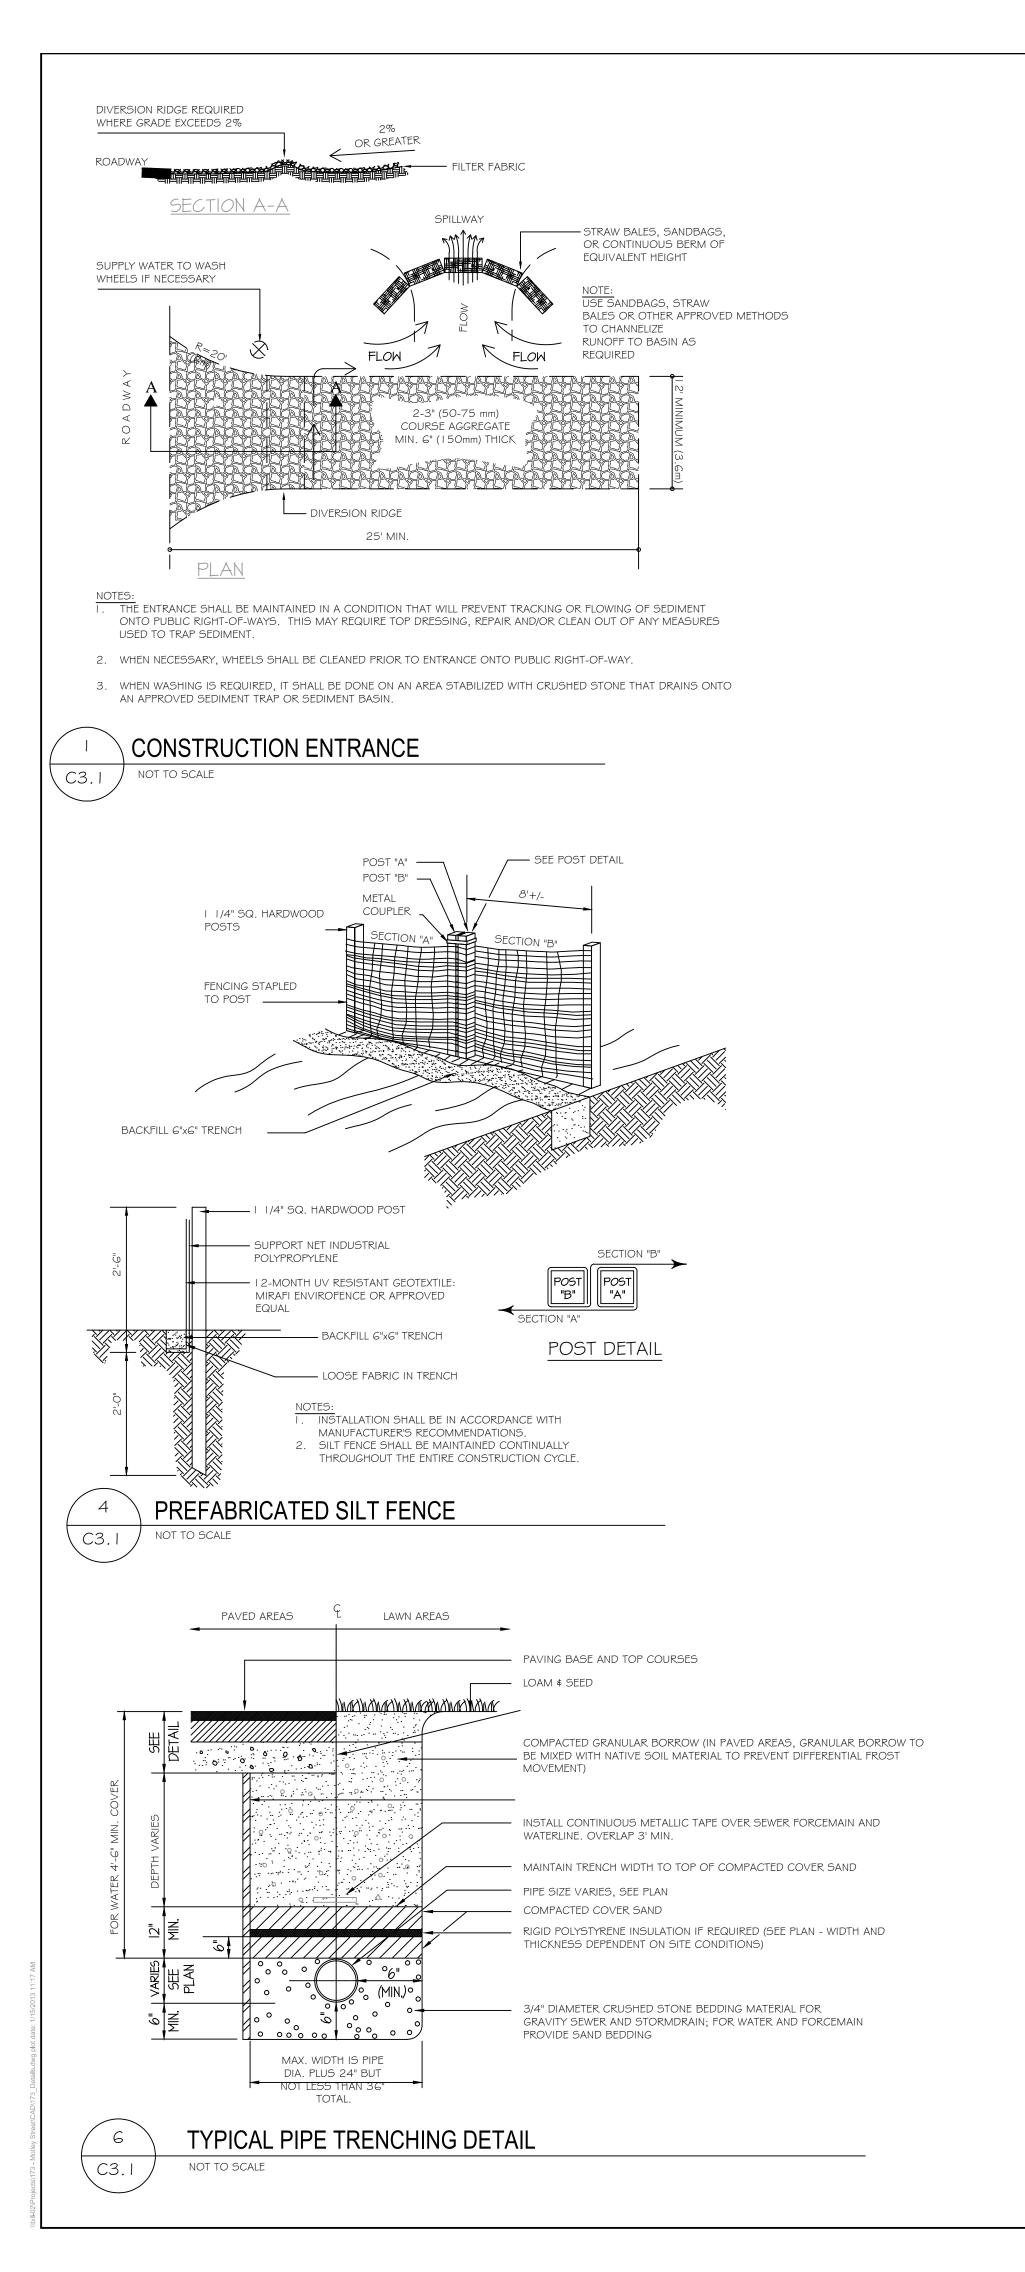


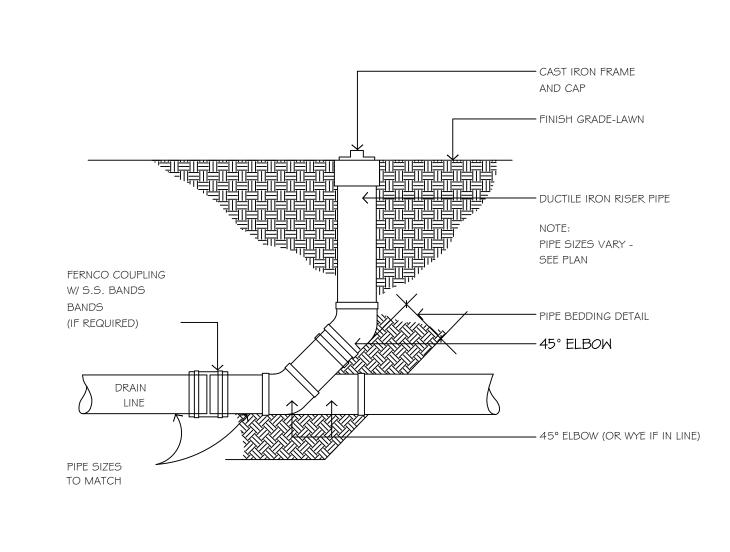


PIPE CLEANOUT DETAIL

NOT TO SCALE

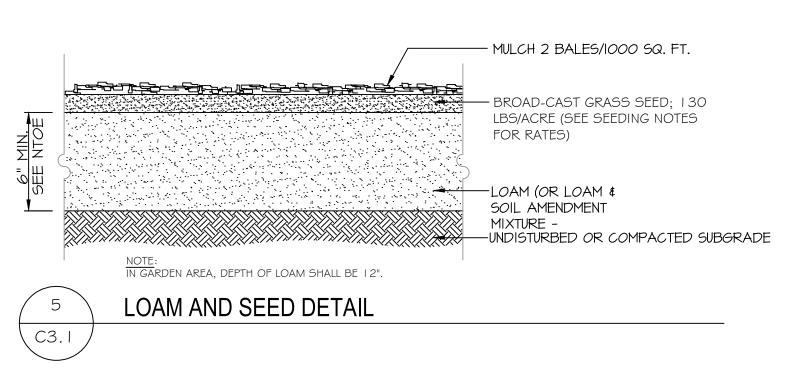

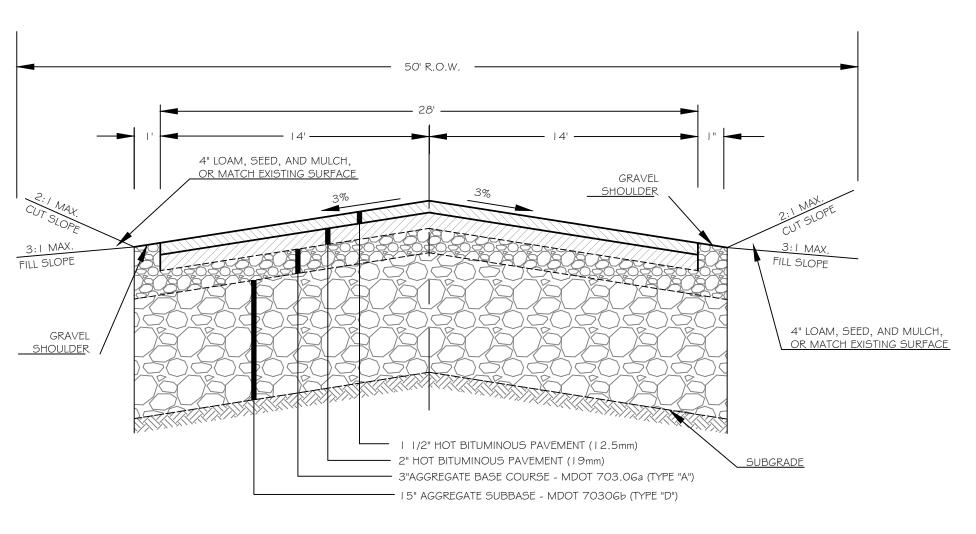




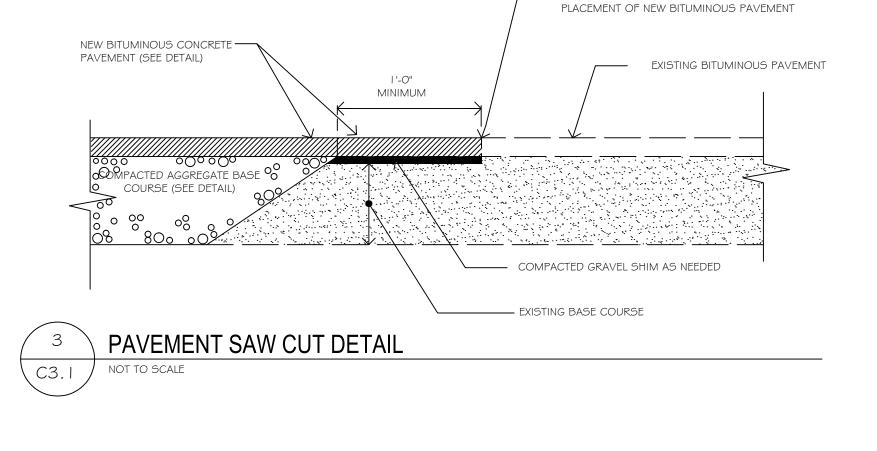

- SAWCUT & REMOVE EXISTING PAVEMENT BACK 1'-0"


AND APPLY BITUMINOUS TACK COAT PRIOR TO

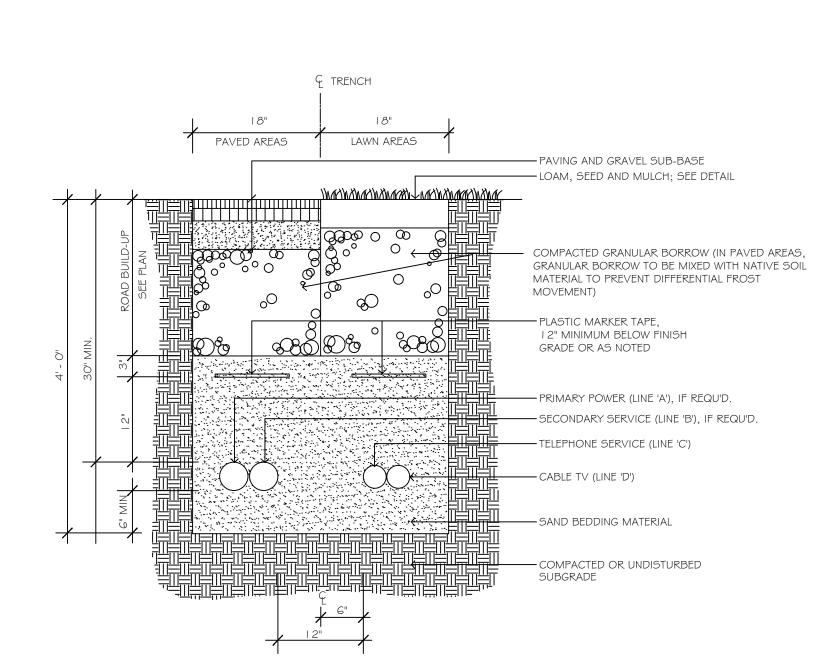


SERVICE	CONDUIT SIZE	CONDUIT TYPE	UTILITY
'A'	4"	SCHEDULE 40 P.V.C. ELECTRICAL GRADE	PRIMARY POWER
'B'	4"	SCHEDULE 40 P.V.C. ELECTRICAL GRADE	SECONDARY POWER
'C'	3"	SCHEDULE 40 P.V.C. ELECTRICAL GRADE	TELEPHONE
'D'	3"	SCHEDULE 40 P.V.C. ELECTRICAL GRADE	CATV
	'A' 'B' 'C'	'A' 4"  'B' 4"  'C' 3"	'A'         4"         SCHEDULE 40 P.V.C. ELECTRICAL GRADE           'B'         4"         SCHEDULE 40 P.V.C. ELECTRICAL GRADE           'C'         3"         SCHEDULE 40 P.V.C. ELECTRICAL GRADE           'D'         3"         SCHEDULE 40 P.V.C.

I. ALL WORK SHALL COMPLY WITH THE RESPECTIVE UTILITY COMPANY STANDARDS. 2. SEE UTILITIES PLANS FOR CONDUIT LOCATIONS. 3. CONTRACTOR TO PROVIDE 1/4" POLYPROPYLENE PULL ROPES IN ALL CONDUITS.

UNDERGROUND UTILITY TRENCH SECTION (MULITPLE CONDUITS) NOT TO SCALE C3.1

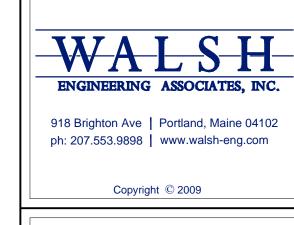

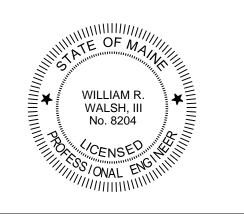

STREE<sup>-</sup>

A 11/9/12 ISSUED FOR SITE PLAN REVIEW B 1/3/13 REVISED PER CITY OF PORTLAND REVIEW COMMENTS

Sheet Title: SITE DETAILS

Date: NOV 9, 2012 NTS

Drawn:

173 Sheet No.: SWC WRW Checked:

