

 \bigcirc $\langle \mathbb{C} \rangle$ $\langle \mathbb{C} \rangle$ SHEATH ONER BED_BCOM Ē $\langle F \rangle$ 31 4'-8" 3'-0" -2 * # # POST 2'-6" 6'-0" SHEATH OVER 252 Ð ž×8 BED ROOM 58 - 5 -2" 3-0


<u>4'-1' 1 3'-9'' 3'-9'' 4'-1''</u> 1 1 1

12 -2'

SECOND FLOOR PLAN SCAL: 1/4"-1"-0"

LEFT HAND UNIT IS MIRROR IMAGE OF RIGHT

12 -2'

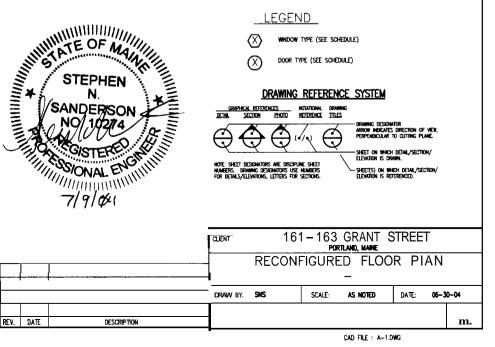

rev.	DATE	DESOR

LEFT HAND UNIT IS MIRROR IMAGE OF RIGHT


GENERAL NOTES:

1. SUBSTITUTE MATERIALS AND/OR SIZES AND GRADES PER CONTRACTOR'S SPECIFICATIONS.


2. CONT. TO VERIFY ALL MATERIALS/SPANS PER MANUFACTURER'S SPECIFICATIONS PRIOR TO CONSTRUCTION

	DOOR SCHEDULE					
SYMB.	MODEL NUMBER	MANUFACTURER	NOMINAL SIZE	REMARKS		
1	4LT	STANLEY	3'-0 "x6'-8 "	Exterior door - steel 6 Panel Woulded - -		
2	2'8" X 80"	MASONITE	2/8 x 80° -	HOLLOW CORE INTERIOR CASED 6 PANEL		
3	2'4" X 80"	MASONITE	2/4 x 80" -	HOLLOW CORE INTERIOR CASED 6 PANEL		
4	-	-	-	-		
5	-	-	-	-		

1	WINDOW SCHEDULE					
SYMB.	SYMB. MODEL NUMBER MANUFACT		STYLE	REMARKS		
Ø	SERIES 1000 R0 46 1/4" X 69 1/4"	AMERICAN CRAFTSMAN	DOUBLE HUNG	EGRESS Clear opening 8.78 ft² 3/8 x 5/6 nominal		
ً₿	SERIES 1000 R0 42 1/4" X 53 1/4"	AMERICAN CRAFTSMAN	Douible- Hung	ECRESS CLEAR OPENING 5.84 FT*2 3/4 x 4/2 NOMINAL		
©	SERIES 1000 RO 38 1/4" X 53 1/4"	AMERICAN CRAFTSMAN	double- Hung	- Clear opening 5.22 FT*2 3/0 x 4/2 Nominal		
Ø	SERIES 2804 RO 84 1/2" X 47 1/2"	AMERICAN CRAFTSMAN	SLIDING WINDOW	- Clear opening 4.73 ft²2 7/0 x 4/0 nominal		
E	SERIES 2802 R0 36 1/2" X 35 1/2"	AMERICAN CRAFTSMAN	sliding Window	- 3/0 x 3/0 nominal		
Ð	EXISTING WINDOW 30° W X 38° H Nominal	EXISTING	DOUBLE HUNG	-		

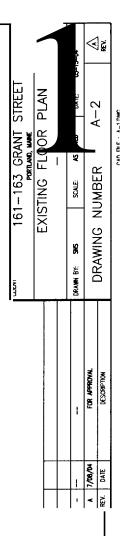


- GENERAL NOTES. 1. SUBSTITUTE MATERIALS AND/OR SIZES AND GRADES PER CONTRACTOR'S SPECIFICATIONS. 2. CONT. TO VERIFY ALL MATERIALS/SPANS PER MANUFACTURER'S SPECIFICATIONS PRIOR TO CONSTRUCTION.

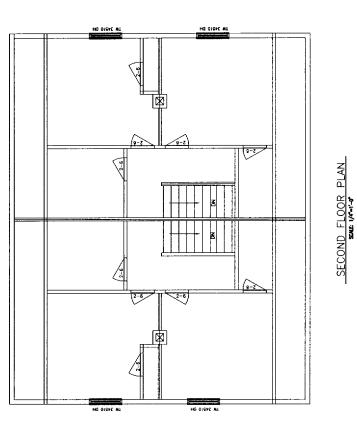


STEPHEN NO 1000 MILLION


719 10H

7

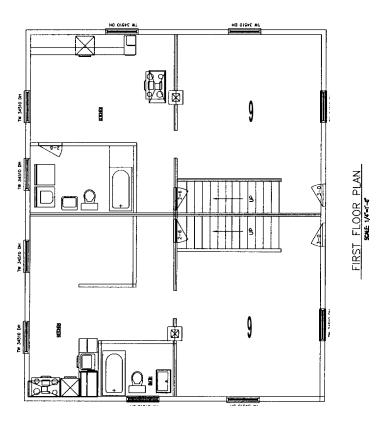



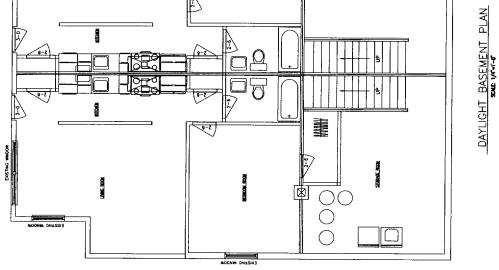


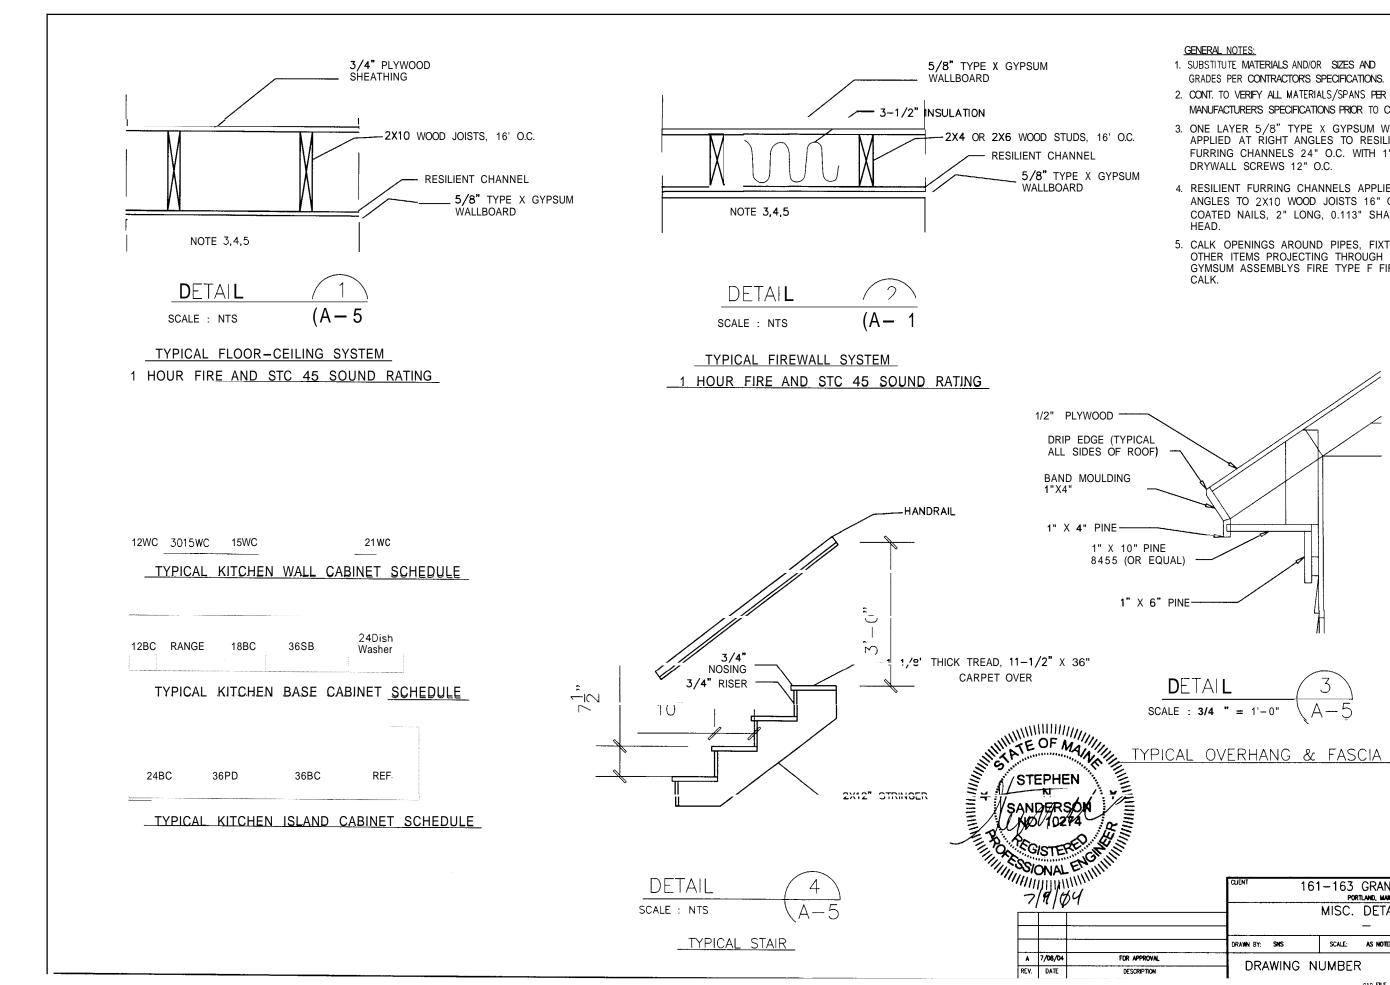


- GRADES PER CONTRACTOR'S SPECIFICATIONS.
- MANUFACTURER'S SPECIFICATIONS PRIOR TO CONSTRUCTION
- 3. ONE LAYER 5/8" TYPE X GYPSUM WALLBOARD APPLIED AT RIGHT ANGLES TO RESILIENT FURRING CHANNELS 24" O.C. WITH 1" TYPE S
- 4. RESILIENT FURRING CHANNELS APPLIED AT RIGHT ANGLES TO 2X10 WOOD JOISTS 16" O.C. WITH 6D COATED NAILS, 2" LONG, 0.113" SHANK, 17/64"
- 5. CALK OPENINGS AROUND PIPES, FIXTURES, AND OTHER ITEMS PROJECTING THROUGH FIRE RATED GYMSUM ASSEMBLYS FIRE TYPE F FIRE RATED

TYPICAL OVERHANG & FASCIA DETAIL

	CUENT 16	1—163 GRANT Portland, maine	STREET	
	MISC. DETAILS			
	DRAWN BY: SNS	SCALE: AS NOTED	DATE: 06-30-04	
PROVAL RIPTION	DRAWING N	UMBER A	-3 <u>A</u>	
	•	CAD FILE A-1.	DWG	

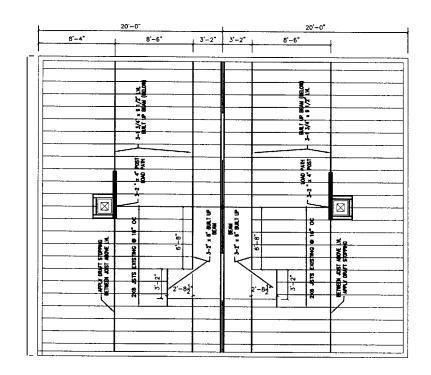

SECOND FLOOR FRAMING SCALE: 1/4"=1"-0"

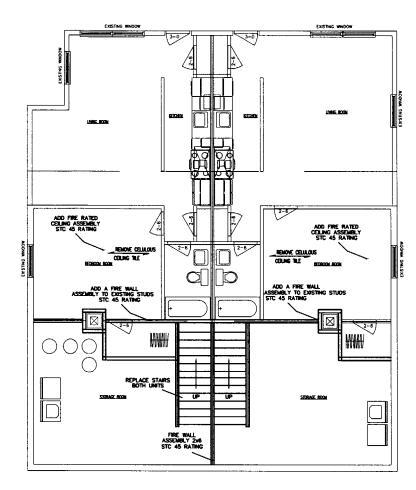

DAYLIGHT BASEMENT PLAN SCAL: 1/4"=1"-0"

A	7/08/04	Fa APP
rev	DAF	DESCR

GENERAL NOTES:

 CALK OPENINGS AROUND PIPES, FIXTURES, AND OTHER ITEMS PROJECTING THROUGH FIRE RATED GYMSUM ASSEMBLYS FIRE TYPE F FIRE RATED CALK.



	CLENT 200 STEVENS AVENUE PORTLAND, MARKE				
	FRAMING AND DAYLIGHT BASMENT REPAIRS AND ALTERATIONS				
	DRAWIN BY SINS	SCALE AS NOTED	DATE: 05-0	9-02	
PROVAL	DRAWING NUMBER A-4				
NOTAR					

