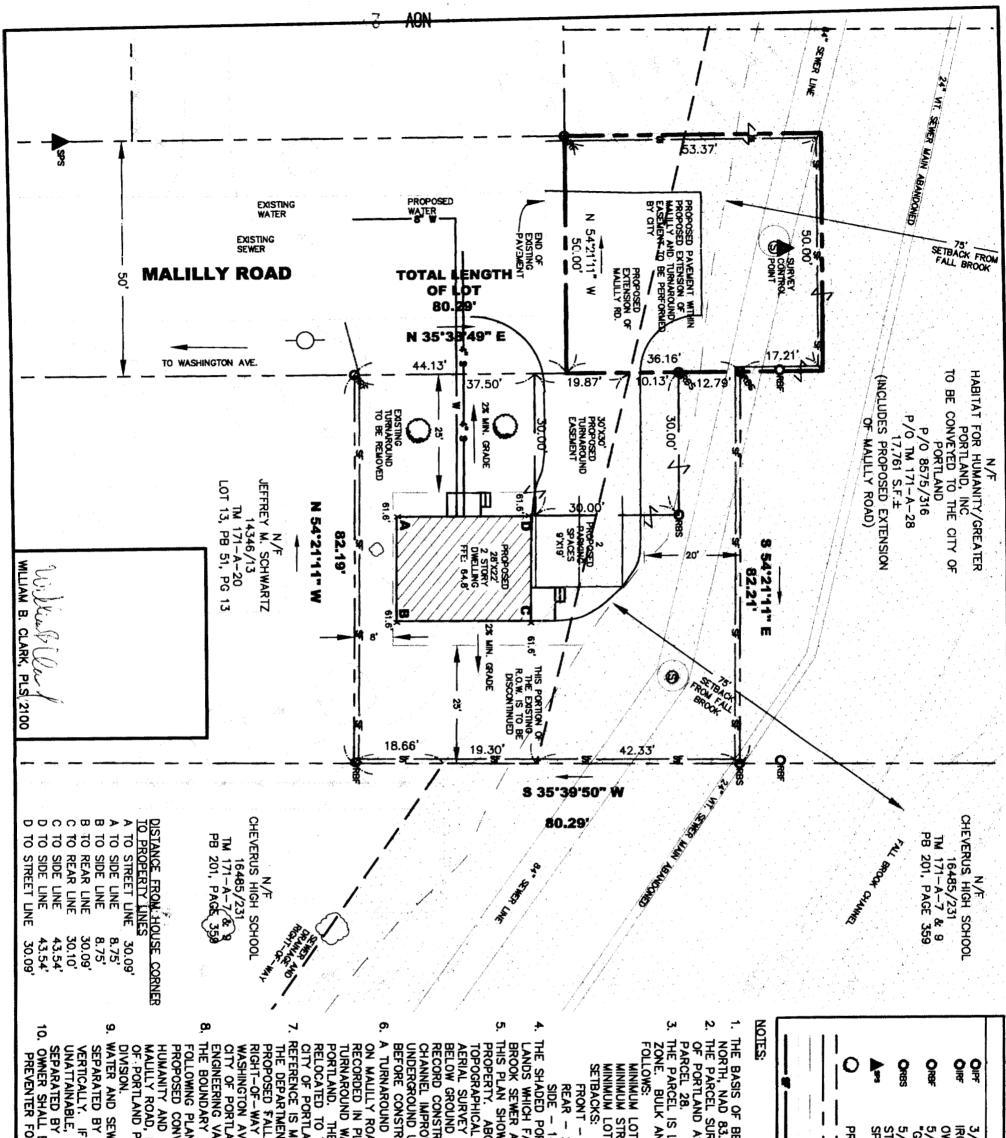
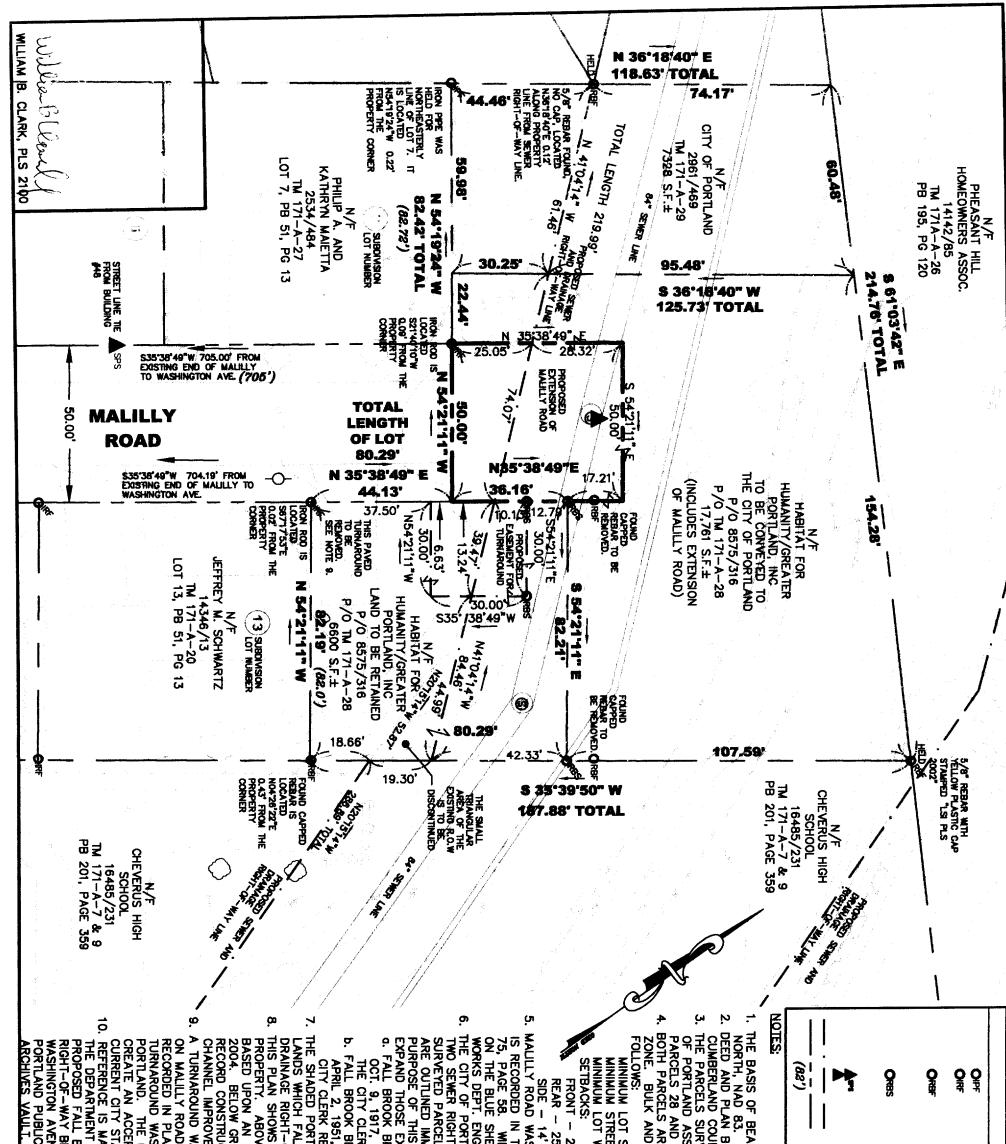
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| HE EXISTING TURNAROUND WILL BE THE PROPOSED TURNAROUND WILL BE AND. MADE TO A PLAN BEING PREPARED BY ENT OF PUBLIC WORKS FOR THE LL BROOK SEWER AND DRAINAGE Y BETWEEN RAY STREET AND AVENUE TO BE ON FILE AT THE LAND PUBLIC WORKS DEPARTMENT VAULT. Y SHOWN HEREON IS BASED UPON THE AN - "BOUNDARY SURVEY FOR NVEYANCES BETWEEN HABITAT FOR O THE CITY OF PORTLAND, MAINE" ON D THE CITY OF PORTLAND, MAINE" ON D THE CITY OF PORTLAND, MAINE" ON D THE CITY OF PORTLAND, MAINE" ON IF 18" SEPARATION IS IF 18" SEPARATION IS IF 18" SEPARATION IS IF 18" SEPARATION IS D HE REQUIRED TO ADD BACK FLOW FOR FOOTING DRAIN. | AND SPACE REQUIREMENTS ARE AS OT SIZE - 6500 S.F. TREET FRONTAGE - 50 FEET OT WDTH - 75 FEET - 25' - 25' - 25' 14' (FOR 2 STORY DWELLING) NOR THON OF THE PLAN SHOWS THE FALL WITHIN THE PROPOSED FALL AND DRAINAGE RIGHT-OF-WAY. DWS THE CURRENT CONDITIONS OF THE BOVE GROUND PHYSICAL AND L FEATURES ARE BASED UPON AN Y PERFORMED IN MAY 2004. D FEATURES ARE BASED UPON TRUCTION DRAWINGS FOR FALL BROOK ROVEMENTS. LOCATION OF 0 UTILITIES SHOULD BE FIELD VERIFIED TRUCTION. D WAS SHOWN ON A PLAN TITLED "LOTS OAD", DATED DECEMBER, 1958 AND PLAN BOOK 51, PAGE 13. THE | NG FOR THIS SURVEY EVATION DATUM IS N FED IS IDENTIFIED ON SSORS MAP 171, BLO | LEGEND 3/4" IRON PIPE FOUND IRON ROD FOUND (HEXAGONAL TORSION BAF OWNERS TO REPLACE ORIGINAL IRON PIPES) 5/8" REBAR FOUND WITH ORANGE PLASTIC "GREENLAW PLS 2303 774-2855" 5/8" REBAR TO BE SET WITH ALUMINUM CA STAMPED "CITY OF PORTLAND SURVEY MARH SPIKE SET PROPOSED TREE TO BE SET PER CITY STAN SEWER AND DRAINAGE I PROPOSED TREE TO BE SET PER CITY STAN SEWER AND DRAINAGE I PROPERTY LINE BUILDING SETBACK LINE CONTOUR LINE SILT FENCE |
|--|--|--|--|
| CITY OF PORTLAND, MAINI IPUBLIC WORKS DEPARTMENT ENGINEERING SECTION Inizalogy Date APPROVED | SITE PLAN FOR PROPOSED HABITAT FOR HUMANITY DWELLING ON 55 MALILLY ROAD W. CLARK | AUTOCAD DRAWNG: FALL BROOK 2004 DATE: 10/27/04 SCALE: 1" = 20' | SET BY CAP STAMP P CAP STAMP R.O.W. LIMIT |

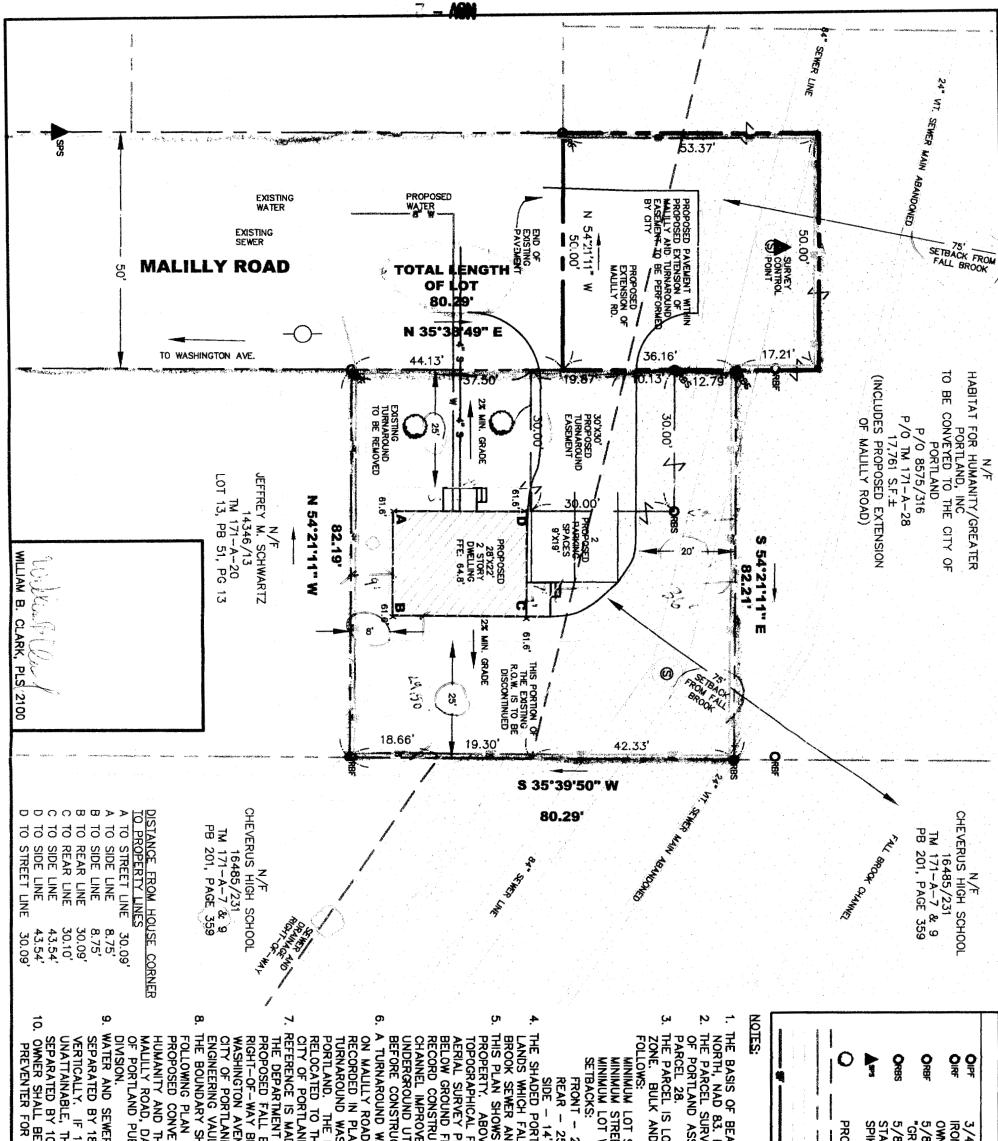
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| VENUE ID BE ON FILE AT THE CITY OF SUIC WORKS DEPARTMENT ENGINEERING LT. | LERK RECORDS. BRANCH COMBINED SEWER, ACCEPTED RECORDS. DRTION OF THE PLAN SHOWS THE PALL WITHIN THE PROPOSED SEWER AND IT-OF-WAY. GROUND FEATURES TOR FALL BROOK OVEMENTS. NAERIAL SURVEY PERFORMED IN MAY GROUND FEATURES ARE BASED UPON RUCTION DRAWINGS FOR FALL BROOK OVEMENTS. WAS SHOWN ON A PLAN TITLED "LOTS DAD", DATED DECEMBER, 1958 AND DAN", DATED DECEMBER, 1958 AND DAN BOOK 51, PAGE 13. THE VAS NOT ACCEPTED BY THE CITY OF THE PURPOSE OF THIS PLAN IS TO CEPTED TURNAROUND WHICH MEETS STANDARDS. MADE TO A PLAN BEING PREPARED BY NAT OF PUBLIC WORKS FOR THE L BROOK SEWER AND DRAINAGE A BETWEEN RAY STREET AND THE PURPOSE OF THE | THE DETAINS ARCEPTED ORIGINA THE DETAINS ARCCEPTED ORIGINAL ARCCEPTED ORIGINAL THE DETAINS ARCCEPTED ORIGINAL | ASSESSORS MAP 171, BLOCK A, VD 29. ARE LOCATED IN THE RESIDENTIAL 3 IND SPACE REQUIREMENTS ARE AS T SIZE - 6500 S.F. REET FRONTAGE - 50 FEET T WIDTH - 75 FFFT | IEARING FOR THIS SURVEY IS GRID 3. ELEVATION DATUM IS NGVD 1929. 1 BOOK REFERENCES ARE TO THE OUNTY REGISTRY OF DEEDS. URVEYED ARE IDENTIFIED ON THE CITY | LEGEND 3/4" IRON PIPE FOUND IRON ROD FOUND (HEXAGONAL TORSIO) OWNERS TO REPLACE ORIGINAL IRON P 5/8" REBAR FOUND WITH ORANGE PLA STAMPED "GREENLAW PLS 2303 774- OTHERWISE NOTED) 5/8" REBAR TO BE SET WITH ALUMINU STAMPED "CITY OF PORTLAND SURVEY #2100) SPIKE SET SURVEY CONTROL POINT SURVEY CONTROL POINT SEWER AND DRAINAGE R.O.W. LIMIT PROPERTY LINE RECORD PLAN DISTANCE |
|--|--|--|--|---|--|
| SHEET#1 OF 1 | CITY OF PORTLAND, MAINE PUBLIC WORKS DEPARTMENT ENGINEERING, SECTION | PROPOSED CONVEYANCES BETWEEN HABITAT FOR HUMANITY AND THE CITY OF PORTLAND, MAINE ON | FALL BROOK 2004 FANN BY: C. ALDEN | AUTOCAD DRAWING: TALL BROOK 2004 DATE: 10/26/04 SCALE: 1" = 30' | N BAR SET BY OIPES) -2855" (UNLESS -UM CAP UM CAP MARKER, PLS |

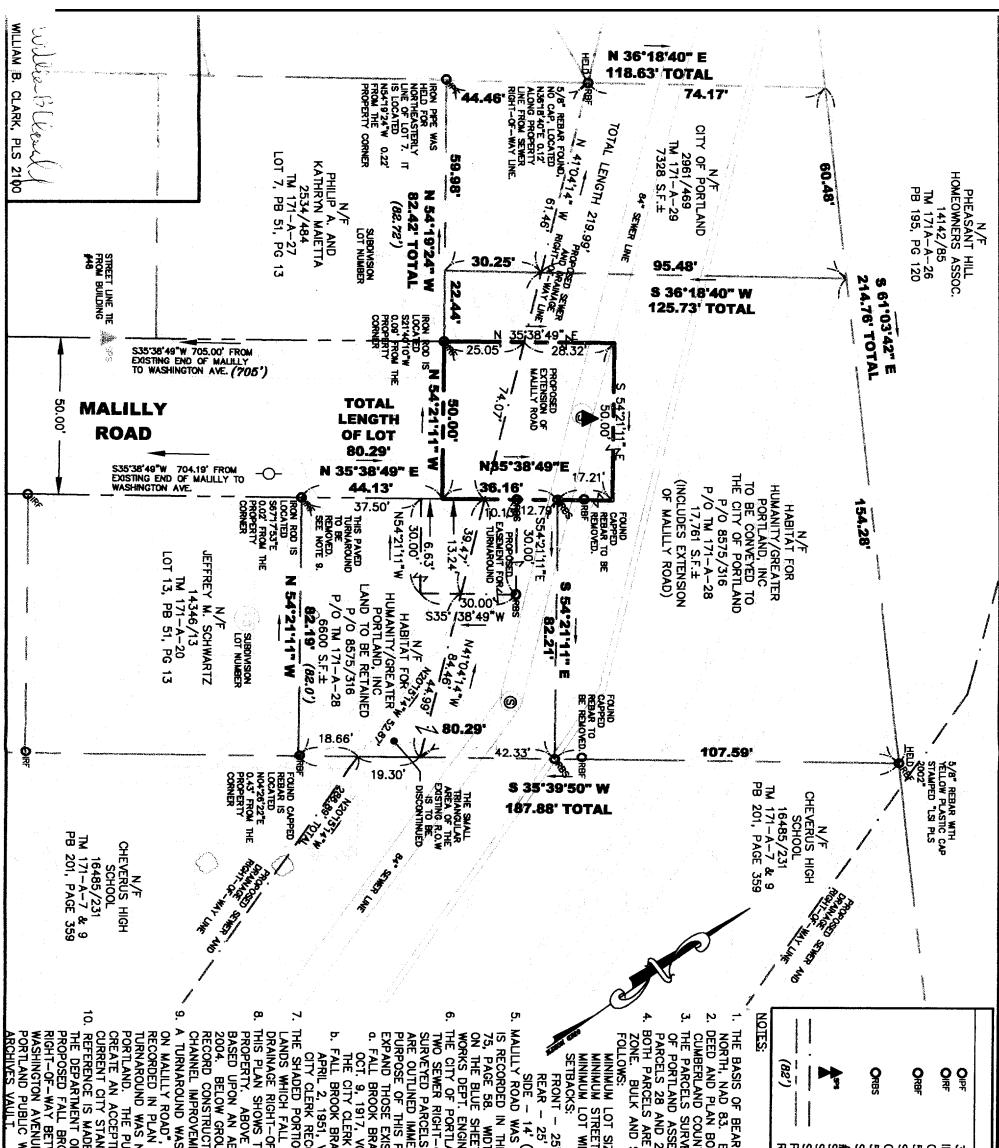
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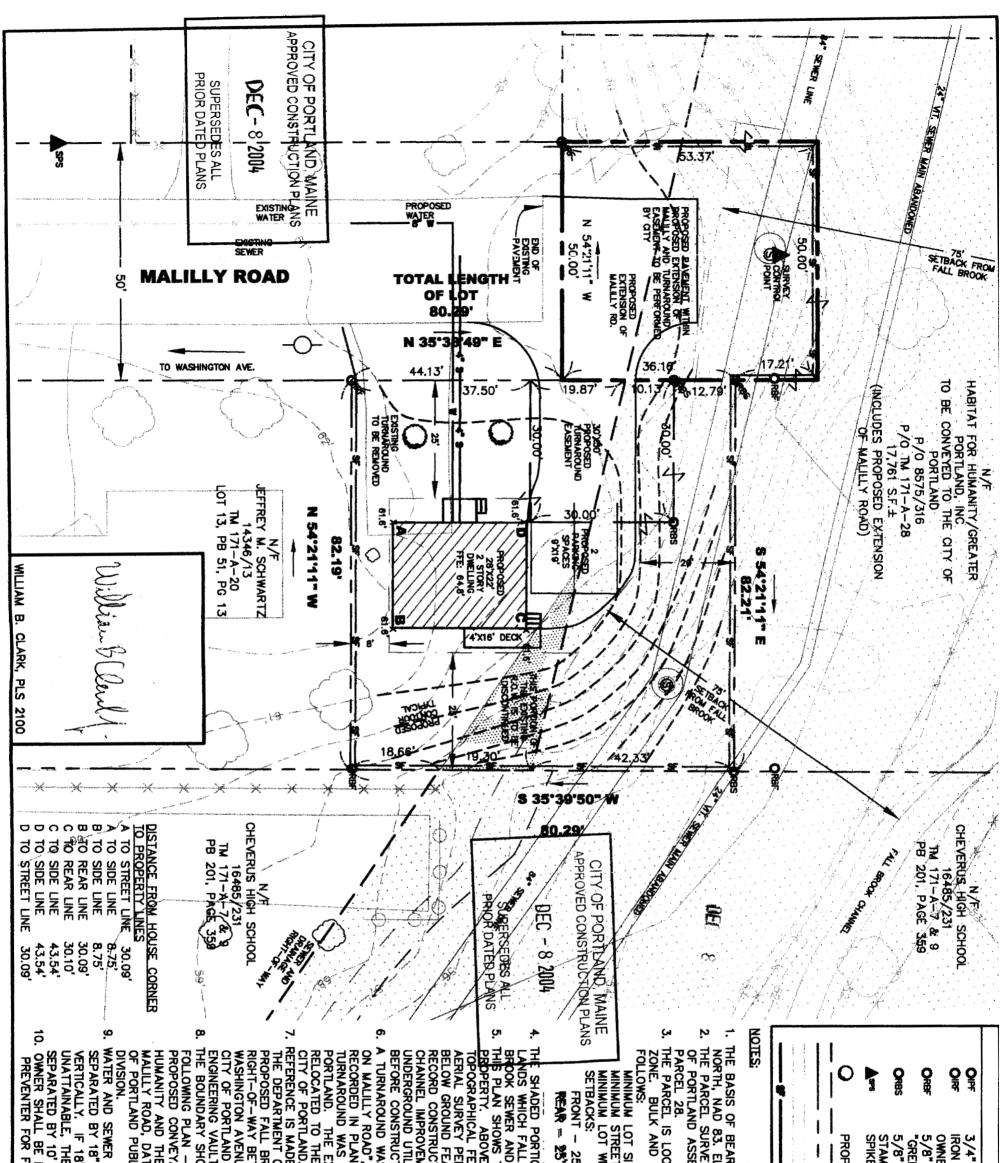


| | VAS NOT ACCEPTED BY THE CITY OF INE EXISTING TURNAROUND WILL BE THE PROPOSED TURNAROUND BY THE AND. ADE TO A PLAN BEING PREPARED BY ADE TO A PLAN BEING PREPARED BY NADE TO A PLAN BEING PREPARED BY NADE TO BE ON FILE AT THE BROOK SEWER AND DRAINAGE BETWEEN RAY STREET AND VENUE TO BE ON FILE AT THE AND PUBLIC WORKS DEPARTMENT AULT. SHOWN HEREON IS BASED UPON THE SHOWN HEREON IS BASED UPON THE VEYANCES BETWEEN HABITAT FOR THE CITY OF PORTLAND, MAINE" ON DATED OCT. 26, 2004 BY THE CITY PUBLIC WORKS DEPT. ENGINEERING WER HOUSE SERVICE MUST BE 18" BOTH HORIZONTALLY AND THEN, THE LINES MUST BE 10' HORIZONTALLY. | - 25' 25' 25' 25' 25' 25' 25' 25' 25' 25' | LOCATED IN THE RESIDENTIAL 3 ND SPACE REQUIREMENTS ARE AS T SIZE 6500 S.F. REET FRONTAGE 50 FEET T MDTH 75 FEET | BEARING FOR THIS SURVEY IS GRID 3. ELEVATION DATUM IS NGVD 1929. RVEYED IS IDENTIFIED ON THE CITY ASSESSORS MAP 171, BLOCK A, | PROPOSED TREE TO BE SET PER CITY ST SEWER AND DRAINAG PROPERTY LINE BUILDING SETBACK LI CONTOUR LINE SILT FENCE | 5/4" IRON PIPE FOUND RON ROD FOUND (HEXAGONAL TORSION E OWNERS TO REPLACE ORIGINAL IRON PIPE 5/8" REBAR FOUND WITH ORANGE PLAST GREENLAW PLS 2303 774-2855" GREENLAW PLS 2303 774-2855" 5/8" REBAR TO BE SET WITH ALUMINUM 57AMPED "CITY OF PORTLAND SURVEY M/ | TRCRND |
|----------|---|--|---|--|--|---|--------|
| SHEET#1 | CITY OF PORTLAND, MAINE PUBLIC WORKS DEPARTMENT ENGINEERING SECTION | SITE PLAN FOR PROP(ED HABITAT FOR HUMAINITY DWELLING ON | | AUTOCAD DRAWING: FALL BROOK 2004 DATE: 10/27/04 | STANDARDS AGE R.O.W. LIMI LINE | BAR SET BY ES) TIC CAP STAMPED CAP (ARKER, PLS 2100 | |
| 야 - 1 | DATE APPROVED CITY_ENGINEER | 55 MALILLY ROAD | CHECKED BY: W. CLARK | SCALE: 1" = 20' | ITS | 4PED 2100" | |

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| | BE REQUIRED TO ADD BACK FLOW | LAN BOOK 51, PAGE 13. THE AS NOT ACCEPTED BY THE CITY OF E EXISTING TURNAROUND WIL BE THE PROPOSED TURNAROUND BY THE ND. ADE TO A PLAN BEING PREPARED BY ADE TO A PLAN BEING PREPARED BY THE TO F PUBLIC WORKS FOR THE BROOK SEWER AND DRAINAGE BETWEEN RAY STREET AND ENUE TO BE ON FILE AT THE ND PUBLIC WORKS DEPARTMENT ULT. SHOWN HEREON IS BASED UPON THE SHOWN HEREON IS BASED UPON THE SHOWN HEREON IS BASED UPON THE VIT OF PORTLAND, MAINE" ON DATED OCT. 26, 2004 BY THE CITY UBLIC WORKS DEPT. ENGINEERING ER HOUSE SERVICE MUST BE THE NOTH HORIZONTALLY AND 18" SEPARATION IS THEN, THE UNES MUST BE THEN, THE UNES MUST BE | 25' 25' 25' 25' 25' 25' 25' 25' 25' 25' | Located in the residential 3 ND Space requirements are as I Size - 6500 S.F. REET FRONTAGE - 50 FEET I MIDTH - 75 FEET | EARING FOR THIS SURVEY IS GRID . ELEVATION DATUM IS NGVD 1929. RVEYED IS IDENTIFIED ON THE CITY ISSESSORS MAP 171, BLOCK A, | ROPOSED TREE TO BE SET PER CITY ST SEWER AND DRAINAG PROPERTY LINE BUILDING SETBACK L CONTOUR LINE SILT FENCE | /4" IRON PIPE FOUND ON ROD FOUND (HEXAGONAL TORSION WNERS TO REPLACE ORIGINAL IRON PIPI /8" REBAR FOUND WITH ORANGE PLAST 3REENLAW PLS 2303 774-2855" 3REENLAW PLS 2303 774-2855" | LECEND |
|---|------------------------------|--|--|--|--|--|--|--------|
| | SHEET#1 (| CITY OF PORTLAND, MAINE PUBLIC WORKS DEPARTMENT ENGINEERING SECTION | SITE PLAN FOR PROPOSED HABITAT FOR HUMANITY DWELLING ON | DRAWN BY: | AUTOCAD DRAWING: FALL BROOK 2004 DATE: 11/4/04 REVISED: 12/3/04 | itandards Ge R.O.W. Limi Line | BAR SET BY ES) TIC CAP STAM CAP ARKER, PLS 2 | |
| L | ନ୍ 1 | 12 6 104 DATE APPROVED CITY ENGINEER | MALILLY ROAD | CHECKED BY: W. CLARK | SCALE: 1" = 20' | 75 | 4PED | |

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