

GENERAL CONTRACTOR

STRUCTURAL ENGINEER


MEP ENGINEER

CLIENT

Spurwink Services
 899 Riverside Street
 Portland, ME 04103

PROJECT
Spurwink Services

901 Washington Ave.
 Portland, ME 04101

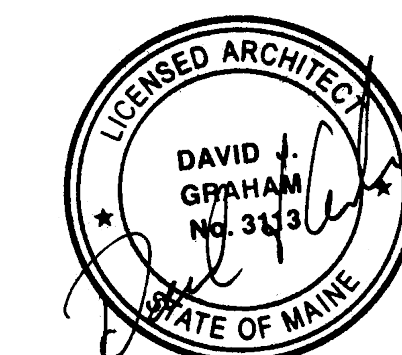

ISSUED FOR PERMIT

INFORMATION

Path: M:/boulos/spurwink

Issue Date: 07.24.14

Drawn By: dijg

Checked By: dijg

Revision:

- 1.
- 2.
- 3.
- 4.

TITLE


REFLECTED CEILING PLAN

SCALE

1/8"=1'-0"

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NOTE:
 ALL LIGHTING FIXTURES LOCATIONS ARE APPROXIMATE.
 G.C. TO DETERMINE EXISTING FIXTURES COUNT TO DETERMINE
 IF ADDITIONAL FIXTURES ARE REQUIRED. COORDINATE THE
 REUSE OF ALL EXISTING FIXTURES WITH PROPOSED PLAN

GENERAL REFLECTED CEILING NOTES

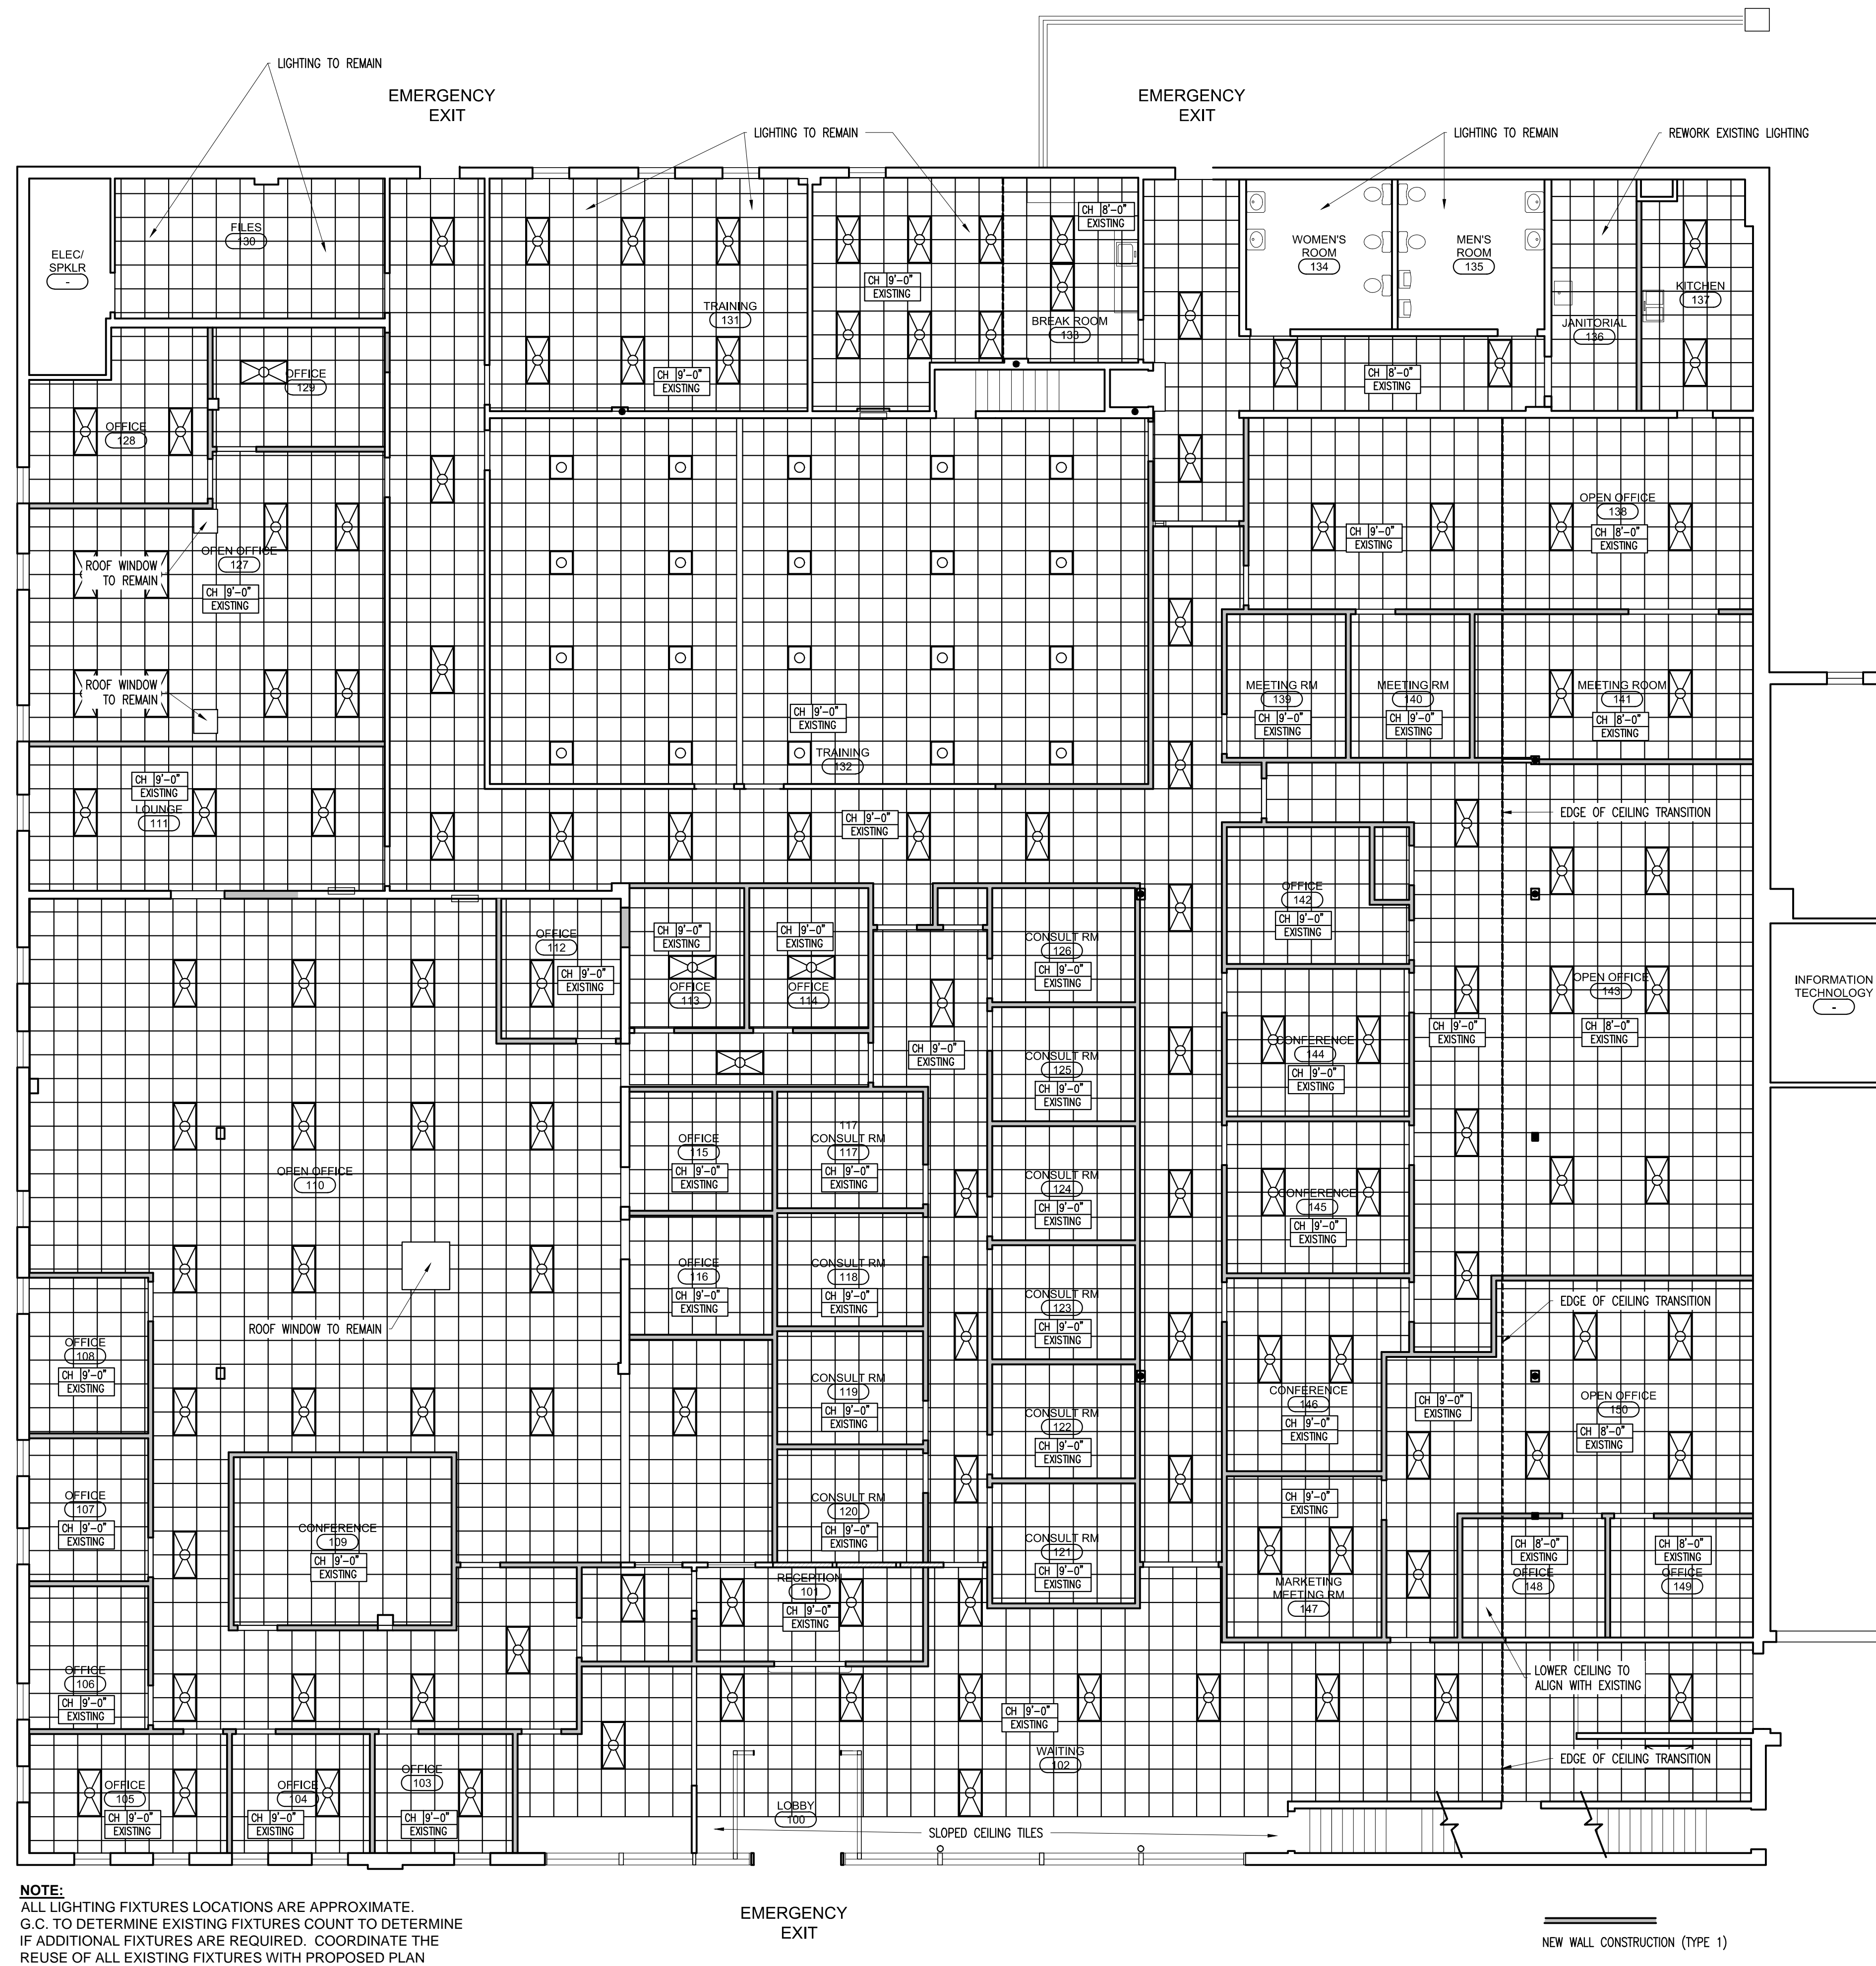1. EXISTING CEILING GRID AND TILES ARE TO BE REUSED. G.C. TO REMOVE AND PROTECT ALL CEILING FINISHES AND GRID DURING CONSTRUCTION AS REQUIRED TO COMPLETE THE ENTIRE SCOPE OF WORK.
2. COORDINATE THE WORK OF ALL TRADES INVOLVED IN THE CEILING WORK TO INSURE CLEARANCES FOR FIXTURES, DUCTS, PIPING, CEILING SUSPENSION SYSTEM, ETC. NECESSARY TO MAINTAIN THE FINISHED EXISTING CEILING HEIGHTS.
3. SUPPLY AND INSTALL ADDITIONAL SUSPENDED TRACK AND MATERIAL REQUIRED TO COMPLETE THE WORK AS INDICATED ON THE DRAWINGS. PROVIDE ALL TIES FOR LIGHT FIXTURES, EXIT SIGNS, SPRINKLERS HEADS AND OTHER CEILING/ SOFFIT ELEMENTS FOR SECURE ATTACHMENT OF GENERAL CONSTRUCTION.
4. LIGHTING TO BE LOCATED AS BEST AS POSSIBLE WITH PROPOSED LAYOUT.
5. CEILING TILES TO MATCH EXISTING.

GENERAL SPRINKLER NOTES

1. G.C. TO COORDINATE THE RELOCATION OF ALL SPRINKLER HEADS TO FIT THE PROPOSED PLAN.
2. SPRINKLER DESIGN TO MEET ALL STATE AND LOCAL LAWS.
3. G.C. TO PROVIDE ALL PERMITS REQUIRED FOR MODIFYING THE EXISTING SPRINKLER SYSTEMS.