


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Unit 1

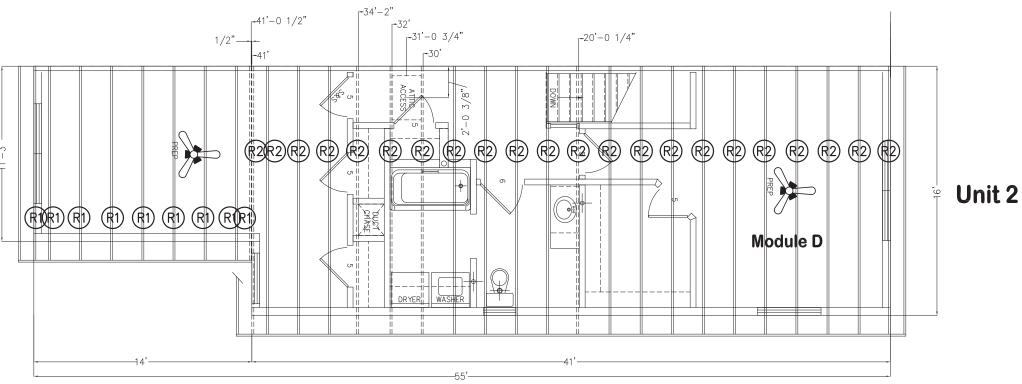


 $(R1) = 18 \sim 11'-3'$ FLAT TRUSSES $(R2) = 44 \sim 16'$ FLAT TRUSSES

CAPS ON SITE FASTENED TO EACH MEMBER BELOW AS PER "STANDARD PIGGY BACK

Serial #: 128	27A	Second Floor Ceiling Centers for 32' x 55'
Reference #:	???	Sheet #
Drawn By:	R.KING	0404
	1441 00 /0047	

SITE CONNECTION DETAIL

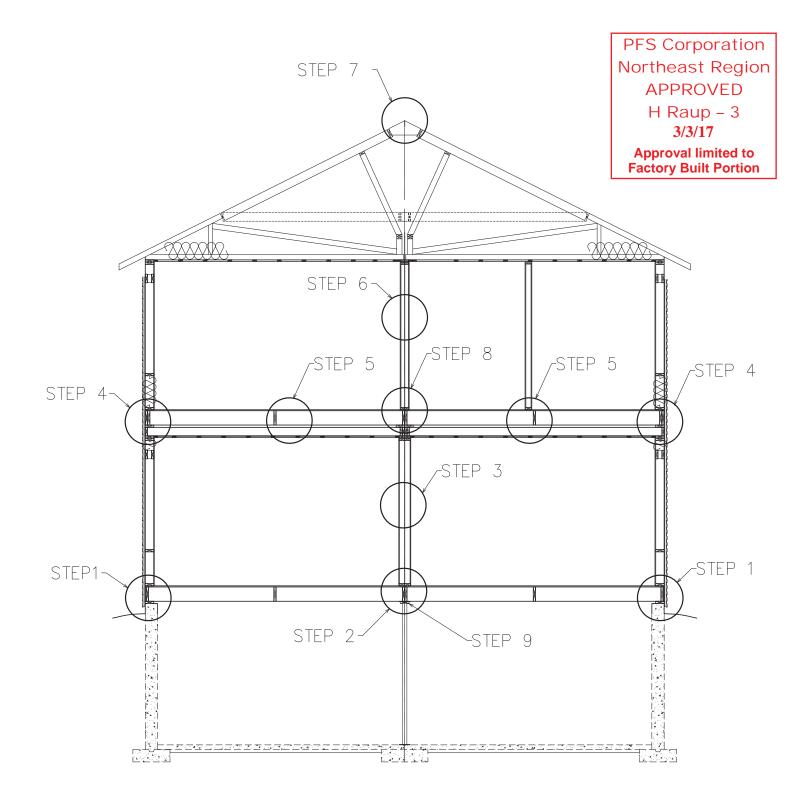

STEP 1: HOME MUST BE TIED TO FOUNDATION WITH STRAP ANCHORS EMBEDDED IN CONCRETE @ 8'-0" C/C (EMBEDDED BY FOUNDATION CONTRACTOR & NAILED TO RIM BY SITE FINISH CREW), OR HAVE STEEL STRAPPING FASTENED @ 32" C/C INTO SILL PLATE & RIM JOIST WITH MIN. 3-1/4" NAILS, 3 PER END (BY SITE FINISH CREW) OR TOENAILED WITH MIN. 3-1/4" NAILS @ 16" C/C FROM RIM JOIST INTO SILL PLATE (BY SITE FINISH CREW)

STEP 2: CENTER BEAM IS MADE UP OF 1-PLY 9-1/4" LVL EACH MODULE AND THROUGH BOLTED AT 4'-0" O/C WITH 5/8" THREADED RODS.

STEP 3: EVERY MATEWALL OPENING MUST BE CLAMPED AND FASTENED WITH 3 PCS OF STEEL STRAPPING WITH MINIMUM OF TWO 2" NAILS PER END (TOP, CENTER, BOTTOM OF WALL)

STEP 4: STEEL STRAPPING MUST SPAN BETWEEN FLOOR FRAMING AND 2X6 SILL AT 32" O/C MINIMUM WITH MINIMUM 3-1/4" NAILS. ONE AT EACH END OF STRAP, OR 3-1/4" NAIL TOE NAILED FROM RIM JOIST TO 2X6 PLATE AT 16" O/C. A MORE SECURE METHOD MAY BE REQUIRED IN HIGH WIND AREAS. ALL AREAS WHERE STRAPS ARE TO BE LOCATED THE 1" CODE BOARD MUST BE CUT OUT AND REINSTALLED UPON INSTALLATION OF THE STEEL STRAPPING. WATER RESISTIVE BARRIER TO COVER THERE AFTER.

STEP 5: INSTALL STEEL STRAPPING WITH 24" OF MARRIAGE WALL AND THREE MORE STRAPS EQUALLY SPACED ON THE EXTERIOR SIDE OF THE GABLE END OF EACH MODULE. THESE WILL BE FASTENED WITH MINIMUM 3-1/4" NAILS PER END OR 3-1/4" NAILS TOE NAILED FROM RIM JOIST TO 2X6 PLATE.

STEP 6: EVERY MATEWALL OPENING MUST BE CLAMPED AND FASTENED WITH 3 PCS OF STEEL STRAPPING WITH MINIMUM OF TWO 2" NAILS PER END. (TOP, CENTER, BOTTOM OF WALL)

STEP 7: HOME MUST BE TIED TOGETHER AT THE PEAK WITH STEEL STRAPPING (MIN. 3-1/4" NAILS PER END) EVERY OTHER TRUSS, MATERIAL SUPPLIED BY PRESTIGE HOMES AND INSTALLED BY SITE COMPLETION TEAM. ASPHALT RIDGE CAP SUPPLIED BY PRESTIGE HOMES AND INSTALLED BY SITE COMPLETION TEAM.

STEP 8: ALL FLOOR SHEATHING AT MATEWALL OPENINGS ARE STEPPED BACK AND A CONTINUOUS PIECE OF FLOOR SHEATHING INSTALLED ON SITE.


STEP 9: BY BUILDER AFTER HOME IS SET TOGETHER. INSTALL 2X6 PLATE(SUPPLIED BY BUILDER) ON BOTTOM OF CENTER BEAM RUNNING FULL LENGTH OF HOME. THIS IS A FIRE STOP.

SITE INSTALLED TRUSSES

ALL SITE INSTALLED TRUSSES AND/OR TRUSS CAPS INSTALLED AS PER STANDARD PIGGYBACK TRUSS CONNECTION DETAIL SUPPLIED IN THIS DRAWING PACKAGE.

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	Original Date	Aug 15/16
	Scale	1/4"=1'-0"

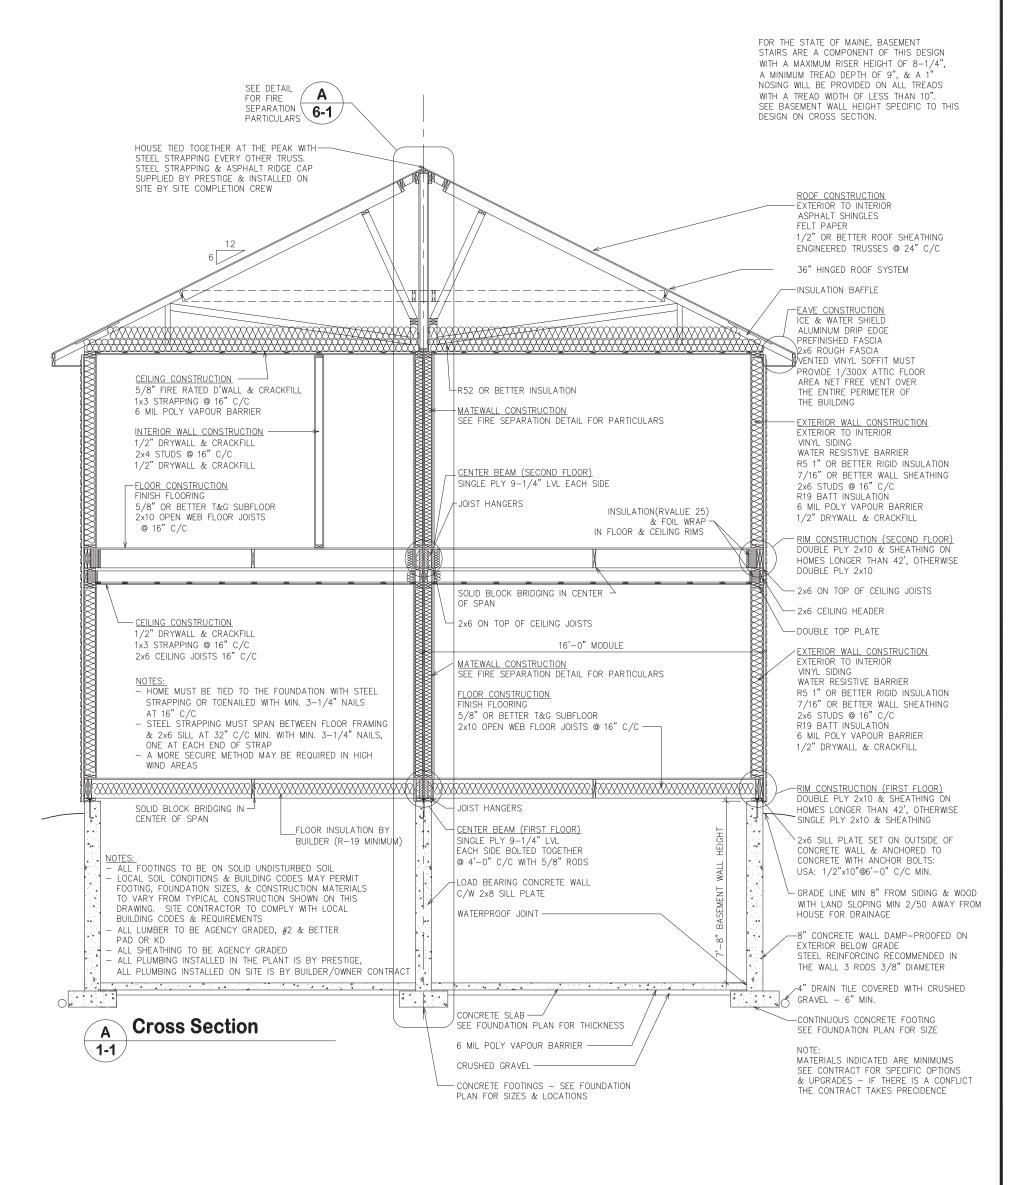

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Cross Section


12827A R12859A-1-1D

Revision Date Feb. 27/17 Revised by

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FOR THE STATE OF MAINE, BASEMENT STAIRS ARE A COMPONENT OF THIS DESIGN WITH A MAXIMUM RISER HEIGHT OF 8-1/4", A MINIMUM TREAD DEPTH OF 9", & A 1" NOSING WILL BE PROVIDED ON ALL TREADS WITH A TREAD WIDTH OF LESS THAN 10". SEE BASEMENT WALL HEIGHT SPECIFIC TO THIS DESIGN ON CROSS SECTION.



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Scale 1/4"=1'-0"

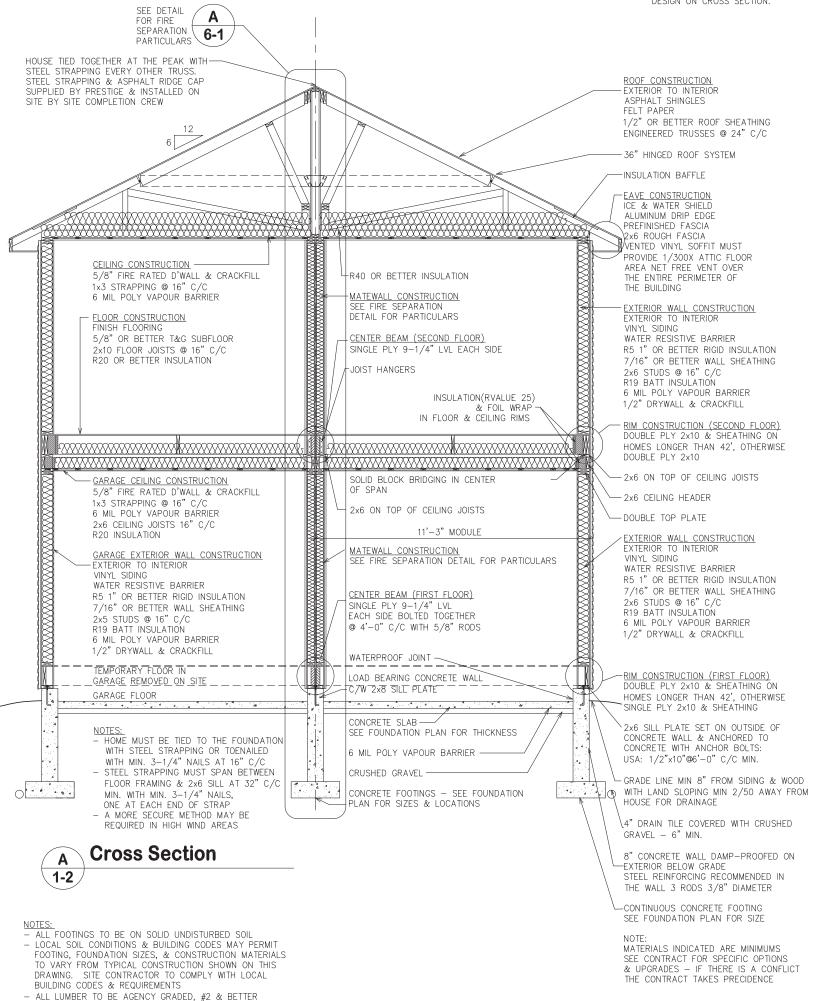Sheet No.

- ALL SHEATHING TO BE AGENCY GRADED

ALL PLUMBING INSTALLED IN THE PLANT IS BY PRESTIGE,


ALL PLUMBING INSTALLED ON SITE IS BY BUILDER/OWNER CONTRACT

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Drawn By AG

Original Date Aug 15/16

Scale 1/2"=1'-0"


PFS Corporation Northeast Region APPROVED H Raup - 3 3/3/17

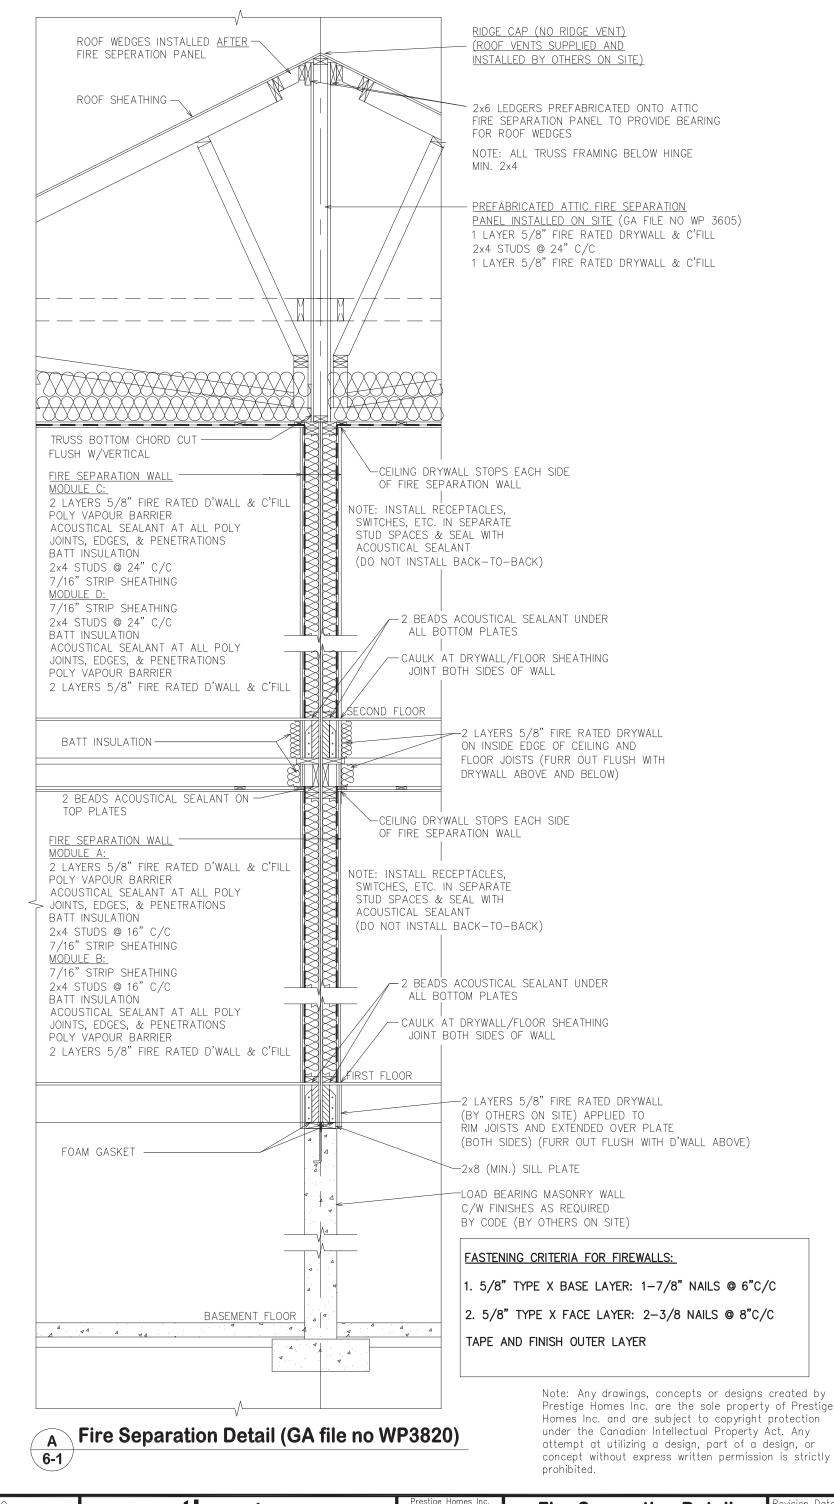
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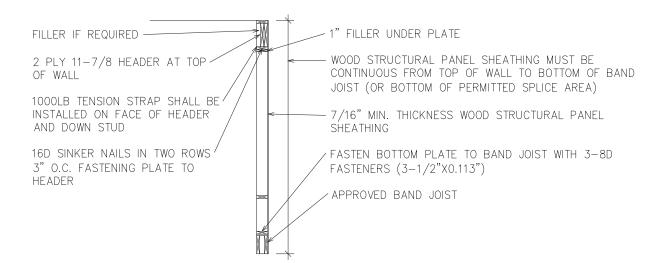
Fire Separation Detail
12827A R12859A-6-1B

Revision Date Feb. 28/17 Revised by



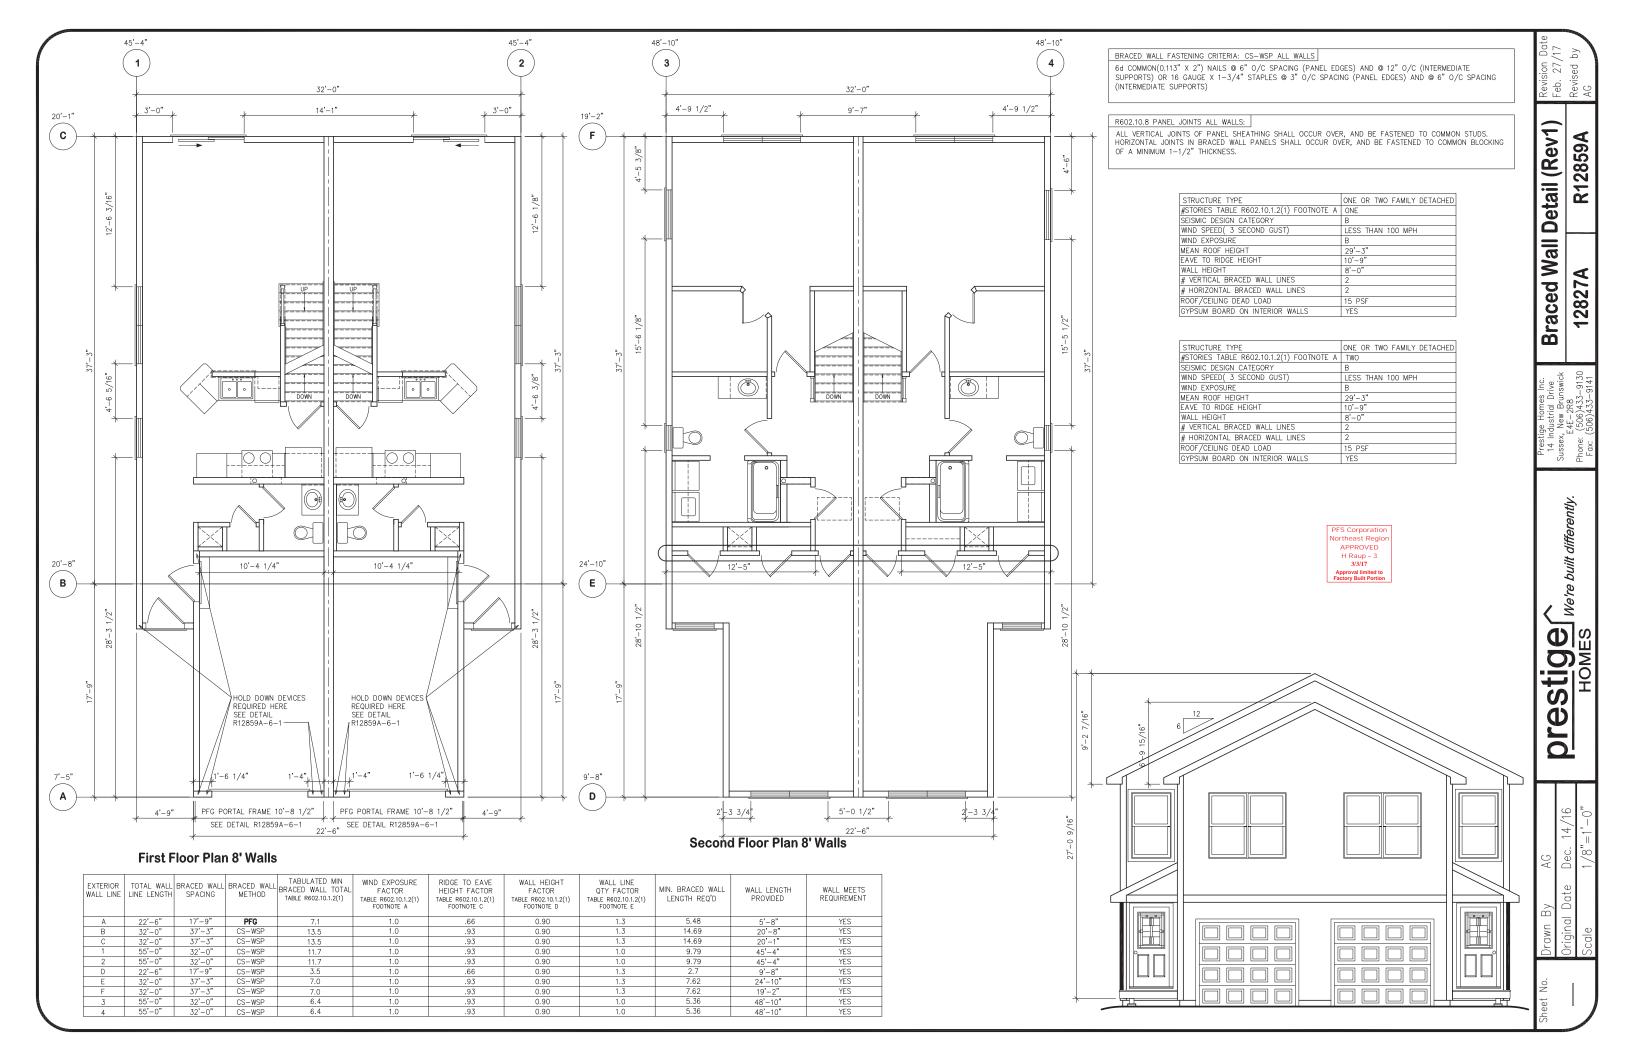

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Section - PFG Portal Frame at Garage Door Openings 6-2 BRACED WALL SECTION AS PER 2009 IRC R602.10.34
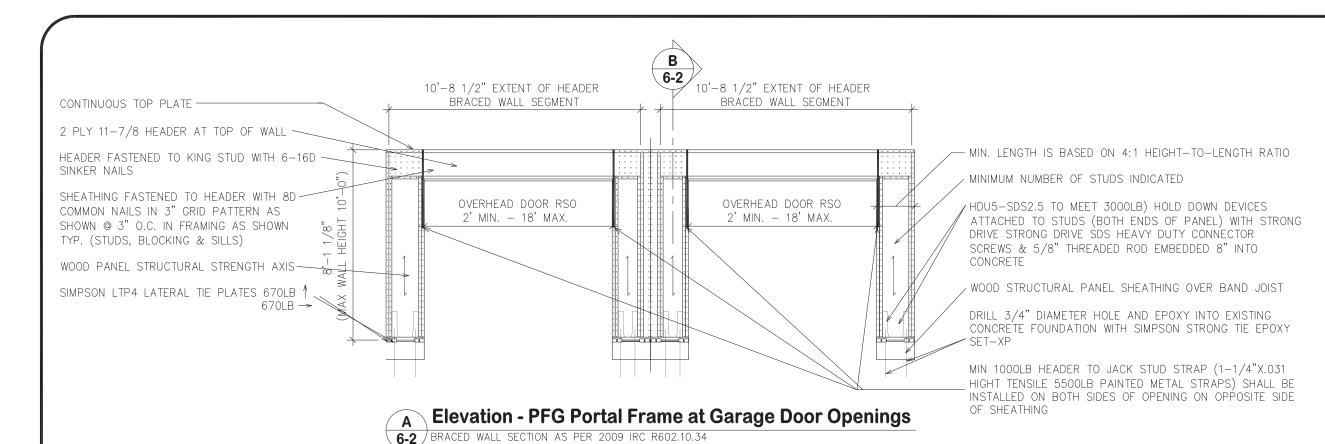
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10n 02

Braced Wall Fastening Detail R12859A-6-2B

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