

DISPLAY THIS CARD ON PRINCIPAL FRONTAGE OF WORK CITY OF PORTLAND

Please Read Application And Notes, If Any, Attached

BUILDING DEPARTMENT PERMIT

Permit Number: 020816

This is to certify that Wright-ryan Real Estate Llc/V RIGHT R STRUCTURE
has permission to Erect a Temporary 40' x 60' Storage Building w/PV Skin
AT 276 Canco Rd 154 B047001

provided that the person or persons, firm or corporation accepting this permit shall comply with all of the provisions of the Statutes of Maine and of the ordinances of the City of Portland regulating the construction, maintenance and use of buildings and structures, and of the application on file in this department.

Apply to Public Works for street line and grade if nature of work requires such information.

Notification of inspection must be given and written permission procured before this building or part thereof is loaded or closed-in. **HEAR NOTICE IS REQUIRED.**

A certificate of occupancy must be procured by owner before this building or part thereof is occupied.

OTHER REQUIRED APPROVALS

Fire Dept. *[Signature]*
Health Dept. _____
Appeal Board _____
Other _____
Department Name

[Signature] 11/25/02
Director - Building & Inspection Services

PENALTY FOR REMOVING THIS CARD

City of Portland, Maine - Building or Use Permit Application

389 Congress Street, 04101 Tel: (207) 874-8703, Fax: (207) 874-8716

Permit No: 02-0816	Issue Date:	CBL: 154 B047001
-----------------------	-------------	---------------------

Location of Construction: 276 Canco Rd	Owner Name: Wright-ryan Real Estate Llc	Owner Address: 10 Danforth St	Phone: 773-3625
Business Name:	Contractor Name: WRIGHT RYAN CONSTRUCTIO	Contractor Address: 10 DANFORTH STREET Portland	Phone: 2077733625
Lessee/Buyer's Name	Phone:	Permit Type: Additions - Commercial	Zone: I-M
Past Use: Storage Facility/Parking	Proposed Use: Storage Facility/Parking	Permit Fee: \$156.00	Cost of Work: \$19,000.00
		CEO District: 2	
Proposed Project Description: Erect a <u>Temporary</u> 40' x 60' Storage Building w/PVC Skin <i>for 1 yr from date of Bldg permit</i>		FIRE DEPT: <input checked="" type="checkbox"/> Approved <input type="checkbox"/> Denied	INSPECTION: Use Group: 52 Type: 2C <i>11/25/02</i>
		Signature: <i>[Signature]</i>	Signature: <i>[Signature]</i>
PEDESTRIAN ACTIVITIES DISTRICT (P.A.D.)			
Action: <input type="checkbox"/> Approved <input type="checkbox"/> Approved w/Conditions <input type="checkbox"/> Denied			
		Signature:	Date:

Permit Taken By: gad	Date Applied For: 07/23/2002	Zoning Approval	
-------------------------	---------------------------------	------------------------	--

<p>1. This permit application does not preclude the Applicant(s) from meeting applicable State and Federal Rules.</p> <p>2. Building permits do not include plumbing, septic or electrical work.</p> <p>3. Building permits are void if work is not started within six (6) months of the date of issuance. False information may invalidate a building permit and stop all work..</p>	<p>Special Zone or Reviews</p> <p><input checked="" type="checkbox"/> Shoreland</p> <p><input type="checkbox"/> Wetland</p> <p><input type="checkbox"/> Flood Zone</p> <p><input type="checkbox"/> Subdivision</p> <p><input checked="" type="checkbox"/> Site Plan <i># 2002-0015</i></p> <p>Maj <input type="checkbox"/> Minor <input checked="" type="checkbox"/> MM <input type="checkbox"/></p> <p>Date:</p>	<p>Zoning Appeal</p> <p><input type="checkbox"/> Variance</p> <p><input type="checkbox"/> Miscellaneous</p> <p><input type="checkbox"/> Conditional Use</p> <p><input type="checkbox"/> Interpretation</p> <p><input type="checkbox"/> Approved</p> <p><input type="checkbox"/> Denied</p> <p>Date:</p>	<p>Historic Preservation</p> <p><input checked="" type="checkbox"/> Not in District or Landma</p> <p><input type="checkbox"/> Does Not Require Review</p> <p><input type="checkbox"/> Requires Review</p> <p><input type="checkbox"/> Approved</p> <p><input type="checkbox"/> Approved w/Conditions</p> <p><input type="checkbox"/> Denied</p> <p>Date: <i>[Signature]</i></p>
---	--	--	--

CERTIFICATION

I hereby certify that I am the owner of record of the named property, or that the proposed work is authorized by the owner of record and that I have been authorized by the owner to make this application as his authorized agent and I agree to conform to all applicable laws of this jurisdiction. In addition, if a permit for work described in the application is issued, I certify that the code official's authorized representative shall have the authority to enter all areas covered by such permit at any reasonable hour to enforce the provision of the code(s) applicable to such permit.

SIGNATURE OF APPLICANT _____ ADDRESS _____ DATE _____ PHONE _____

RESPONSIBLE PERSON IN CHARGE OF WORK, TITLE _____ DATE _____ PHONE _____

WRIGHT-RYAN - CANCO Rd.

We Cover The World.®



ESTIMATED FOUNDATION FORCES

11/13/02

40' BVR/12' Leg

The following estimated foundation forces are the maximum values of all applicable load case combinations and are based upon the following assumptions:

- Span: 40 ft
- Bay Spacing: 15 ft
- Live Load: 30 psf
- Ground Snow Load: 50 psf
- Basic Wind Speed: 90 mph ASCE 7 - 93
- Leg Height: 12 ft
- Peak Height: 15.5 ft
- Gable Column Spacing: 10 ft
- Dead Load: 4 psf

I) Sides:

	A. D + Live/Snow:	Fx = 2.0k	Lateral
		Fy = 12.0k	Downward
And			
	B. D + Wind:	Fx = 4.0k	Lateral
		Fy = 4.0k	Net Uplift

II) Corners & 2nd Spans: (Gable Wind Cases)

	A. D + Gable Wind:	Fx = 1.0k	Lateral
		Fy = 5.0k	Uplift
		Fz = 4.0k	Lateral
or			
		Fx = 1.0k	Lateral
		Fy = 3.0k	Downward
		Fz = 0	Lateral

III) Gable Columns:

(Assuming 3 columns per endwall)

	A. Gable Wind:	Fz = 1.4k	Lateral
--	----------------	-----------	---------


Notes:

- 1) The forces in I are for one 15' - 0" bay length. The lateral load and downward load is a point load at each column. The uplift is a distributed load along the bay length.
- 2) Forces in II and III are all point loads at span or column locations.

WRIGHT RYAN


ESTIMATED FOUNDATION SIZING

4-#5 BARS CONTINUOUS

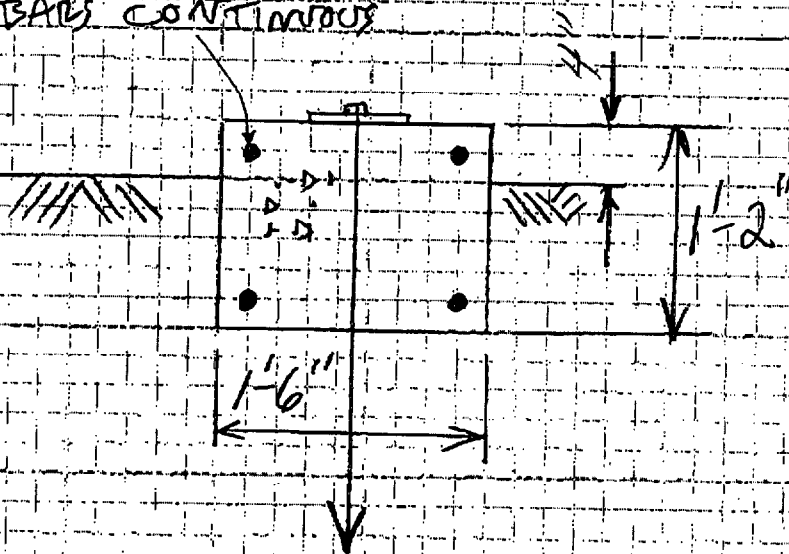

MIN-3 GROUND ANCHOR
 (1 ROD/D NEAR EACH LEG COLUMN)
 (10 ROD/D TOTAL)

TYP. SIDE WALL CONTINUOUS
 CONC. GRADE BEAM

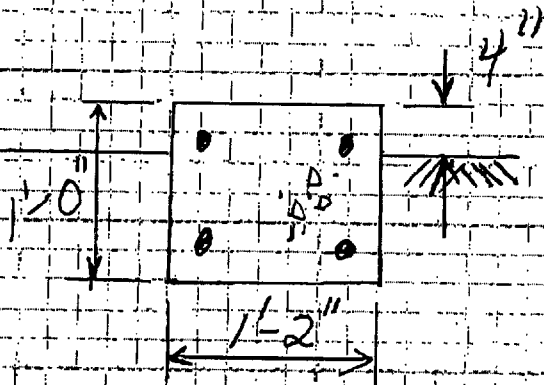


TYP. GABLE WALL CONTINUOUS CONC.
 GRADE BEAM.

We Cover The World®



BUILDING SYSTEMS

TELEFAX

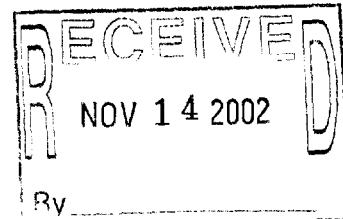

COMPANY:

ATTN: KEVIN GRIFFETH-415-406

FROM: GARY SUTRYN

FAX NO: 773-5173

NO. SHEETS: 3

REF:

DATE: 11/13/02

RUBB INC.,
Sanford Airport
P.O. Box 711
Sanford, Maine 04073
Tel: (207) 324-2877
Fax: (207) 324-2347
E-mail: info@rubbusa.com

Sent []

FOUNDATION INFO.



AN INTERNATIONAL COMPANY



2002-0015

Application ID Number:	2-0816						
Department:	Zoning	Status:	Approved with Conditions	Applicant:	Marge Schmuckal		
Address:	276 Canco Rd.			Approval Date:	07/29/2002		
				Issue Date:	07/25/2002		
<input checked="" type="checkbox"/> OK to Issue Permit	Name:	Marge Schmuckal	Date:	07/29/2002	Time:		
Conditions Section:							
This permit is being approved on the basis of plans submitted. Any deviations shall require a separate approval before starting that work.							
This is a TEMPORARY PERMIT and is valid only for one (1) year from the date of building permit issuance. If this building is to remain longer, it will be necessary to ask for an extension in writing PRIOR to when this permit approval lapses.							
Expiry Date:	07/24/2002	By:	gad	Issue Date:	07/29/2002	By:	mes

Permit Nbr
 Location of Construction
 Canco Rd
 Appl. Date

Status
 Permit Type
 Estimated Cost
 Issue Date

CBL
 Terriory Nbr
 Date Closed

Prmt
 Text93
 Const Type
 Num1

07/31/2002 hold until Planning approval

10/10/2002 PLANNING APPROVAL BROUGHT DOWN BY KANDI ON 10/10/02

Name
 Follow Up Date
 Completed

10/15/2002 Advised contractor of the need for loading and uplift information, the building will be there in 180 days, thus a permanent structure for Building Code purposes.

Name
 Follow Up Date
 Completed

CreatedBy
 CreateDate
 ModBy
 ModDate

Department of Planning & Development
Lee D. Urban, Director



CITY OF PORTLAND

Division Directors
Mark B. Adelson
Housing & Neighborhood Services

Alexander Q. Jaegerman, AICP
Planning

John N. Lufkin
Economic Development

October 22, 2002

Tom Wright
Wright-Ryan Real Estate LLC
10 Danforth Street
Portland, ME 04101

RE: Temporary RUBB Building, 276 Canco Road
ID #2002-0015, CBL #154-B-47

Dear Mr. Wright:

On October 8, 2002, the Portland Planning Authority granted minor site plan approval for a 2,400 sq. ft. temporary RUBB building located at 276 Canco Road.

The approval is based on the submitted site plan. If you need to make any modifications to the approved site plan, you must submit a revised site plan for staff review and approval.

Please note the following provisions and requirements for all site plan approvals:

1. The site plan approval will be deemed to have expired unless work in the development has commenced within one (1) year of the approval or within a time period agreed upon in writing by the City and the applicant. A one year extension may be granted by this department if requested by the applicant in writing prior to the expiration date of the site plan.
2. Prior to construction, a pre-construction meeting shall be held at the project site with the contractor, development review coordinator, Public Work's representative and owner to review the construction schedule and critical aspects of the site work. At that time, the site/building contractor shall provide three (3) copies of a detailed construction schedule to the attending City representatives. It shall be the contractor's responsibility to arrange a mutually agreeable time for the pre-construction meeting.
3. The Development Review Coordinator must be notified five (5) working days prior to date required for final site inspection. The Development Review Coordinator can be reached at the Planning Division at 874-8632. Please make allowances for completion of site plan requirements determined to be incomplete or defective during the inspection. This essential as all site plan requirements must be completed and approved by the Development Review Coordinator prior to issuance of a Certificate of Occupancy. Please schedule any property closing with these requirements in mind.

02-0816

All Purpose Building Permit Application

If you or the property owner owes real estate or personal property taxes or user charges on any property within the City, payment arrangements must be made before permits of any kind are accepted.

Location/Address of Construction: <u>276 REAR CANCO ROAD</u>		
Total Square Footage of Proposed Structure <u>2400 SQUARE FEET</u>	Square Footage of Lot <u>2 ACRES</u>	
Tax Assessor's Chart, Block & Lot Chart# <u>154</u> Block# <u>B</u> Lot# <u>47</u>	Owner: <u>WRIGHT-RYAN REAL ESTATE LLC.</u>	Telephone: <u>773-3625</u>
Lessee/Buyer's Name (If Applicable)	Applicant name, address & telephone: <u>TOM WRIGHT 10 DANFORTH STREET PORTLAND 04101 773-3625</u>	Cost Of Work: <u>\$19,000</u> Fee: \$ <u>156.00</u>
Current use: <u>CONTRACTOR STORAGE, PARKING</u>		
If the location is currently vacant, what was prior use: _____		<u>Site Review</u> <u># 2002 0015</u>
Approximately how long has it been vacant: _____		
Proposed use: <u>TEMPORARY STORAGE of FORMS & SUPPLIES</u>		
Project description: <u>40' x 60' TEMP STORAGE Building WITH P.V.C. SKIN NO FOUNDATION, NO WATER, NO SEWER, NO ELECTRICAL.</u>		
Contractor's name, address & telephone: <u>WRIGHT-RYAN CONSTRUCTION INC 10 DANFORTH STREET 773-3625</u>		
Who should we contact when the permit is ready: <u>TOM WRIGHT</u>		
Mailing address: _____ <u>X-2000</u>		
We will contact you by phone when the permit is ready. You must come in and pick up the permit and review the requirements before starting any work, with a Plan Reviewer. A stop work order will be issued and a \$100.00 fee if any work starts before the permit is picked up. PHONE: <u>773-3625</u> <u>XX</u>		

IF THE REQUIRED INFORMATION IS NOT INCLUDED IN THE SUBMISSIONS THE PERMIT WILL BE AUTOMATICALLY DENIED AT THE DISCRETION OF THE BUILDING/PLANNING DEPARTMENT, WE MAY REQUIRE ADDITIONAL INFORMATION IN ORDER TO APPROVE THIS PERMIT.

I hereby certify that I am the Owner of record of the named property, or that the owner of record authorizes the proposed work and that I have been authorized by the owner to make this application as his/her authorized agent. I agree to conform to all applicable laws of this jurisdiction. In addition, if a permit for work described in this application is issued, I certify that the Code Official's authorized representative shall have the authority to enter all areas covered by this permit at any reasonable hour to enforce the provisions of the codes applicable to this permit.

Signature of applicant: <u>[Signature]</u>	Date: <u>7-23</u>
--	-------------------

This is NOT a permit, you may not commence ANY work until the permit is issued. If you are in a Historic District you may be subject to additional permitting and fees with the Planning Department on the 4th floor of City Hall.



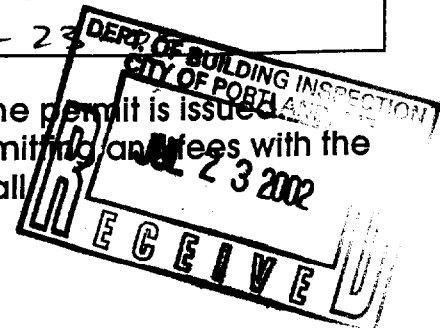


PHOTO of AN EXISTING 40 x 60

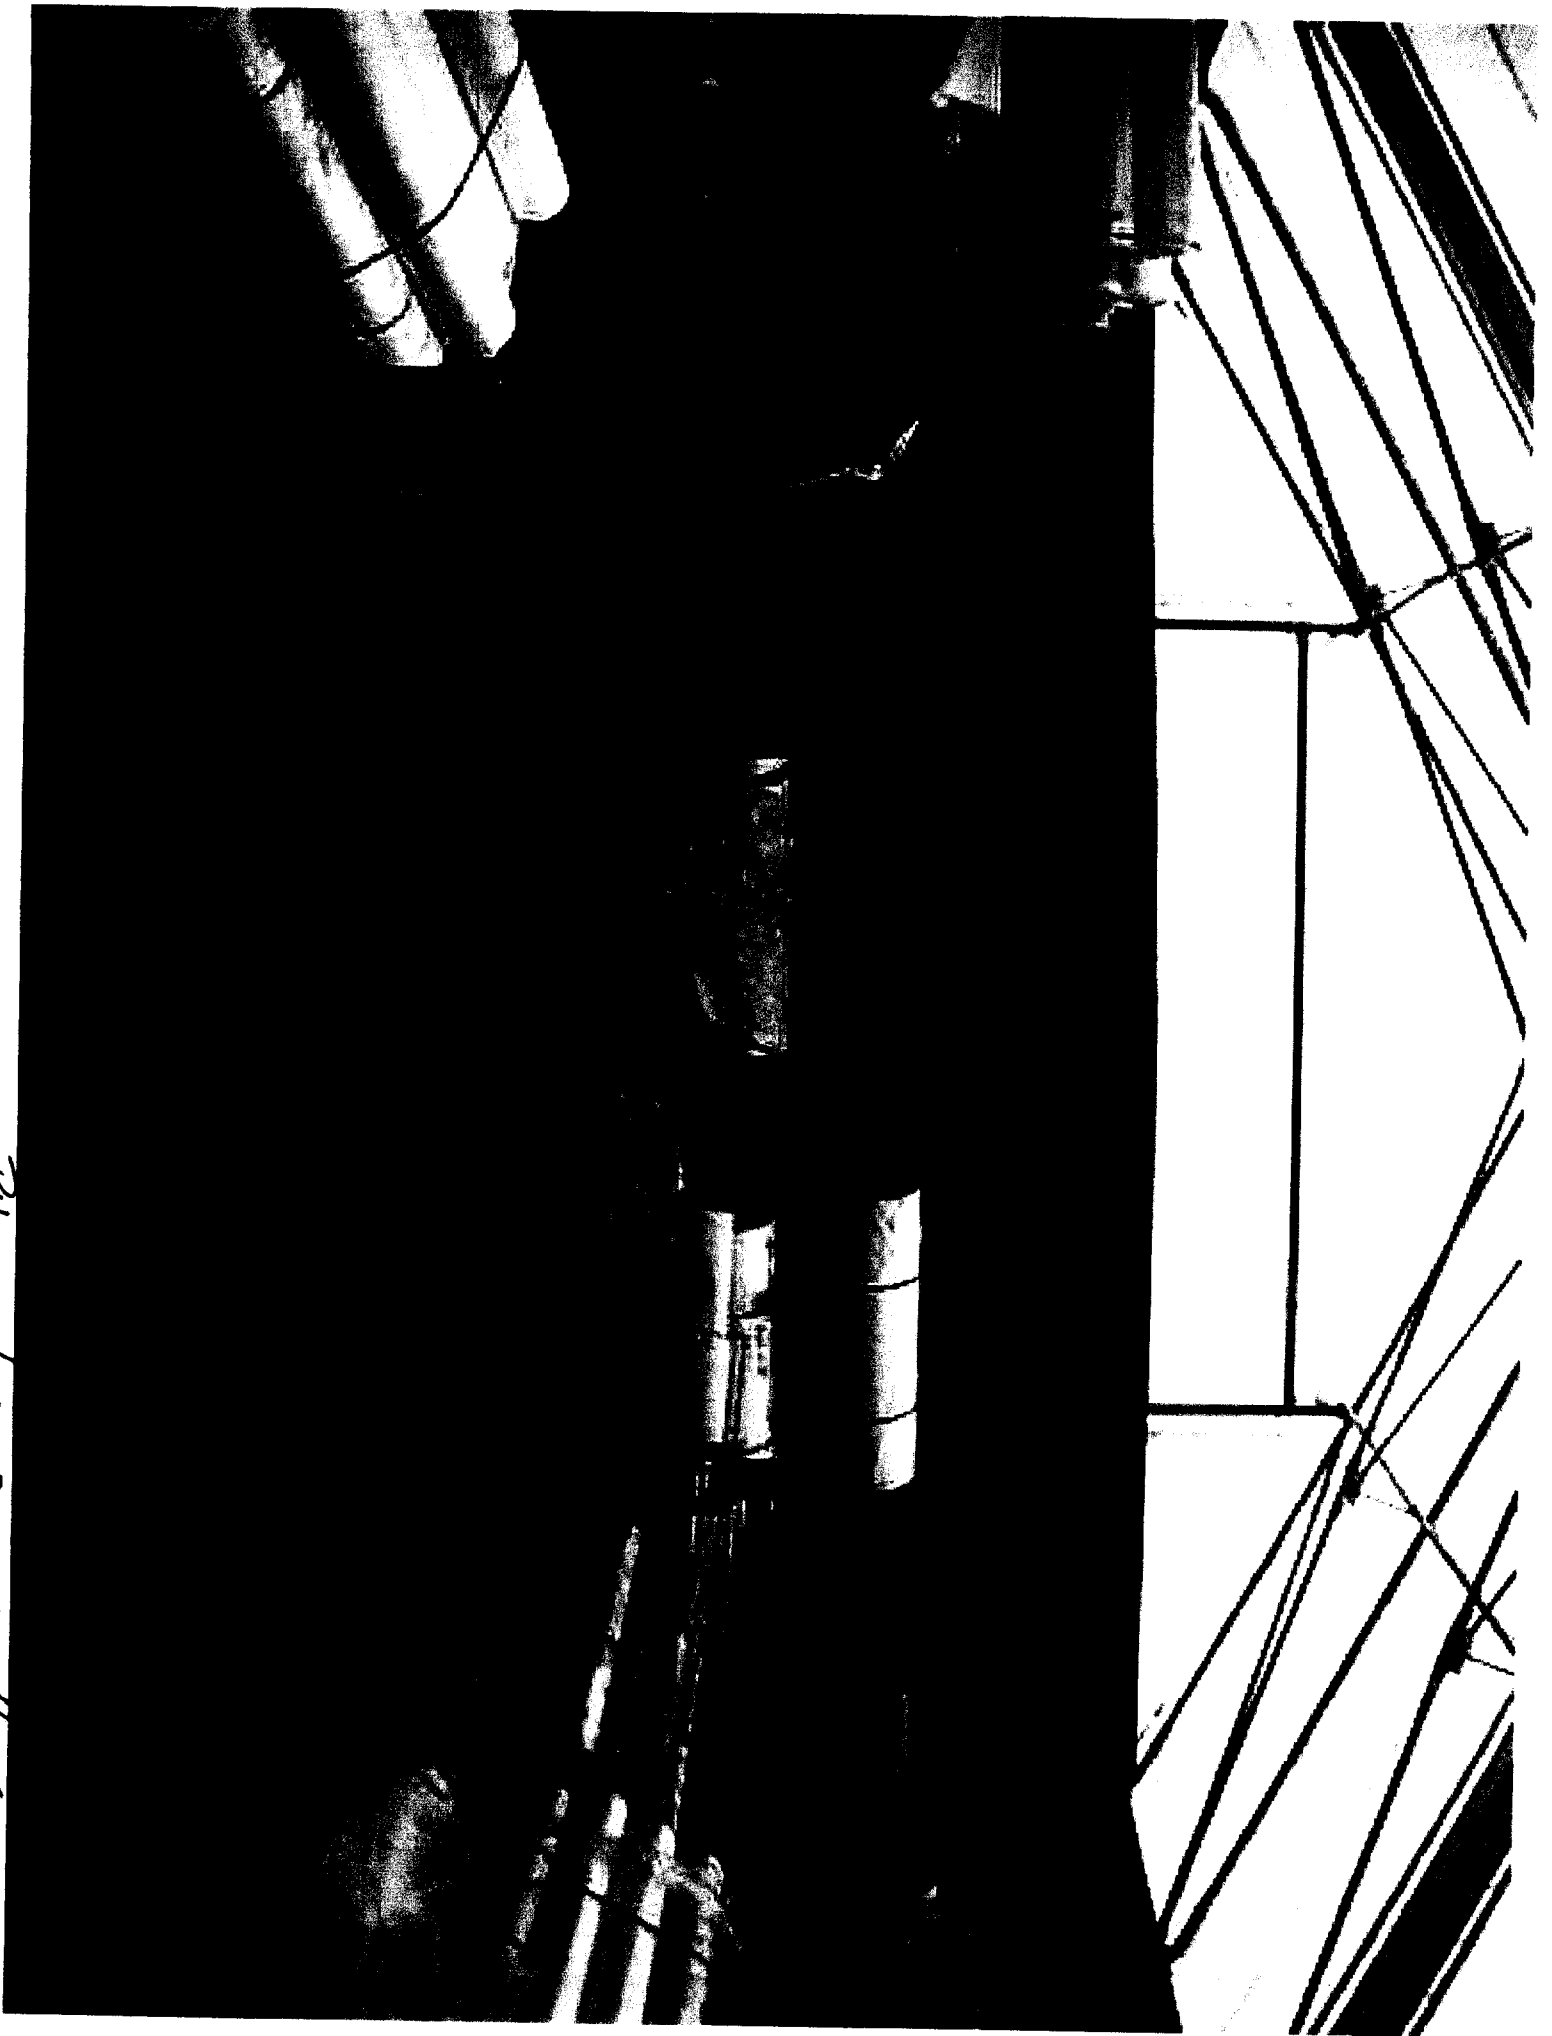

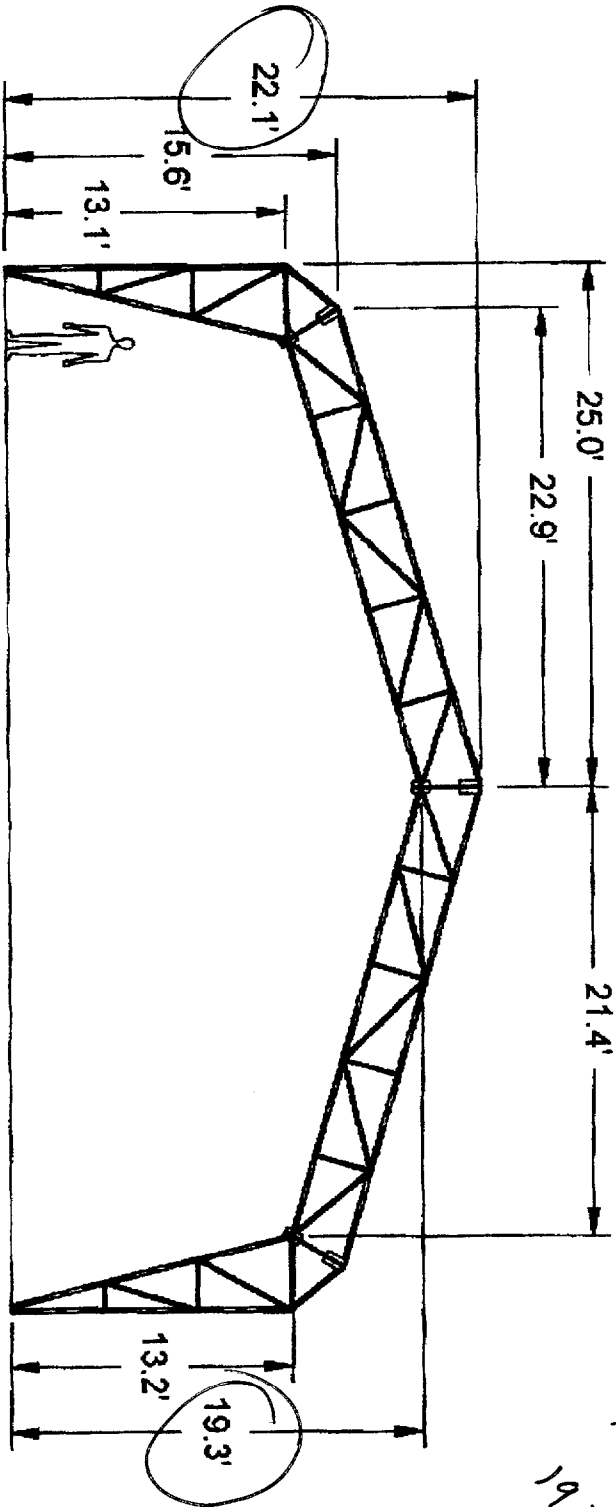

*I-M and
75' max height
Allowed
19.3' shown*

**50' SPAN BOWE W/13.1' LEG
SPAN PROFILE**

Fig. K 100

SA 930 SF 81 LF 1:100 DCN

TRUBB
BUILDING SYSTEMS

DATE 5/2/97 DRAWING NO. 80133



WRIGHT-RYAN CONSTRUCTION, INCORPORATED

23 July, 2002

Kandice Talbot
Planning and Urban Development
City of Portland
389 Congress Street
Portland, Maine 04101

Re: 276 Rear Canco Road, Temporary Structure

Dear Ms. Talbot:

The attached application is for a much more reduced project than that of our previous application in February, 2002.

We are proposing to place a forty foot by sixty foot temporary structure on existing grade without a concrete foundation. There will be no utilities to the building. The enclosure will be covered in PVC of the same gray color to that of the existing building.


*limit to one year
from date of approval*

Our intention is to provide covered storage for our forms and supplies and also make the yard more attractive for the adjoining dentist offices.

Please call me with any questions about the application.

Thank you,

Tom Wright

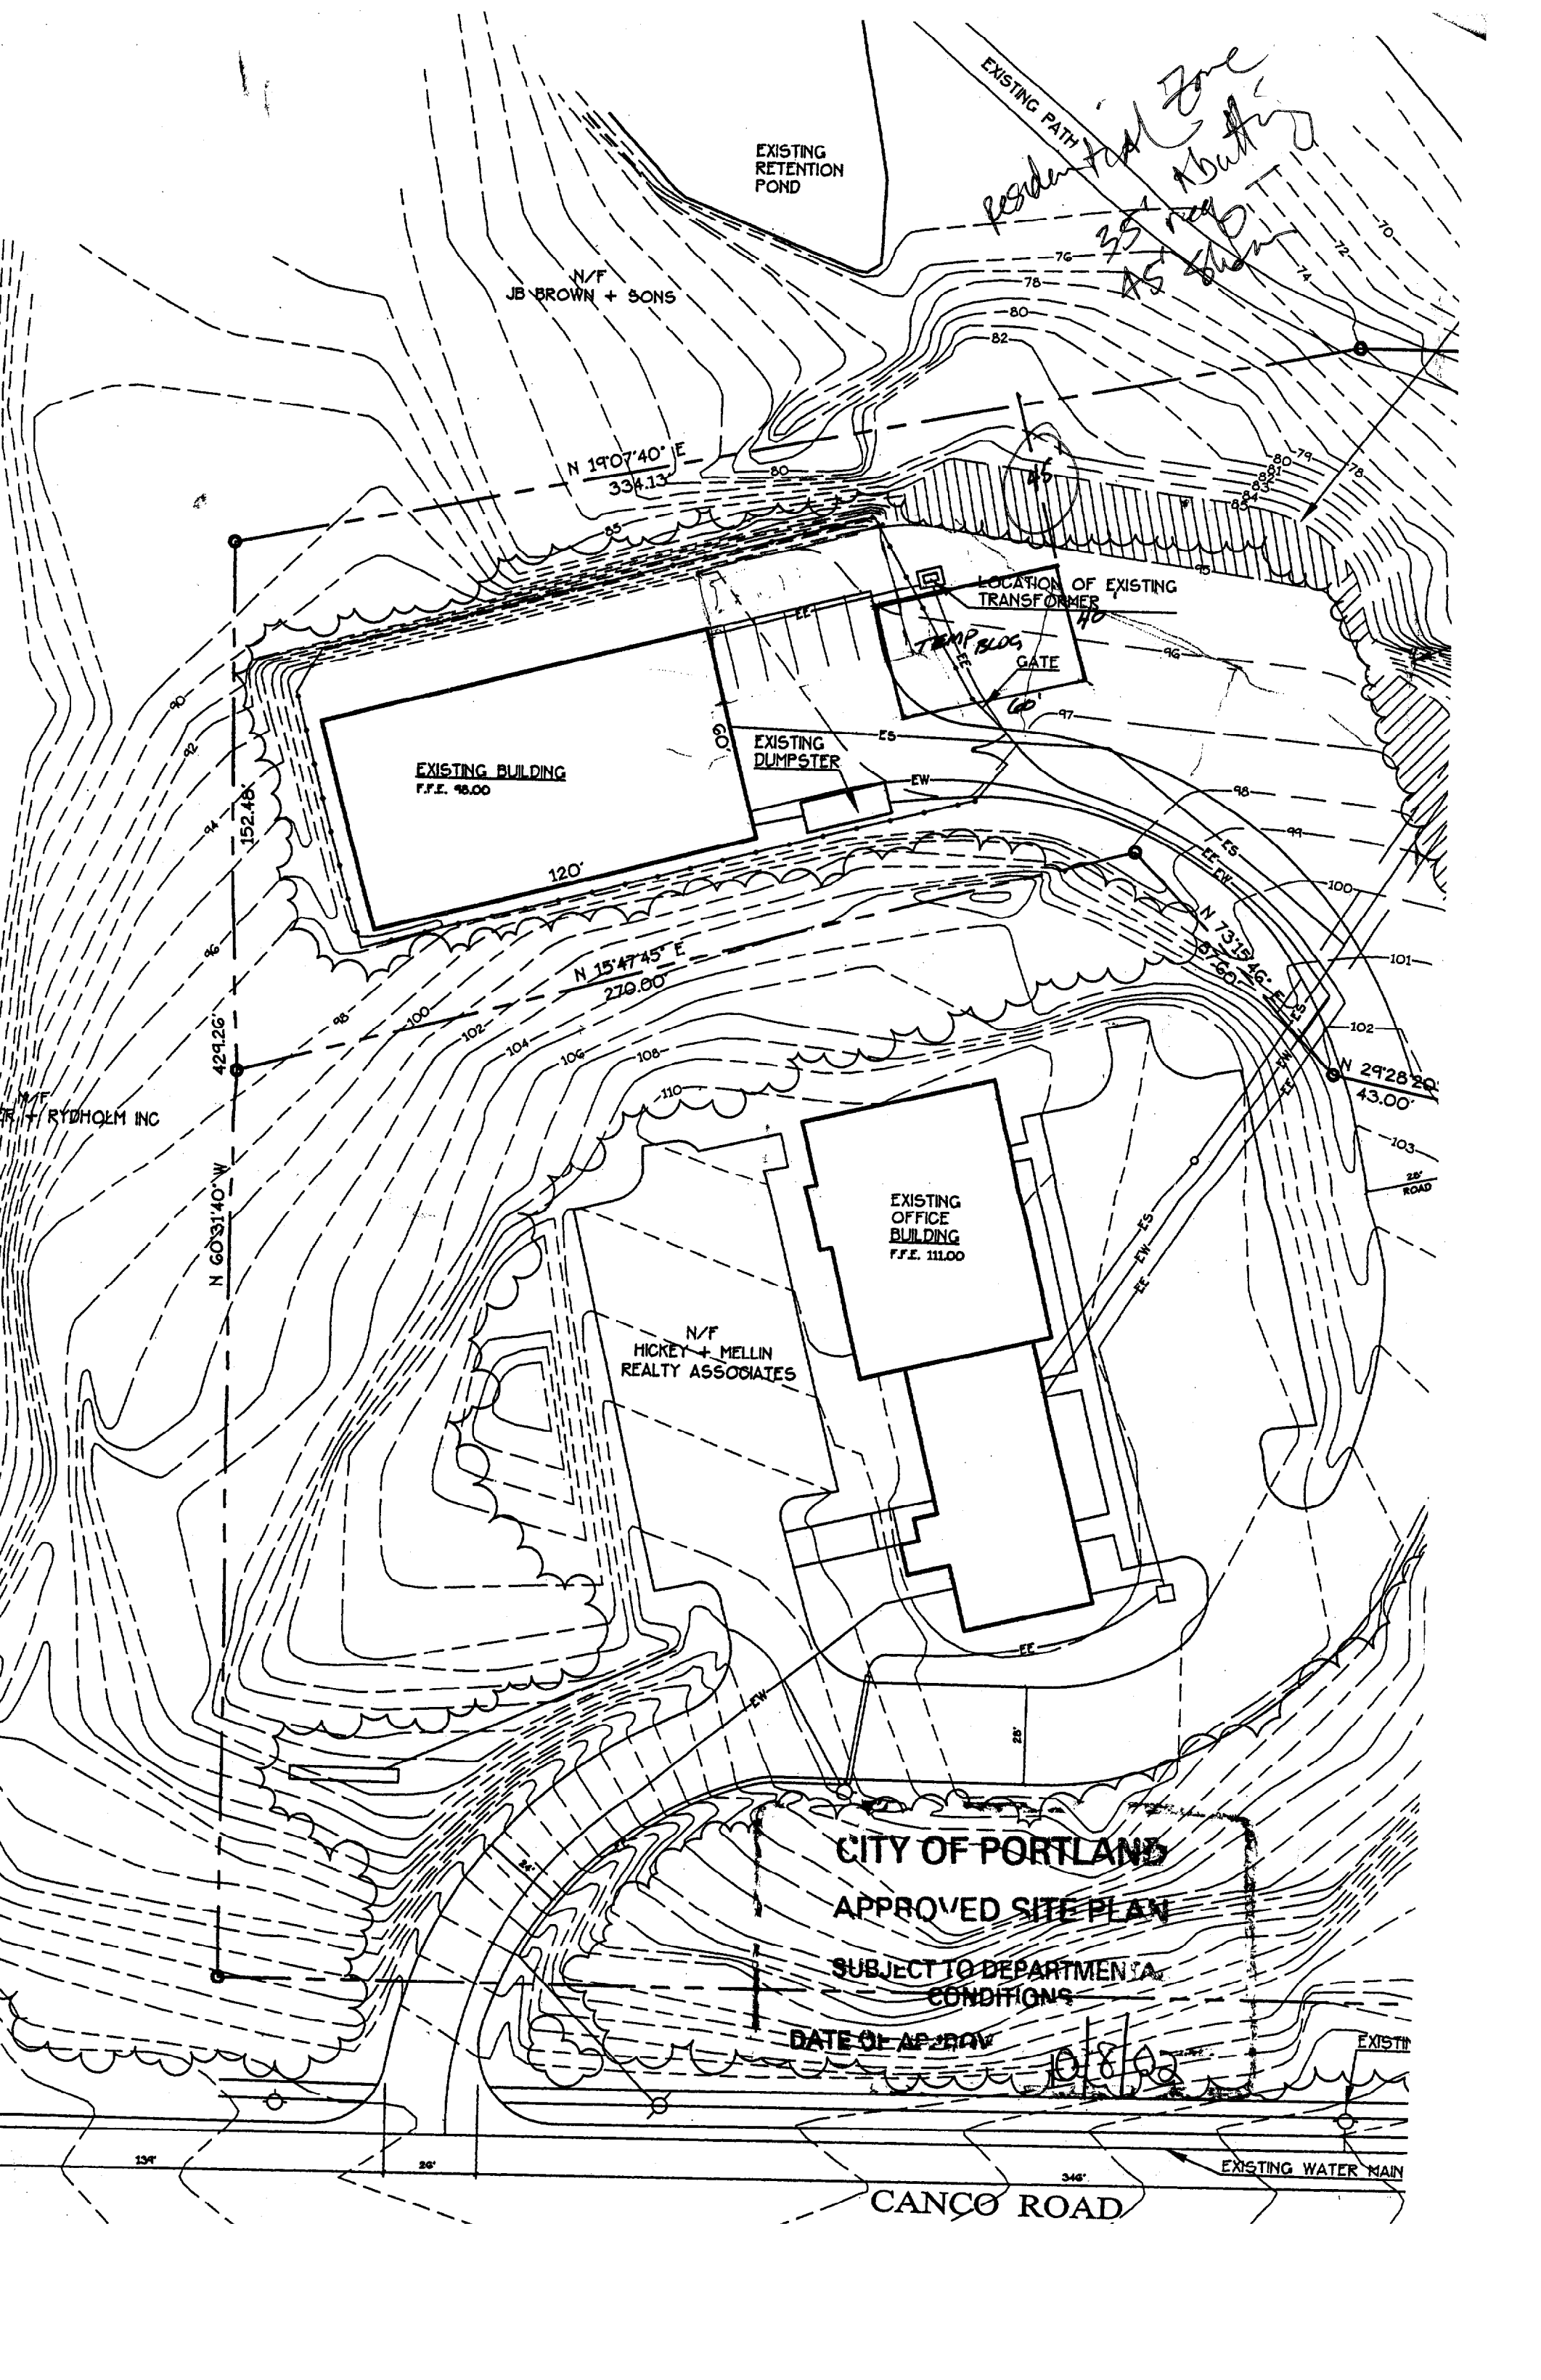

EXISTING RETENTION POND

N/F JB BROWN + SONS

N 19°07'40" E
334.13'

EXISTING PATH

*residential zone
35' setback
AS shown*

LOCATION OF EXISTING TRANSFORMER

TEMP BLOS GATE

EXISTING BUILDING
F.F.E. 98.00

EXISTING DUMPSTER

EXISTING OFFICE BUILDING
F.F.E. 111.00

N/F HICKEY + MELLIN REALTY ASSOCIATES

N/F RYDHOLM INC

CITY OF PORTLAND
APPROVED SITE PLAN


SUBJECT TO DEPARTMENTAL
CONDITIONS

DATE OF APPROVAL

10/8/02

CANCO ROAD

EXISTING WATER MAIN

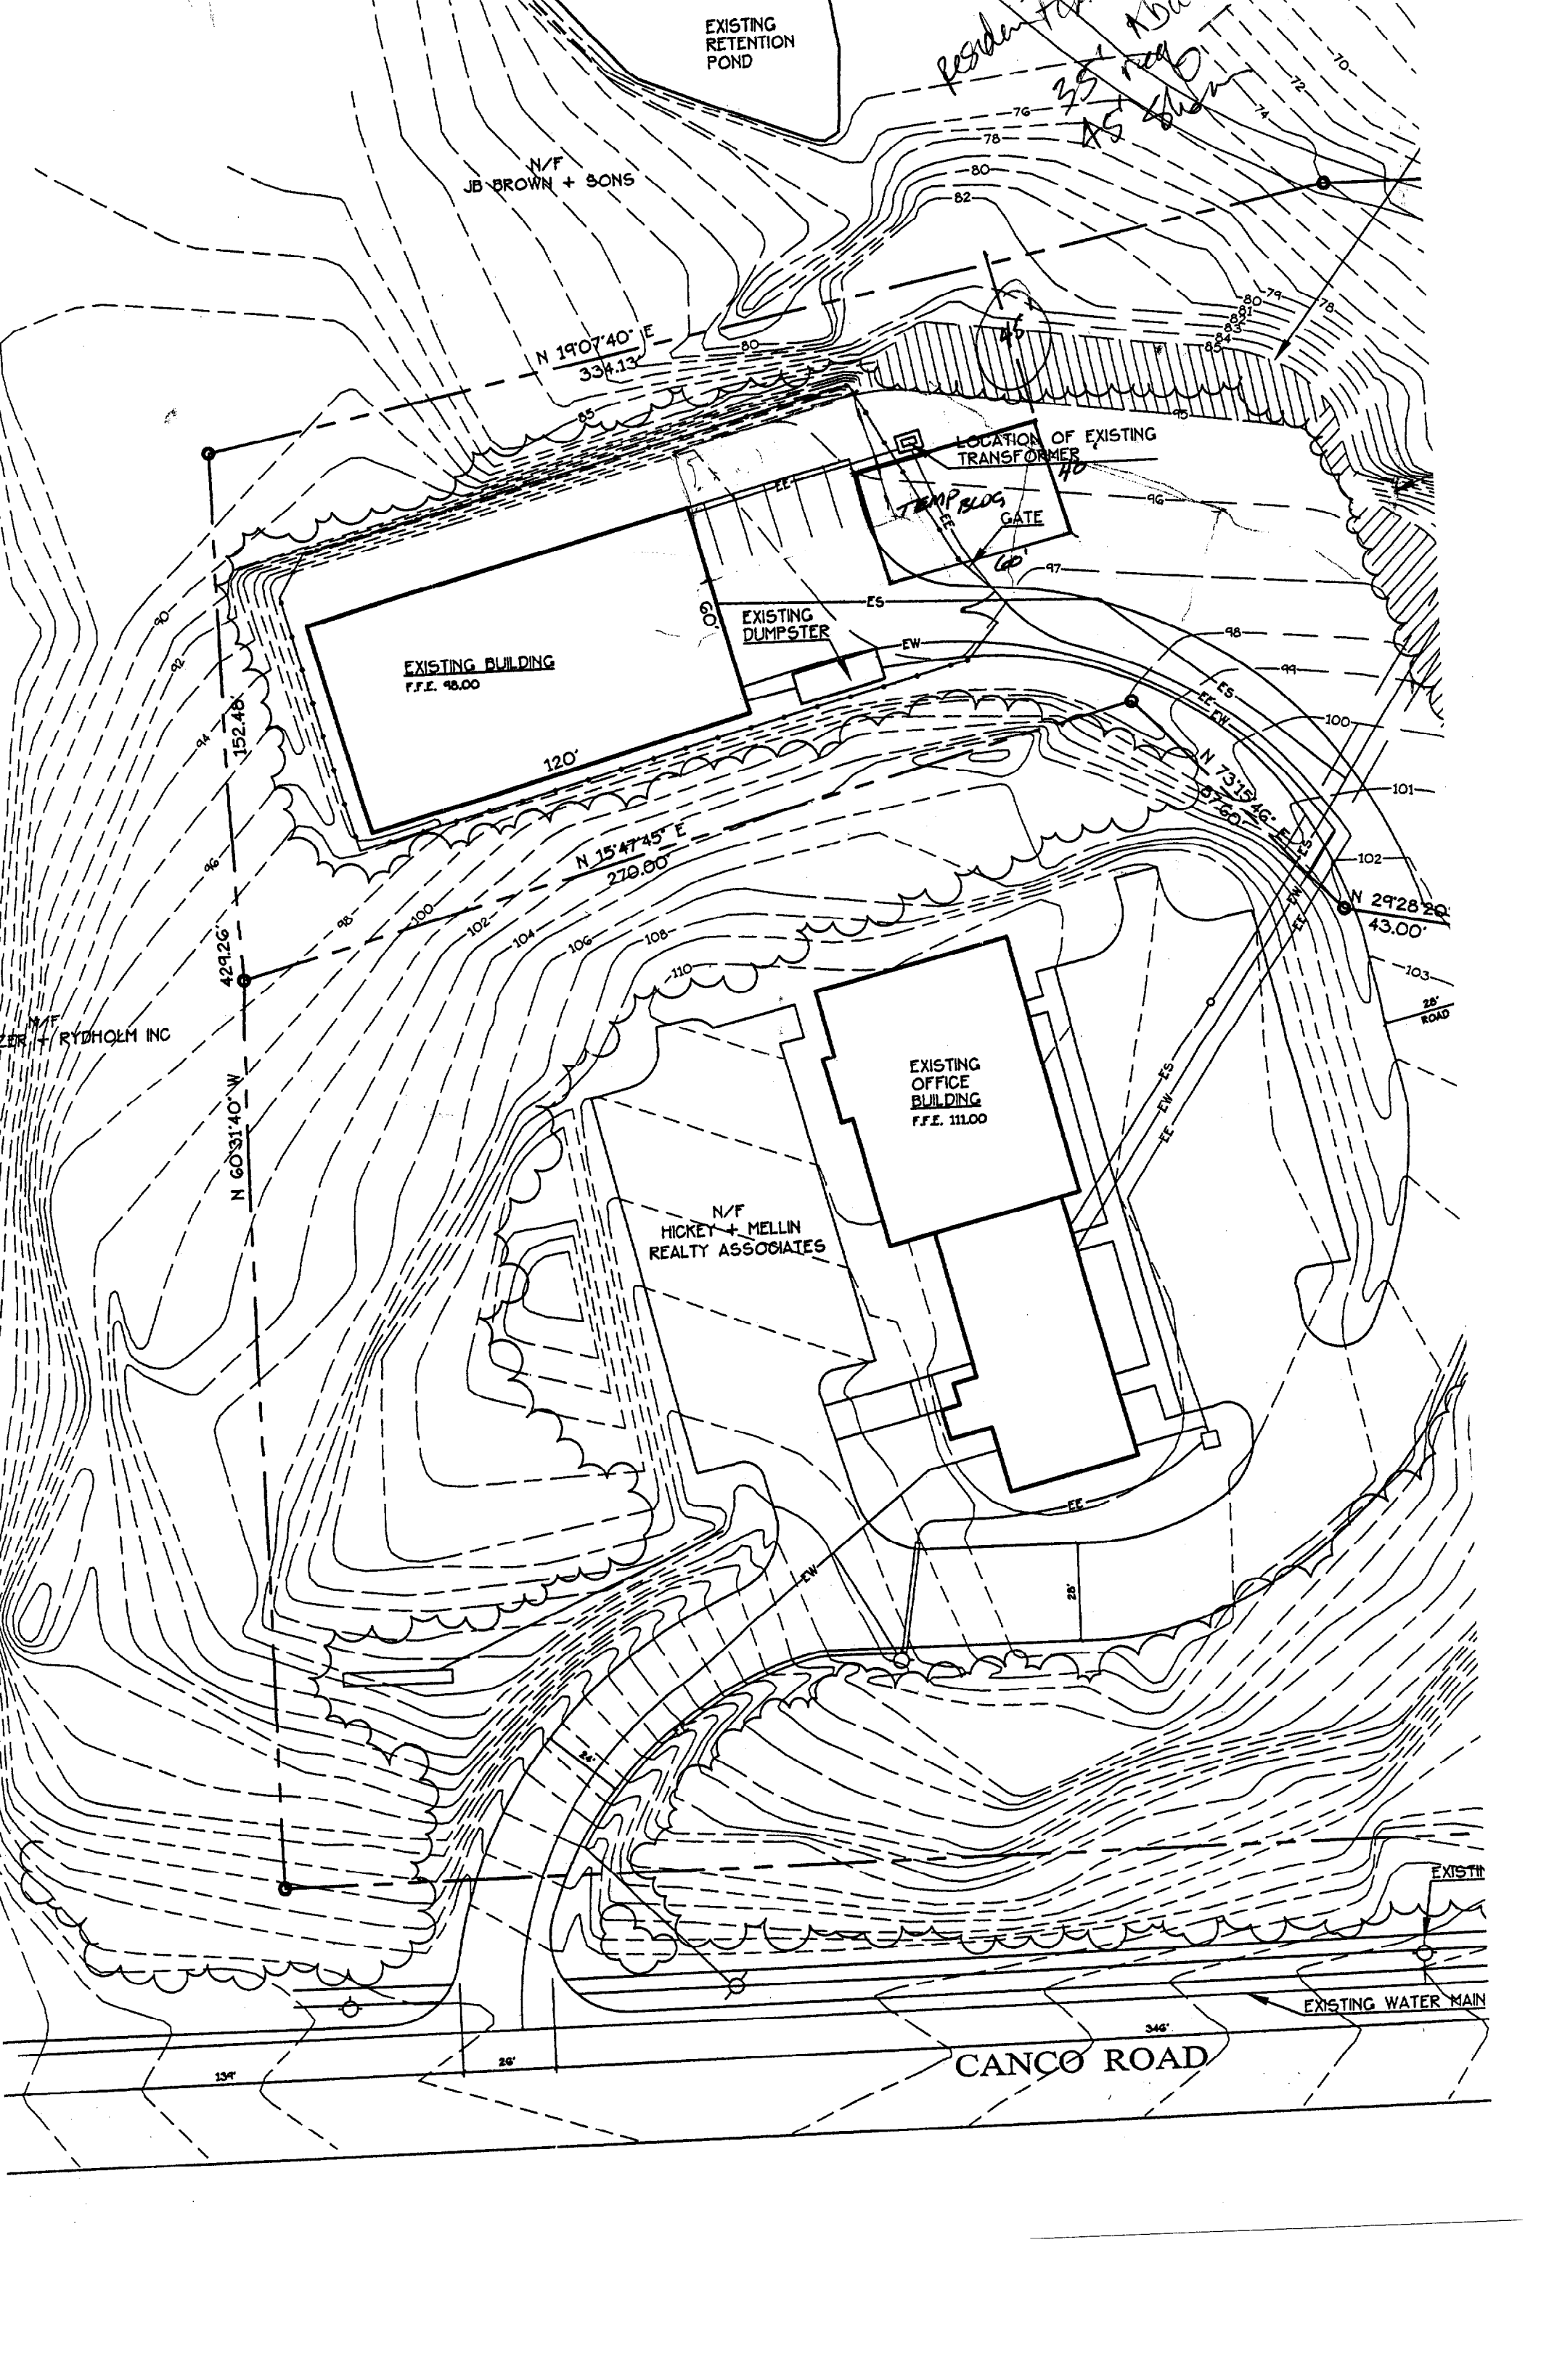

Wright-Ryan

40' x 60' x 12' BVR BUILDING
(12.19m x 18.29m x 3.65m)

Design Loads
BOCA 1999 BUILDING CODE
90 mph Wind (ASCE 7-99)
50 psf Ground Snow Load

URUBB BUILDING SYSTEMS


DEPT. OF BUILDING INSPECTION
CITY OF PORTLAND
NOV 25 2002
RECEIVED

STATE OF MAINE
REGISTERED PROFESSIONAL ENGINEER
No. 8848
11/29/02


RE: 876 Camco
#02 0816
154 3047

FOR PERMIT APPLICATION ONLY


REV	DESCRIPTION	DATE
1	1219A BVR / 3.65M LEG BOLTING INSTRUCTIONS AND AXIAL STEEL FITUP DETAILS	
RUBB We Cover The World		
SCALE	1:5	
DATE	GLJ 11-20-02	
PROJECT	RLB, INC. SANFORD NAME 04073 TEL: 207-324-2877 FAX 207-324-2347	
DESIGNED BY	WRIGHT-RYAN	
This drawing is the property of RLB, Inc. and may not be reproduced or used for any purpose without the express written consent of RLB, Inc.		
PROJECT NO.	01497	

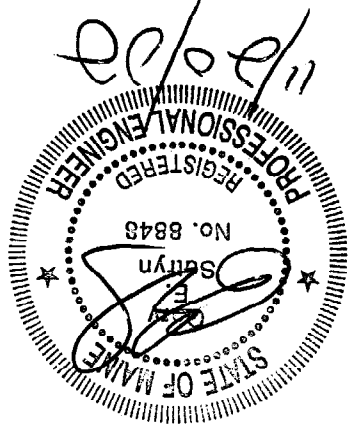


SPAN TIE TUBE S1

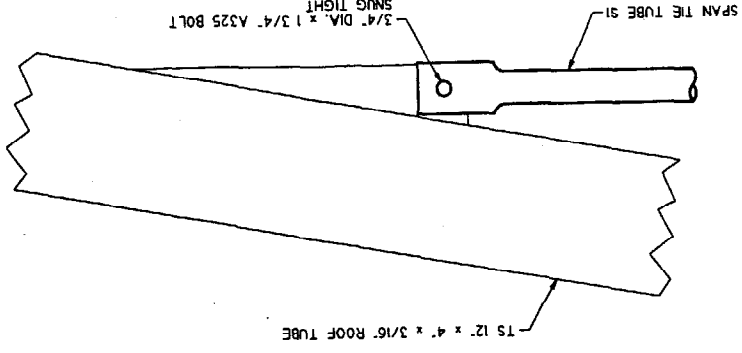


PEAK AXIAL TUBE A1

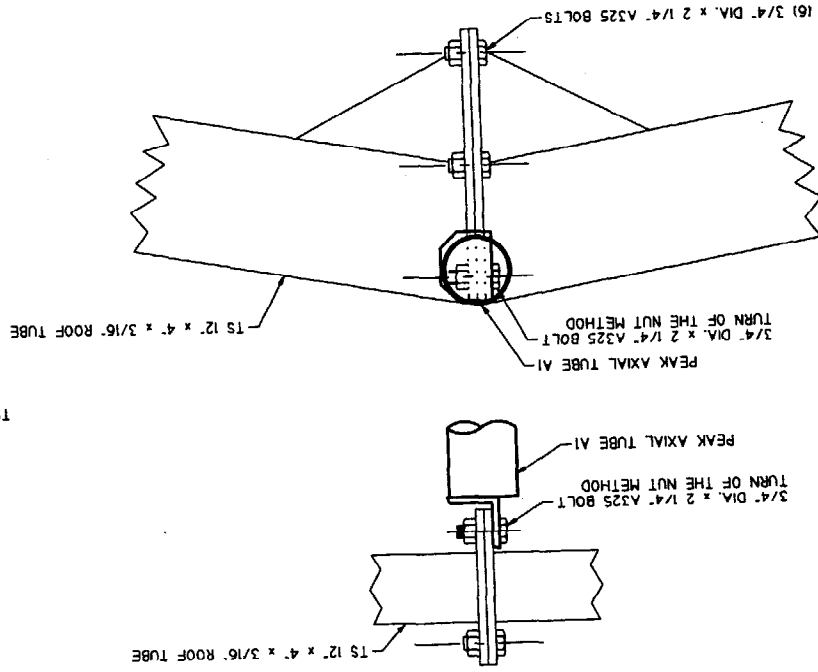


EAVE AXIAL TUBE A2

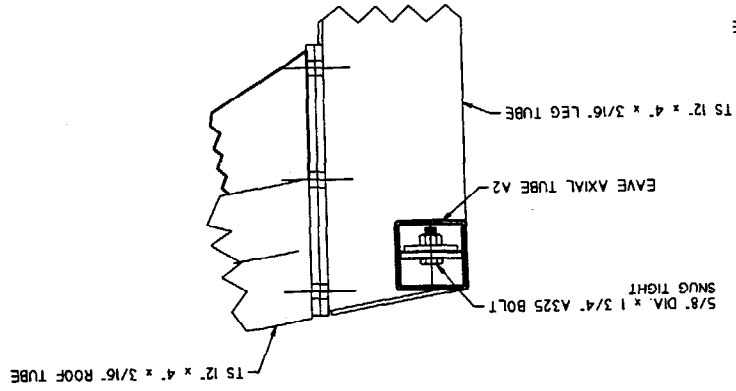


LEG TO ROOF FLANGE

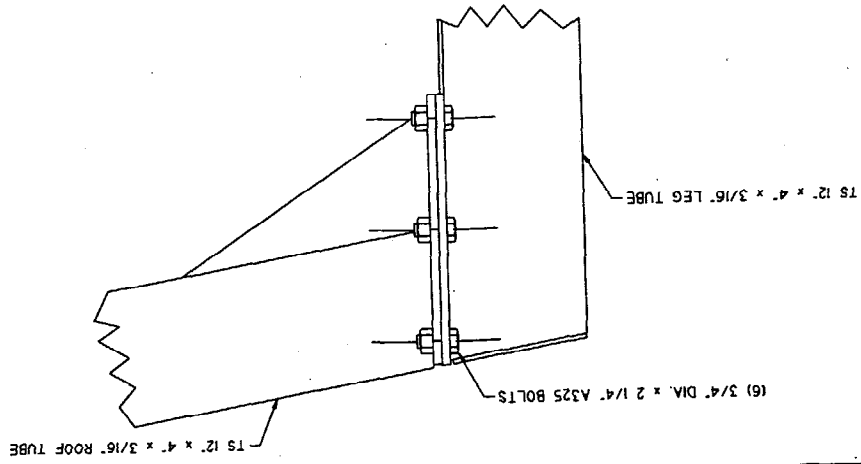


ROOF TO ROOF FLANGE

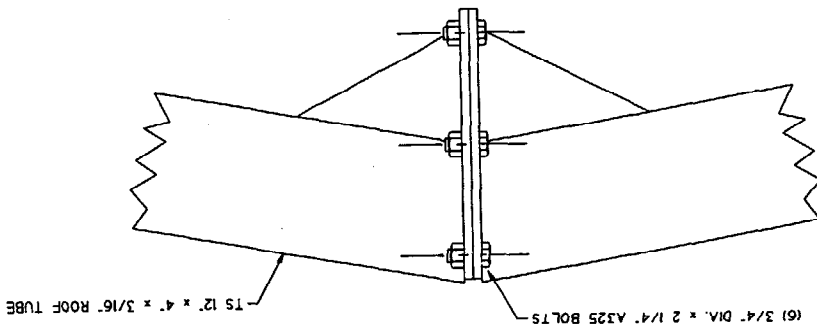


LEG TO CONCRETE

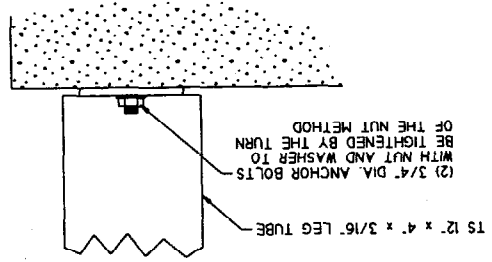


ROOF LONGITUDINAL A3

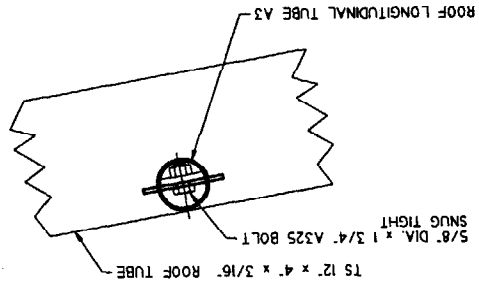


LEG LONGITUDINAL A4

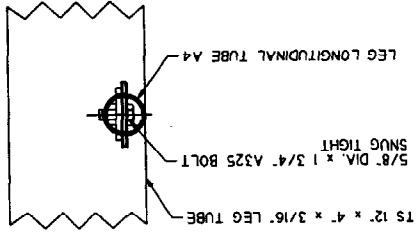

FIELD NOTE:
 1) ALL FLANGE BOLTS TO BE TIGHTENED BY THE TURN OF THE NUT METHOD.
 2) ALL AXIAL STEEL BOLTS TO BE TIGHTENED SNUG TIGHT.
 3) ALL METHODS FOR TIGHTENING NUTS ARE AS DEFINED IN THE AISC STEEL MANUAL (NINTH EDITION).
 4) DIMENSIONS NOT LABELED WITH UNITS ARE IN MILLIMETERS.

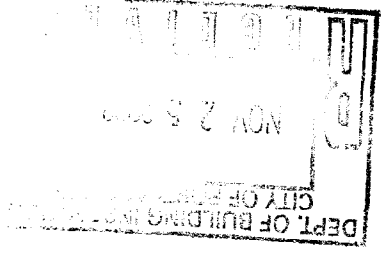



FOR PERMIT APPLICATION ONLY

REV	DESCRIPTION	DRAWN	APP.	DATE
We Cover The World				
 BUILDING SYSTEMS 12.19 m BVR / 3.65m LEG PURLIN PROFILE				
DATE	JOB NAME	JOB #		
WRIGHT-RYAN	GLJ 11-20-02	1 : 40		
This drawing is the property of Rubb Inc. and may not be reproduced or used for any manufacturing purpose without the express written consent of Rubb, Inc.				
DRAWING NO.	RUBB, INC. SANFORD MAINE 04073			
81498	TEL: 207-324-2877 FAX 207-324-2347			

ASSEMBLY	BOLT DIMENSIONS	SPEC
A1	3/4" DIA. x 2 1/4"	A325
A2	5/8" DIA. x 1 3/4"	A325
A3	5/8" DIA. x 1 3/4"	A325
A4	5/8" DIA. x 1 3/4"	A325


BOLT SCHEDULE


FOR PERMIT APPLICATION ONLY

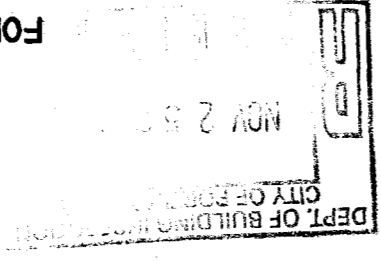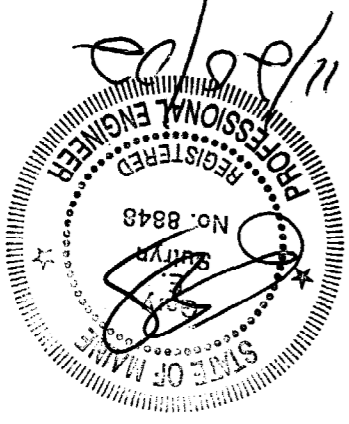

ALL BAYS


ASSEMBLY	QTY.	DESCRIPTION
A1	1	4" DIA. x 0.120" PEAK AXIAL TUBE
A2	2	4" x 4" x 3/16" EAVE AXIAL TUBE
A3	6	3" DIA. x 0.120" ROOF LONGITUDINAL
A4	6	2 3/8" x 0.120" DIA. LEG LONGITUDINAL

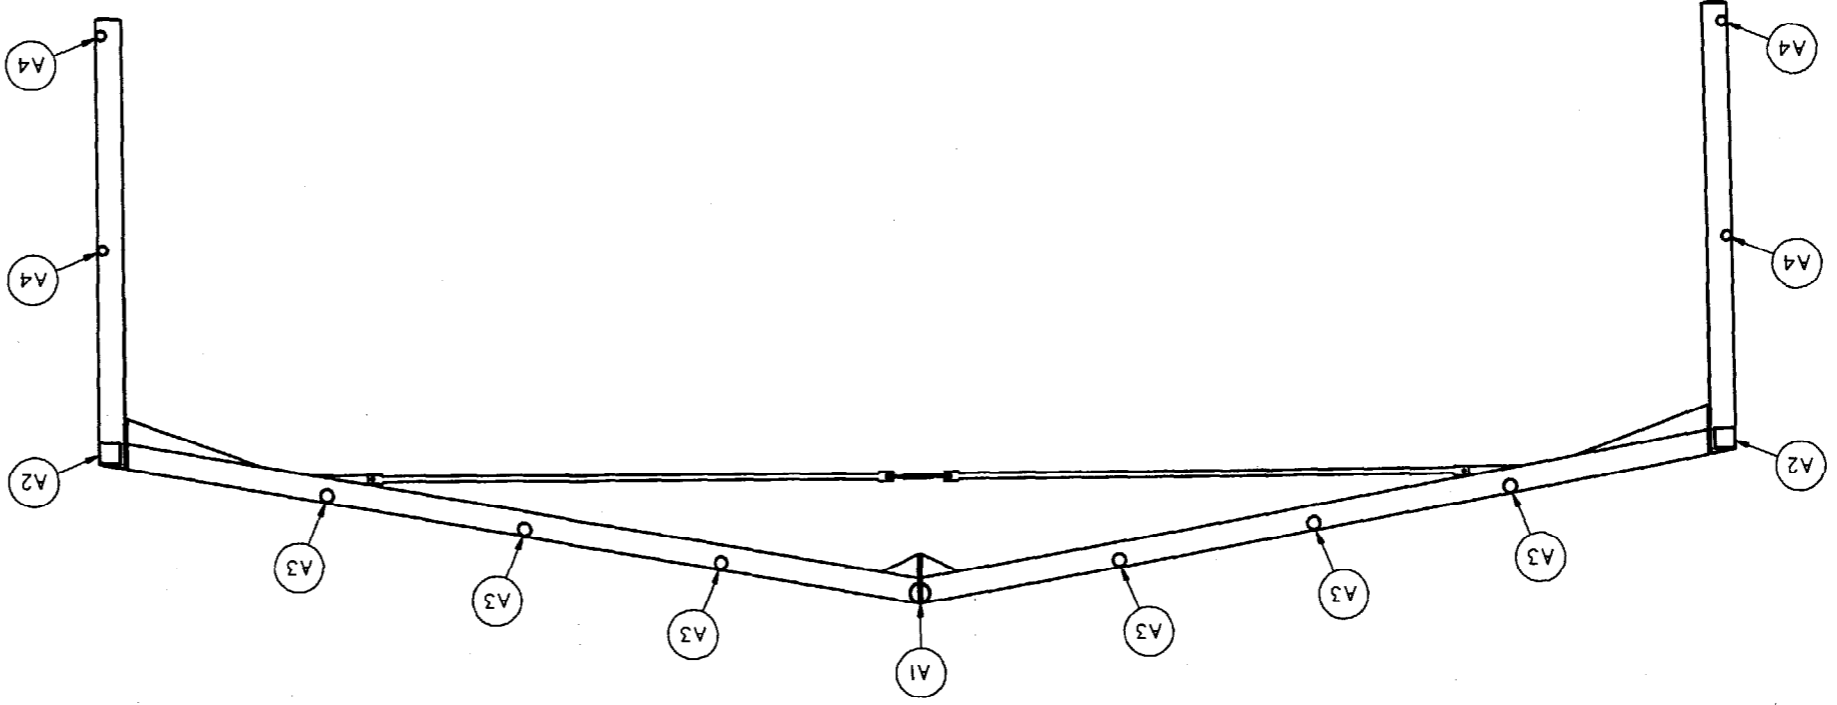

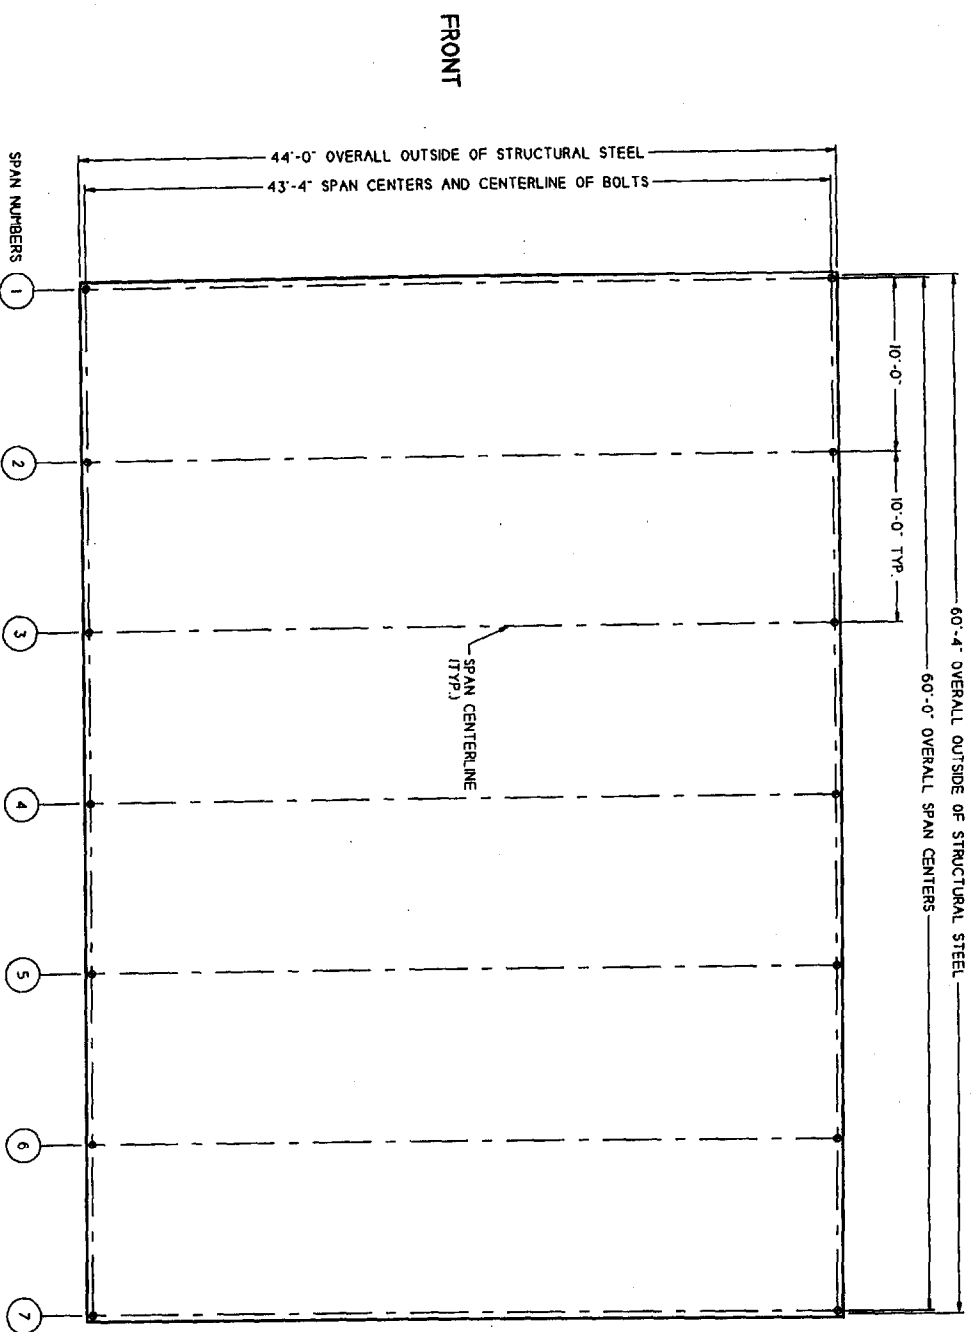


FRONT

REAR

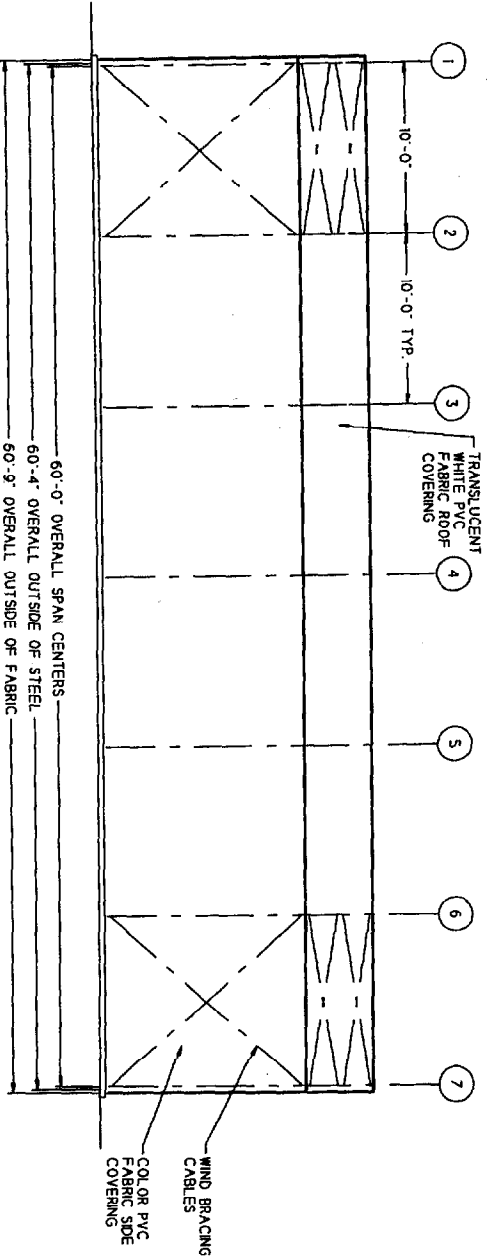

SIDE ELEVATION

TYPICAL BOTH SIDES

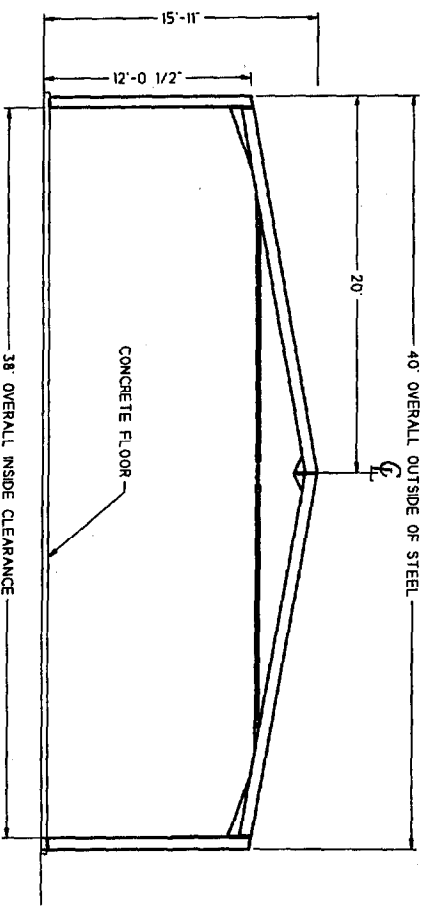


GABLE END

OPEN GABLE ENDS

- NOTES:
- COVERING MATERIAL IS A PVC FREGATED POLYESTER WEAVE FABRIC, SELF-EXTINGUISHING TO FEDERAL TEST STANDARD 191 (ASTM D 1571) AND CALIFORNIA STATE FIRE MARSHAL'S BUREAU OFCE 55-1 AND CALIFORNIA STATE FIRE MARSHAL'S BUREAU OFCE 55-1 STRUCTURAL FRAMEWORK IS TUBULAR STEEL INTERCONNECTED WITH TUBULAR STEEL PURLINS, STEEL PLATE AND SHAVES ARE A36, STEEL TUBING IS A500B.

11/20/02

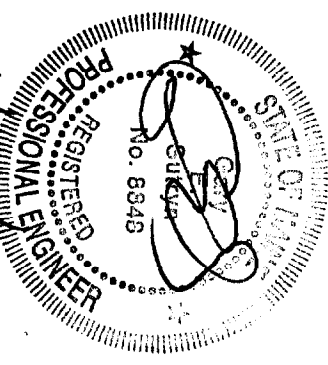

DEPT. OF BUILDING INSPECTION
CITY OF BALTIMORE

FOR PERMIT APPLICATION ONLY


REV	DESCRIPTION	DATE	BY	CHK
1	1219 th BVR / 1.65 th LEG PLAN VIEW & ELEVATIONS	11-20-02	WRGHT-R/AN	

1219th BVR / 1.65th LEG
PLAN VIEW & ELEVATIONS

WRGHT-R/AN

11/20/02

81499

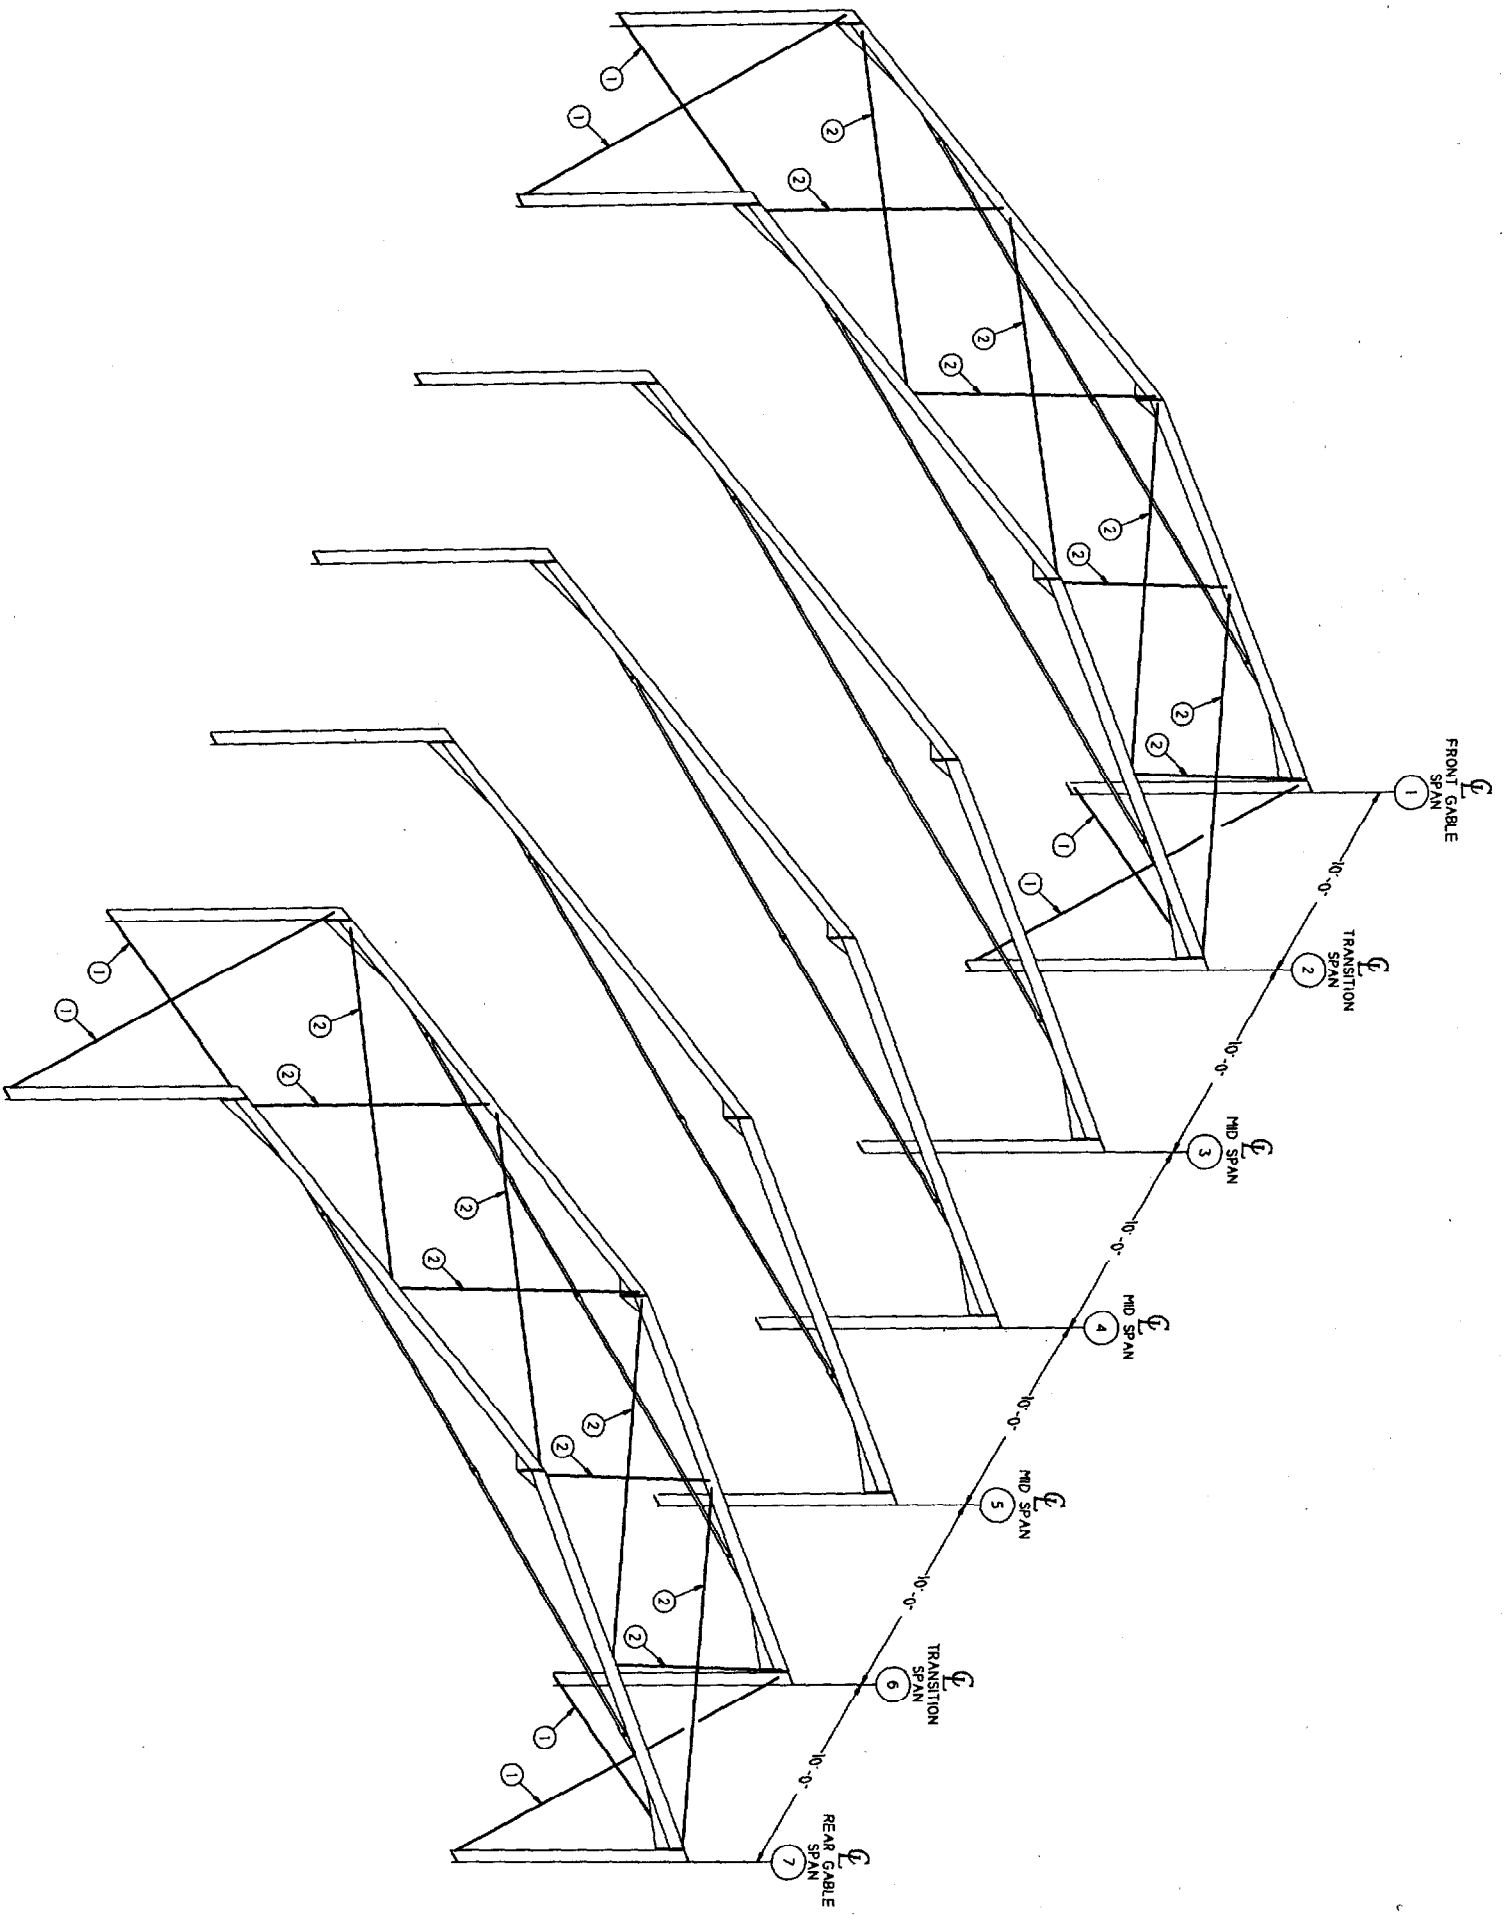


WIND BRACING CABLES

ITEM QTY	DESCRIPTION	DRAWING
1	LOWER & UPPER LEG	36020
2	LOWER & UPPER ROOF	36020

DEPT. OF BUILDING INSPECTION
CITY OF PORTLAND, OREGON

FOR PERMIT APPLICATION ONLY

11/20/02

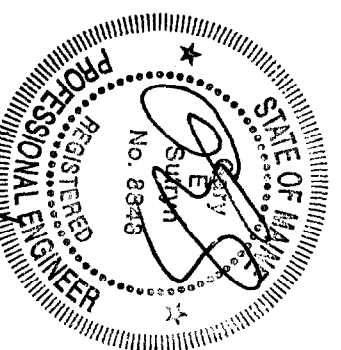

REV	DESCRIPTION	DATE	BY
1	12.19a BVR / 3.65a LEG		
2	WIND BRACING CABLE ISOMETRIC		

To Cover: The Work
RUBB
 BUILDING SYSTEMS
 61 J 11-20-02
 1 : 50
 DRAWN BY: MIGHT-RYAN
 CHECKED BY: MIGHT-RYAN
 DESIGNED BY: MIGHT-RYAN
 TEL: 207-524-2877 FAX: 207-524-2547
 81500

REV	DESCRIPTION	DRAWN	APP.	DATE
1	1219# BVR / 3.65# LEG FOUNDATION AND ANCHOR BOLT LAYOUT	RUBB		
BUILDING SYSTEMS				
GLJ 11-20-02				
SCALE 1:60				
PROJECT NO. 207-224-2347				
RUBB, INC. SANFORD MAINE 04073				
TEL: 207-224-2347 FAX: 207-224-2347				
81501				

RECEIVED
NOV 25 2002


NOTES:
1) THE LATERAL LOAD IS A POINT LOAD AT EACH COLUMN.
2) THE LATERAL LOAD IS A DISTRIBUTED LOAD ALONG THE BAY LENGTH.
3) 1000 POUNDS

CASE 1	DEAD - SNOW	4.0 kips UPLIFT	12 kips DOWN
CASE 2	DEAD - WIND	4.0 kips UPLIFT	4.0 kips UPLIFT
CASE 3	DEAD - GABLE WIND	10 kips UPLIFT	5.0 kips UPLIFT
	4.0 kips LATERAL	4.0 kips LATERAL	


FOUNDATION FORCES
WORST CASES COMBINED FROM ALL APPLICABLE LOAD COMBINATIONS
90 mph WIND
50 psf GROUND SNOW UBC 1997

MARK	TYPE	ANCHOR BOLT DIA.	D	V	B	C	E	H	MIN. THREADED	T	HALL	QTY	LOCATION
	AB	3/4"							STD			2	SPAN FOOTPLATES


ANCHOR BOLT SCHEDULE

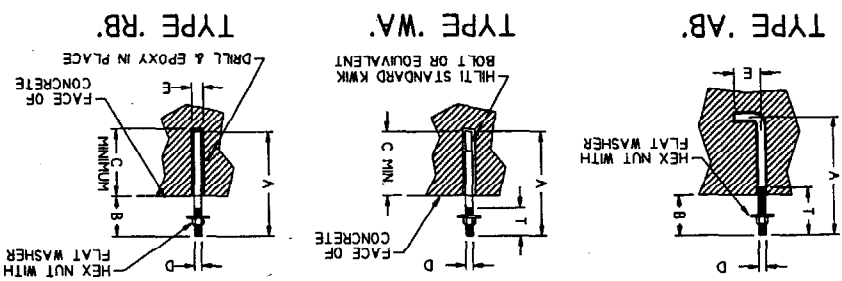

SECTION A-A
20x SCALE

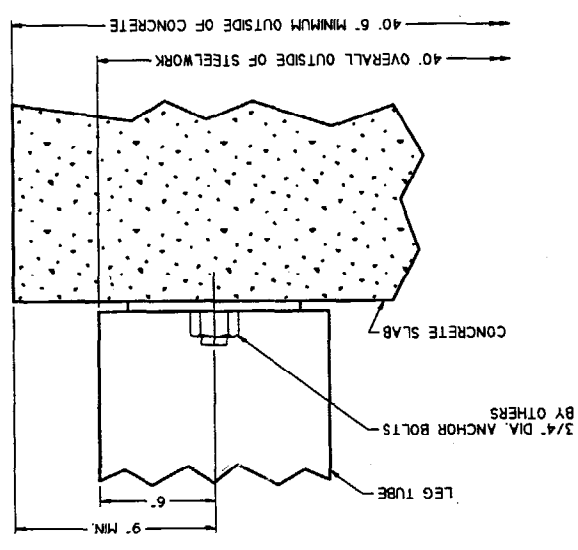


DETAIL C

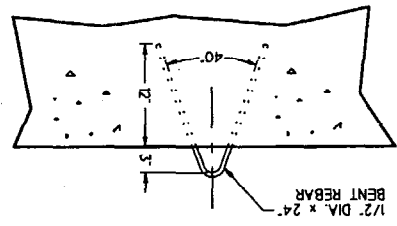


PVC CLADDING ANCHOR LOOP SHOWN AS DOTS IN PLAN VIEW NOT TO SCALE




DETAIL B
20x SCALE

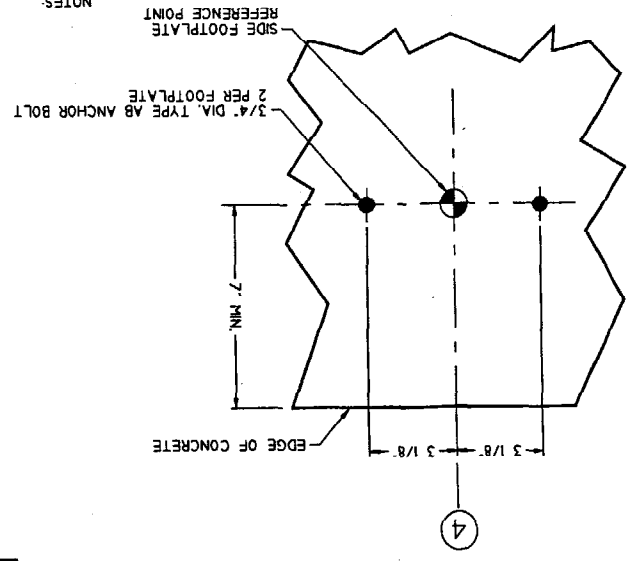

DETAIL A
20x SCALE

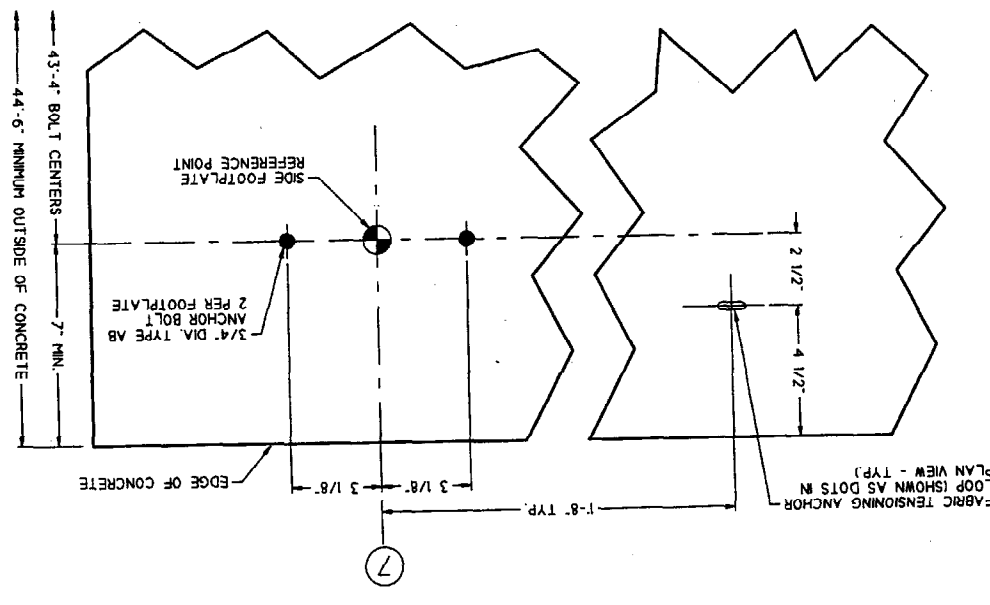

PLAN VIEW

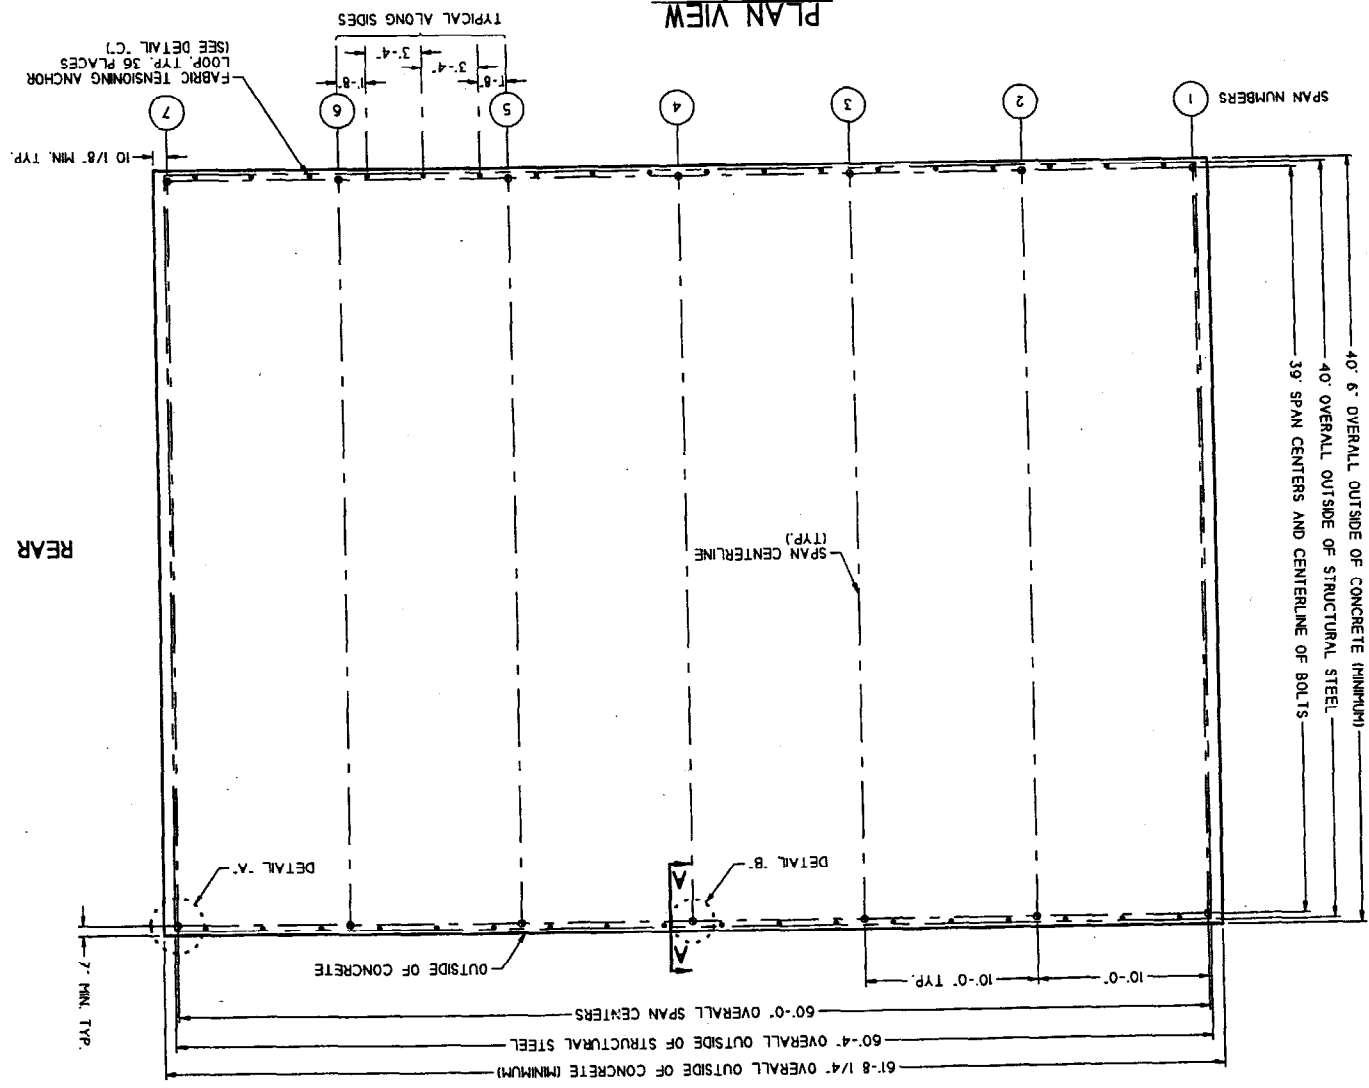

FRONT

REAR



40'-6" OVERALL OUTSIDE OF CONCRETE (MINIMUM)
40' OVERALL OUTSIDE OF STRUCTURAL STEEL
39' SPAN CENTERS AND CENTERLINE OF BOLTS

61'-8 1/4" OVERALL OUTSIDE OF CONCRETE (MINIMUM)
60'-0" OVERALL SPAN CENTERS
60'-4" OVERALL OUTSIDE OF STRUCTURAL STEEL
10'-0" TYP.
10'-0" TYP.

ITEM	QTY.	DESCRIPTION	DRAWING
M1	2	MID LEG TUBE	35969
M2	2	MID ROOF TUBE	35361
S1	2	SPAN TIE TUBE	35364

NOTE: BILL OF MATERIAL IS FOR ONE MID SPAN.

SPAN PROFILE

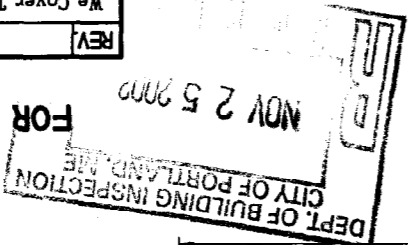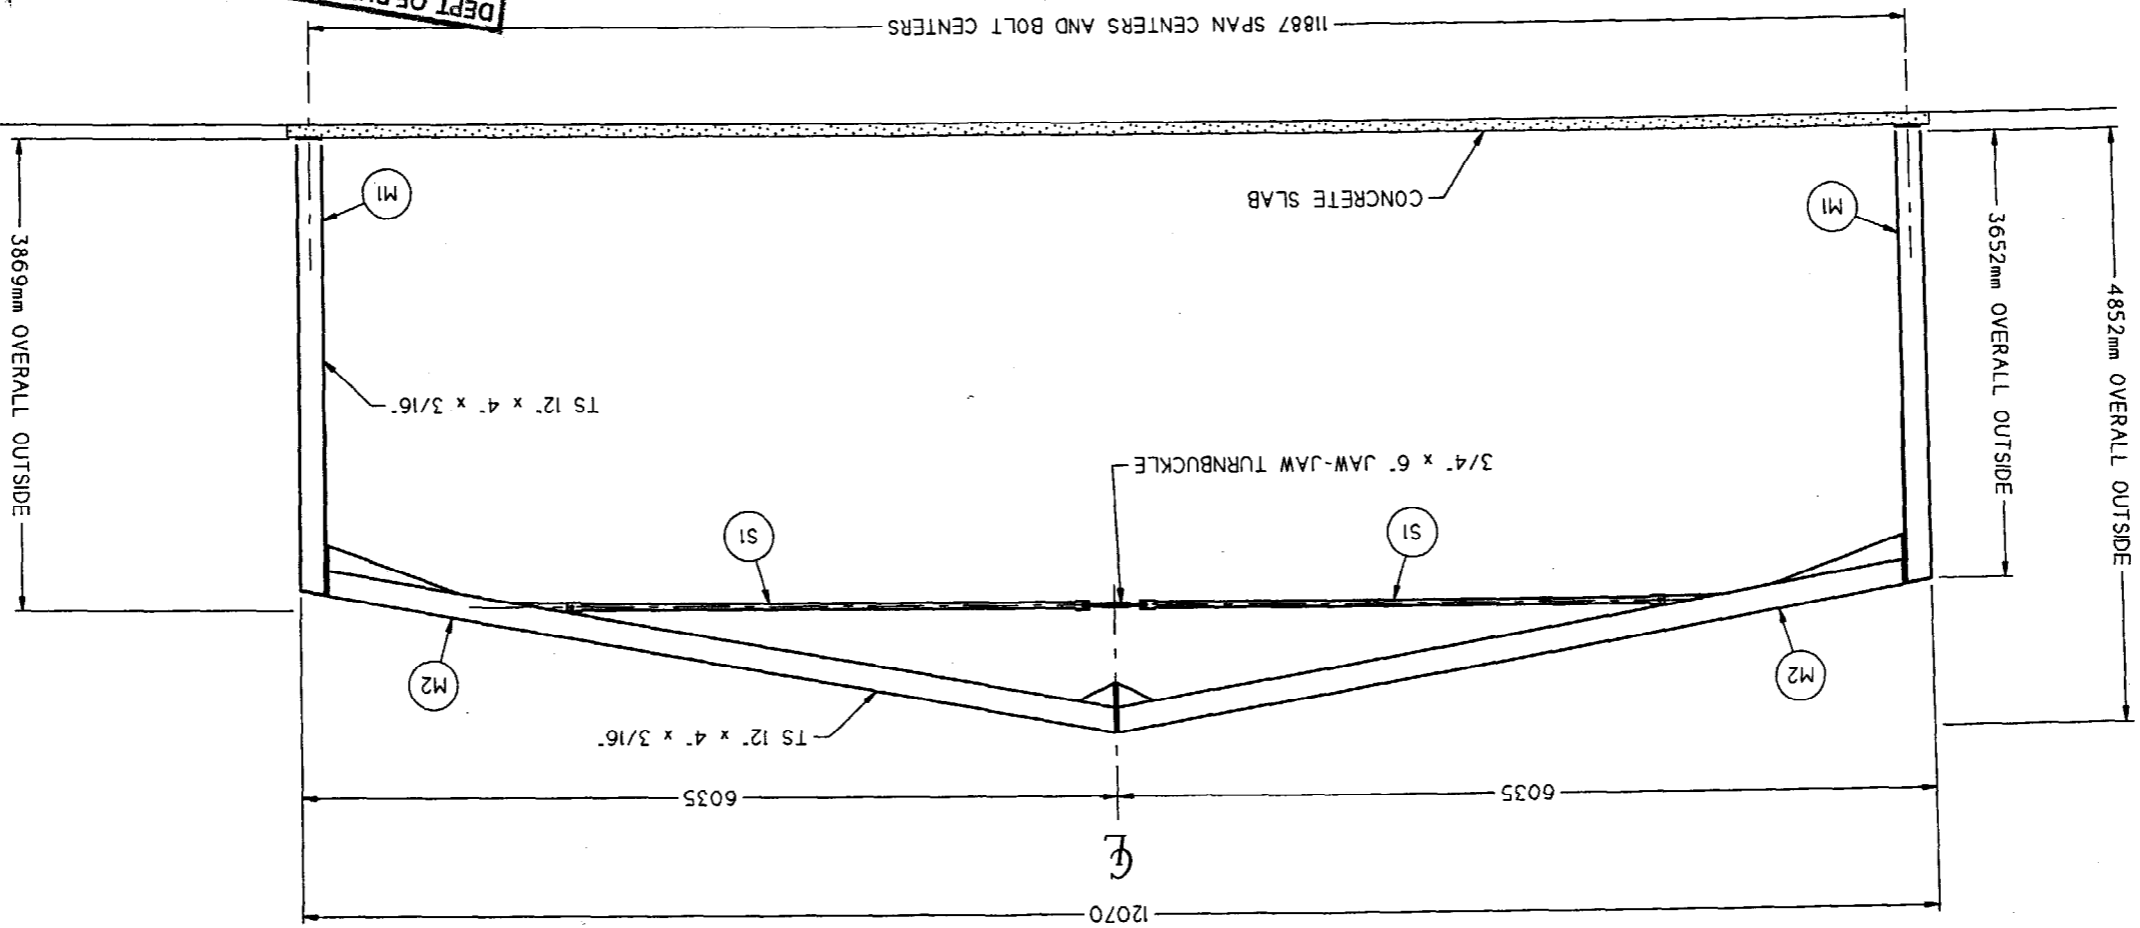

FOR PERMIT APPLICATION ONLY

REV.	DESCRIPTION	DRAWN	APP.	DATE

We Cover The World
RUBB
 BUILDING SYSTEMS
 12.19m BVR / 3.65m LEG
 SPAN PROFILE

DRAWN: GLJ 11-20-02
 SCALE: 1 : 40
 DATE: 11-20-02
 JOB:
 JOB NAME: WRIGHT-RYAN
 DATE:
 DRAWING NO.: 81502

This drawing is the property of Rubb, Inc. and may not be reproduced or used for any manufacturing purpose without the express written consent of Rubb, Inc.