


1 PLAN DETAIL AT 2X4 POST
SEE FLOOR FRAMING PLANS AT 1/2 BATH WALL

ROOF TRUSS LOADING TYPES "A,B,D,F,G,H,J"
TCLL = 42 PSF TCDL = 10 PSF BCLL = 0 PSF BCDL = 10 PSF
MAXIMUM ALLOWABLE LIVE LOAD DEFLECTION = L/360 GABLE TRUSSES (*G) TO BE DESIGNED FOR LATERAL WIND LOADING, TYPICAL.


ROOF TRUSS LOADING TYPES "E,K,L"
TCLL = 110 PSF TCDL = 10 PSF BCLL = 0 PSF BCDL = 10 PSF
MAXIMUM ALLOWABLE LIVE LOAD DEFLECTION = L/360 GABLE TRUSSES (*G) TO BE DESIGNED FOR LATERAL WIND LOADING, TYPICAL.

FLOOR TRUSS LOADING TYPICAL U.O.N.
TCLL = 40 PSF TCDL = 10 PSF BCLL = 0 PSF BCDL = 5 PSF
MAXIMUM ALLOWABLE LIVE LOAD DEFLECTION = L/480


SHEAR WALL NOTES
AT ALL SEHAR WALLS (TYPE A,B,C,D - SEE A6.1)
PROVIDE SOLID 2X BLOCKING AT ALL PANEL EDGES
AND FASTEN GWB WITH SCREWS AT 4" C/C AT EDGES
AND INTERMEDIATE.

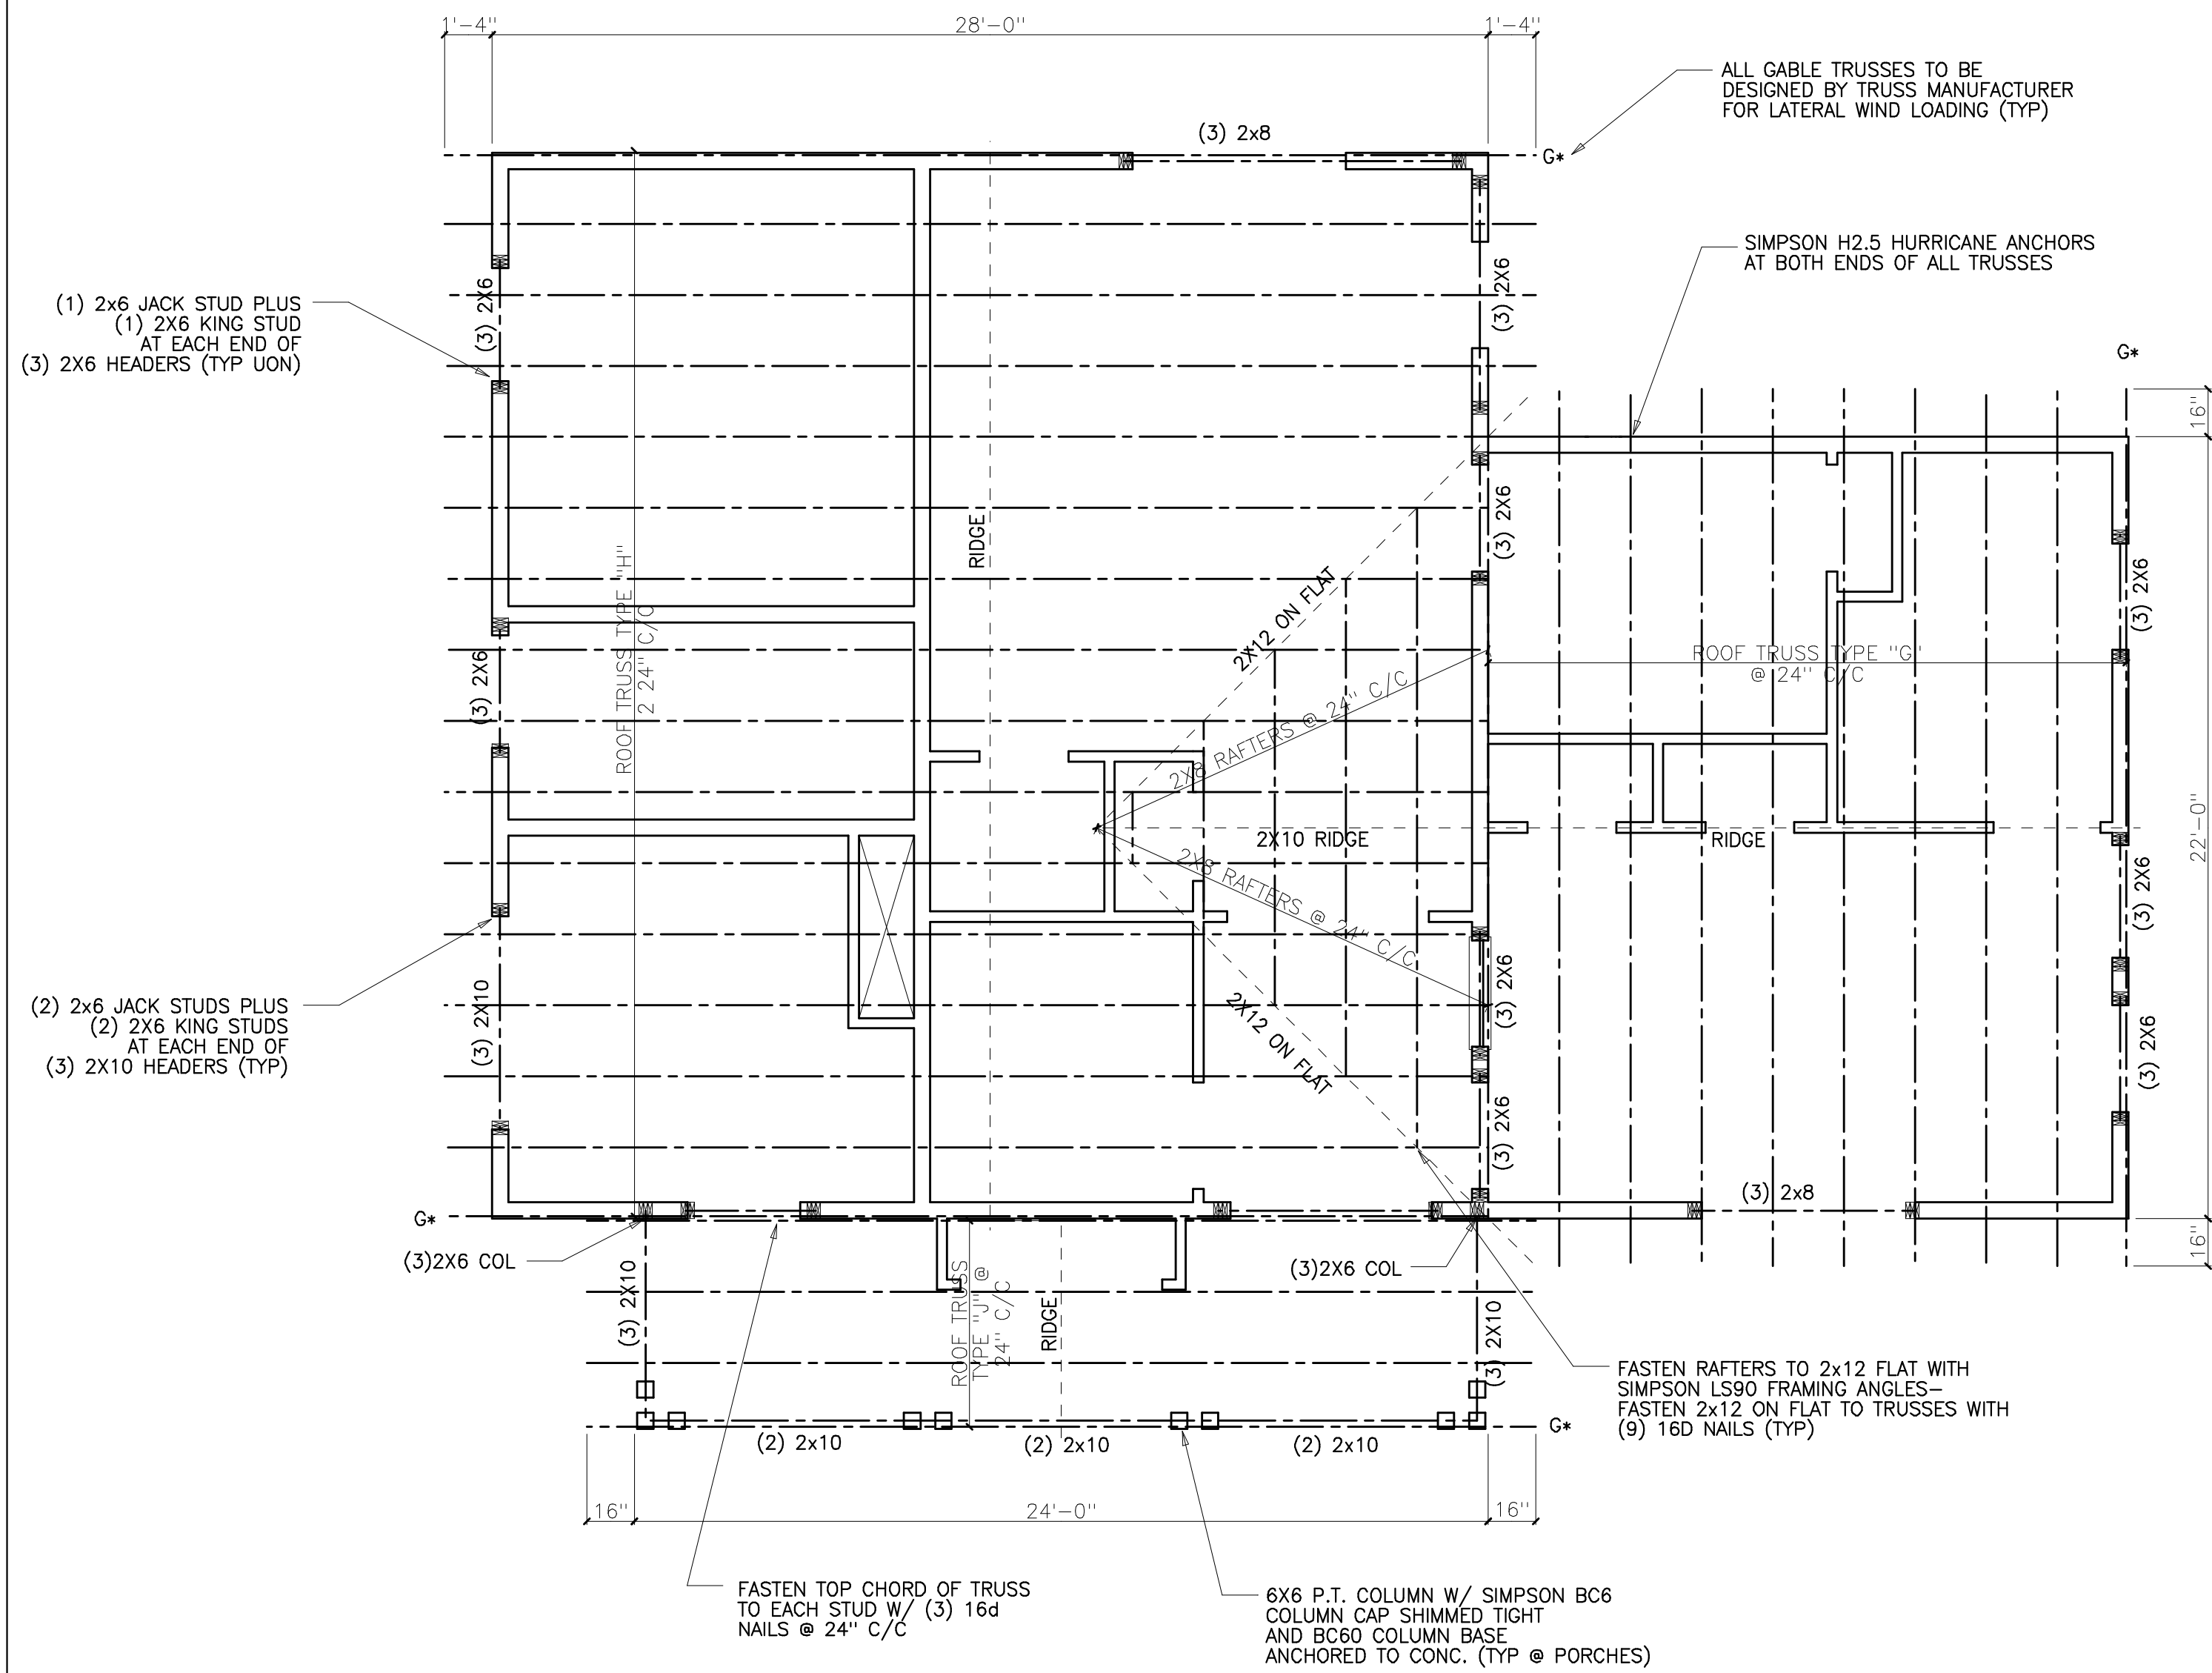

B COMMUNITY BUILDING ROOF FRAMING
SCALE: 1/4"=1'-0"

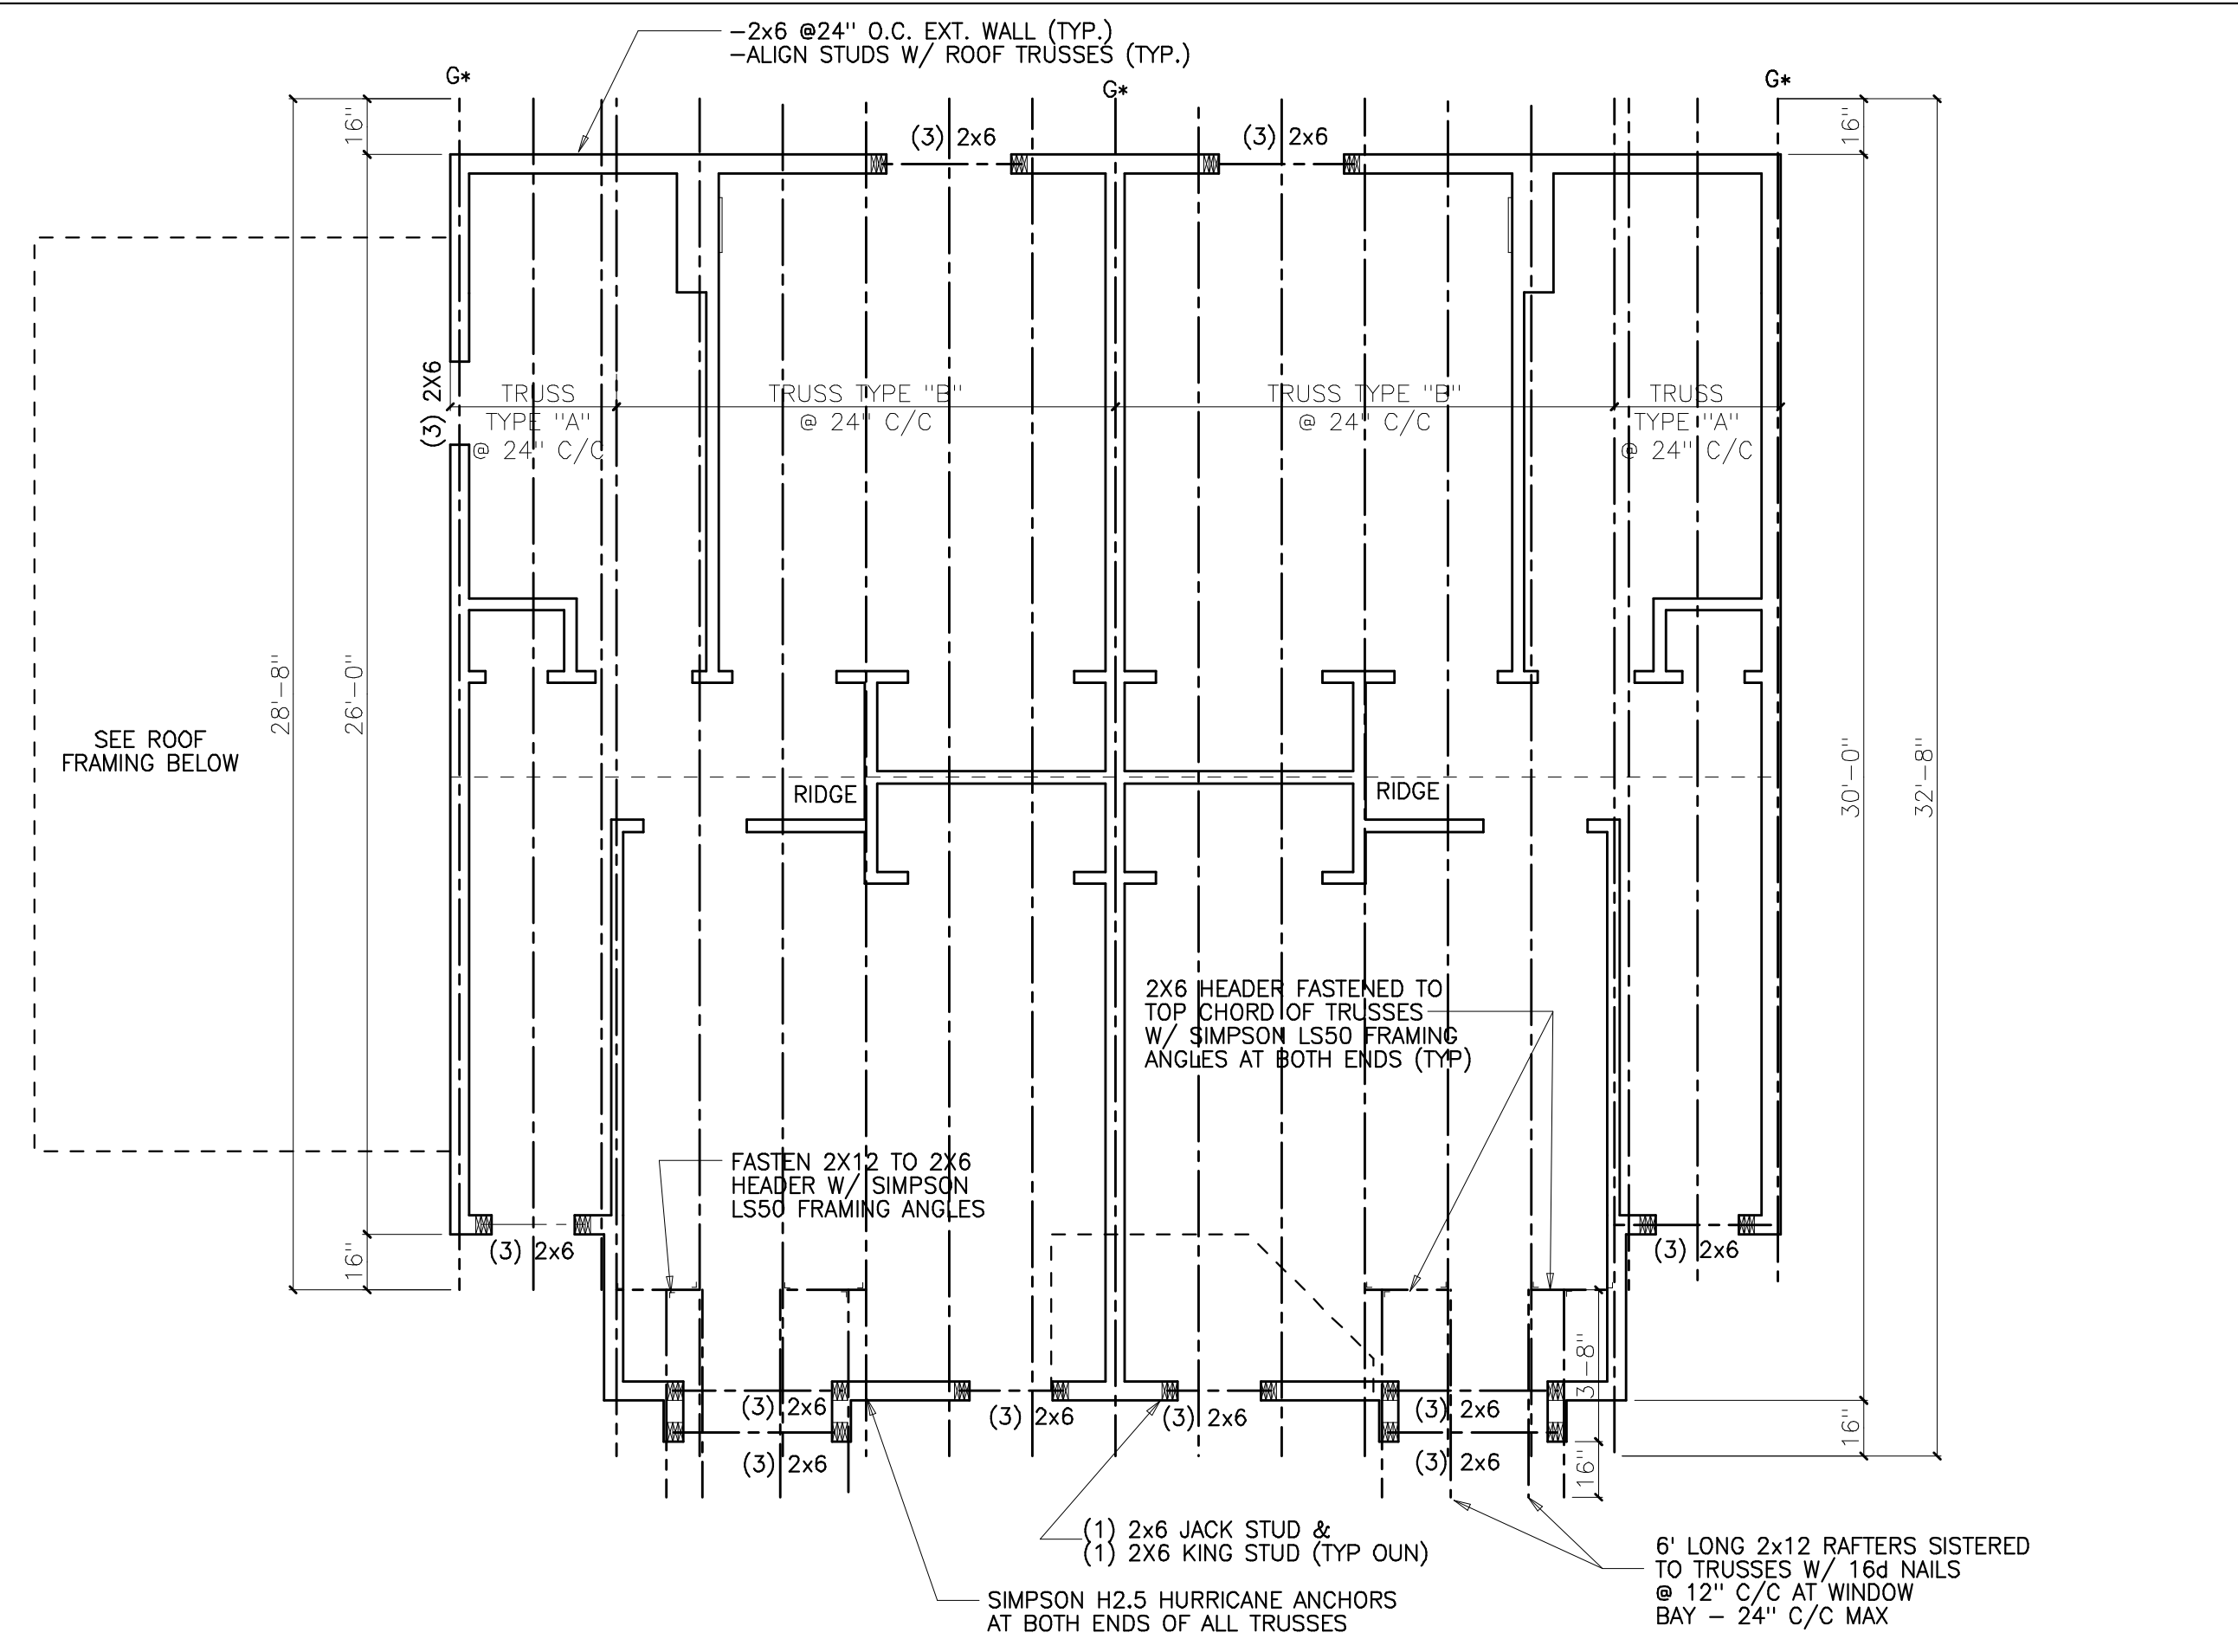

A 3BR HC TOWNHOUSE ROOF FRAMING
SCALE: 1/4"=1'-0"

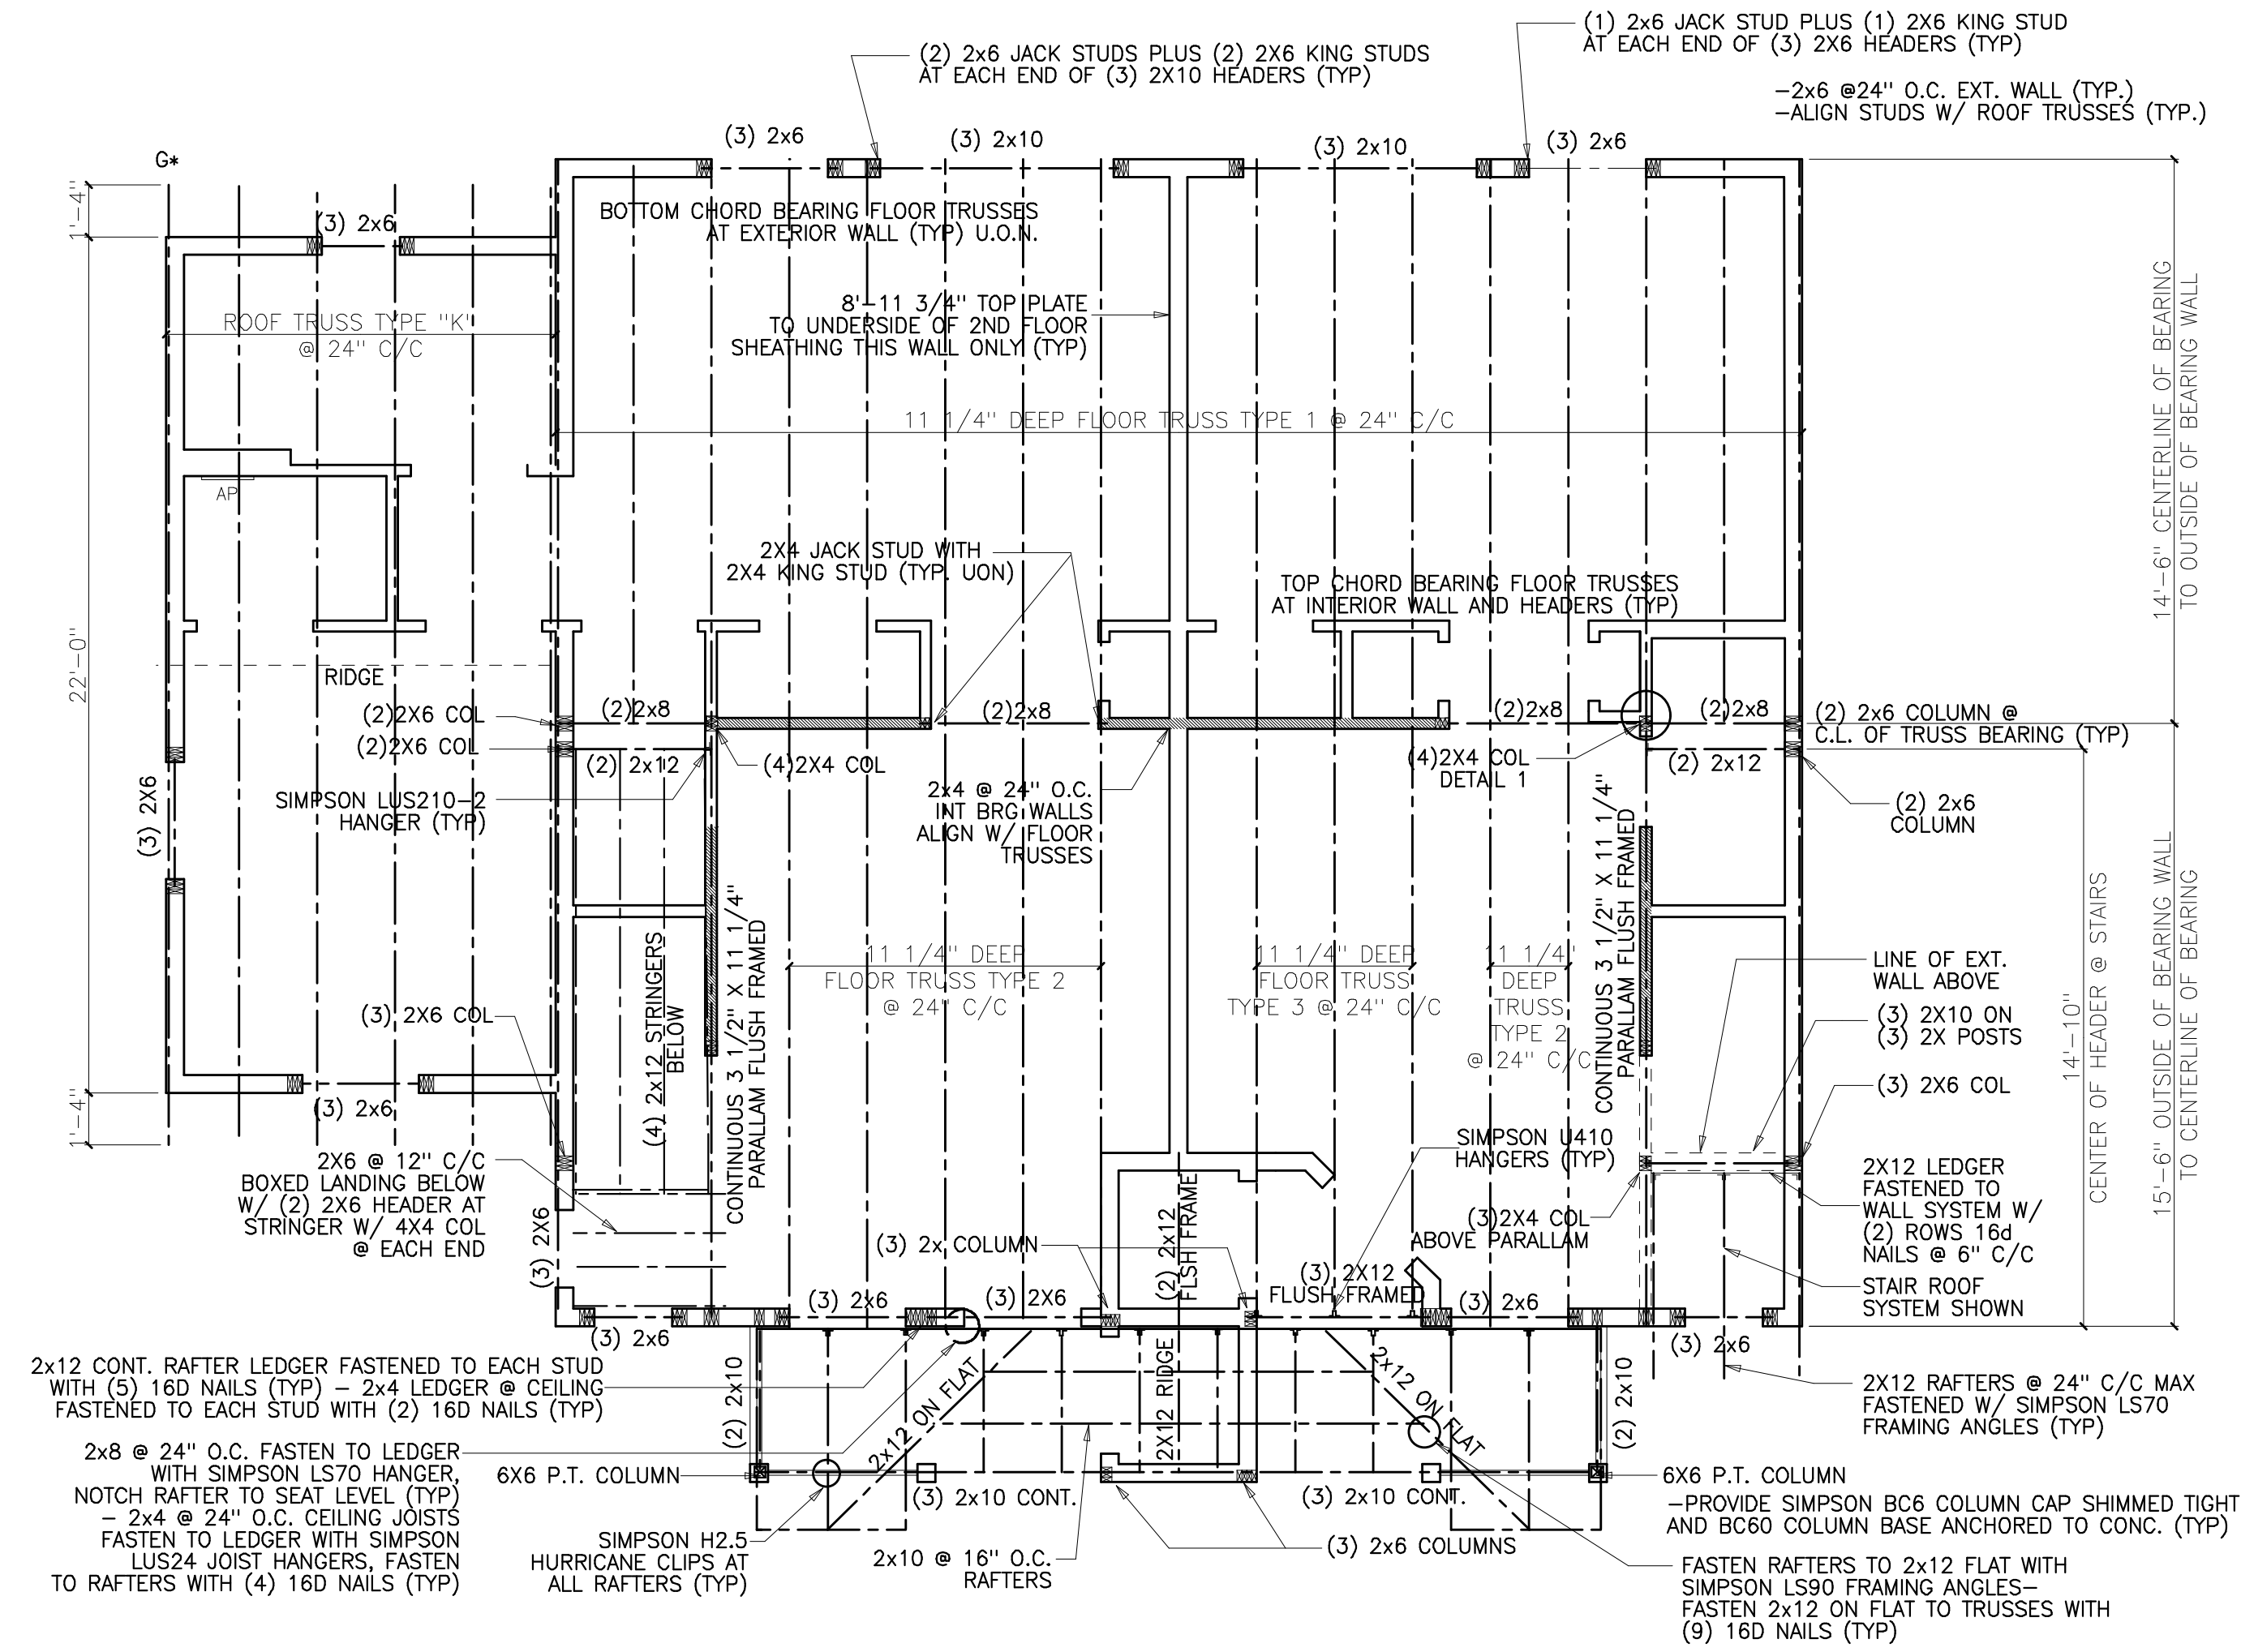

C 3BR HC TOWNHOUSE FLOOR FRAMING PLAN
SCALE: 1/4"=1'-0"

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Portland, ME

Contractor:

YALE COURT APARTMENTS

YALE COURT
PORTLAND, MAINE

Project No: 02.405.YSA

Drawing Title:
ROOF FRAMING PLANS

Scale: 1/4"=1'-0"
Date: PROGRESS 01/25/03
Revisions:

Drawing Number:

S1.3