

Prepared For:

Owner:
Home For The Aged
777 Stevens Avenue
Portland, Maine 04103
Tel.: 207-797-7710

Applicant:
The Park Danforth
777 Stevens Avenue
Portland, Maine 04103
Tel.: 207-797-7710

Prepared By:

MITCHELL & ASSOCIATES
Landscape Architects
The Staples School
70 Center Street

70 Center Street
Portland, Maine 04101
Tel.: 207-774-4427

ortland, Maine

Dantorth

a

Date:
OCTOBER 17, 2014

Issued For:
CONSTRUCTION

Revisions: NOV. 25, 2014: Per City of Portland Staff Review Comments JAN. 5, 2015: Per City of Portland

Staff Review Comments
APR. 10, 2015: Amended Site Plan
and Subdivision Plan
OCT. 16, 2015: 100% Construction
Documents

SEPT. 23, 2016: Added Layout Information DEC. 16, 2016: Added CMP Easement

Reproduction or reuse of this document

without the expressed written consent of Mitchell & Associates is prohibited.

© 2015

Title:

SUBDIVISION PLAT

Scale: 1"=30"

0 10 20 30 60 II.

North: Sheet No.:

North:

Sheet No.:

1 of

777 Stevens Avenue, Portland, Maine

April 10, 2015: Amended Site Plan and Subdivision Plan



PREPARED BY:

LANDSCAPE ARCHITECT AND SITE PLANNER:

MITCHELL & ASSOCIATES 70 CENTER STREET PORTLAND, MAINE 04101 PHONE: 207.774.4427 FAX: 207.874.2460 CONTACT: ROBERT METCALF E-MAIL: RMETCALF@MITCHELLASSOCIATES.BIZ

ARCHITECT:

LAVALLEE | BRENSINGER ARCHITECTS 155 DOW STREET, SUITE 400 MANCHESTER, NH 03101 PHONE: 603.622.5450 CONTACT: JOAN EAGLESON EMAIL: JOAN.EAGLESON@LBPA.COM

CIVIL ENGINEER:

BH2M ENGINEERS 28 STATE STREET GORHAM, MAINE 04038 PHONE: 207.839.2771 CONTACT: LES BERRY P.E. E-MAIL: LBERRY@BH2M.COM

LAND SURVEYOR

OWEN HASKELL 390 U.S. ROUTE ONE, SUITE 10 FALMOUTH, MAINE 04105 PHONE: 207.774.0424 CONTACT: JOHN SWAN, P.L.S.

GEOTECHNICAL ENGINEER

S. W. COLE ENGINEERING, INC. 286 PORTLAND ROAD GRAY, MAINE 04039 207.657.2866

SOIL SCIENTEST

ALBERT FRICK ASSOCIATES, INC. 95A COUNTY ROAD GORHAM, MAINE 04038 PHONE: 207.839.5563 CONTACT: ALBERT FRICK

TRAFFIC ENGINEER

GORRILL-PALMER CONSULTING ENGINEERS, INC. 15 SHAKER ROAD GORHAM, MAINE 04038 PHONE: 207.675.6910 CONTACT: TIMOTHY BOYCE, P.E. CONTACT: RANDALL DUNTON, P.E.

UTILITIES:

CENTRAL MAINE POWER **ELECTRICAL DISTRIBUTION ENGINEERING** 162 CANCO ROAD PORTLAND, MAINE 04103 PHONE: 207.842.2367 CONTACT: JAMIE COUGH E-MAIL: JAMES.COUGH@CMPCO.COM

TELEPHONE:

FAIRPOINT COMMUNICATIONS 45 FOREST AVENUE PORTLAND, MAINE 04101 PHONE: 866.984.2001

WATER:

PORTLAND WATER DISTRICT 225 DOUGLASS STREET P.O. BOX 3553 PORTLAND, MAINE 04104-3553 PHONE: 207.774.5961 x.3199 FAX: 207.761.8307 CONTACT: RICO SPUGNARDI, P.E. E-MAIL: RSPUGNARGI@PWD.ORG

SANITARY SEWER:

CITY OF PORTLAND PUBLIC SERVICES DEPARTMENT 55 PORTLAND STREET PORTLAND, MAINE 04101 PHONE: 207.874.8832 FAX: 207.874.8816 CONTACT: FRANK BRANCELY E-MAIL: FJB@PORTLANDMAINE.GOV

TIME WARNER CABLE OF MAINE 118 JOHNSON ROAD PORTLAND, MAINE 04102 PHONE: 207.253.2324 CONTACT: MARK PELLETIER, CONSTRUCTION PROJECT COORDINATOR E-MAIL: MARK.PELLETIER@TWCABLE.COM

NATURAL GAS:

UNITIL SERVICE CORPORATION 1075 FOREST AVENUE PORTLAND, MAINE 04103 PHONE: 207.541.2505 CONTACT: SCOTT CARPENTER

OWNER

HOME FOR THE AGED 777 STEVENS AVENUE PORTLAND, MAINE 04103 PHONE: 207.797.7710

APPLICANT

THE PARK DANFORTH 777 STEVENS AVENUE PORTLAND, MAINE 04103 PHONE: 207.797.7710

PERMITS:

TYPE OF PERMIT:

SITE PLAN REVIEW:

GOVERNING BODY:

CITY OF PORTLAND 389 CONGRESS STREET 4TH FLOOR PORTLAND, MAINE 04101 TEL: 207.874.8728 CONTACT: BARBARA BARHYDT E-MAIL: BAB@PORTLANDMAINE.GOV

STATUS:

SUBMITTED: OCTOBER 17, 2014

SHEET INDEX: SHEET COVER PAGE BOUNDARY AND TOPOGRAPHIC SURVEY SUBDIVISION PLAT EXISTING CONDITIONS PLAN L1.1 CONSTRUCTION MANAGEMENT PLAN L2.0 LAYOUT PLAN DETAIL PLANS: RAMPS AND CROSSWALKS L2.1 L3.0 GRADING AND DRAINAGE PLAN GRADING PLAN -- GARAGE LEVEL L3.1 L3.2 EROSION AND SEDIMENT CONTROL PLAN 1_4.0 UTILITIES PLAN L5.0 PLANTING PLAN L6.0 SITE DETAILS L6.1 SITE DETAILS L6.2 SITE DETAILS L6.3 SITE DETAILS L6.4 SITE DETAILS L7.0 LIGHTING PHOTOMETRICS PLAN PRE DEVELOPMENT WATERSHED MAP POST DEVELOPMENT WATERSHED PLAN STORMWATER TREATMENT PLAN PROPOSED GARAGE LEVEL PROPOSED LEVEL ONE PROPOSED LEVEL TWO PROPOSED LEVEL THREE PROPOSED LEVEL FOUR PROPOSED LEVEL FIVE


SITE LOCATION MAP:

PROPOSED EXTERIOR ELEVATIONS

PROPOSED EXTERIOR ELEVATIONS


PROPOSED CONNECTOR AND AUDITORIUM


PROPOSED RENOVATIONS -- MAIN STREET

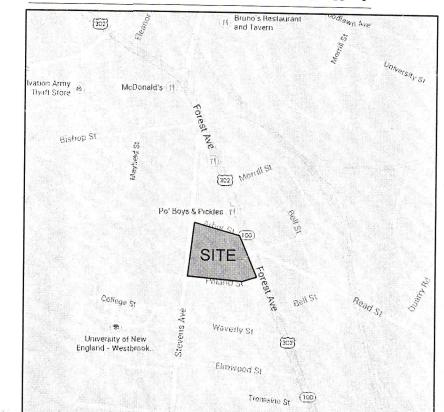



Subject to Dept. Condition

Date of Approval:_____

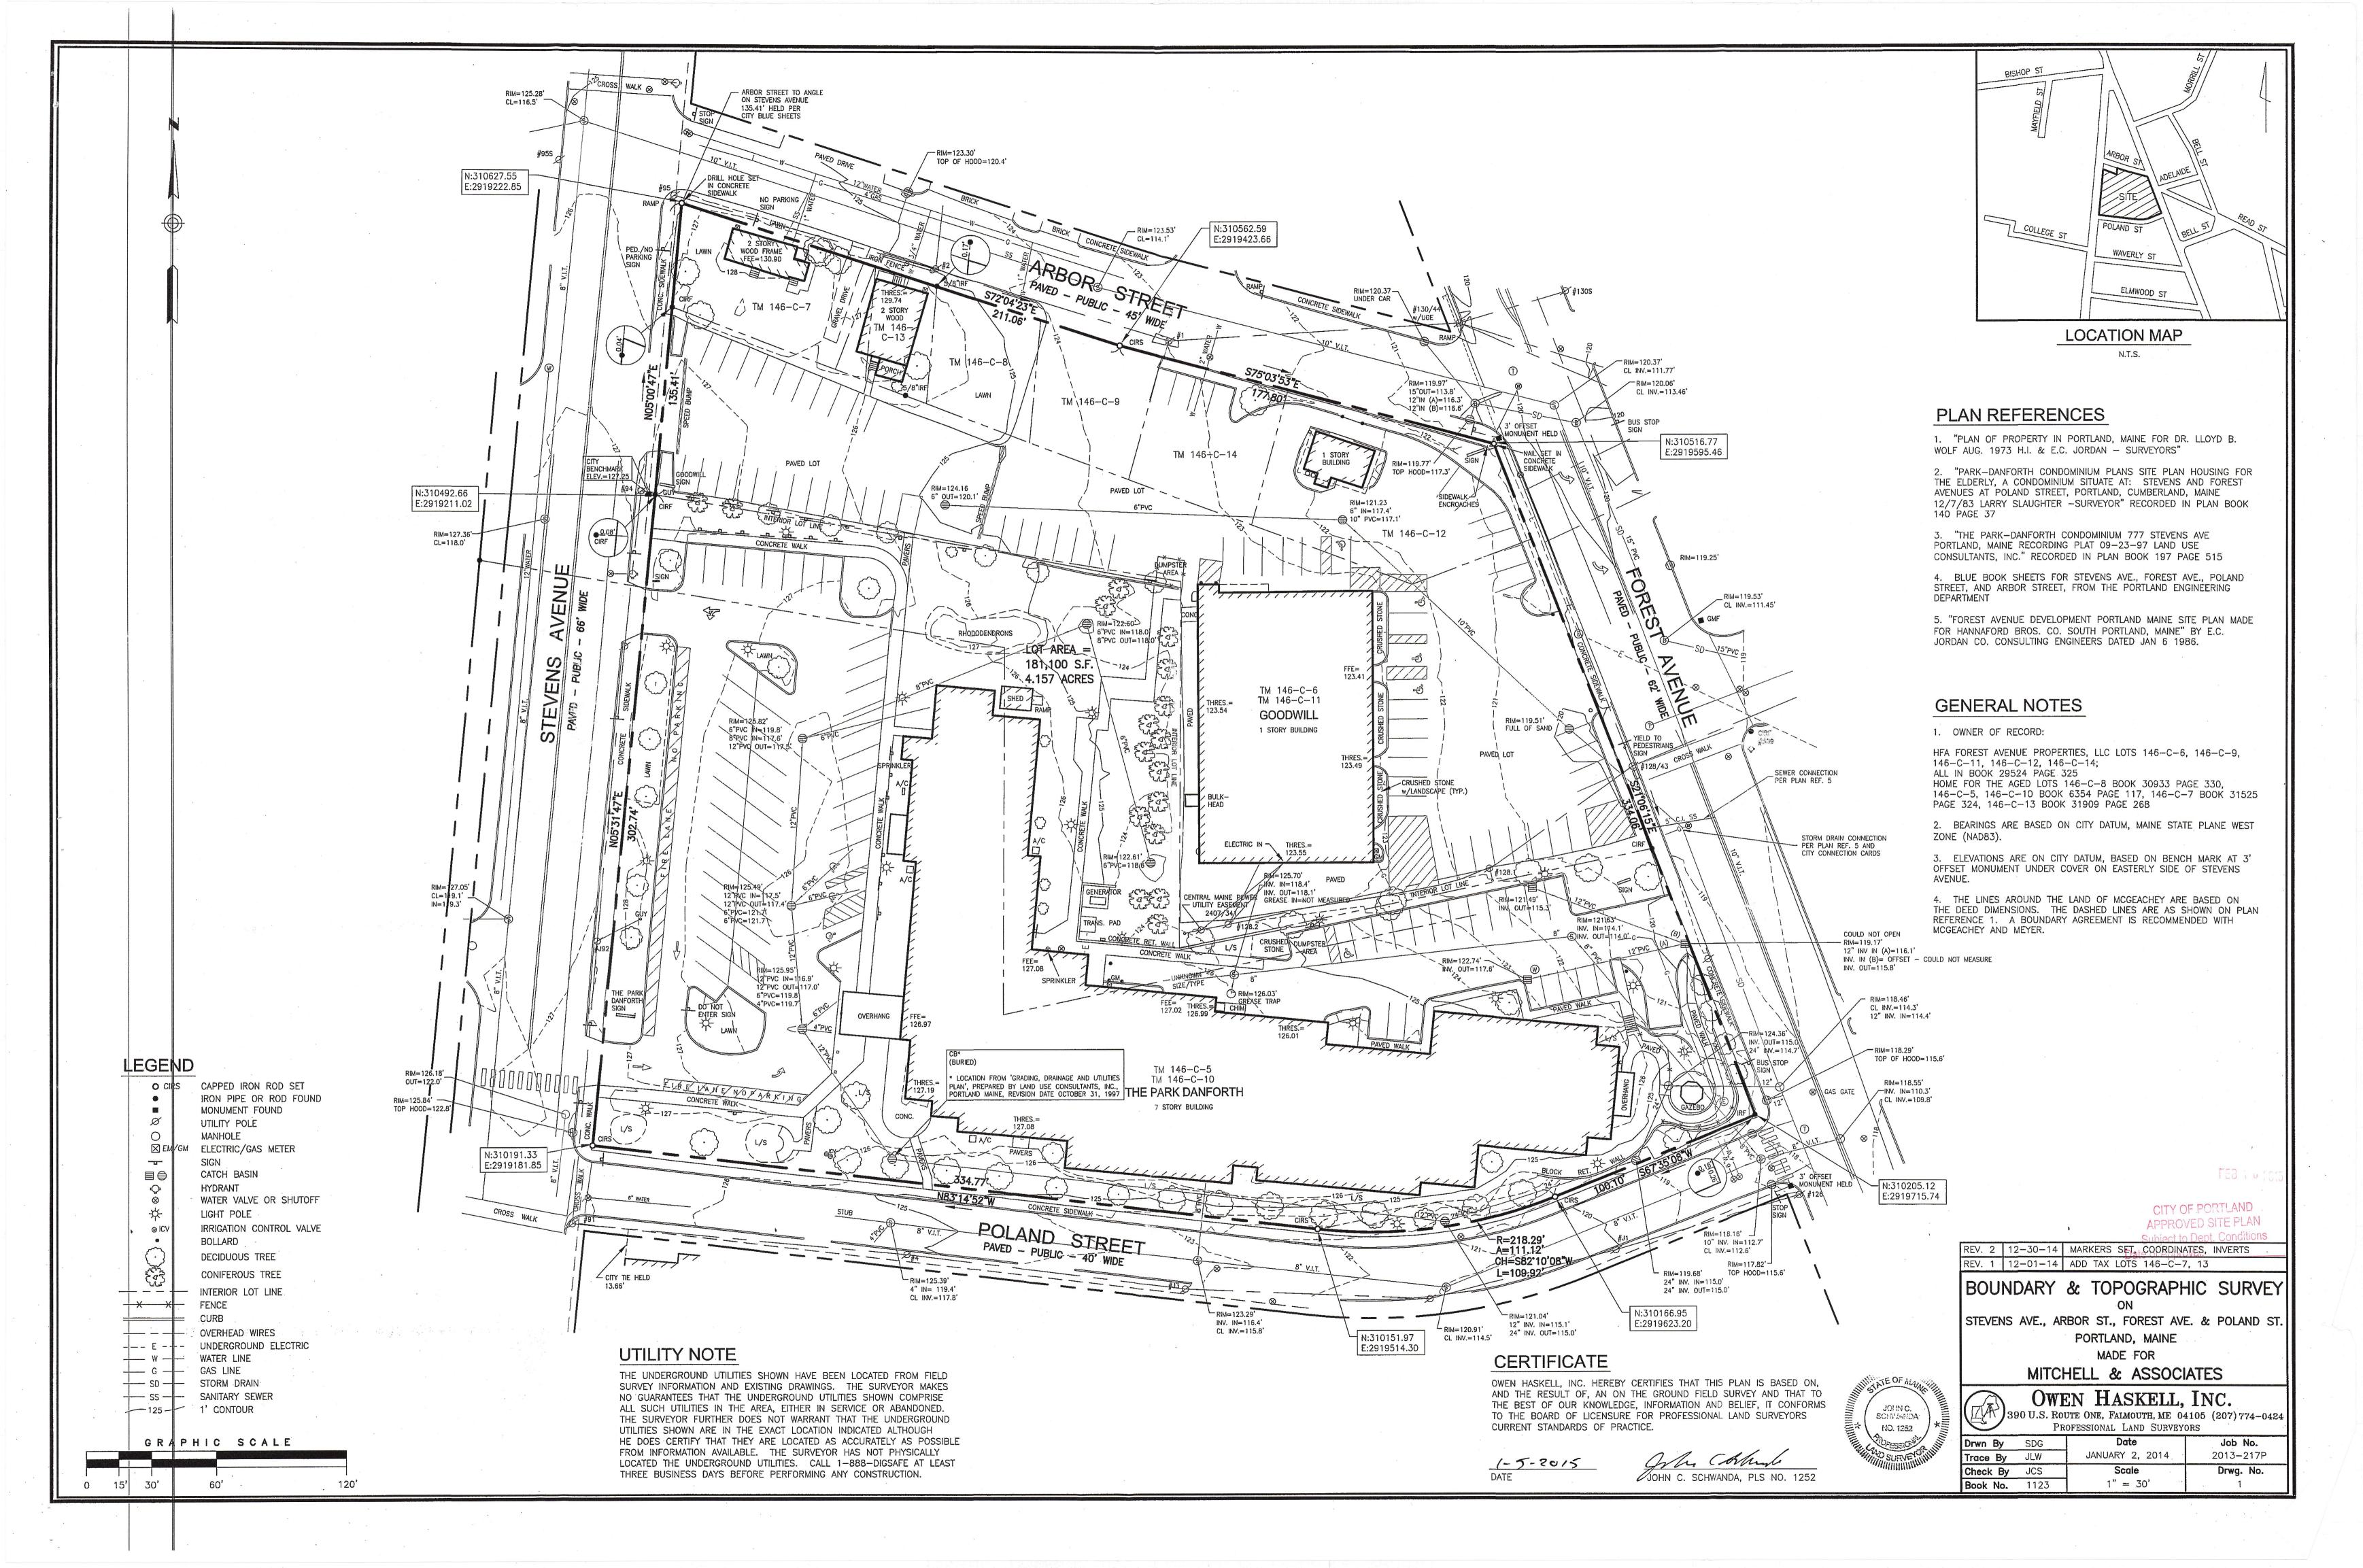

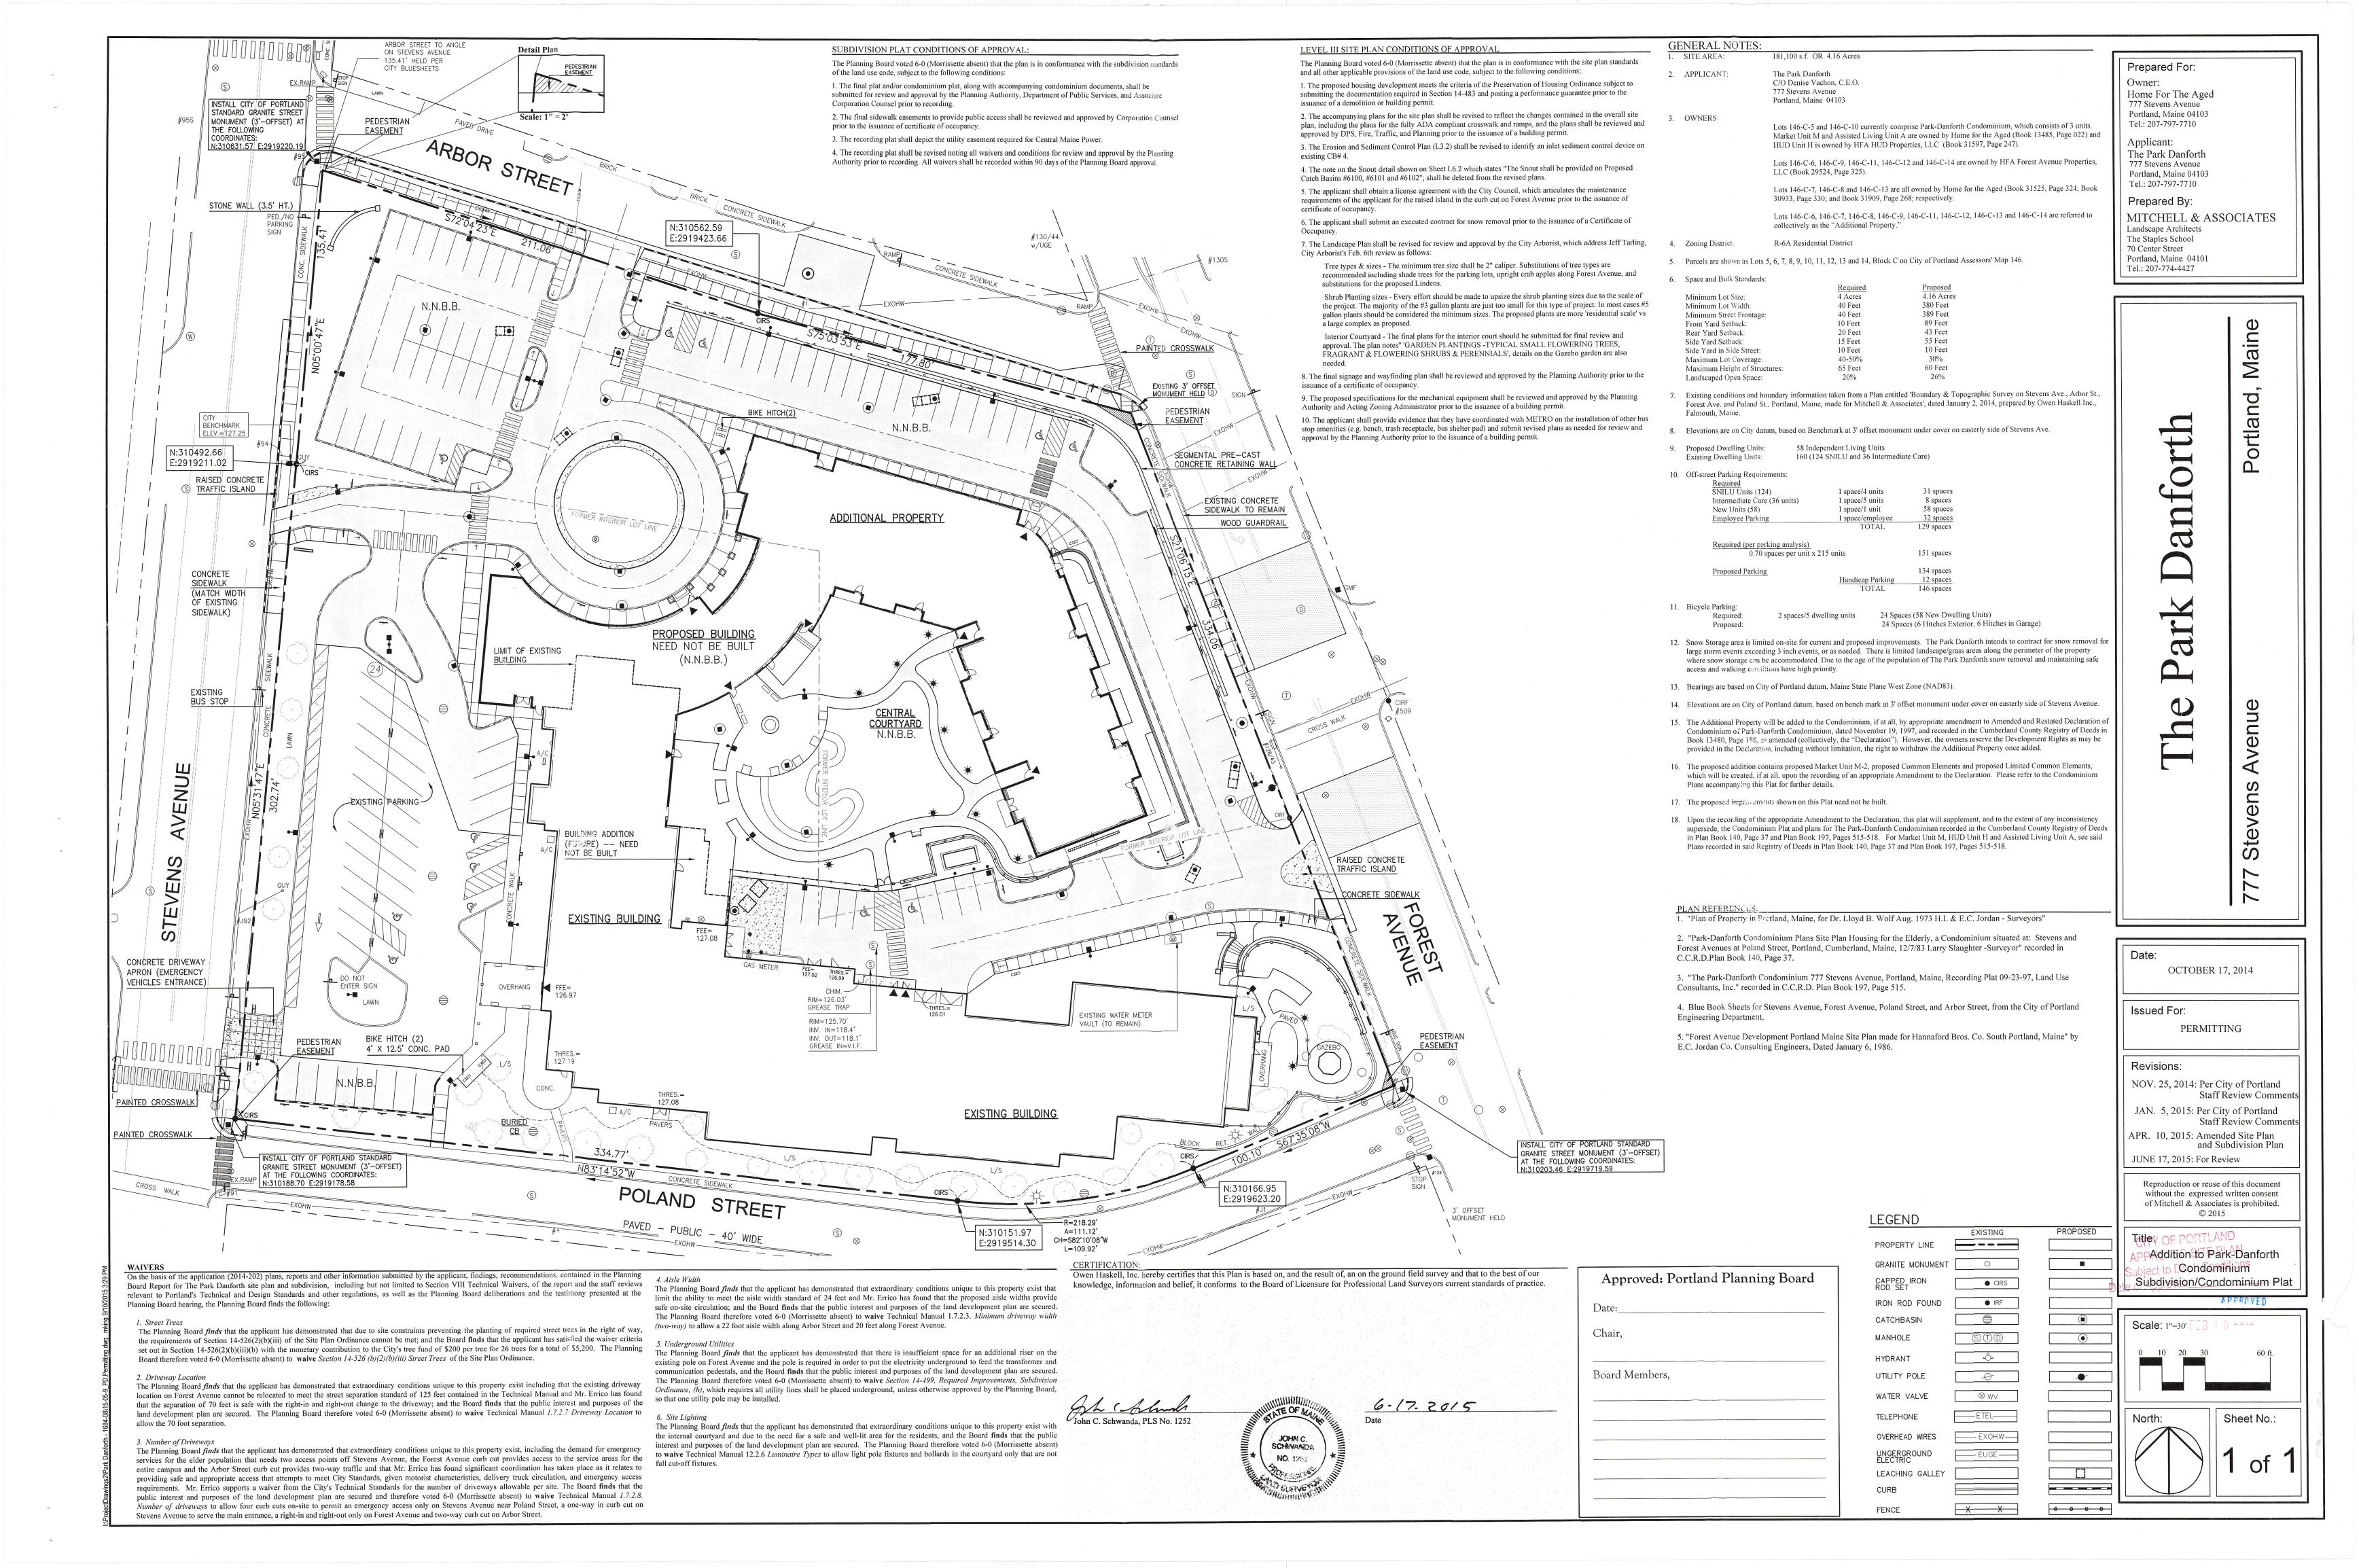

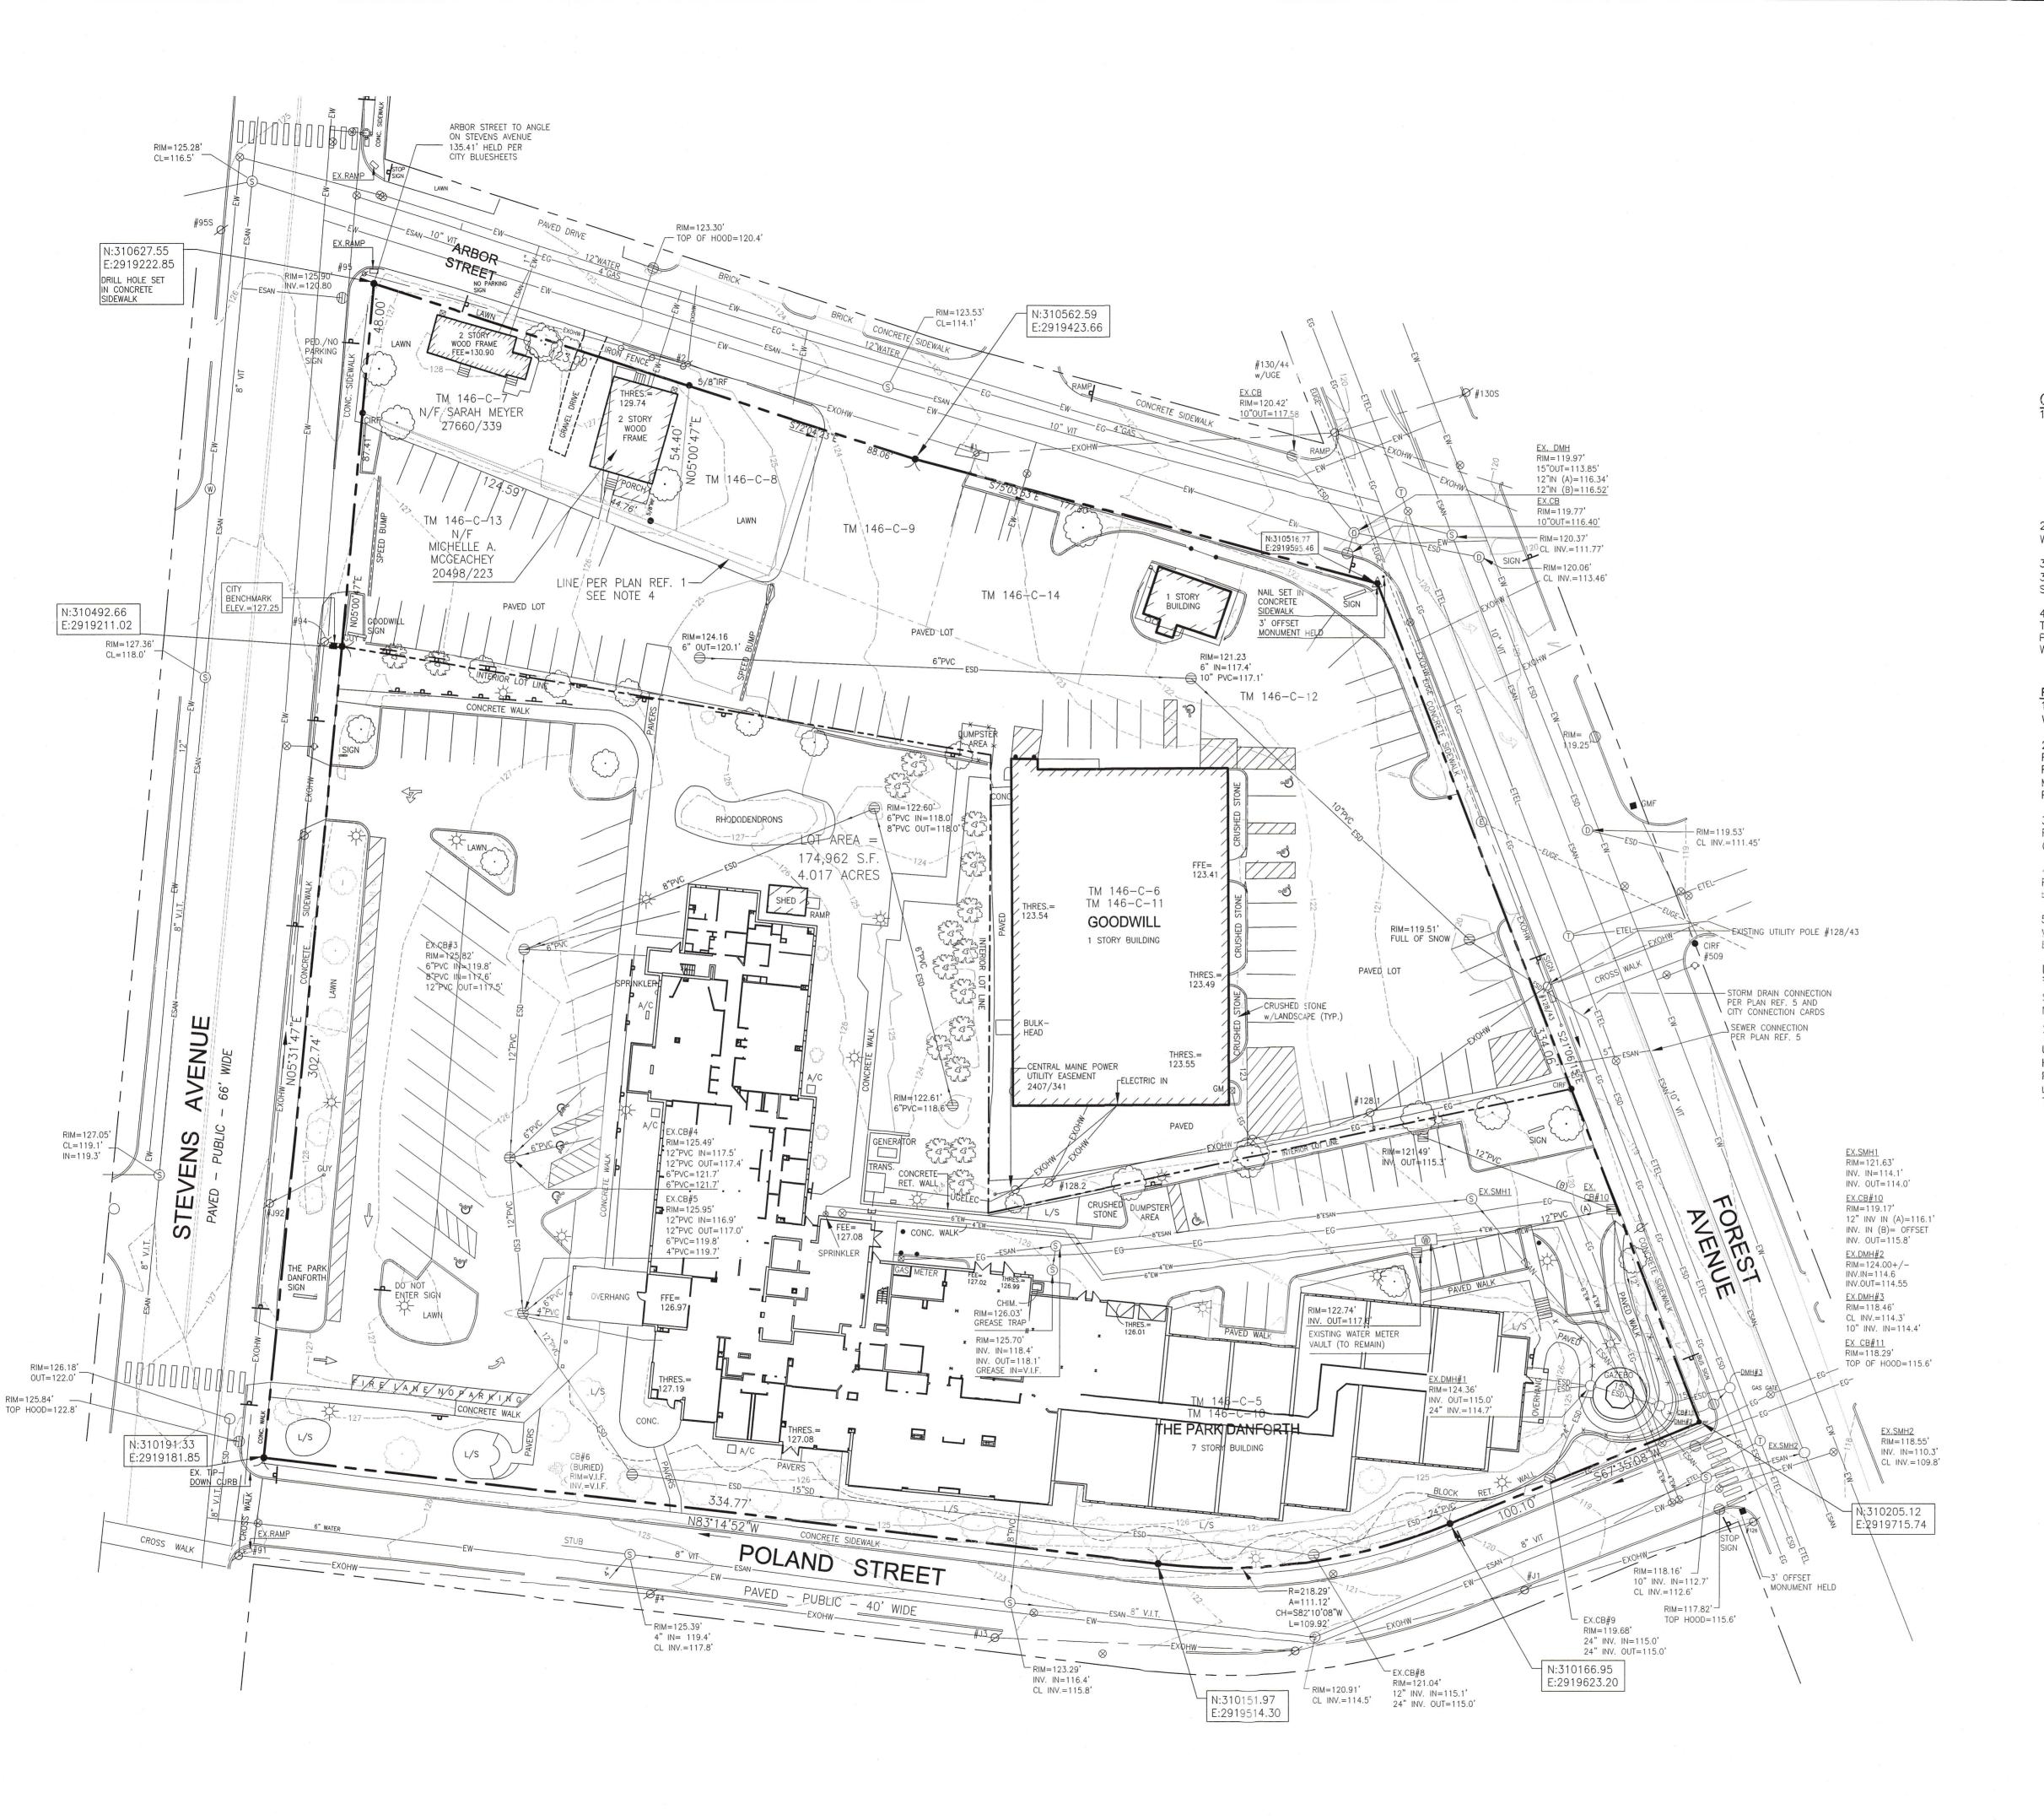

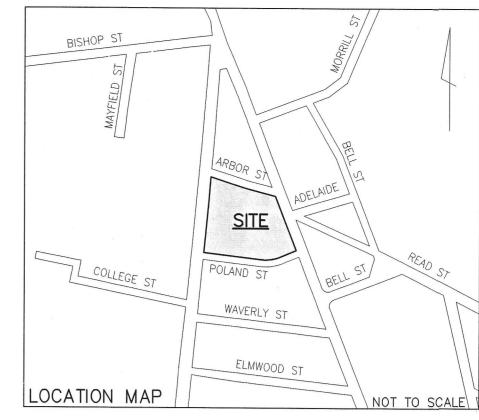

GENERAL NOTES

146-C-9, 146-C-11, 146-C-12, 146-C-14 (ALL IN BOOK

HOME FOR THE AGED LOTS 146-C-8 BOOK 30933 PAGE 330, 146-C-5, 146-C-10 BOOK 6354 PAGE 117.

- 2. BEARINGS ARE BASED ON CITY DATUM, MAINE STATE PLANE
- 3. ELEVATIONS ARE ON CITY DATUM, BASED ON BENCH MARK AT 3' OFFSET MONUMENT UNDER COVER ON EASTERLY SIDE OF STEVENS AVENUE.
- THE DEED DIMENSIONS. THE DASHED LINES ARE AS SHOWN ON PLAN REFERENCE 1. A BOUNDARY AGREEMENT IS RECOMMENDED WITH MCGEACHEY AND MEYER.

PLAN REFERENCES

1. "PLAN OF PROPERTY IN PORTLAND, MAINE FOR DR. LLOYD B.

- 2. "PARK-DANFORTH CONDOMINIUM PLANS SITE PLAN HOUSING FOR THE ELDERLY, A CONDOMINIUM SITUATE AT: STEVENS AND FOREST AVENUES AT POLAND STREET, PORTLAND, CUMBERLAND, MAINE 12/7/83 LARRY SLAUGHTER -SURVEYOR" RECORDED IN
- 3. "THE PARK-DANFORTH CONDOMINIUM 777 STEVENS AVE PORTLAND, MAINE RECORDING PLAT 09-23-97 LAND USE

THE UNDERGROUND UTILITIES SHOWN HAVE BEEN LOCATED FROM FIELD SURVEY INFORMATION AND EXISTING DRAWINGS. THE SURVEYOR MAKES NO GUARANTEES THAT THE UNDERGROUND UTILITIES SHOWN COMPRISE ALL SUCH UTILITIES IN THE AREA, EITHER IN SERVICE OR ABANDONED. THE SURVEYOR FURTHER DOES NOT WARRANT THAT THE UNDERGROUND UTILITIES SHOWN ARE IN THE EXACT LOCATION INDICATED ALTHOUGH HE DOES CERTIFY THAT THEY ARE LOCATED AS ACCURATELY AS POSSIBLE FROM INFORMATION AVAILABLE. THE SURVEYOR HAS NOT PHYSICALLY LOCATED THE UNDERGROUND UTILITIES. CALL 1-888-DIGSAFE AT LEAST THREE BUSINESS DAYS BEFORE PERFORMING ANY CONSTRUCTION.

HFA FOREST AVENUE PROPERTIES, LLC LOTS 146-C-6. 29524 PAGE 325)

- WEST ZONE (NAD83).
- 4. THE LINES AROUND THE LAND OF MCGEACHEY ARE BASED ON

WOLF AUG. 1973 H.I. & E.C. JORDAN - SURVEYORS"

- PLAN BOOK 140 PAGE 37
- CONSULTANTS, INC." RECORDED IN PLAN BOOK 197 PAGE 515
- 4. BLUE BOOK SHEETS FOR STEVENS AVE., FOREST AVE., POLAND STREET, AND ARBOR STREET, FROM THE PORTLAND ENGINEERING DEPARTMENT
- 5. "FOREST AVENUE DEVELOPMENT PORTLAND MAINE SITE PLAN MADE FOR HANNAFORD BROS. CO. SOUTH PORTLAND, MAINE" BY E.C. JORDAN CO. CONSULTING ENGINEERS DATED JAN 6 1986.

EGEND	
PROPERTY LINE	
GRANITE MONUMENT	
CATCHBASIN	
MANHOLE	① S D
HYDRANT	\$
JTILITY POLE	0
WATER VALVE	\otimes W \vee
SANITARY SEWER	—— ESAN——
STORM DRAIN	ESD
WATER	EW
relephone	ETEL-
GAS	EG
OVERHEAD WIRES	EOHW
CMP CABLE LINES	EUGE—
CURB	
FENCE	X, X
SIGN	-
TREE	(*)
CONTOUR	72

LIGHT FIXTURE

Issued For: **PERMITTING** Revisions: NOV. 25, 2014: Per City of Portland Staff Review Comments JAN. 5, 2015: Per City of Portland Staff Review Comments APR. 10, 2015: Amended Site Plan and Subdivision Plan Reproduction or reuse of this document without the expressed written consent

OCTOBER 17, 2014

Date:

Prepared For:

Applicant:

The Park Danforth

777 Stevens Avenue Portland, Maine 04103 Tel.: 207-797-7710

Prepared By:

Landscape Architects

Portland, Maine 04101

The Staples School

Tel.: 207-774-4427

70 Center Street


MITCHELL & ASSOCIATES


Home For The Aged 777 Stevens Avenue Portland, Maine 04103 Tel.: 207-797-7710


Title: **EXISTING** CONDITIONS PLAN CITY OF PORTLA

of Mitchell & Associates is prohibited.

© 2015

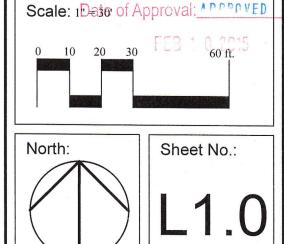

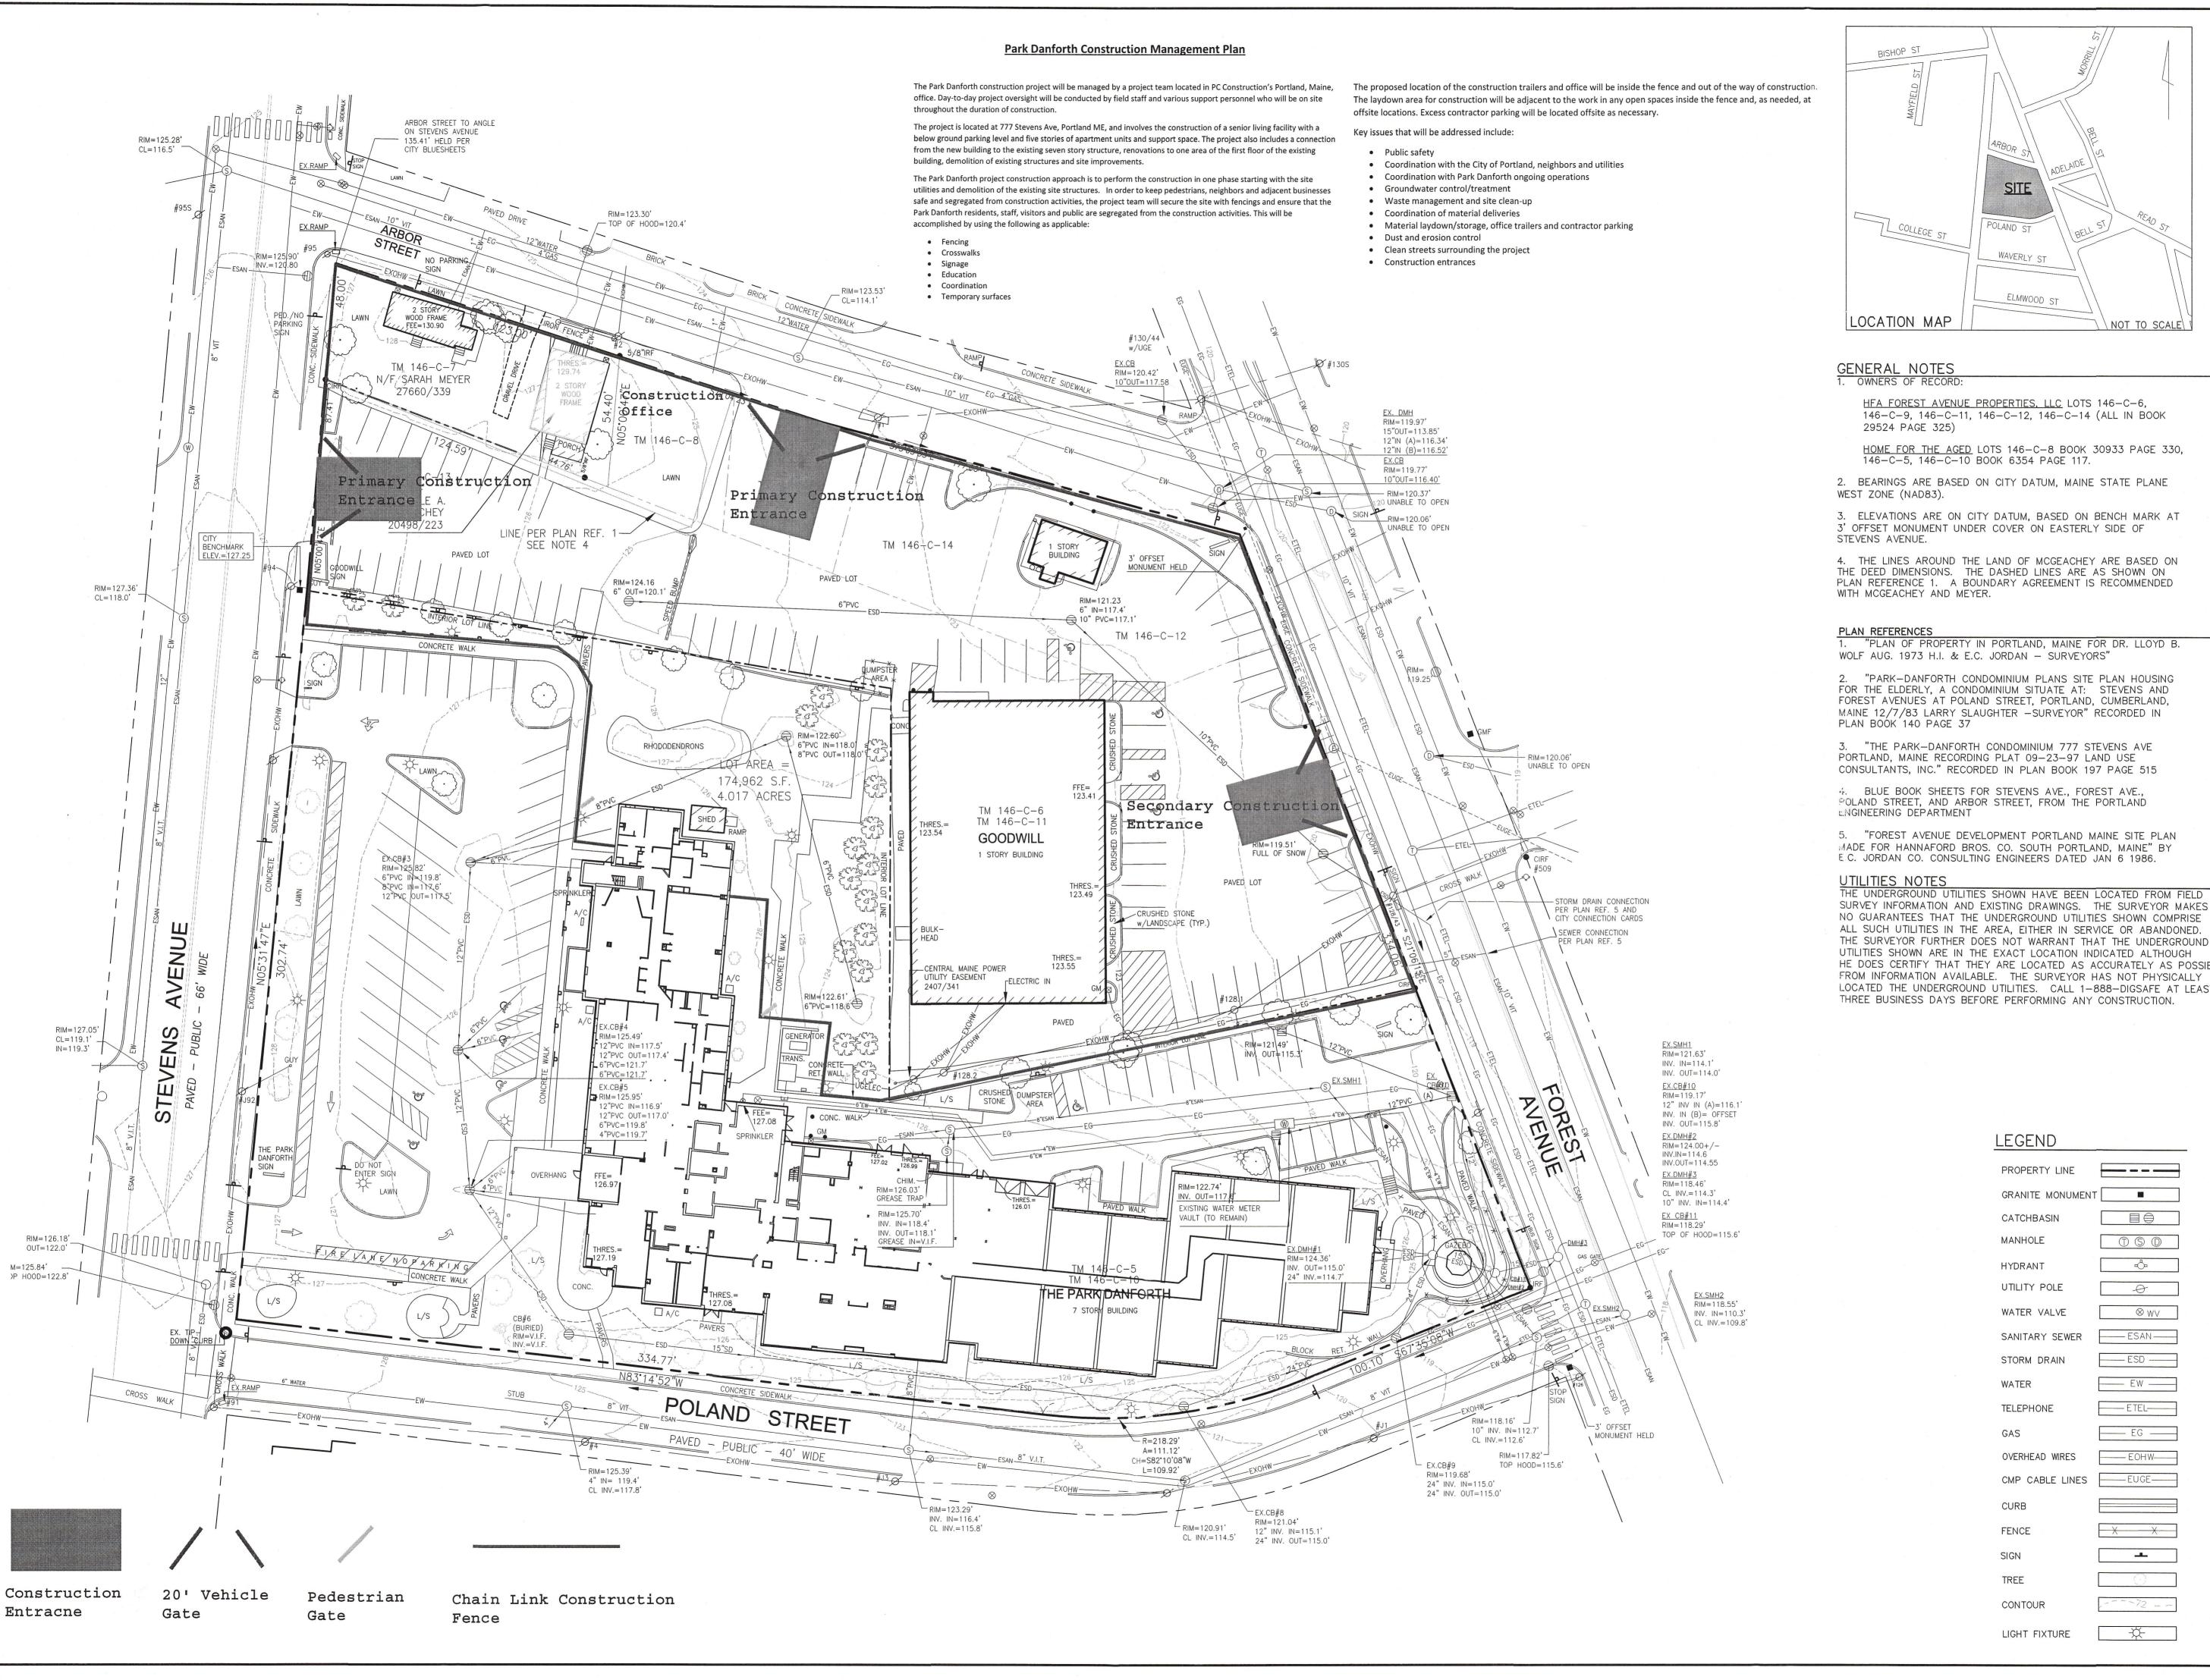

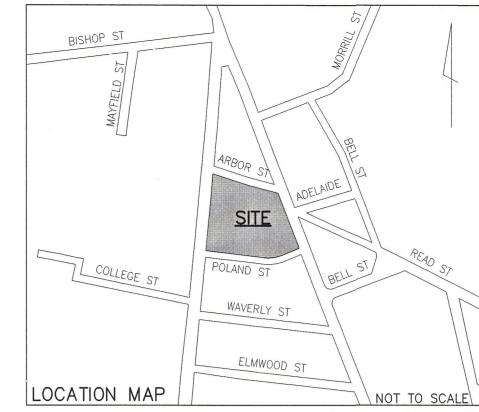

HFA FOREST AVENUE PROPERTIES, LLC LOTS 146-C-6, 146-C-9, 146-C-11, 146-C-12, 146-C-14 (ALL IN BOOK

146-C-5, 146-C-10 BOOK 6354 PAGE 117.

3' OFFSET MONUMENT UNDER COVER ON EASTERLY SIDE OF

THE DEED DIMENSIONS. THE DASHED LINES ARE AS SHOWN ON PLAN REFERENCE 1. A BOUNDARY AGREEMENT IS RECOMMENDED

"PLAN OF PROPERTY IN PORTLAND, MAINE FOR DR. LLOYD B. WOLF AUG. 1973 H.I. & E.C. JORDAN - SURVEYORS"

2. "PARK-DANFORTH CONDOMINIUM PLANS SITE PLAN HOUSING FOR THE ELDERLY, A CONDOMINIUM SITUATE AT: STEVENS AND FOREST AVENUES AT POLAND STREET, PORTLAND, CUMBERLAND, MAINE 12/7/83 LARRY SLAUGHTER -SURVEYOR" RECORDED IN

3. "THE PARK-DANFORTH CONDOMINIUM 777 STEVENS AVE PORTLAND, MAINE RECORDING PLAT 09-23-97 LAND USE CONSULTANTS, INC." RECORDED IN PLAN BOOK 197 PAGE 515

4. BLUE BOOK SHEETS FOR STEVENS AVE., FOREST AVE., POLAND STREET, AND ARBOR STREET, FROM THE PORTLAND

5. "FOREST AVENUE DEVELOPMENT PORTLAND MAINE SITE PLAN MADE FOR HANNAFORD BROS. CO. SOUTH PORTLAND, MAINE" BY

SURVEY INFORMATION AND EXISTING DRAWINGS. THE SURVEYOR MAKES NO GUARANTEES THAT THE UNDERGROUND UTILITIES SHOWN COMPRISE ALL SUCH UTILITIES IN THE AREA, EITHER IN SERVICE OR ABANDONED. THE SURVEYOR FURTHER DOES NOT WARRANT THAT THE UNDERGROUND UTILITIES SHOWN ARE IN THE EXACT LOCATION INDICATED ALTHOUGH HE DOES CERTIFY THAT THEY ARE LOCATED AS ACCURATELY AS POSSIBLE FROM INFORMATION AVAILABLE. THE SURVEYOR HAS NOT PHYSICALLY LOCATED THE UNDERGROUND UTILITIES. CALL 1-888-DIGSAFE AT LEAST THREE BUSINESS DAYS BEFORE PERFORMING ANY CONSTRUCTION.

① S D

-0-

0

 \otimes W \vee

---- ESAN -----

---- ESD ----

--- EW ----

—— ETEL——

—— EG ——

____ EOHW____

---EUGE---

X

MITCHELL & ASSOCIATES

Prepared For:

Home For The Aged

777 Stevens Avenue Portland, Maine 04103

Tel.: 207-797-7710

The Park Danforth

Portland, Maine 04103

777 Stevens Avenue

Tel.: 207-797-7710

Landscape Architects

Portland, Maine 04101

Tel.: 207-774-4427

The Staples School

70 Center Street

Prepared By:

Applicant:

Owner:


O


Date: OCTOBER 17, 2014 Issued For: **PERMITTING** Revisions: Reproduction or reuse of this document without the expressed written consent of Mitchell & Associates is prohibited. © 2014

Scale: 1"=30" North: Sheet No.:


CONSTRUCTION MANAGEMENT PLAN

Title:

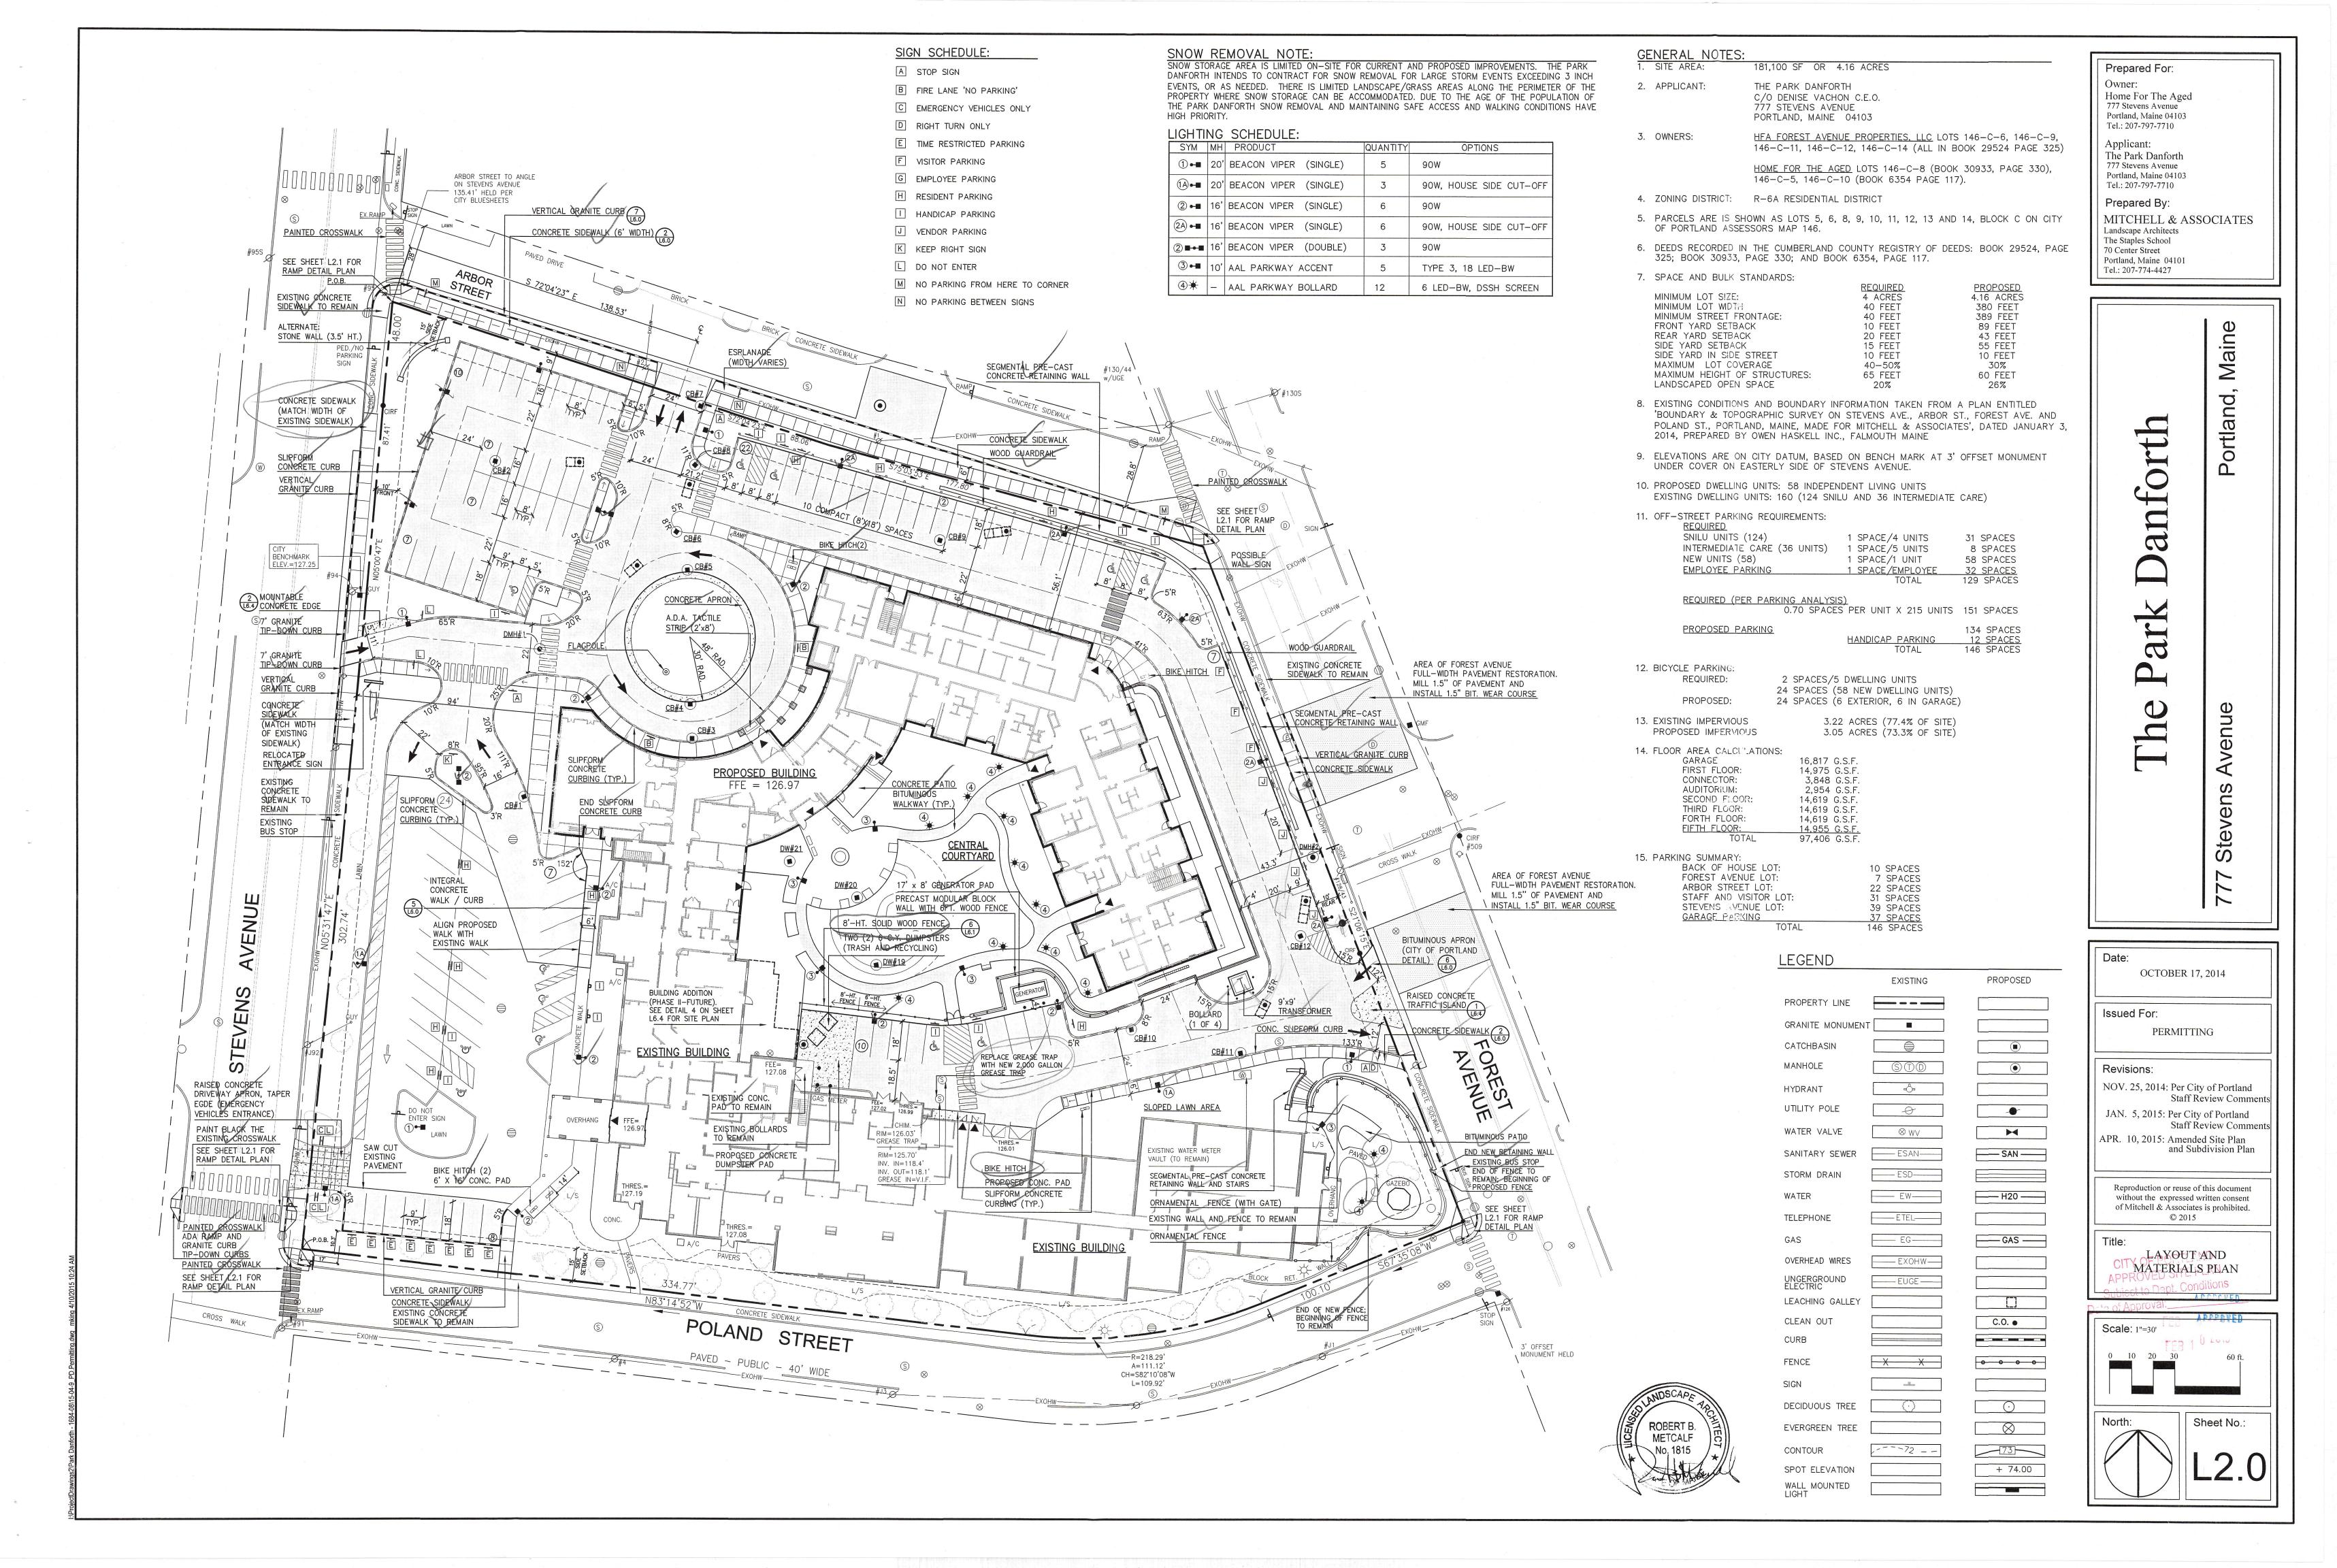


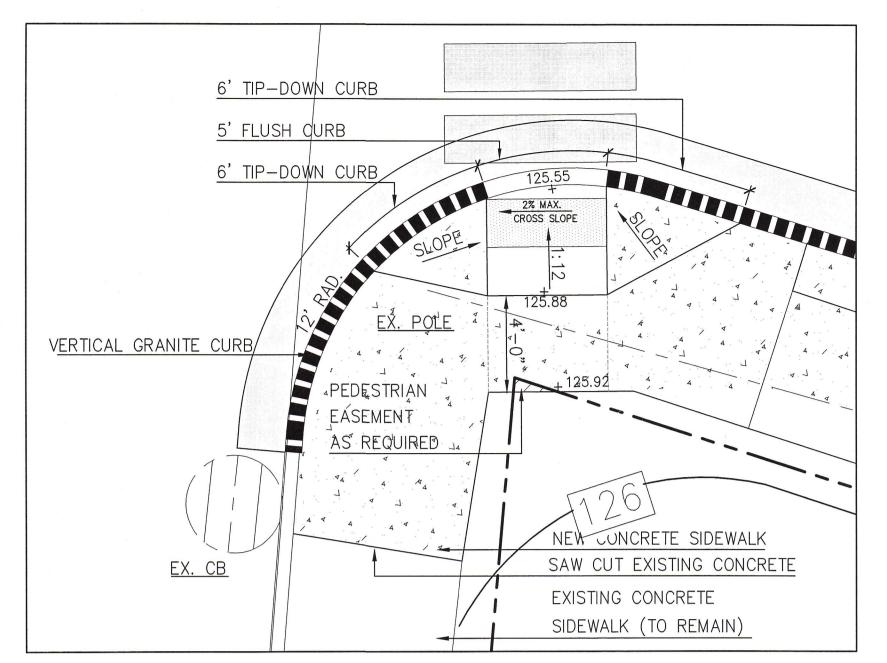


STEVENS AVE./ARBOR STREET INTERSECTION L2.1) SCALE: 1' = 4'-0"

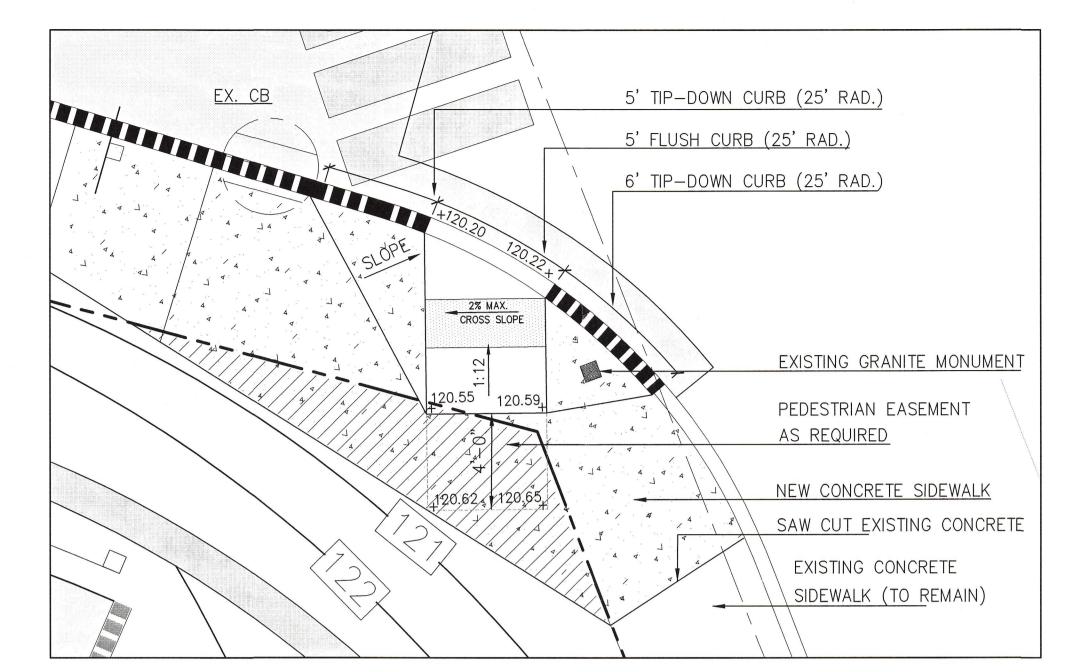

FOREST AVE./ARBOR STREET INTERSECTION SCALE: I' = 4'-0"

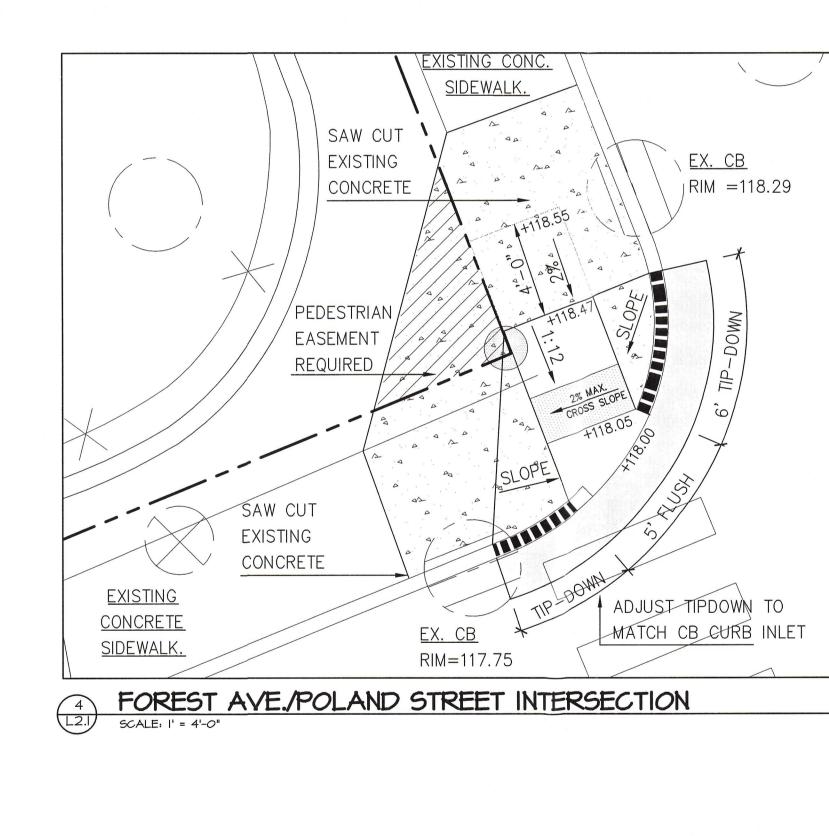

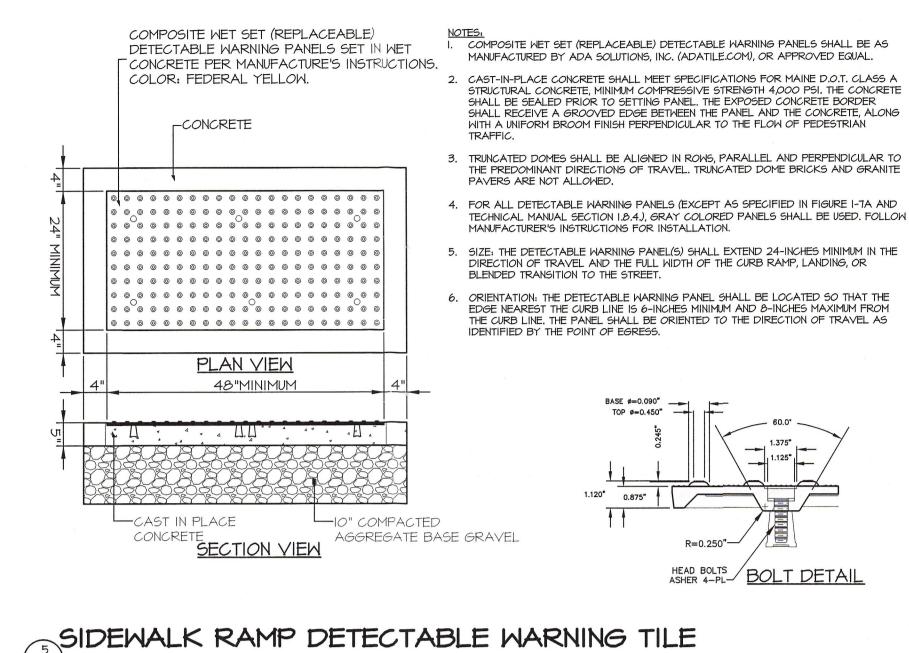

NOT TO SCALE

Q

Prepared For:

Home For The Aged 777 Stevens Avenue Portland, Maine 04103 Tel.: 207-797-7710

The Park Danforth

777 Stevens Avenue

Tel.: 207-797-7710

Landscape Architects

The Staples School

Tel.: 207-774-4427

70 Center Street Portland, Maine 04101

Prepared By:

Portland, Maine 04103

MITCHELL & ASSOCIATES

Maine

0

ortla

Owner:

Applicant:

OCTOBER 17, 2014 **PERMITTING**


Issued For:


NOV. 25, 2014: Per City of Portland Staff Review Comments JAN. 5, 2015: Per City of Portland Staff Review Commen

APR. 10, 2015: Amended Site Plan and Subdivision Plan SEPT. 10, 2015: Per Staff Review Commen

Reproduction or reuse of this document without the expressed written consent of Mitchell & Associates is prohibited. © 2015


CURB CUT AND RAMP DETAIL PLANS

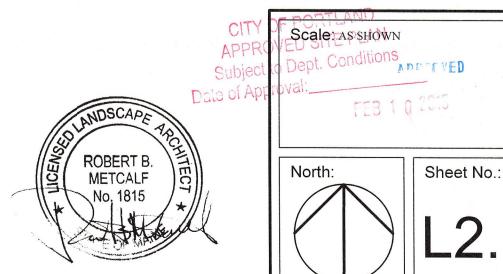

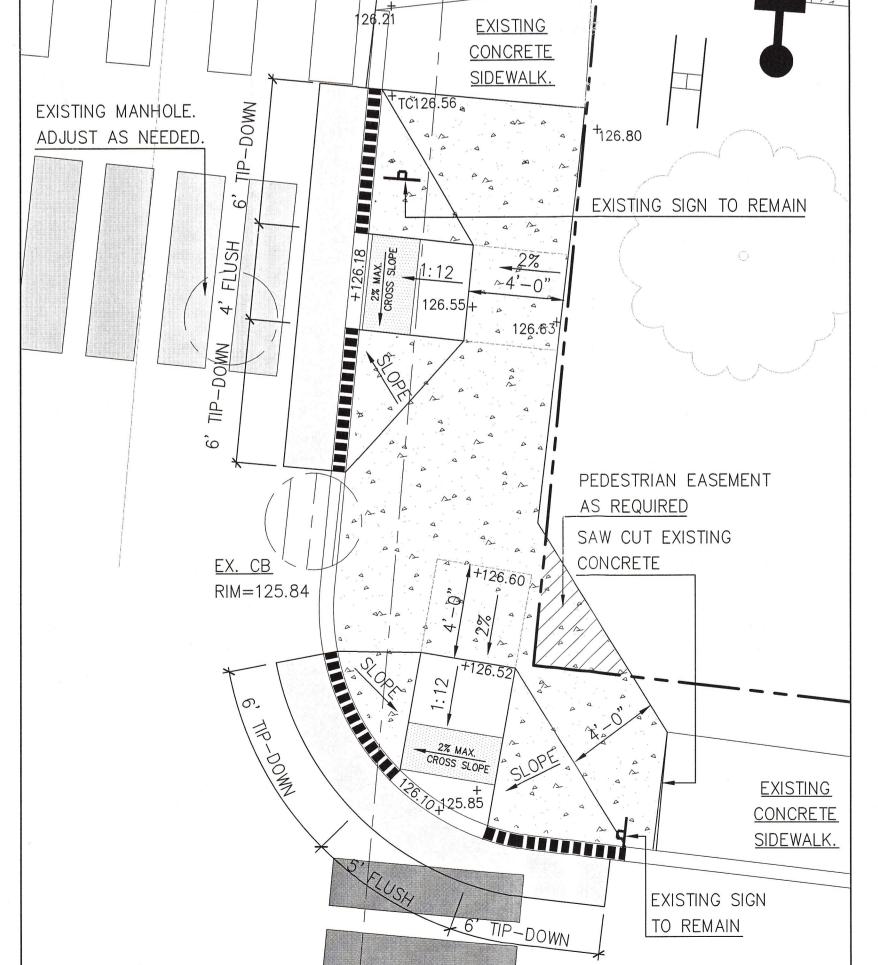

STEVENS AVE./POLAND STREET INTERSECTION

SCALE: I' = 4'-0"

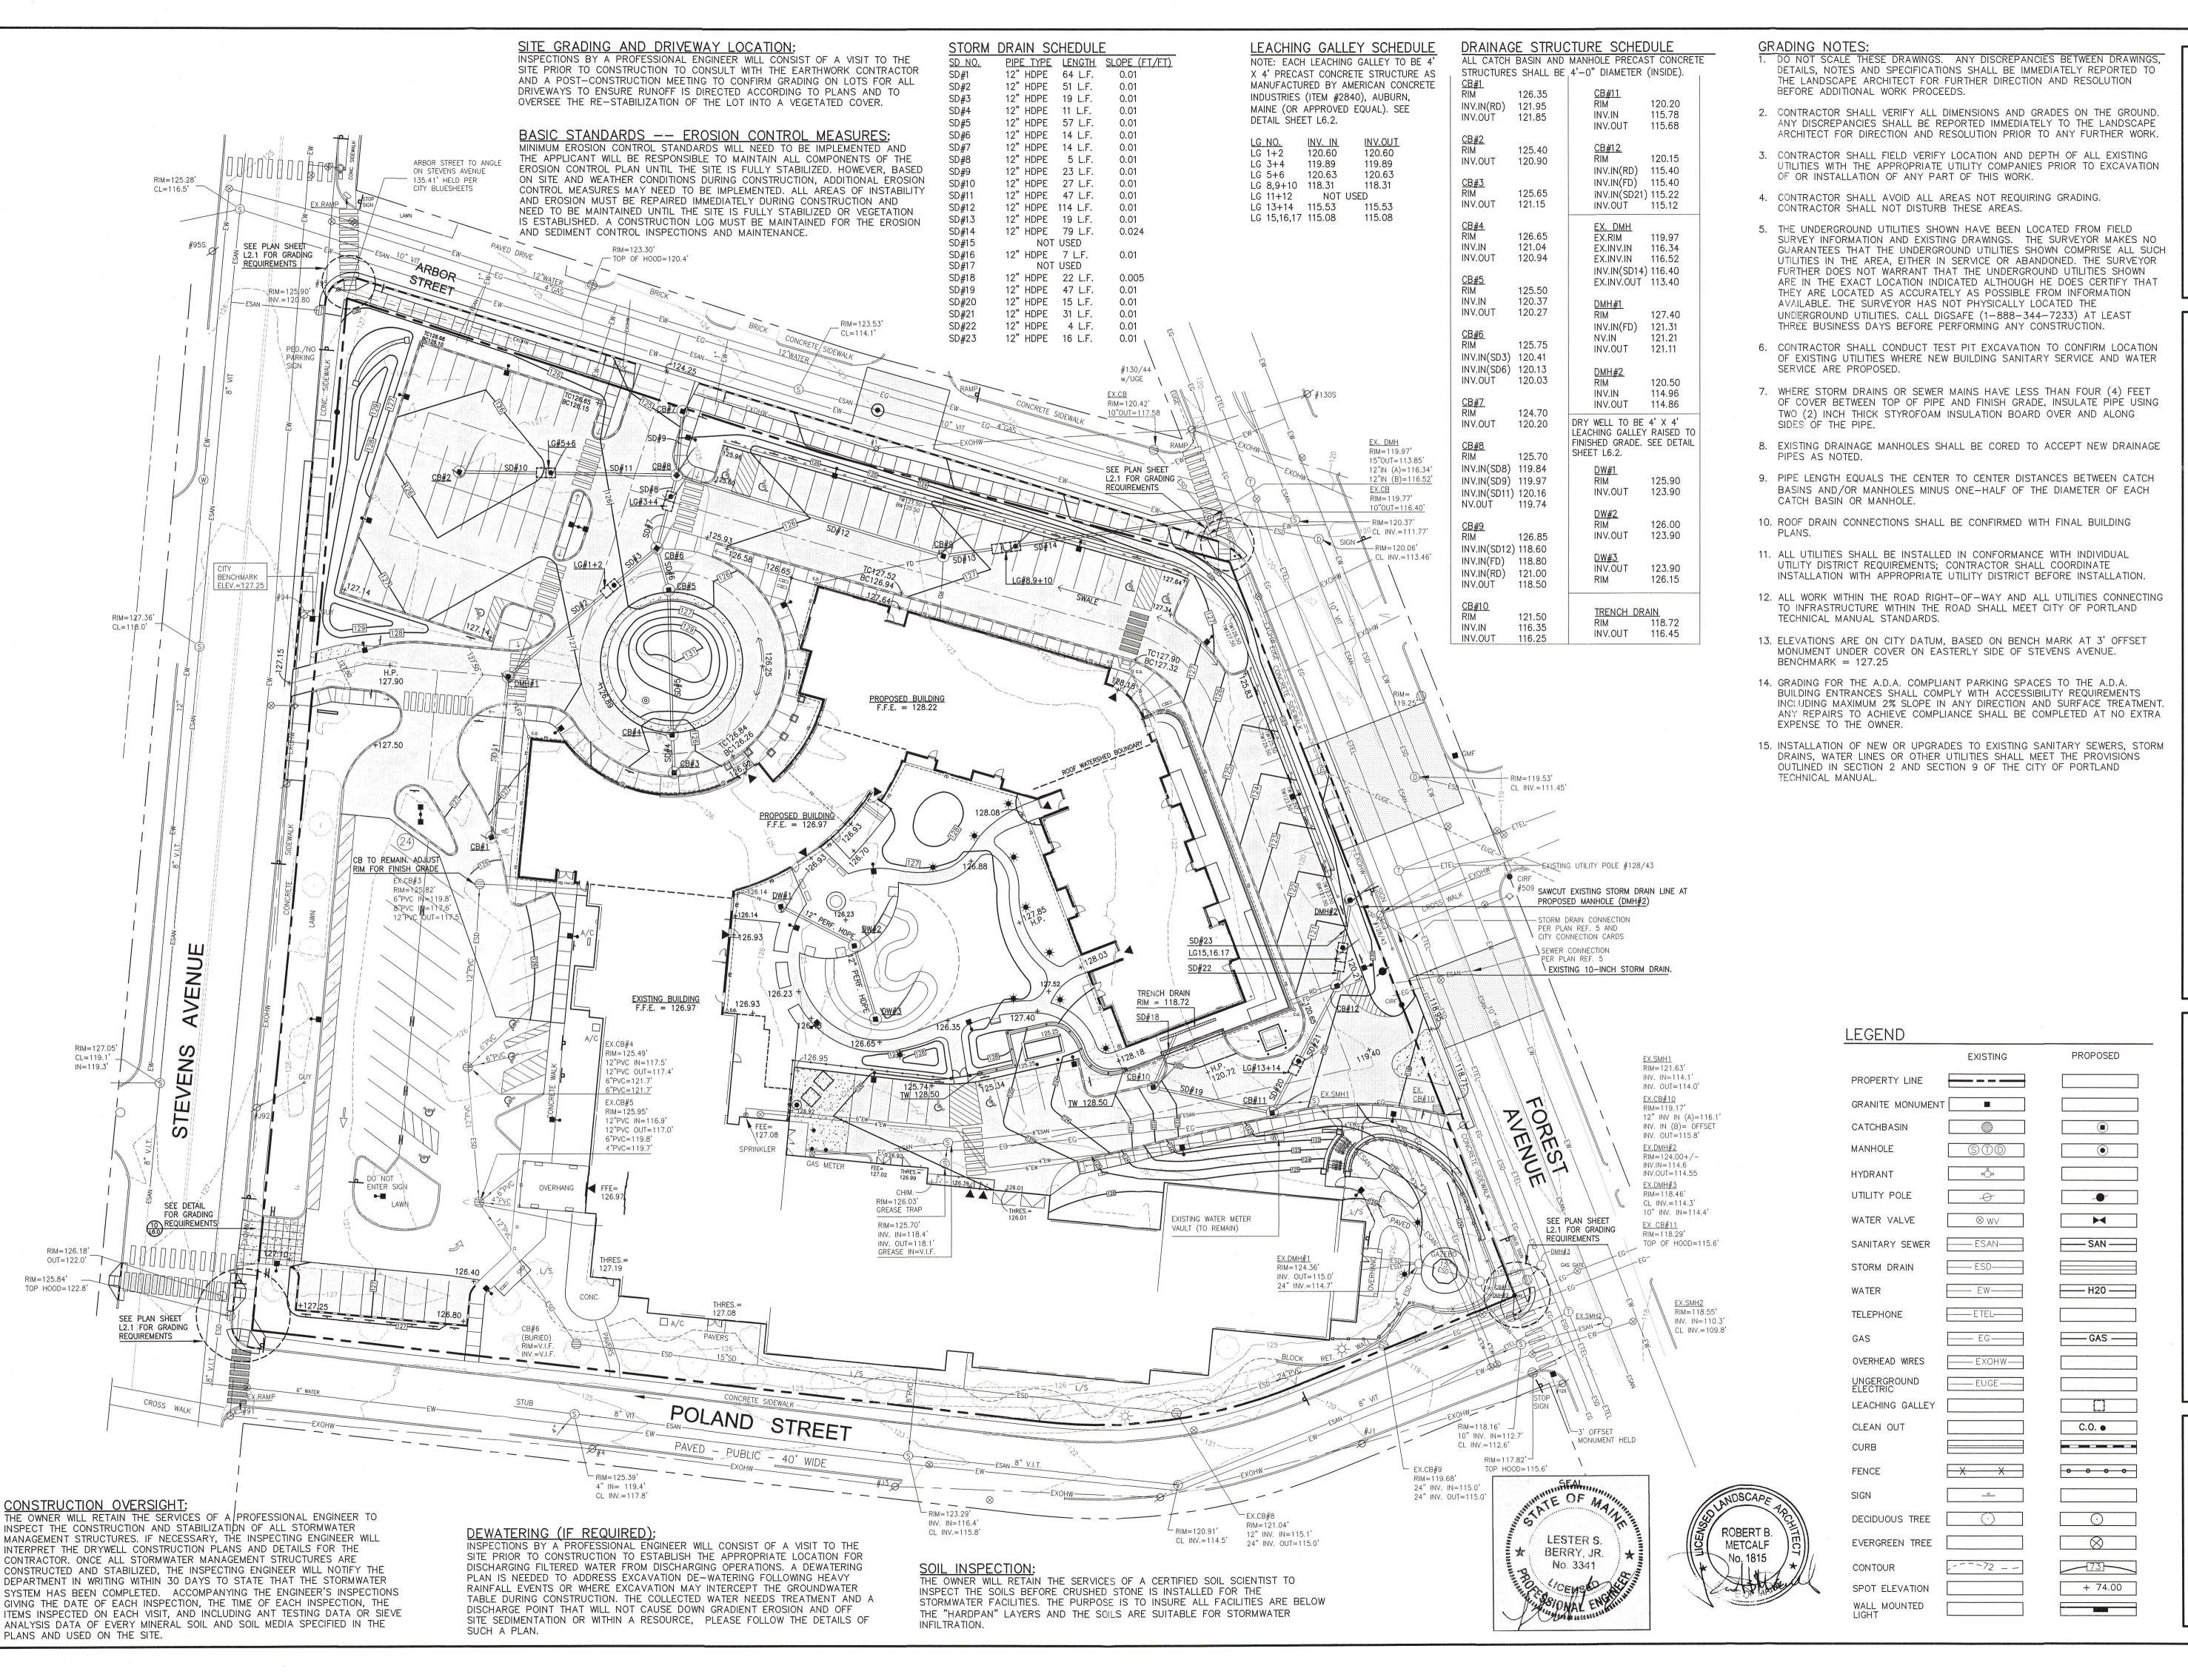

Prepared For: Owner:

Home For The Aged 777 Stevens Avenue

Portland, Maine 04103 Tel.: 207-797-7710

Applicant: The Park Danforth 777 Stevens Avenue Portland, Maine 04103 Tel.: 207-797-7710

Prepared By:

MITCHELL & ASSOCIATES Landscape Architects The Staples School 70 Center Street

Portland, Maine 04101 Tel.: 207-774-4427

O

Date: OCTOBER 17, 2014

Issued For:

PERMITTING

Revisions:

NOV. 25, 2014: Per City of Portland Staff Review Comments JAN. 5, 2015: Per City of Portland Staff Review Comments

APR. 10, 2015: Amended Site Plan


Reproduction or reuse of this document without the expressed written consent of Mitchell & Associates is prohibited.

and Subdivision Plan

GRADING AND DRAINAGE PLAN


© 2015


APPPOVED Scale: 1" = 30' North: Sheet No.:

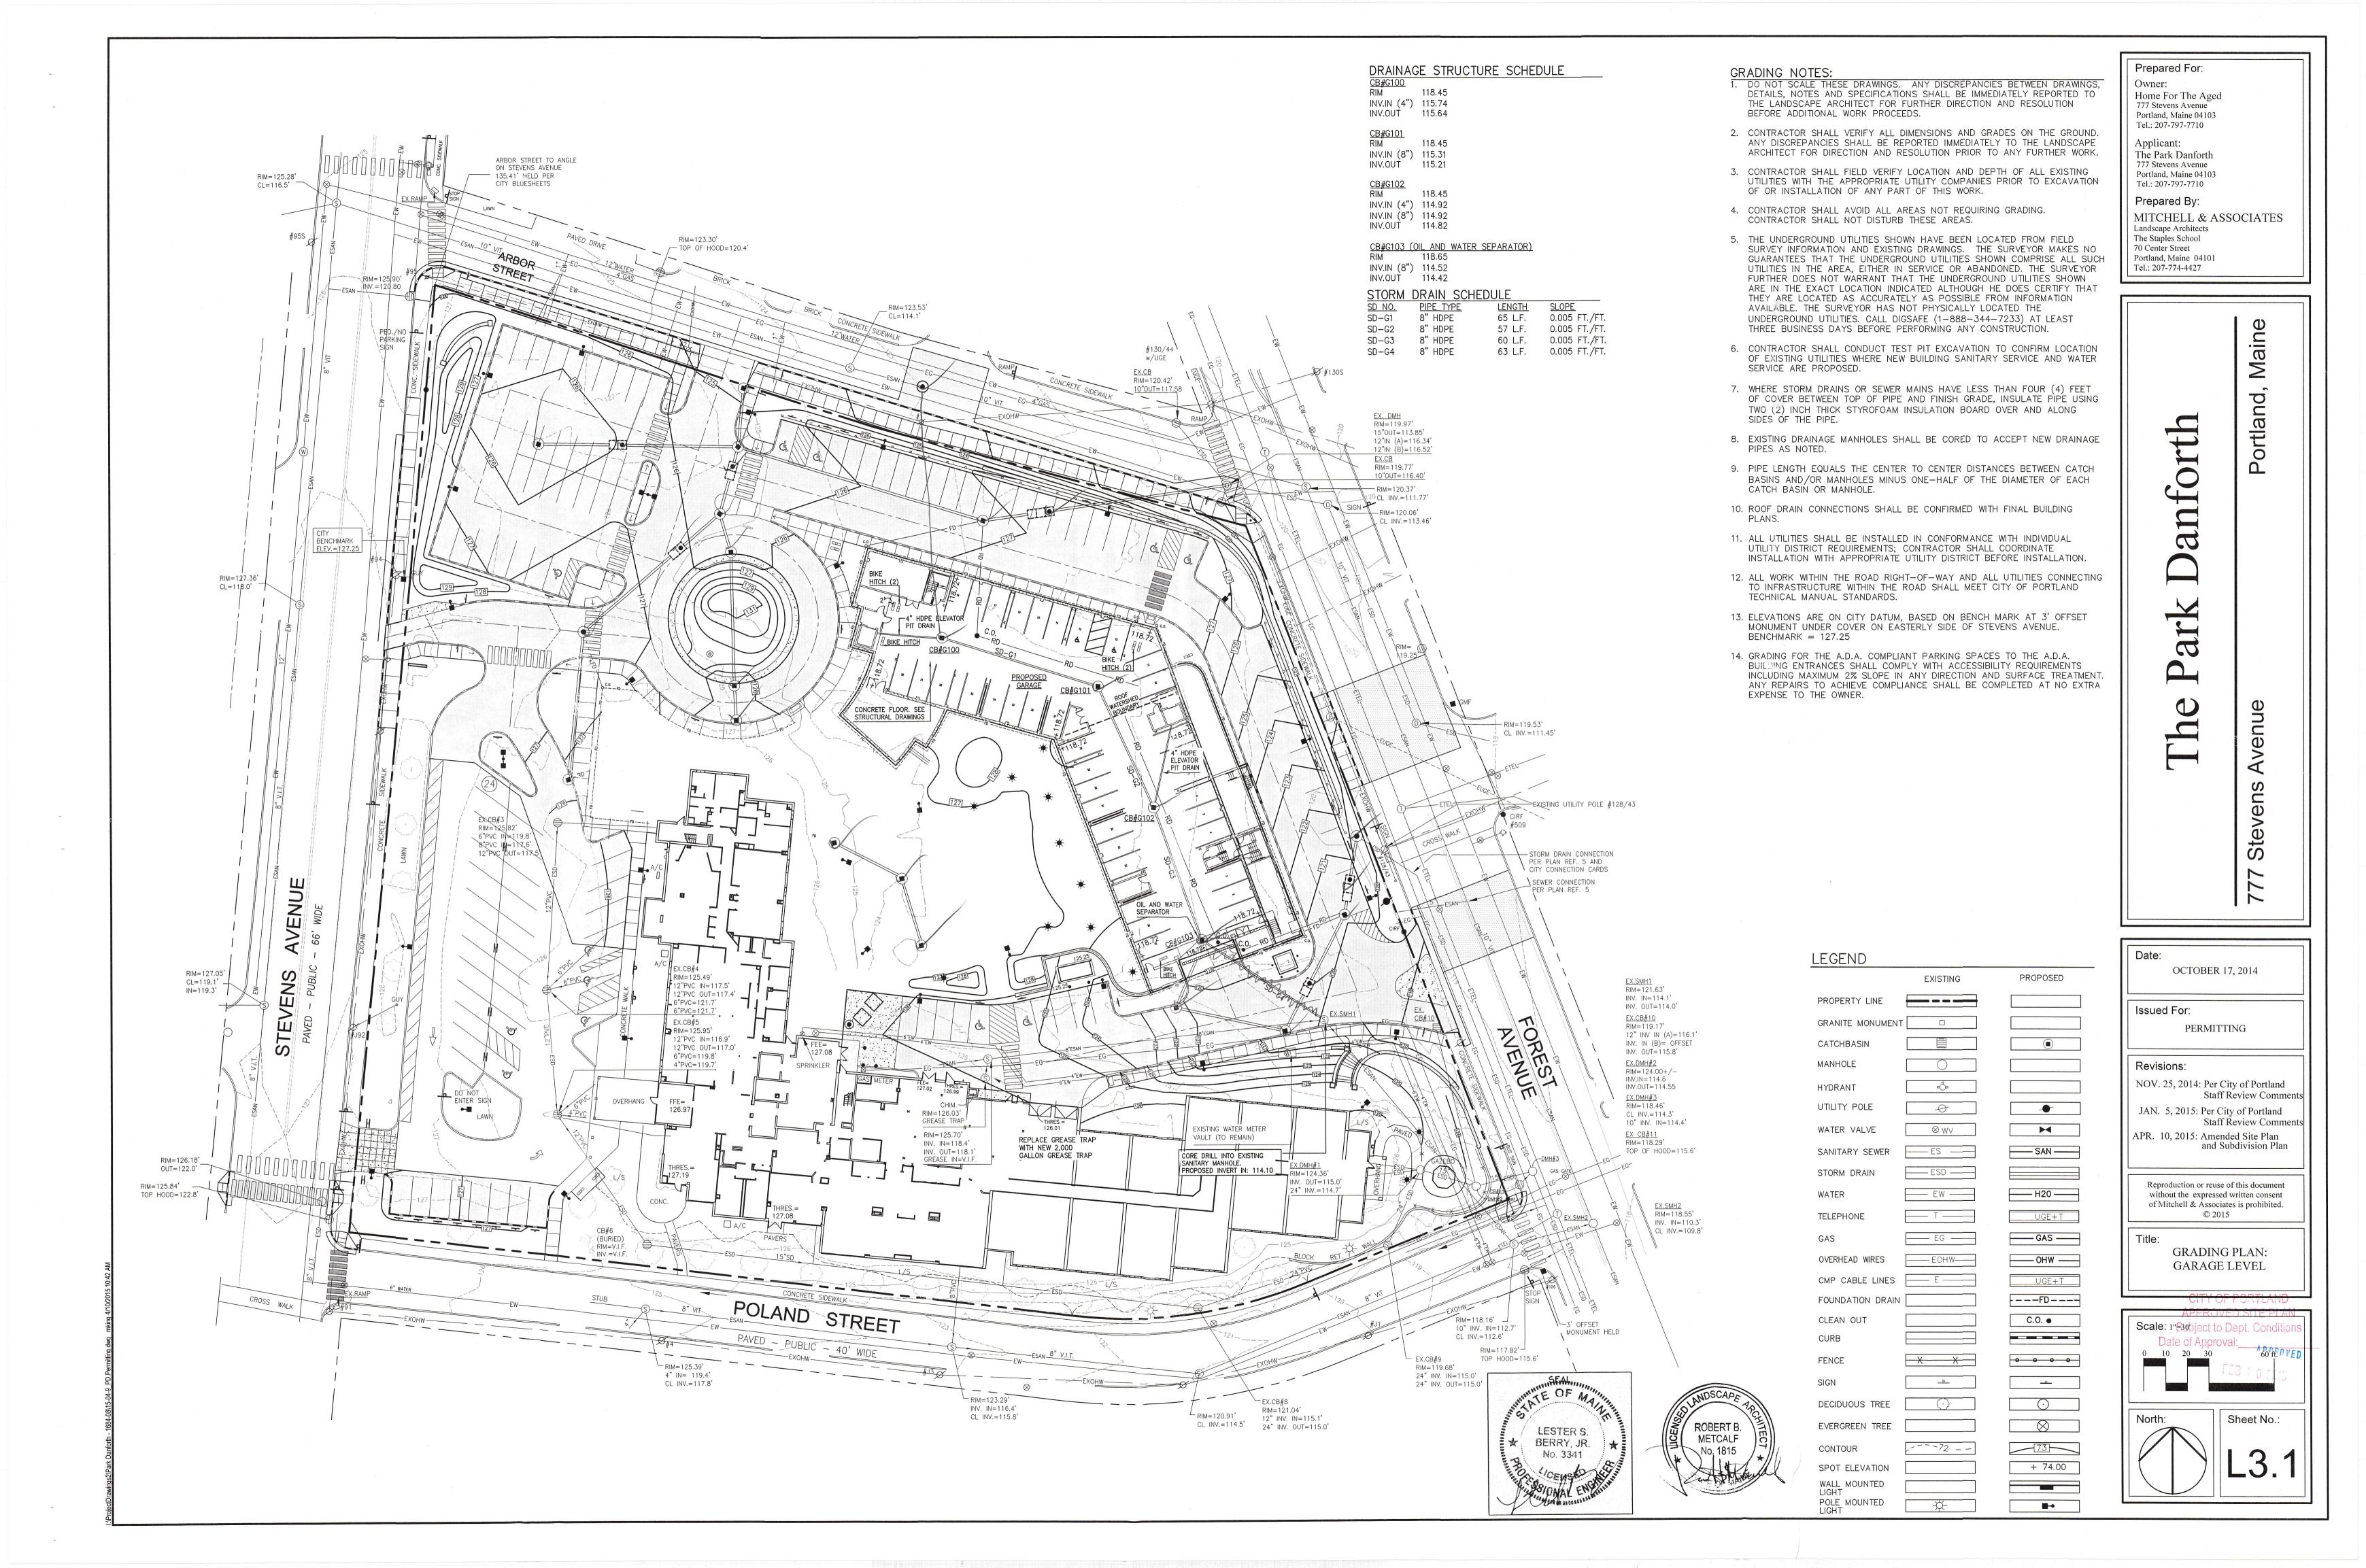



EROSION AND SEDIMENT CONTROL PLAN LEGEND THIS PLAN HAS BEEN DEVELOPED AS A STRATEGY TO CONTROL SOIL EROSION AND SEDIMENTATION DURING AND AFTER THE EXPANSION OF THE PARK DANFORTH AT 777 STEVENS PROPOSED **EXISTING** Prepared For: AVENUE IN PORTLAND, MAINE. THIS PLAN IS BASED ON THE MAINE EROSION AND SEDIMENTATION CONTROL HANDBOOK FOR CONSTRUCTION, BEST MANAGEMENT PRACTICES, MARCH, PROPERTY LINE ----Home For The Aged INLET SEDIMENT 777 Stevens Avenue CONTROL GRANITE MONUMENT INLET SEDIMENT Portland, Maine 04103 DEVICE (TYP.) A. PROPOSED DEVELOPMENT CONTROL DEVICE (TYP.) Tel.: 207-797-7710 CATCHBASIN SEE PLAN SHEET L2.1 FOR GRADING REQUIREMENTS THE PROJECT CONSISTS OF THE CONSTRUCTION OF A FIVE-STORY, 21,777 SQUARE FOOT BUILDING. THE BUILDING WILL INCLUDE 54 APARTMENT UNITS, A PARKING GARAGE, A GARAGE Applicant: MANHOLE LEVEL MECHANICAL ROOM AND SERVICE CORE. THE 4.16-ACRE PARCEL CURRENTLY CONSISTS OF BUILDING AND A PARKING LOT; 77.4% OF THE EXISTING SITE IS IMPERVIOUS. THE The Park Danforth STABILIZED 777 Stevens Avenue PROPOSED IMPERVIOUS LOT IMPERVIOUS IS 3.05-ACRES OR 73.3% OF THE SITE. **HYDRANT** <u></u> Portland, Maine 04103 INLET SEDIMENT Tel.: 207-797-7710 CONTROL DEVICE (TYP.) B. EROSION CONTROL PRACTICES/TEMPORARY MEASURES UTILITY POLE 0 -0 Prepared By: **EROSION CONTROL** THE FOLLOWING TEMPORARY MEASURES TO CONTROL EROSION AND SEDIMENTATION SHALL BE UTILIZED: MITCHELL & ASSOCIATES WATER VALVE FENCE (TYP.) \otimes W \vee Landscape Architects EACH GROUND AREA, OPENED OR EXPOSED, WHETHER DIRECTLY OR INDIRECTLY DUE TO THE DEVELOPMENT, SHALL BE MINIMIZED AND SHALL BE STABILIZED WITHIN 15 DAYS OF The Staples School ESC FENCE -0-0-0-0-0 INITIAL DISTURBANCE OF SOIL AND SHALL BE PERMANENTLY STABILIZED WITHIN SEVEN DAYS OF FINAL GRADING. THIS STATEMENT APPLIES TO DISTURBED AREAS BEYOND THE 70 Center Street LIMITS OF THE PROPOSED BUILDING. EXPOSED AREAS SHALL BE STABILIZED PRIOR TO A RAIN EVENT. Portland, Maine 04101 CONTROL DEVICE Tel.: 207-774-4427 TEMPORARY SOIL STABILIZATION SHALL BE EITHER BY TEMPORARY MULCHING, TEMPORARY SEEDING, PERMANENT BASE GRAVEL, OR ASPHALT BINDER COURSE AS FOLLOWS: TEMPORARY SEEDING: SEED SHALL BE AROOSTOOK RYE APPLIED AT 2.60#/1000 SF. LIME SHALL BE AGRICULTURAL GROUND LIMESTONE APPLIED AT 138#/1000 SF. FERTILIZER SHALL BE 10-10-10 CLASSIFICATION APPLIED AT 13.8#/1000 SF. MULCH SHALL CONSIST OF HAY AND STRAW MULCH AND SPREAD EVENLY AT A RATE OF 70-90#/1000 SF. TEMPORARY SEEDINGS SHALL ONLY BE MADE BETWEEN APRIL 15 AND OCTOBER I, AND SHALL NOT BE PLACED OVER SNOW. TEMPORARY MULCHING: MULCH SHALL CONSIST OF CHOPPED HAY OR STRAW MULCH AND SPREAD BY MECHANICAL BLOWER EVENLY AT A RATE OF 150-200#/1000 SF. TEMPORARY MULCH SHALL BE REMOVED PRIOR TO PERMANENT SOIL STABILIZATION. MULCH MUST NOT BE PLACED OVER SNOW. SNOW SHALL BE REMOVED PRIOR TO MULCHING. PERMANENT BASE GRAVEL: BASE GRAVEL UNDER PAVEMENT SHALL BE SUITABLE AS TEMPORARY SOIL STABILIZATION UNDER THE FOLLOWING CONDITIONS: STABILIZED a) SLOPES SHALL BE LESS THAN EIGHT PERCENT: CONSTRUCTION O b) GRAVEL SHALL MEET THE SPECIFICATIONS FOR BASE OR SUBBASE GRAVEL FOR THE PROPOSED COMPLETED PAVEMENT. ENTRANCE C. EROSION CONTROL PRACTICES/PERMANENT MEASURES PROPOSED BUILDING F.F.E. = 128.22 THE FOLLOWING PERMANENT MEASURES TO CONTROL EROSION AND $\,$ SEDIMENTATION SHALL BE UTILIZED: ENTRANCE (TYP.) . PERMANENT SEEDING SHALL BE PERFORMED DURING CONSTRUCTION OPERATIONS AS EACH DISTURBED AREA HAS BEEN BROUGHT TO FINISH GRADE. PERMANENT SEEDINGS SHALL BE MADE AS DORMANT SEEDING AFTER THE FIRST KILLING FROST. DORMANT SEEDING AND MULCH SHALL BE USED AT TWO TIMES THE PERMANENT SEEDING AND MULCHING RATE SHOWN BELOW FOR BOTH LAWN AS WELL AS EMBANKMENTS. SEED, LOAM, LIME, FERTILIZER AND MULCH ARE TO BE AS FOLLOWS: SEED: THE SEED MIXTURE SHALL CONSIST OF SEED PROPORTIONED BY WEIGHT. ALL SEED SHALL BE FRESH, CLEAN, "NEW CROP" SEED. HARMLESS INERT MATTER AND WEED SEEDS SHALL BE PERMITTED UP TO ONE PERCENT OF THE GROSS WEIGHT OF EACH VARIETY OF SEED. ALL SEED SUPPLIED SHALL BE PACKED IN APPROVED CONTAINERS INLET SEDIMENT BEARING THE MANUFACTURER'S MANE AND ANALYSIS OF CONTENTS. THE FOLLOWING MATERIALS AND APPLICATION RATES SHALL BE REQUIRED FOR PERMANENT SEEDING: CONTROL DEVICE (TYP.) CREEPING RED RESCUE: 0.69#/1000 SF 0.57#/1000 SF KENTUCKY BLUEGRASS: PROPOSED MANHOLE (DMH#2) PERENNIAL RYEGRASS: 0.46#/1000 SF REDTOP: 0.12#/1000 SF TOTAL: 1.84#/1000 SF ENC LOAM: SHALL BE FREE OF GRASSES, ROOTS, LARGE STONE AND INORGANIC DEBRIS. PLACE LOAM AT FOUR INCHES MINIMUM DEPTH OVER ALL DISTURBED AREAS. FINAL LEXISTING 10-INCH STORM DRAIN. GRADING OF ALL LAWN AREAS TO BE APPROVED BY LANDSCAPE ARCHITECT BEFORE SEEDING. LIME: LIME SHALL BE AGRICULTURAL GROUND LIMESTONE AND APPLIED AS PER RECOMMENDATION OF A STATE COMMERCIAL SOIL TESTING LABORATORY. FERTILIZER: INLET SEDIMENT FERTILIZER SHALL BE 10-20-20 CLASSIFICATION AND APPLIED AS PER RECOMMENDATION OF A STATE COMMERCIAL SOIL TESTING LABORATORY. CONTROL DEVICE (TYP.) MULCH: MULCH SHALL CONSIST OF HAY OR STRAW MULCH. MULCH SHALL BE SPREAD EVENLY AT A RATE OF TWO AND ONE HALF TONS PER ACRE OVER ALL SEEDING. AFTER APPLICATION, THE MULCH SHALL BE THOROUGHLY WETTED. IN STEEP AREAS, THE MULCH SHALL BE HELD IN PLACE BY THE USE OF JUTE EROSION CONTROL NETTING OR INV. OUT=114.0 APPROVED ALTERNATIVE NETTING MATERIAL. NOTE: ALL EXPOSED SOIL MUST BE COVERED REGARDLESS OF MULCHING RATES SPECIFIED. 2"PVC IN=116.9' 2"PVC OUT=117.0 THE CONTRACTOR SHALL MAINTAIN THE SEEDED AND MULCHED AREAS UNTIL FINAL ACCEPTANCE OR THE WORK, MAINTENANCE SHALL CONSIST OF PROVIDING PROPER WATERING. PROTECTION AGAINST TRAFFIC AND REPAIRING ANY AREAS DAMAGED DUE TO WIND, WATER, EROSION, FIRE OR OTHER CAUSES. SUCH DAMAGED AREAS SHALL BE REPAIRED TO REESTABLISH THE CONDITION AND GRADE OF THE SOIL PRIOR TO SEEDING AND SHALL THEN BE REFERTILIZED, RESEEDED AND REMULCHED. EXCAVATION AND EARTHWORK SHALL BE COMPLETED SUCH THAT NO MORE THAN I ACRE OF THE SITE IS WITHOUT STABILIZATION AT ANY ONE TIME, LIMIT THE EXPOSED AREA TO THOSE AREAS IN WHICH WORK IS EXPECTED TO BE UNDERTAKEN DURING THE PROCEEDING IS DAYS AND THAT CAN BE MULCHED IN ONE DAY PRIOR TO ANY SNOW EVENT. HAY AND STRAW MULCH RATE SHALL BE A MINIMUM OF 150 LBS./1,000 S.F. (3 TONS/ACRE) AND SHALL BE PROPERLY ANCHORED. THE CONTRACTOR SHALL INSTALL ANY ADDED MEASURES INV. OUT=118.1' GREASE IN=V.I.F. WHICH MAY BE NECESSARY TO CONTROL EROSION/SEDIMENTATION FROM THE SITE, DEPENDENT UPON THE ACTUAL SITE AND WEATHER CONDITIONS. CONTINUATION OF EARTHWORK OPERATIONS ON ADDITIONAL AREAS SHALL NOT BEGIN UNTIL THE EXPOSED SOIL SURFACE ON THE AREA BEING WORKED HAS BEEN STABILIZED, IN ORDER TO MINIMIZE AREAS WITHOUT EROSION CONTROL PROTECTION. <u>E. CONSTRUCTION SEQUENCE</u> THE GENERAL SEQUENCE OF WORK SHALL BE AS FOLLOWS: INSTALL EROSION CONTROL DEVICES. (SILT FENCE, STABILIZED CONSTRUCTION ENTRANCE AND OR SEDIMENT BARRIER.) INLET SEDIMENT TEMPORARILY STABILIZE DISTURBED AREAS BY MULCHING ALL EXPOSED SOIL WITHIN 15 DAYS OF INITIAL DISTURBANCE. CONTROL DEVICE (TYP. INSTALL STORMWATER SYSTEM COMPLETE SITE CONSTRUCTION WORK CONSTRUCT PAVED ACCESS AND PARKING AREAS; Date: INSTALL PERMANENT VEGETATION ON ALL EXPOSED AREAS WITHIN 15 DAYS OF FINAL GRADING; AND \ MONUMENT HELD PERFORM CONTINUING MAINTENANCE ON ALL EROSION AND SEDIMENTATION CONTROL DEVICES AND MEASURES. OCTOBER 17, 2014 F. SITE INSPECTION & MAINTENANCE WEEKLY INSPECTIONS, AS WELL AS ROUTINE INSPECTIONS FOLLOWING RAINFALLS OF 0.5" OVER A CONSECUTIVE 24-HOUR PERIOD, SHALL BE CONDUCTED BY THE SITE CONTRACTOR Issued For: OF ALL TEMPORARY AND PERMANENT EROSION CONTROL DEVICES UNTIL FINAL ACCEPTANCE OF THE PROJECT. NECESSARY REPAIRS SHALL BE MADE TO CORRECT UNDERMINING OR DETERIORATION. FINAL ACCEPTANCE SHALL INCLUDE A SITE INSPECTION TO VERIFY THE STABILITY OF ALL DISTURBED AREAS AND SLOPES, UNTIL FINAL INSPECTION, ALL EROSION PERMITTING AND SEDIMENTATION CONTROL MEASURES SHALL IMMEDIATELY BE CLEANED, AND REPAIRED BY THE SITE CONTRACTOR AFTER STORM EVENTS. DISPOSAL OF ALL TEMPORARY EROSION CONTROL DEVICES SHALL BE THE RESPONSIBILITY OF THE SITE CONTRACTOR. 2 EACH DUMP STRAPS Revisions: CONTINUED TEMPORARY MAINTENANCE AND LONG TERM PROVISIONS FOR PERMANENT MAINTENANCE OF ALL EROSION AND SEDIMENTATION CONTROL FACILITIES AFTER ACCEPTANCE OF THE PROJECT SHALL BE THE RESPONSIBILITY OF THE PARK DANFORTH. NOV. 25, 2014: Per City of Portland EXPANSION RESTRAINT Staff Review Commer (I/4" NYLON ROPE, 2" 50' MINIMUM JAN. 5, 2015: Per City of Portland Staff Review Comment APR. 10, 2015: Amended Site Plan REBAR OR 2" X 2" WOODEN STAKE I.5' - 2' IN GROUND. MAX SPACING OF 6' and Subdivision Plan · WOVEN FABRIC INSTALLATION DETAIL EXISTING GROUND -PROFILE PROVIDE APPROPRIATE TRANSITION BETWEEN BAG DETAIL STABILIZATION CONSTRUCTION ENTRANCE AND PUBLIC GEOTEXTILE FABRIC MIRAFI — 600X OR APPROVED EQUAL Reproduction or reuse of this document RIGHT-OF-WAY without the expressed written consent 50' MINIMUM of Mitchell & Associates is prohibited. DUMP STRAP © 2015 I" REBAR FOR BAG-REMOVAL FROM INLET LESTER S. **EROSION AND SEDIMENT** BERRY, JR. CONTROL PLAN No. 3341 CITY OF PODTI AND SILTSACK OR ----APPROVED EQUAL - UNDISTURBED SOIL Scale: 40'r OPTIONAL METAL HANGING FRAME FOR TRAFFIC CONDITIONS STONE SIZE: AASHTO DESIGNATION M 43, SIZE NO. 2 (2.5" TO 1.5"). USE CRUSHED STONE. -ROLL END STAKES SILT FENCE TO BE INSTALLED PARALLEL TO EXISTING CONTOURS DOWNSLOPE FROM AREAS OF LENGTH: AS EFFECTIVE, BUT NOT LESS THAN 50 FEET. SOIL DISTURBANCE. 3. THICKNESS: NOT LESS THAN EIGHT (8) INCHES. 4. WIDTH: NOT LESS THAN FULL WIDTH OF ALL POINT OF INGRESS OR EGRESS -FILTER FABRIC 2. SILT FENCE TO BE SECURELY ATTACHED TO THE UPSLOPE SIDE OF THE SUPPORTING STAKES. 5. WASHING: WHEN NECESSARY, WHEELS SHALL BE CLEANED TO REMOVE SEDIMENT PRIOR TO ENTRANCE ONTO PUBLIC RIGHT-OF-WAY. WHEN WASHING IS REQUIRED, IT SHALL BE DONE ON AN AREA STABILIZED WITH CRUSHED 3. BOTTOM 4 TO 6 INCHES OF SILT FENCE TO BE BURIED IN SLOPE AND BACKFILLED WITH STONE WHICH DRAINS INTO AN APPROVED SEDIMENT TRAP OR SEDIMENT BASIN. ALL SEDIMENT SHALL BE ROBERT I COMPACTED SOIL. PREVENTED FROM ENTERING ANY STORM DRAIN, DITCH, OR WATERCOURSE THROUGH THE USE OF SAND BAGS, METCALF North: Sheet No. GRAVEL, BOARDS OR OTHER APPROVED METHODS 4. INSPECTION SHALL BE MADE AFTER EVERY RAINFALL WITH REMOVAL OF EXCESSIVE SEDIMENT 6. MAINTENANCE: THE ENTRANCE SHALL BE MAINTAINED IN A CONDITION WHICH WILL PREVENT TRACKING OR AND REPAIR OF THE FENCE ACCOMPLISHED PROMPTLY. WOODEN STAKES FLOWING OF SEDIMENT ONTO PUBLIC RIGHT-OF-WAY. THIS MAY REQUIRE PERIODIC TOP DRESSING WITH ADDITIONAL STONES AS CONDITIONS DEMAND AND REPAIR AND/OR CLEANOUT OF ANY MEASURES USED TO END POST OVERLAP DETAIL SILT FENCE AND ACCUMULATED SEDIMENT SHALL BE REMOVED AS SOON AS PERMANENT TRAP SEDIMENT. ALL SEDIMENT SPILLED, DROPPED, WASHED, OR TRACKED ONTO PUBLIC RIGHT-OF-WAY MUST EROSION CONTROL MEASURES HAVE BEEN ESTABLISHED. BE REMOVED IMMEDIATELY. NOT TO SCALE SILT FENCE INLET SEDIMENT CONTROL DEVICE STABILIZED CONSTRUCTION ENTRANCE

L3.2 NOT TO SCALE

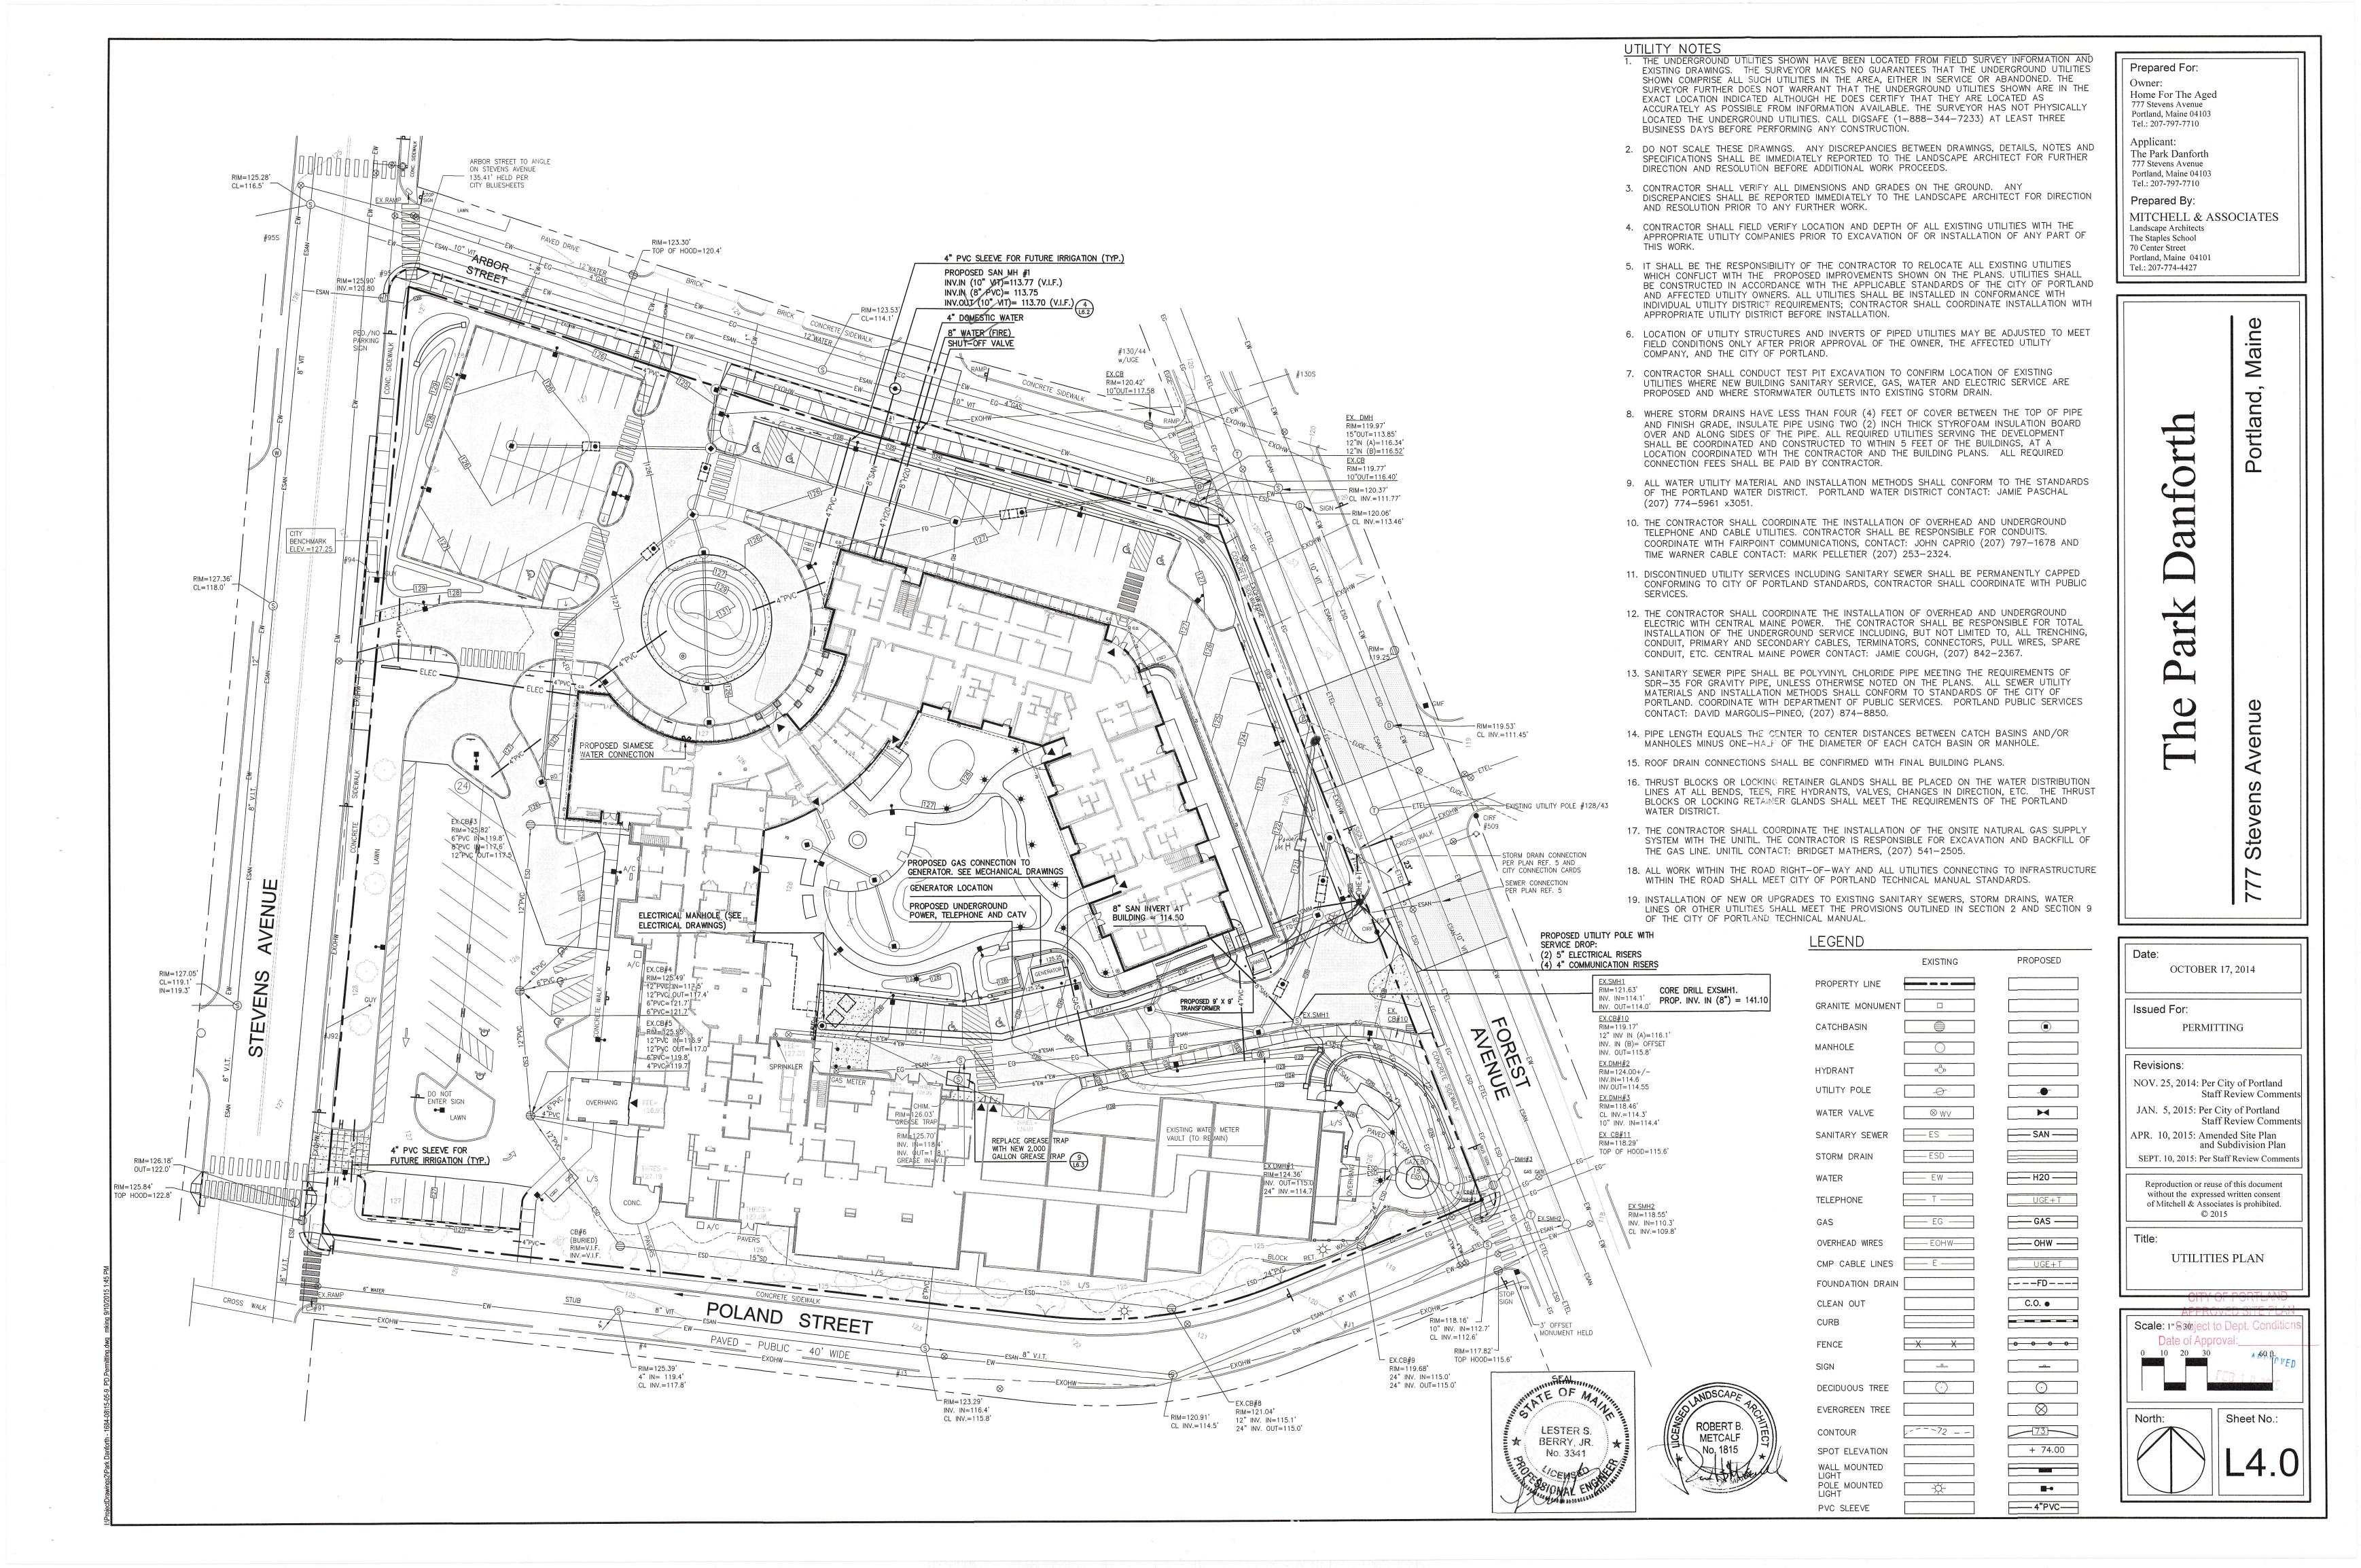


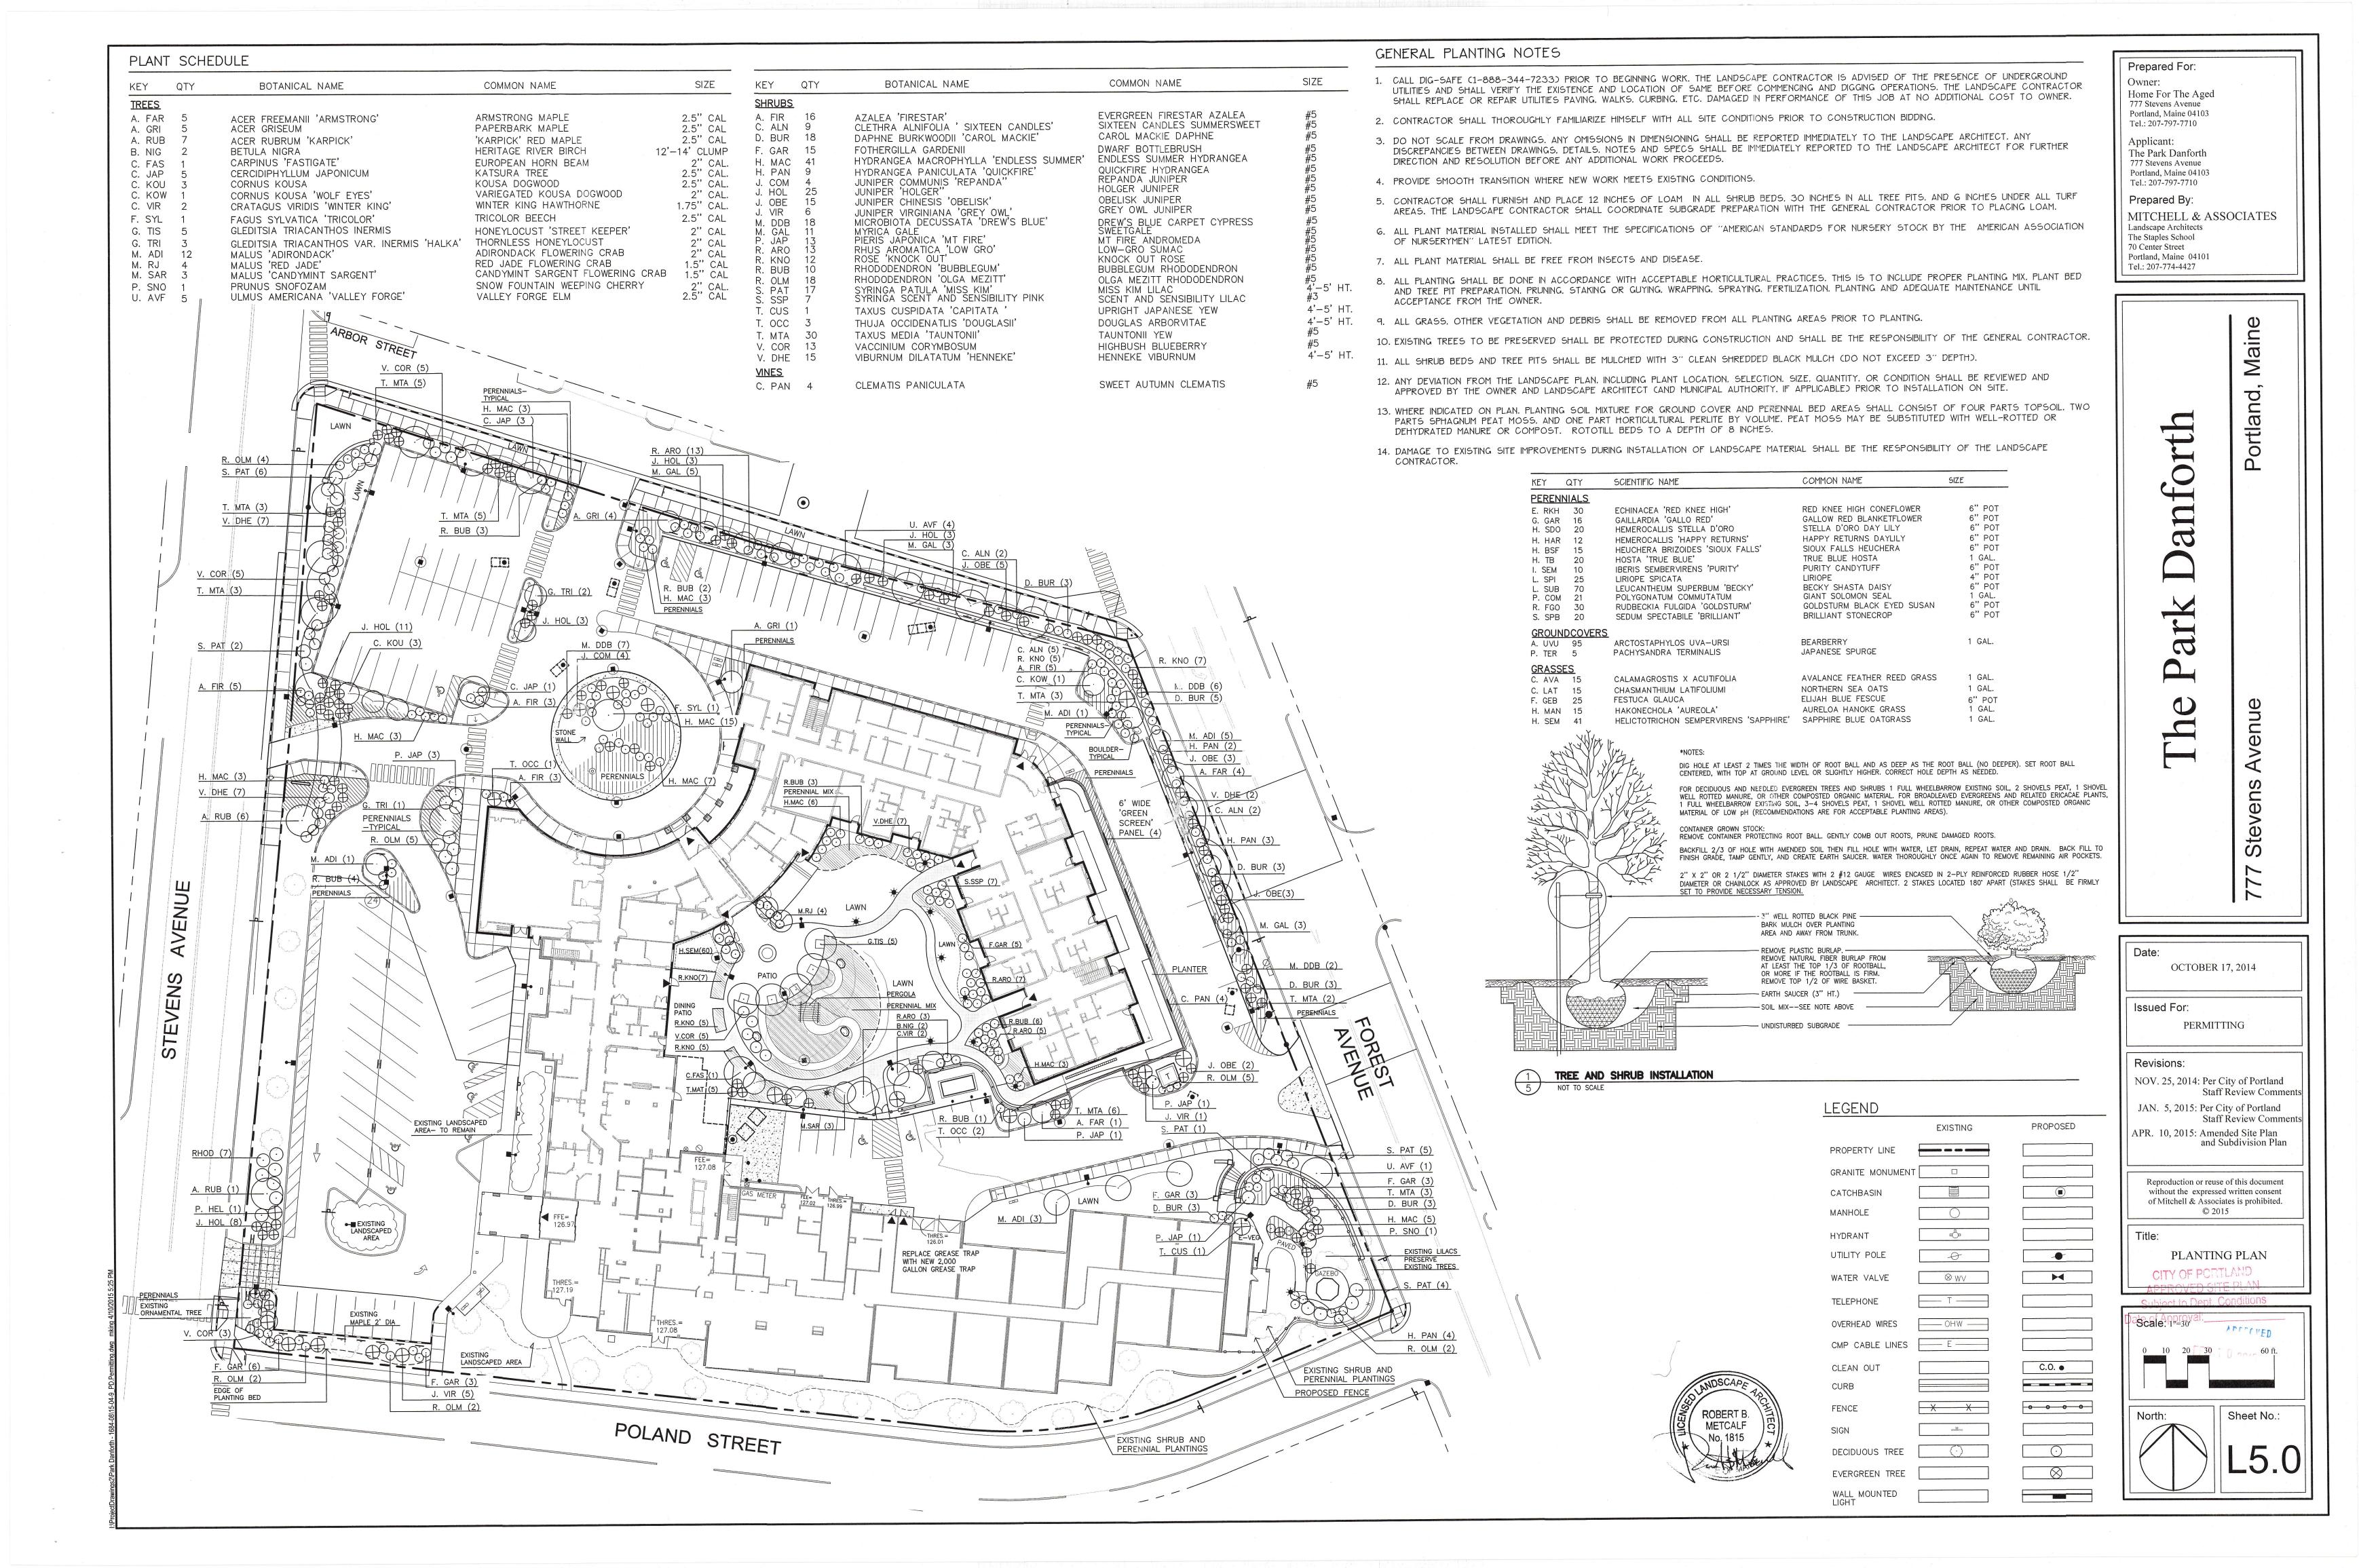

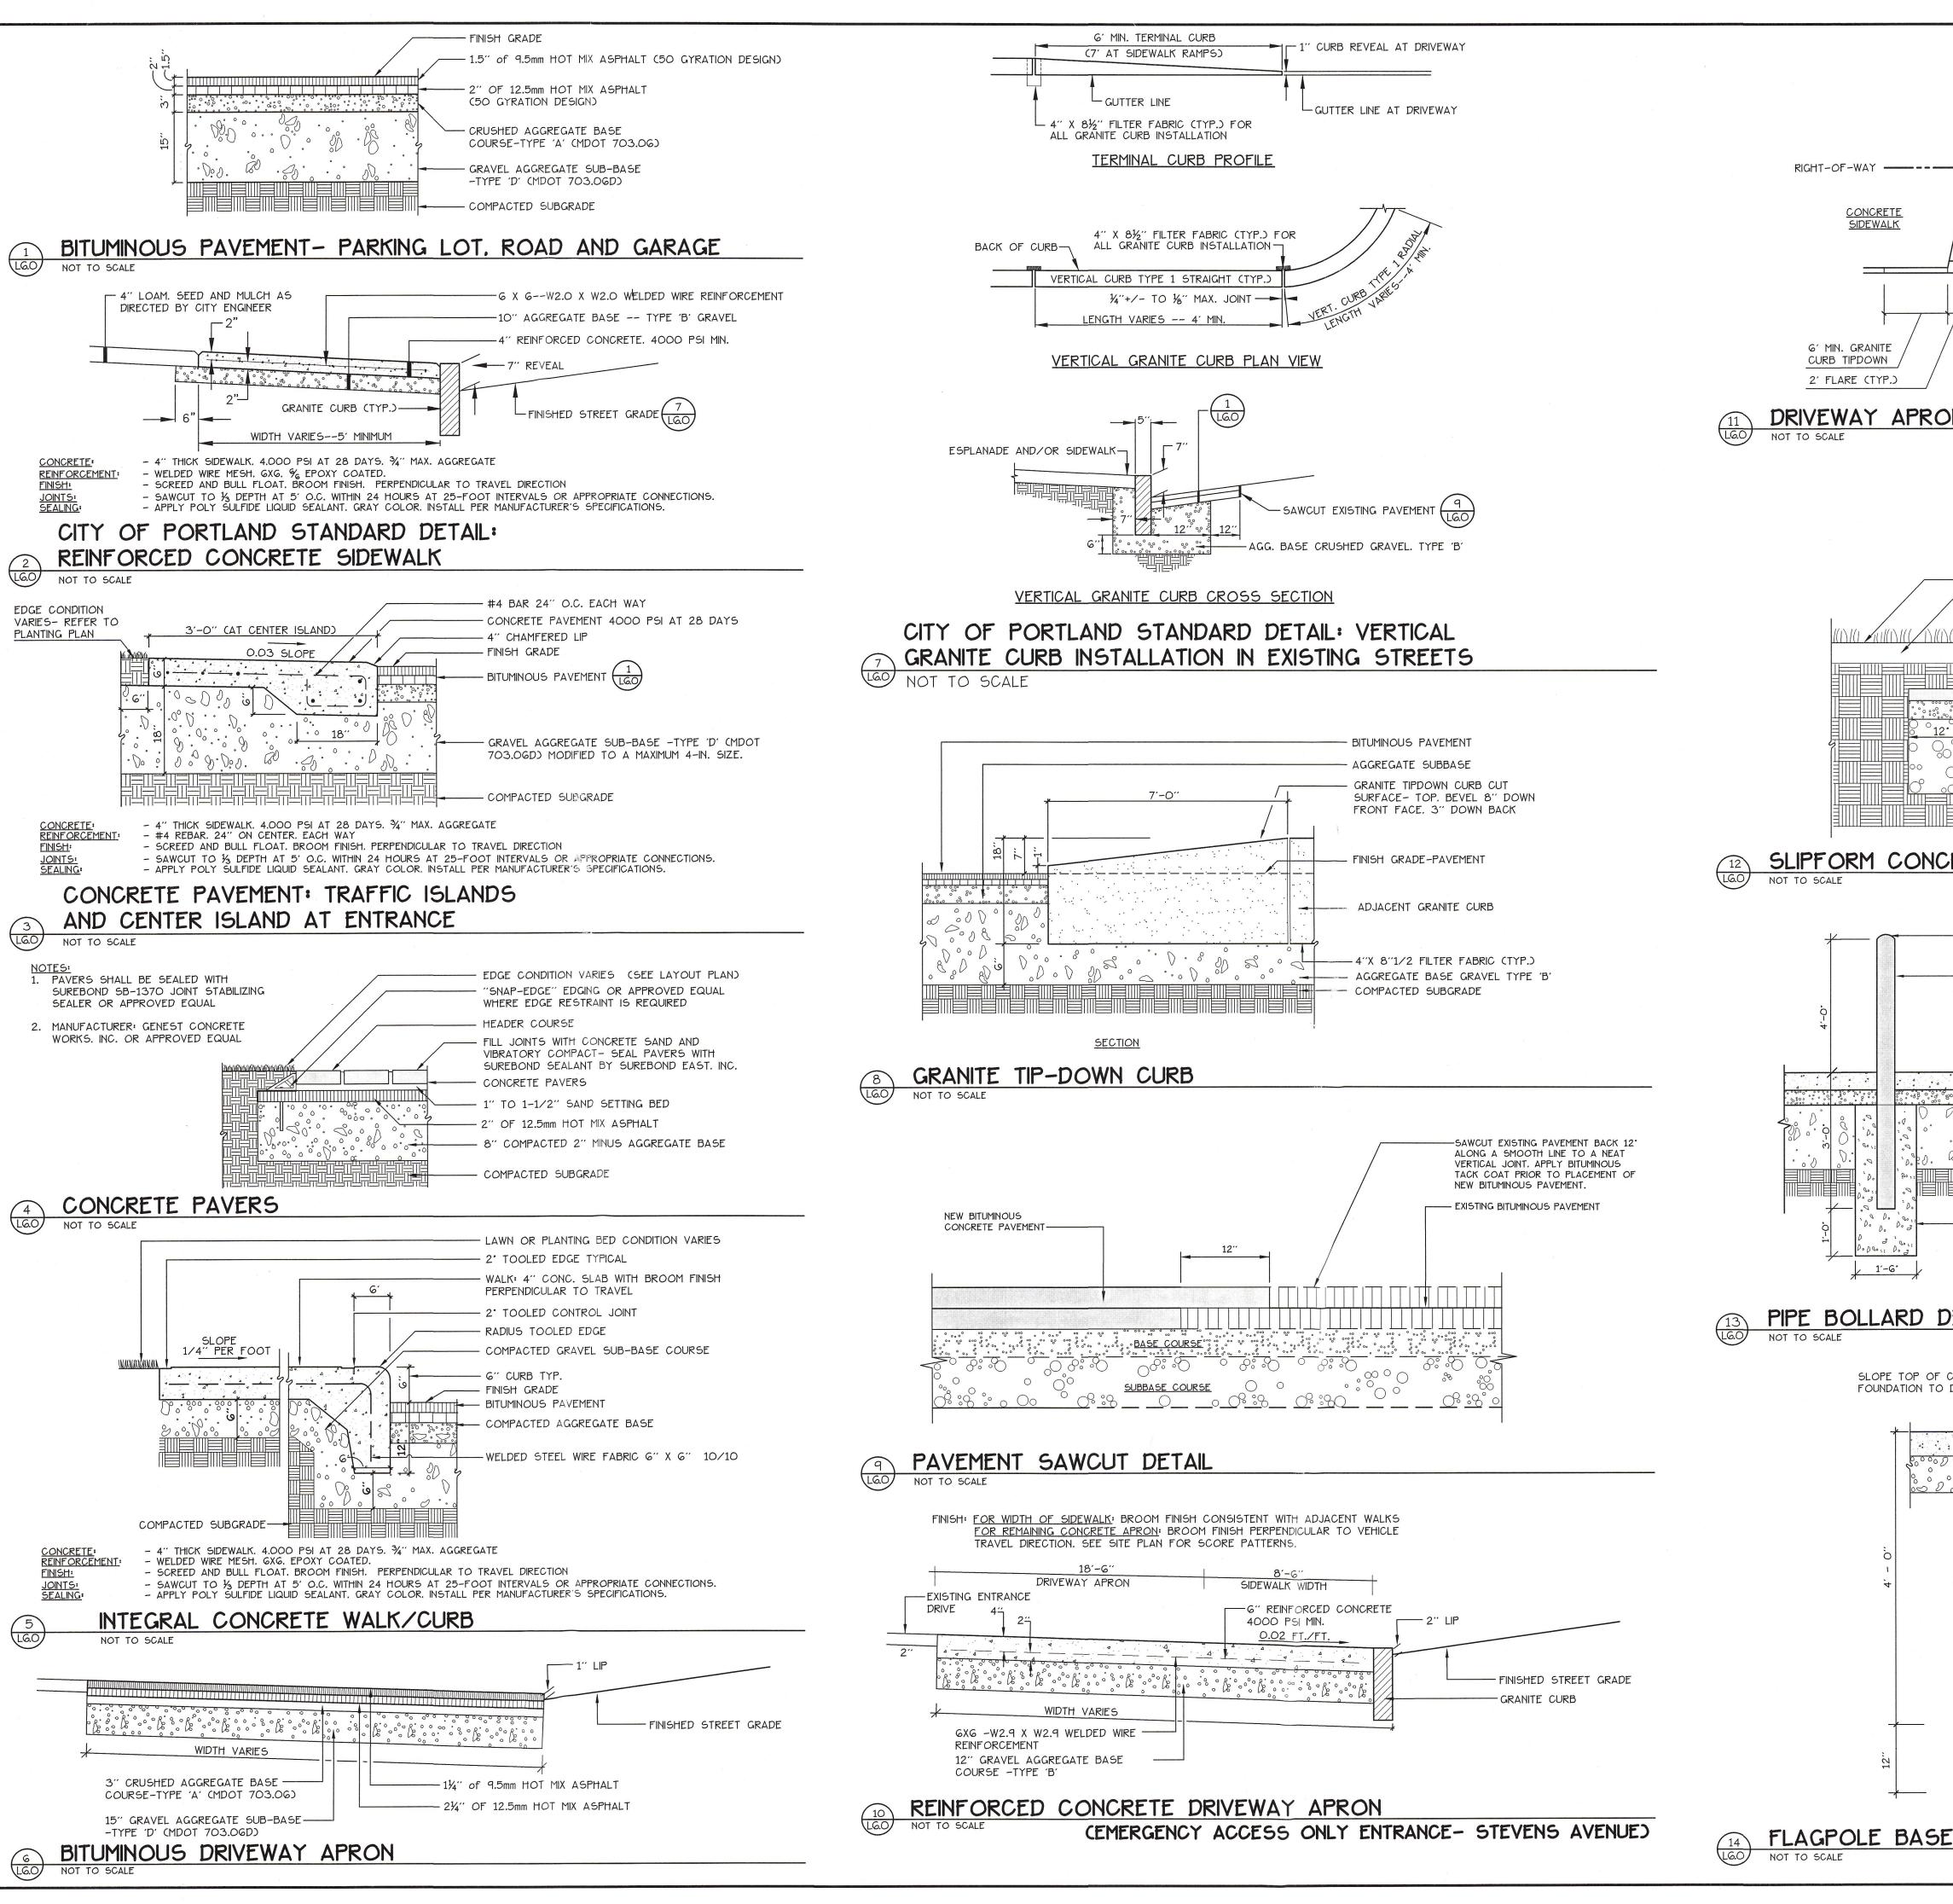


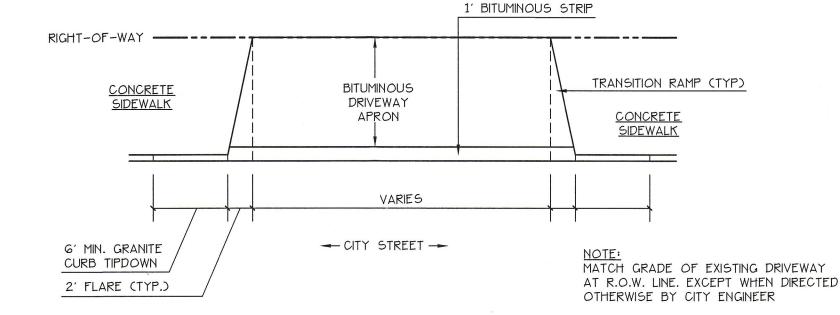


DRIVEWAY APRON LAYOUT

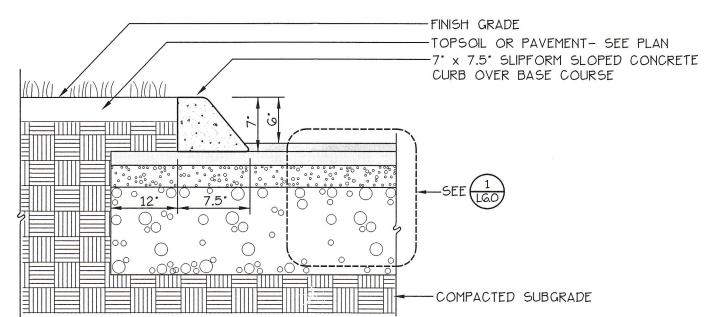

SLIPFORM CONCRETE CURB

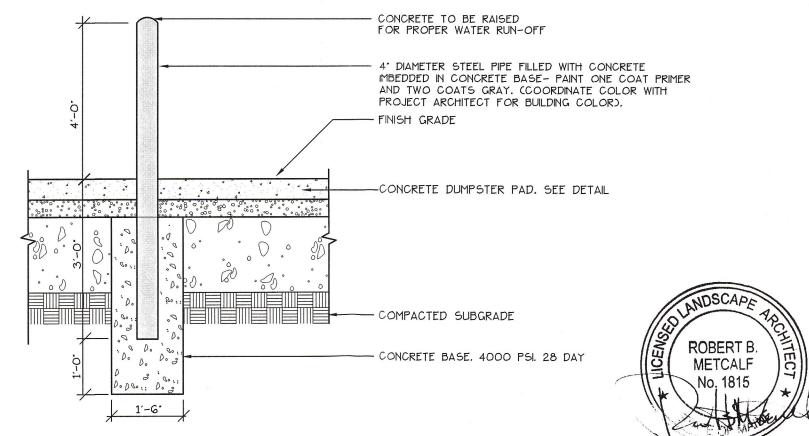

PIPE BOLLARD DETAIL

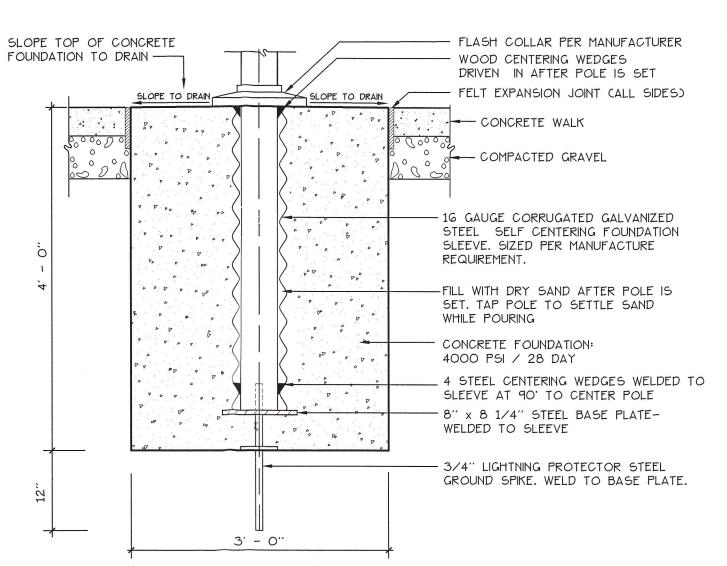


Prepared For: Owner: Home For The Aged 777 Stevens Avenue Portland, Maine 04103 Tel.: 207-797-7710 Applicant: The Park Danforth 777 Stevens Avenue Portland, Maine 04103 Tel.: 207-797-7710 Prepared By: MITCHELL & ASSOCIATES Landscape Architects The Staples School 70 Center Street Portland, Maine 04101


Tel.: 207-774-4427


Q Q

Date: OCTOBER 17, 2014 Issued For: **PERMITTING** Revisions: NOV. 25, 2014: Per City of Portland Staff Review Comment JAN. 5, 2015: Per City of Portland Staff Review Comments APR. 10, 2015: Amended Site Plan and Subdivision Plan Reproduction or reuse of this document without the expressed written consent of Mitchell & Associates is prohibited. © 2015 Title: SITE DETAILS


Scale AS SHOWN Subject to Dept. Conditions Date of Approval. North: Sheet No.:

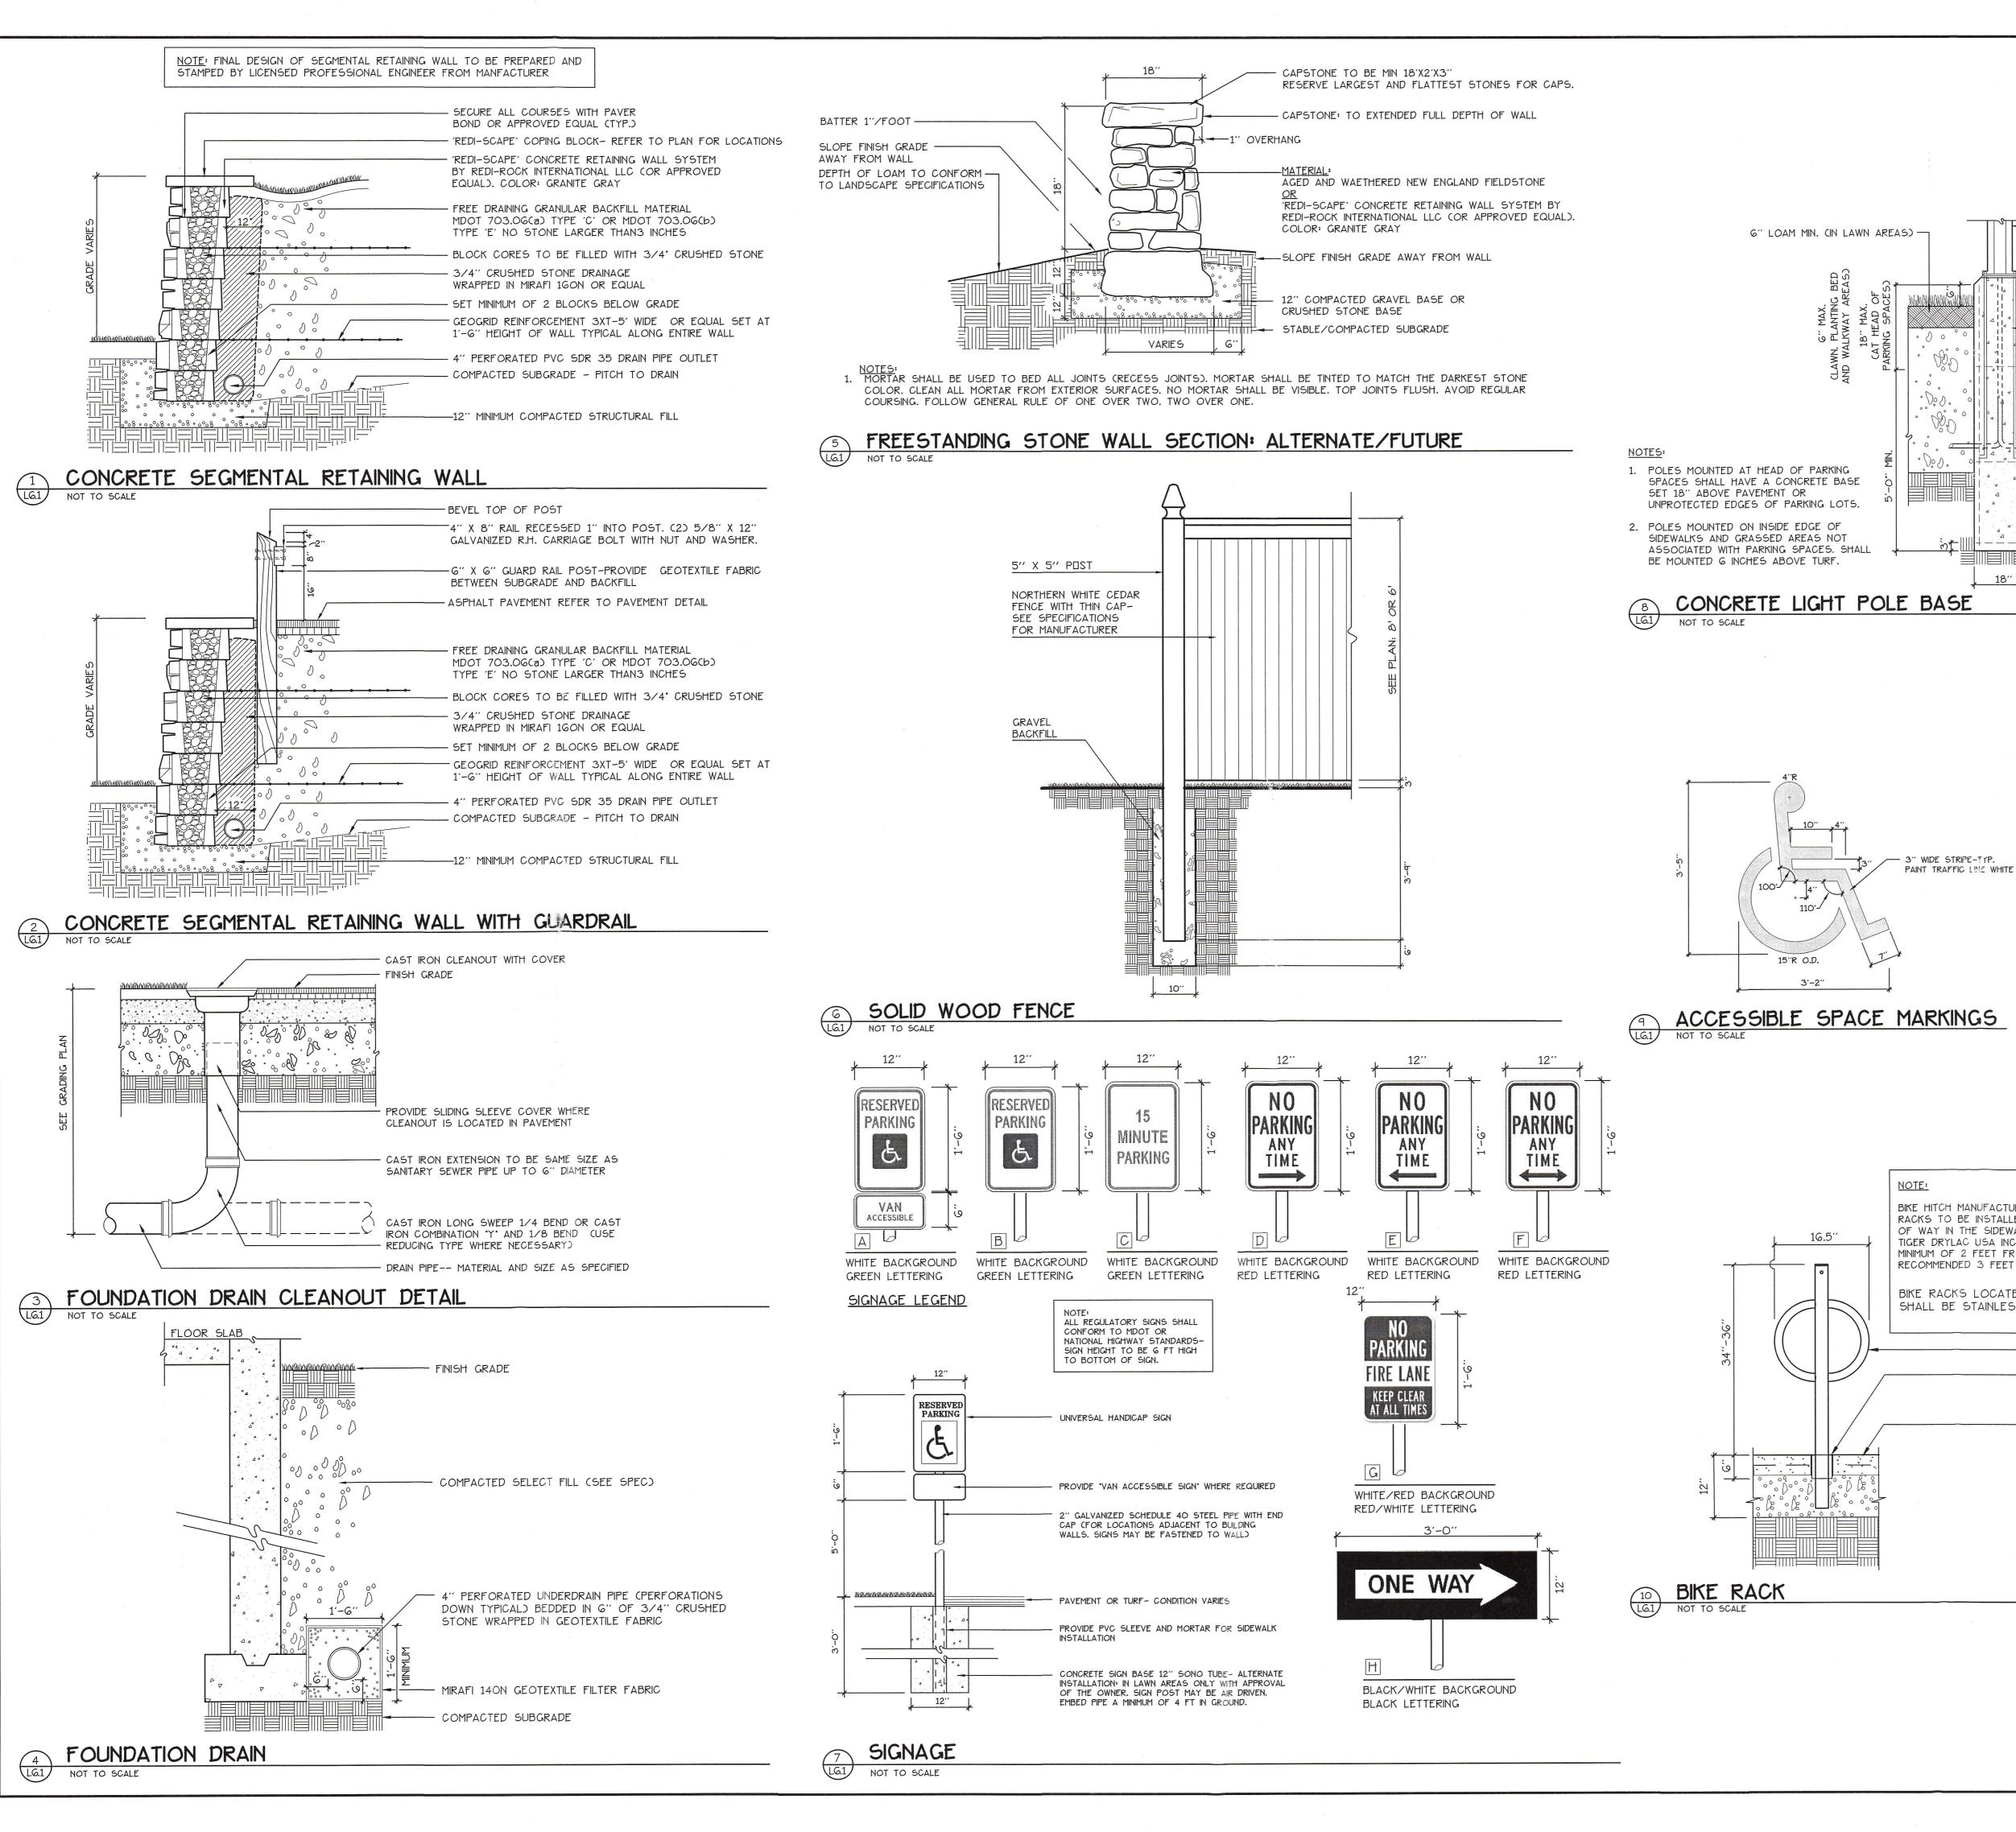


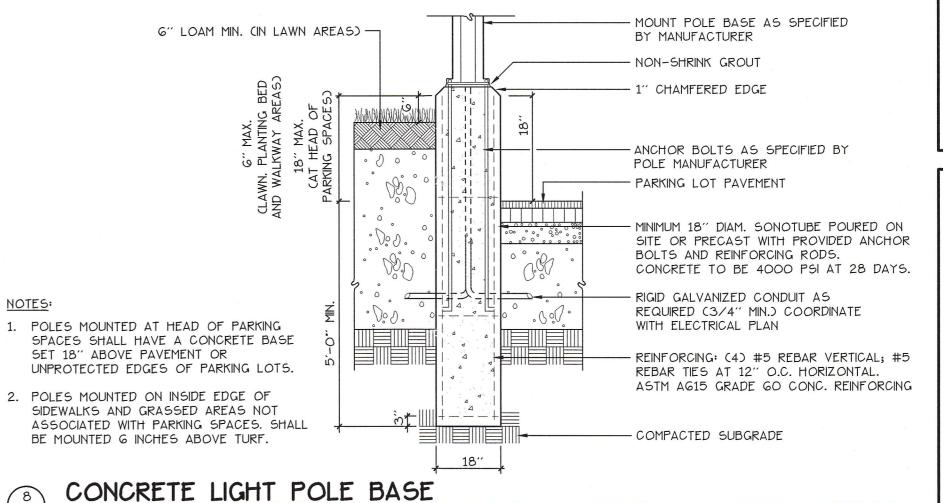

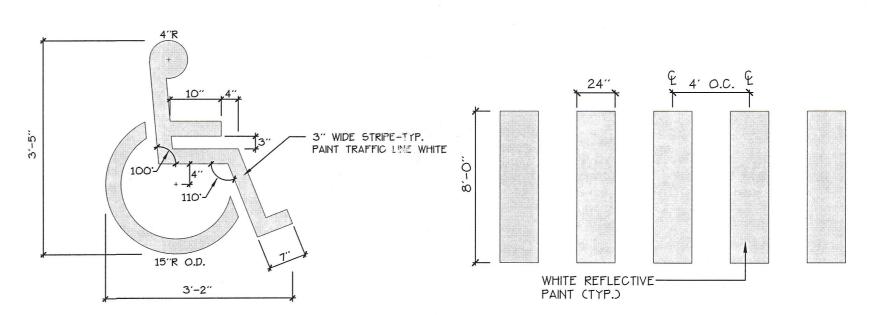


PAINTED CROSSWALK

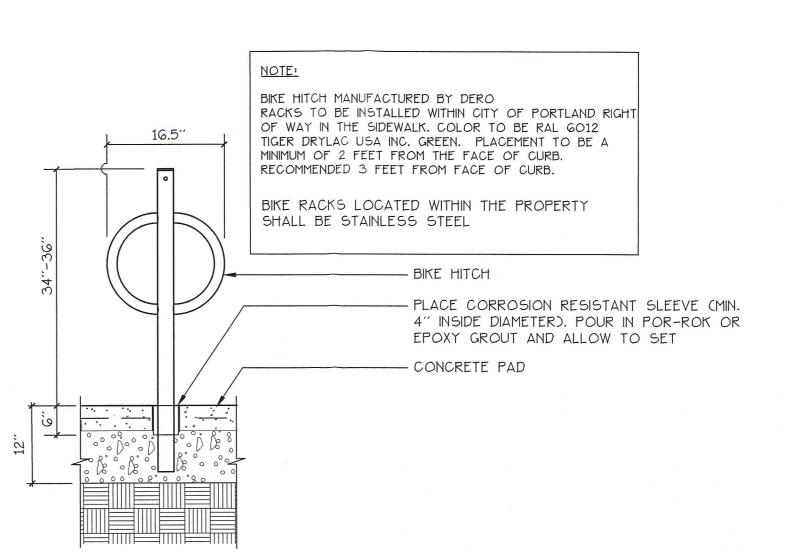

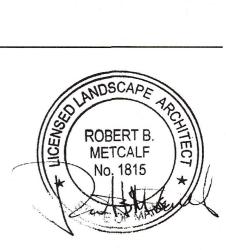





7

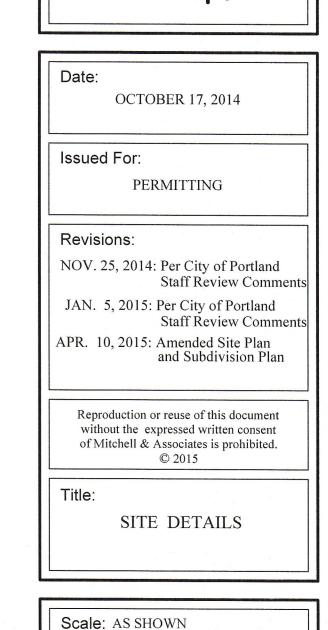

CITY OF PORTLAND APPROVED SITE PLAN Subject to Dept. Conditions North: Sheet No.:

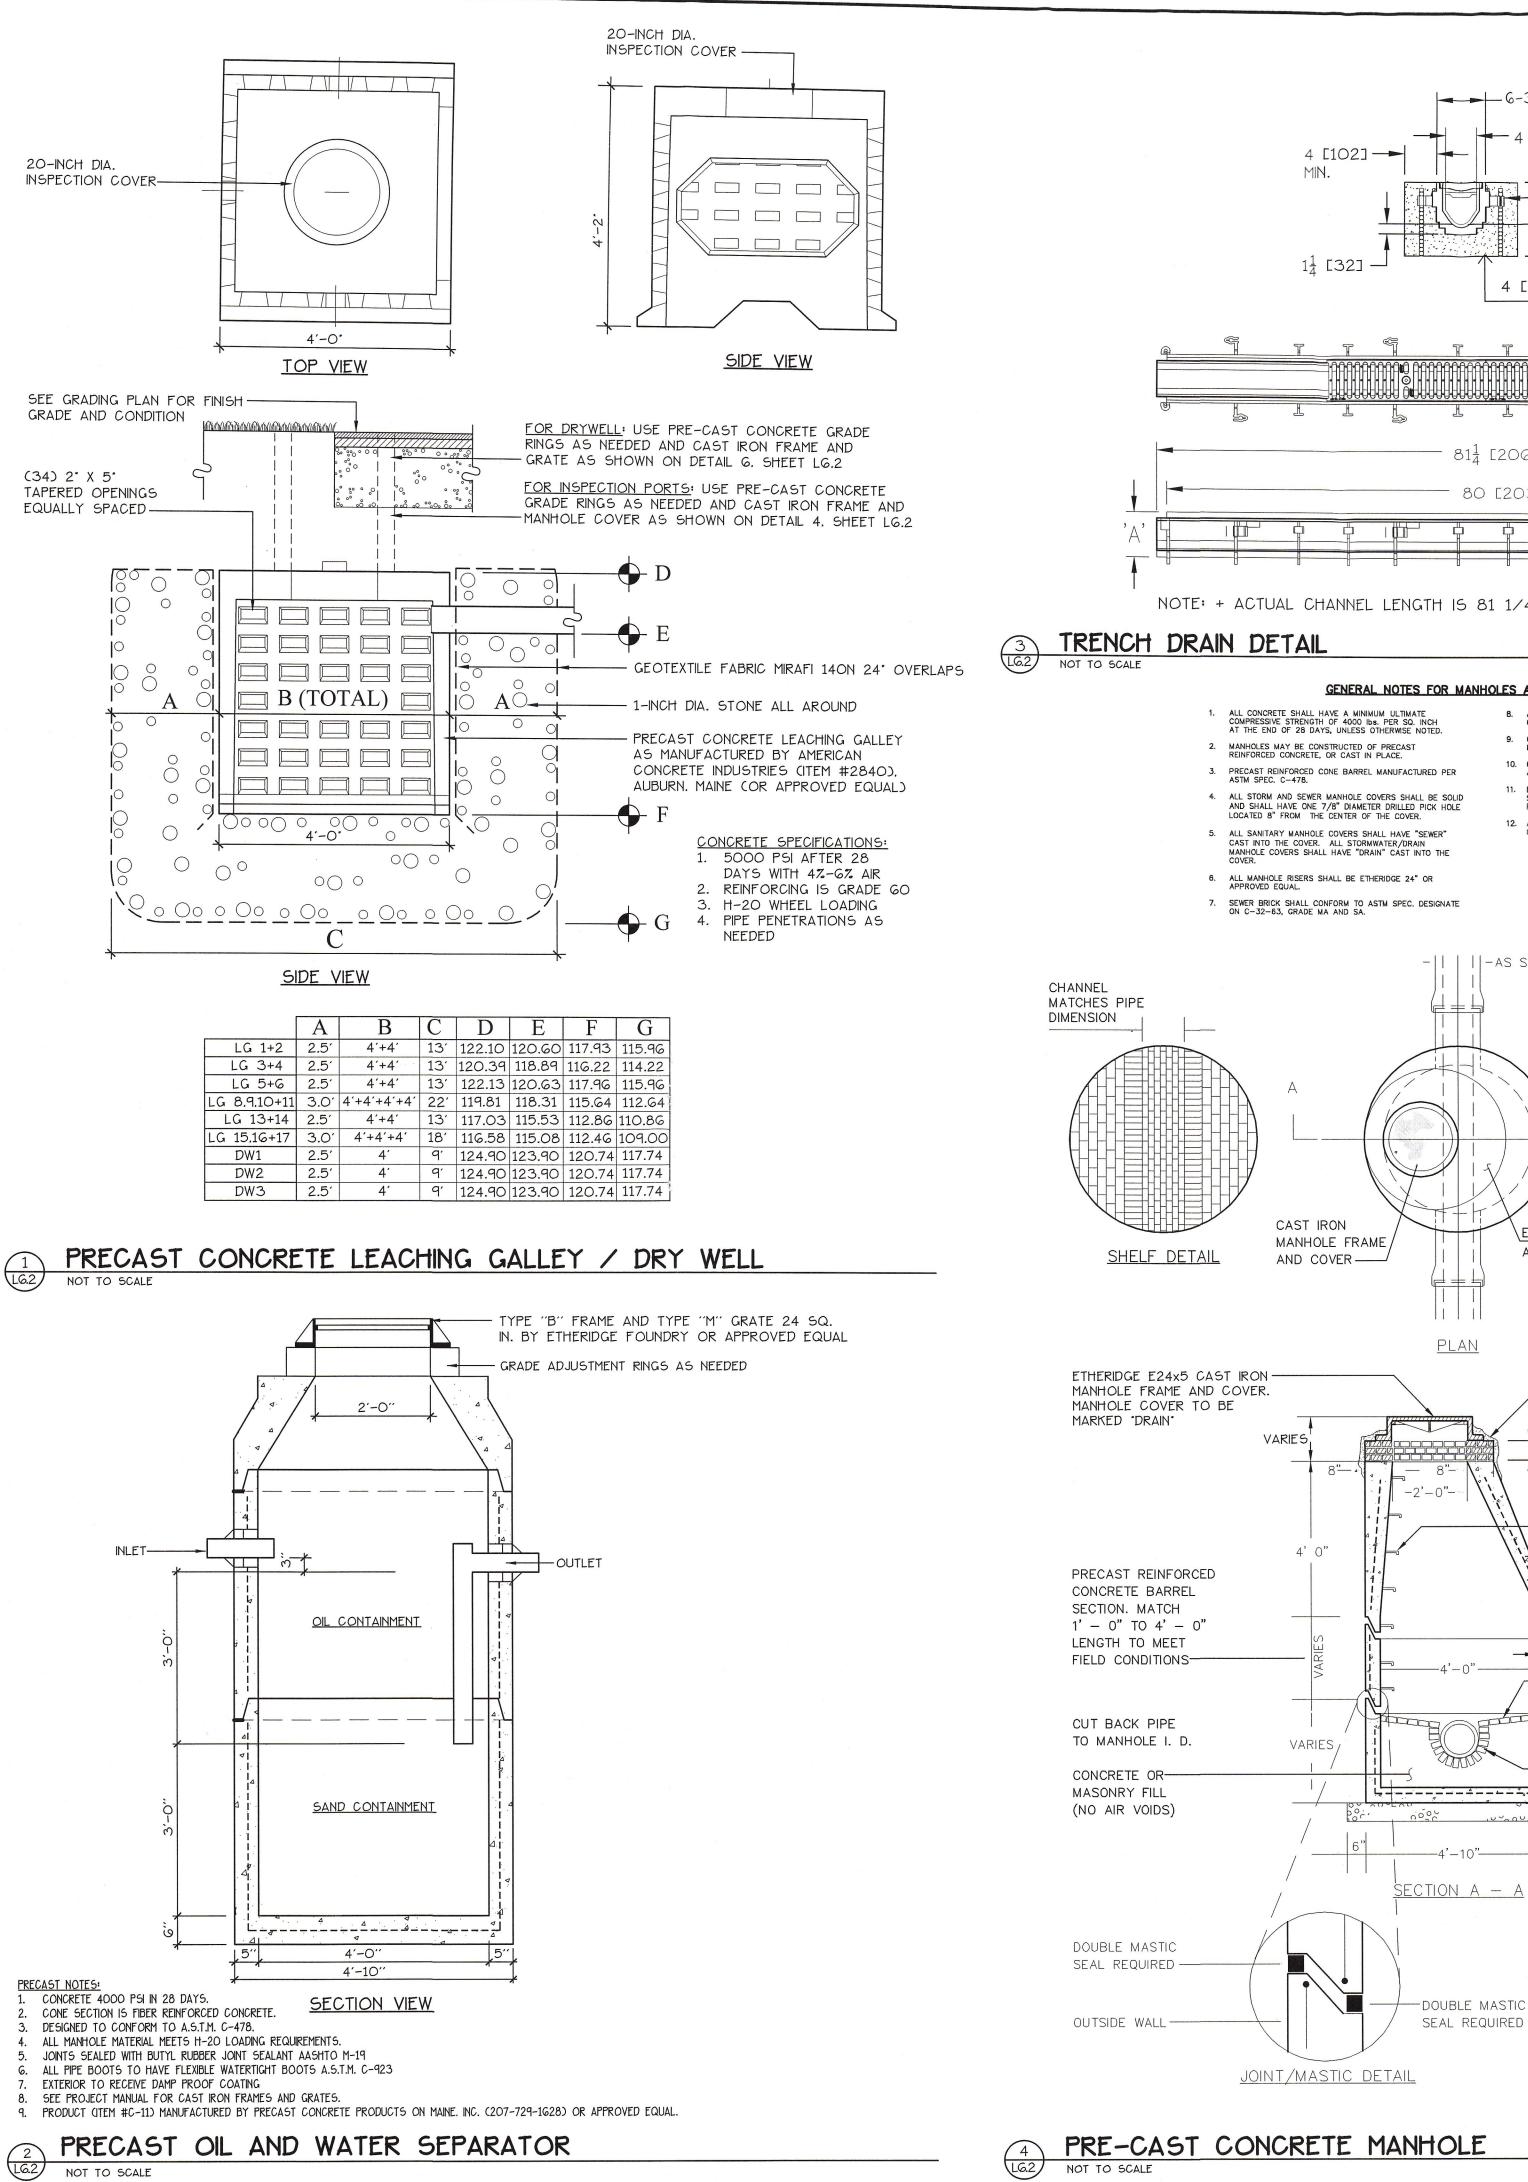

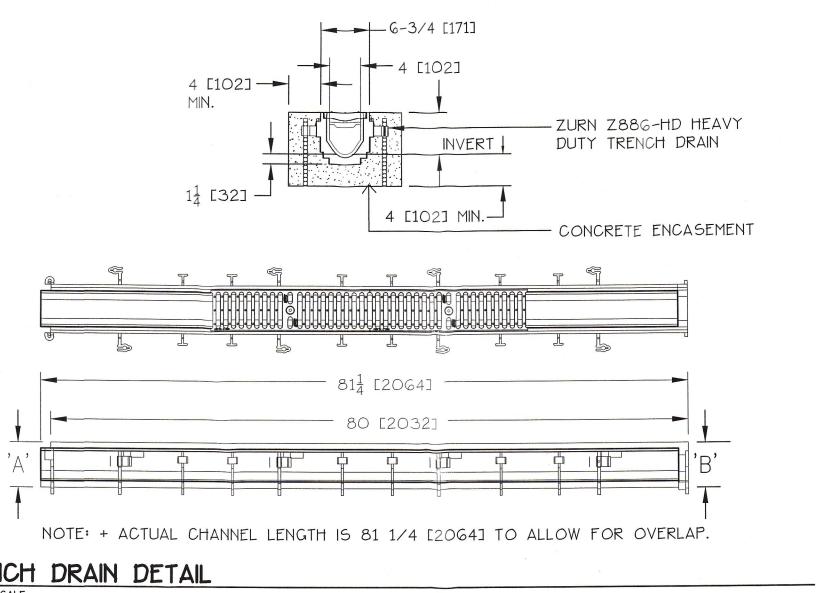

GENERAL NOTES FOR MANHOLES AND CATCH BASINS

ALL CATCH BASIN OUTLETS SHALL BE INSTALLED WITH A CASCO TRAP. SEE FIGURE II—09.


BUILT ON SMOOTH RADIUS.

TO BE SHAPED TO RECEIVE

ADDED SIDE FLOW.


IF SIDE PIPES ENTER, CHANNEL

- CATCH BASIN FRAMES FOR TYPE A4 CATCH BASIN CURB INLETS SHALL BE ETHERIDGE DR5A OR APPROVED EQUAL. 10. CASTINGS SHALL CONFORM TO ASTM DESIGNATION A48-CLASS 35.
- ALL STORM AND SEWER MANHOLE COVERS SHALL BE SOLID AND SHALL HAVE ONE 7/8" DIAMETER DRILLED PICK HOLE LOCATED 8" FROM THE CENTER OF THE COVER.

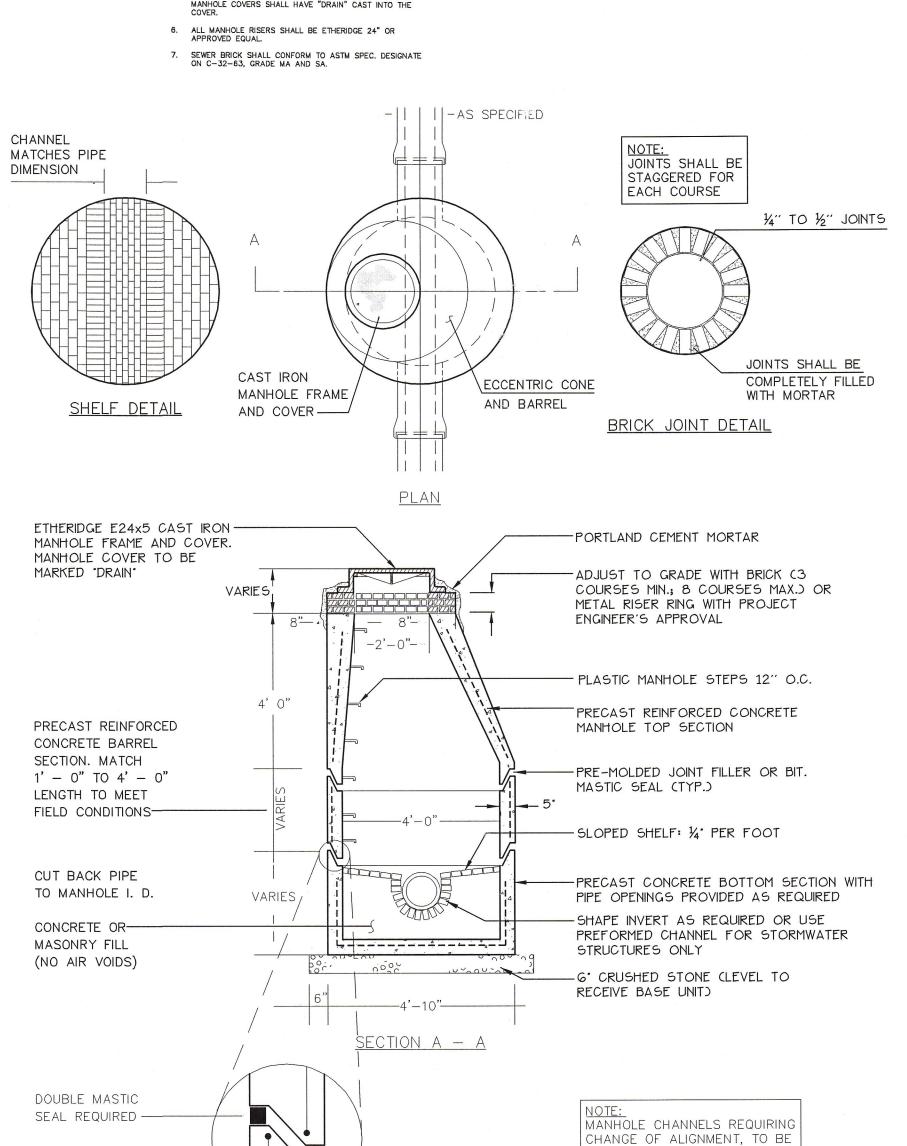


ALL MANHOLE COVERS SHALL BE SOLID AND SHALL HAVE ONE 7/8" DIAMETER DRILLED PICK HOLE, LOCATED 8" FROM THE CENTER OF THE COVER. ALL SANITARY MANHOLE COVERS SHALL HAVE "SEWER" CAST INTO THE COVER. ALL STORMWATER/DRAIN MANHOLE COVERS SHALL HAVE "DRAIN" CAST INTO THE COVER. 7/8" DIA. PICK HOLE NAMOND DESIGN SURFACE COVER **FRAME** PLAN VIEW PLAN VIEW ---24 1/8"---- 24° DIA. 8"-SECTION A - A MIN. WGT. 320 LBS. **COVER** SECTION B - B

CAST IRON MANHOLE COVER AND FRAME NOT TO SCALE

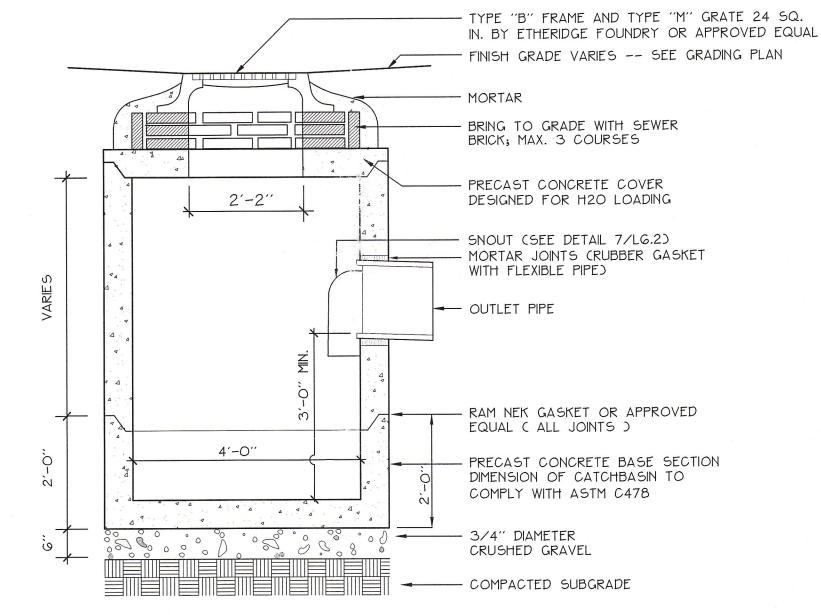

FRAME

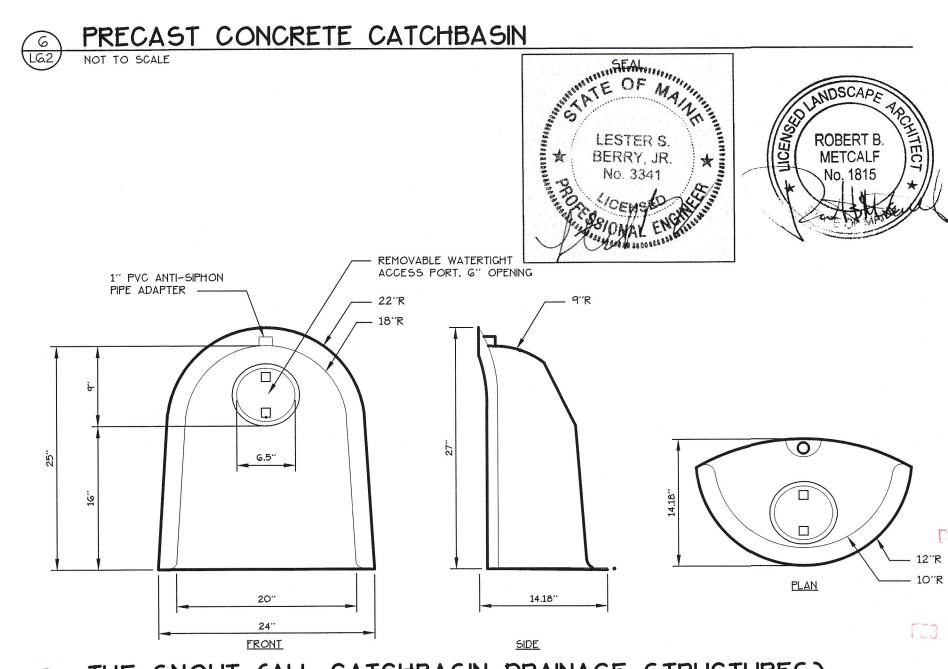

THE SNOUT (ALL CATCHBASIN DRAINAGE STRUCTURES) LG.2 NOT TO SCALE

Prepared For: Owner: Home For The Aged 777 Stevens Avenue Portland, Maine 04103 Tel.: 207-797-7710 Applicant: The Park Danforth 777 Stevens Avenue Portland, Maine 04103 Tel.: 207-797-7710 Prepared By: MITCHELL & ASSOCIATES Landscape Architects The Staples School 70 Center Street

Portland, Maine 04101 Tel.: 207-774-4427

ortla

Date: OCTOBER 17, 2014

> Issued For: PERMITTING

Revisions:

NOV. 25, 2014: Per City of Portland Staff Review Comments JAN. 5, 2015: Per City of Portland Staff Review Comments APR. 10, 2015: Amended Site Plan

Reproduction or reuse of this document without the expressed written consent

and Subdivision Plan


of Mitchell & Associates is prohibited. © 2015

SITE DETAILS


Scale: AS SHOWN APPROVED SITE PLAN ubject to Dept. Conditions

North:

Sheet No.:

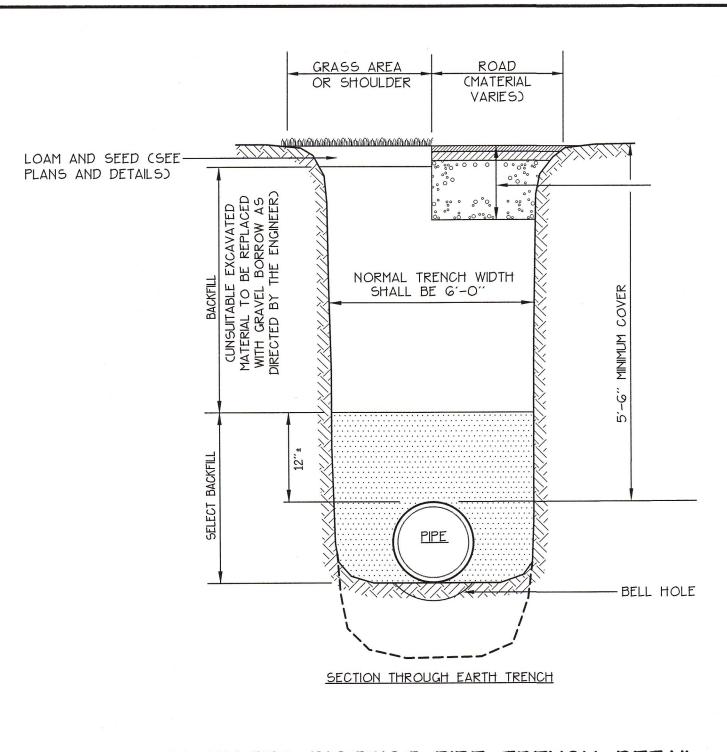


PORTLAND WATER DISTRICT PIPE TRENCH DETAIL NOT TO SCALE

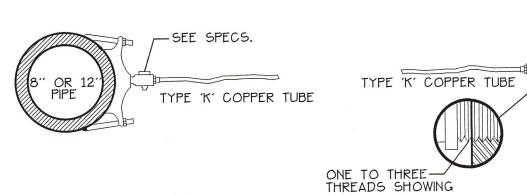


(1-1/2" + 2" C.C. OR IRON PIPE THREAD)

(3/4" AND 1" C.C. THREAD)

SERVICE CONNECTIONS (DIRECT TAPS AND SERVICE CLAMPS) WILL BE INSTALLED SO THAT THE OUTLET IS AT AN ANGLE OF NOT MORE THAN 45' ABOVE THE HORIZONTAL. ALWAYS PUT A BEND OR 'GOOSENECK' IN THE SERVICE LINE PRIOR TO CONNECTING TO PROVIDE FLEXIBILITY AND "GIVE" TO COUNTERACT THE EFFECTS OF A LOAD DUE TO SETTLEMENT OR EXPANSON AND/OR CONTRACTION (SEE DETAILS).

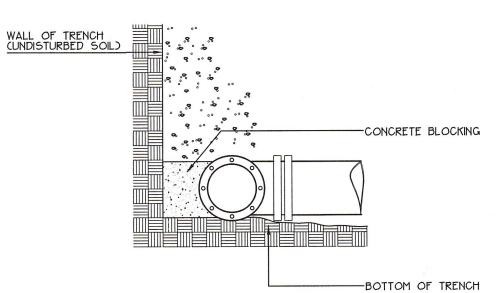


ELEVATION

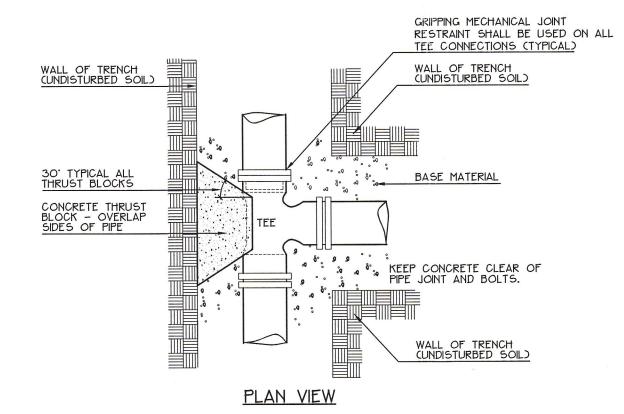

. INSTALL POLY BARRIER BETWEEN PIPE AND ALL THRUST BLOCKS. ANY MODIFICATION TO THRUST BLOCK SIZING OR PIPE RESTRAINT REVISIONS SHALL BE APPROVED IN WRITING BY THE LANDSCAPE ARCHITECT PRIOR TO 3. ANY WORK RELATING TO WATER PIPING OF DETAILS SHALL BE IN ACCORDANCE WITH THE PORTLAND WATER DISTRICT SPECIFICATIONS.

BEA	RING SURFA	ACE REQUI	RED IN SQ	UARE FEET	
PIPE SIZE	1/32 BEND	1/16 BEND	1/8 BEND	1/4 BEND	TEES/CAPS
6.	1.0	1.5	2.5	4.5	3.5
8'	1.5	2.5	4.5	8.0	5.5

STANDARD TEE BLOCKING

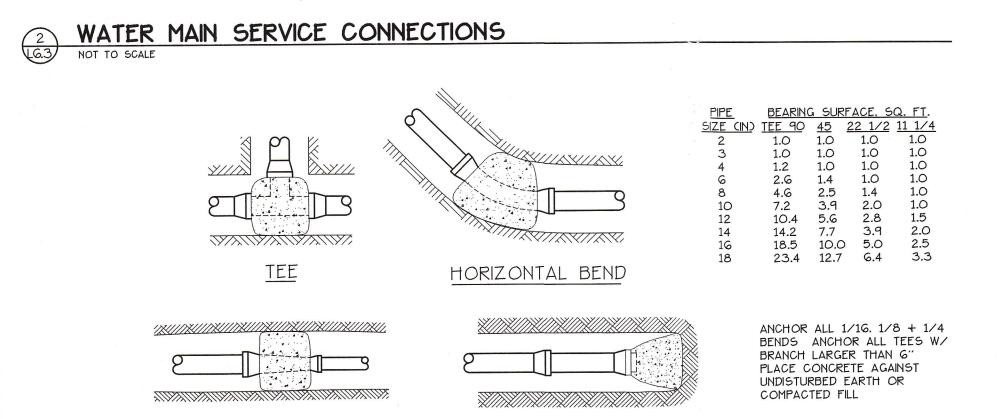


<u>PLUG</u>


- SPACER 5' O.C.


WATER MAIN ANCORAGE DETAILS

TELEPHONE / CABLE T.V.

REDUCER

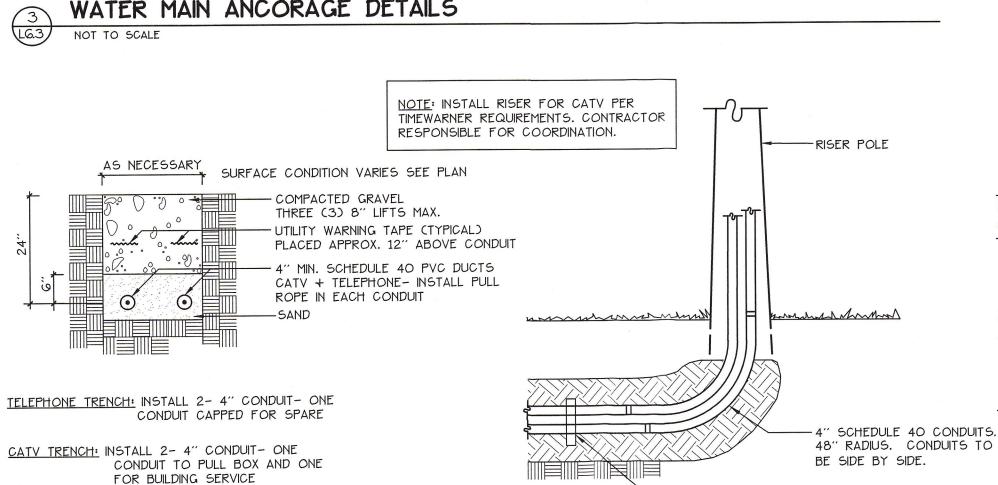

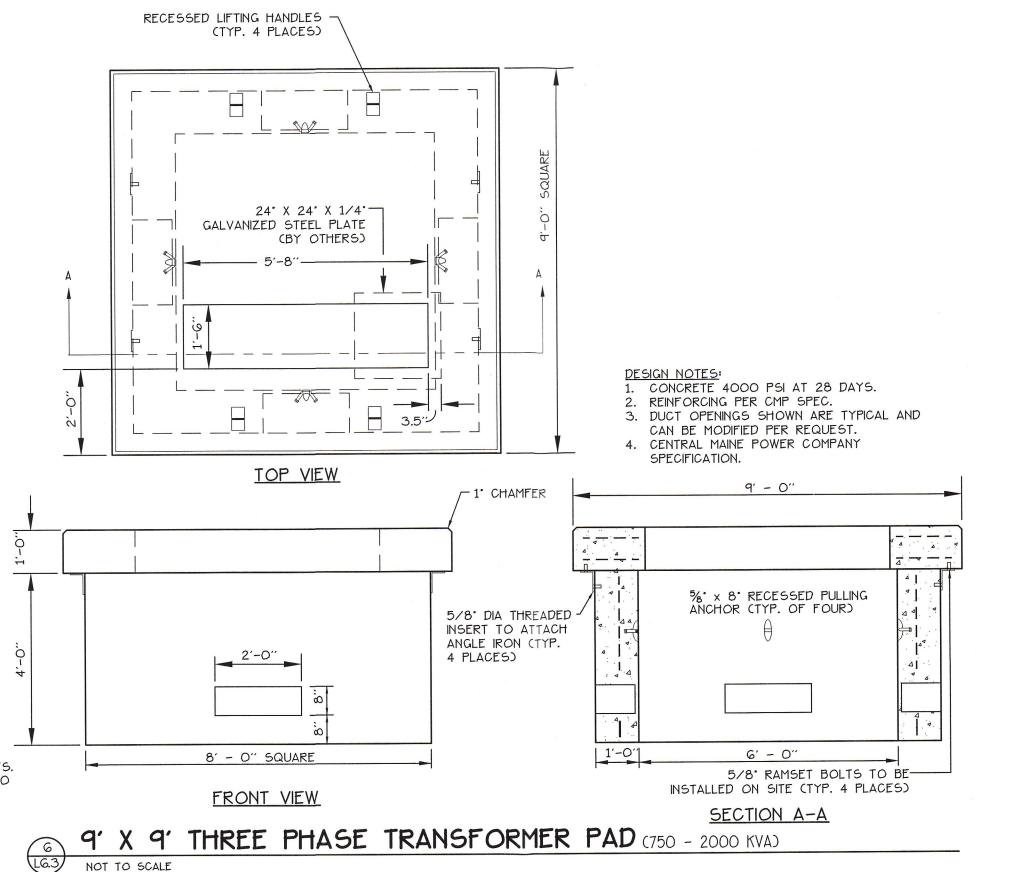


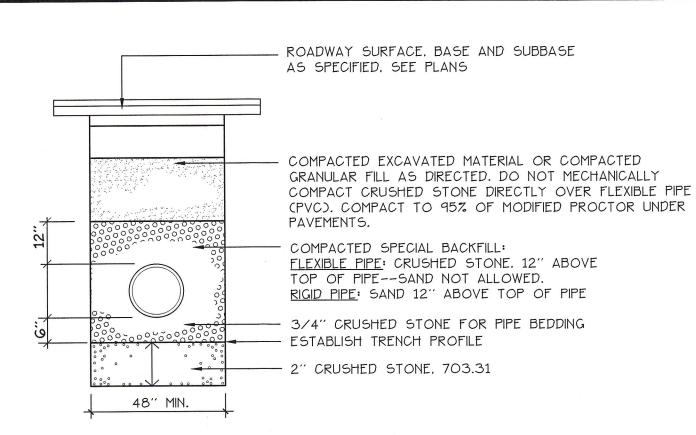


1. ANY ALTERNATE TRENCHING METHODS SHALL BE APPROVED IN ADVANCE BY THE CITY. 2. ALL TRENCH DIMENSIONS SHALL BE IN CONFORMANCE WITH THE CITY OF PORTLAND'S

DETAIL FIGURE 11-12 OF THE TECHNICAL AND DESIGN STANDARDS AND GUIDELINES.

PIPE TRENCH DETAIL

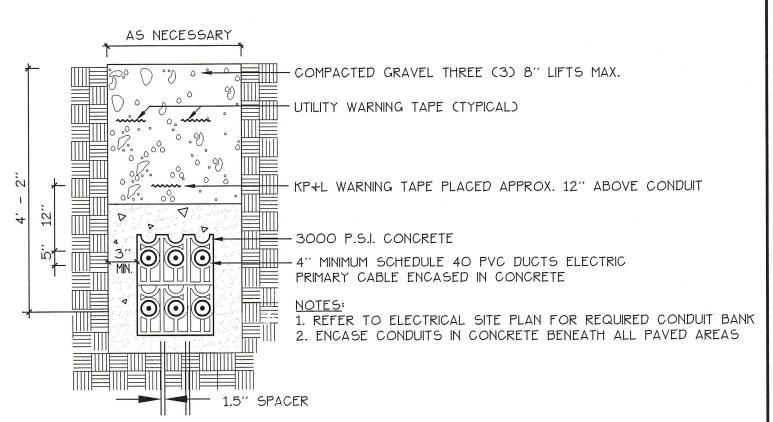




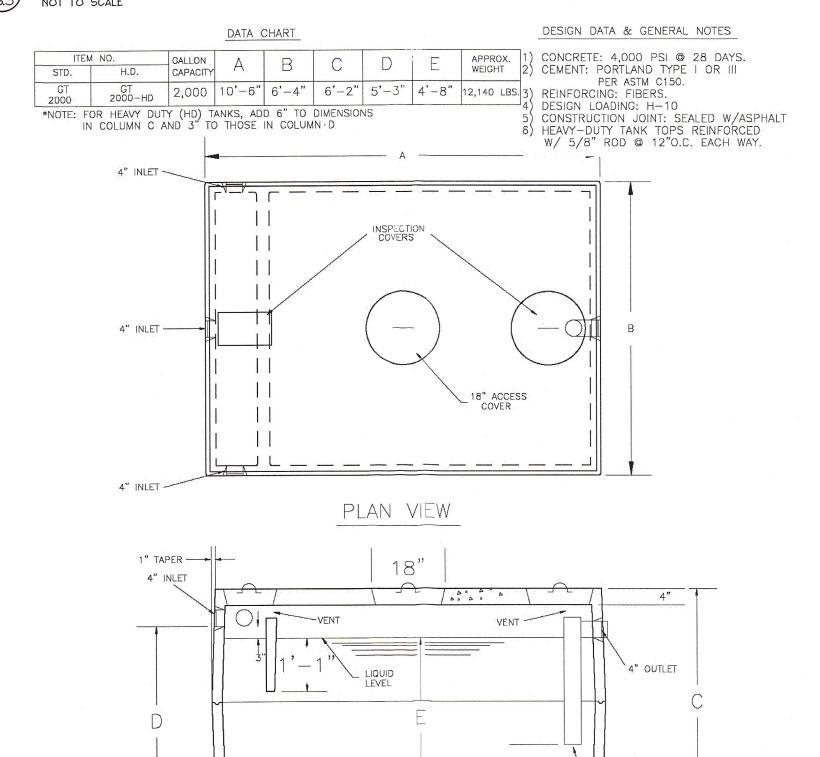

REPLACEMENT 2000 GALLON GREASE TRAP

SIDE ELEV. VIEW SECTIONED

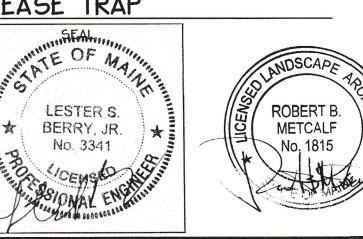

1'-0"

Prepared For: Owner:

Home For The Aged 777 Stevens Avenue Portland, Maine 04103

Tel.: 207-797-7710 Applicant: The Park Danforth

Portland, Maine 04103 Tel.: 207-797-7710

777 Stevens Avenue

Prepared By: MITCHELL & ASSOCIATES Landscape Architects The Staples School 70 Center Street

Portland, Maine 04101 Tel.: 207-774-4427

Q


OCTOBER 17, 2014


Date:


Issued For: **PERMITTING** Revisions: NOV. 25, 2014: Per City of Portland Staff Review Comments JAN. 5, 2015: Per City of Portland Staff Review Comments APR. 10, 2015: Amended Site Plan and Subdivision Plan Reproduction or reuse of this document without the expressed written consent of Mitchell & Associates is prohibited. © 2015

SITE DETAILS

Scale: AS SHOWN North: Sheet No.:

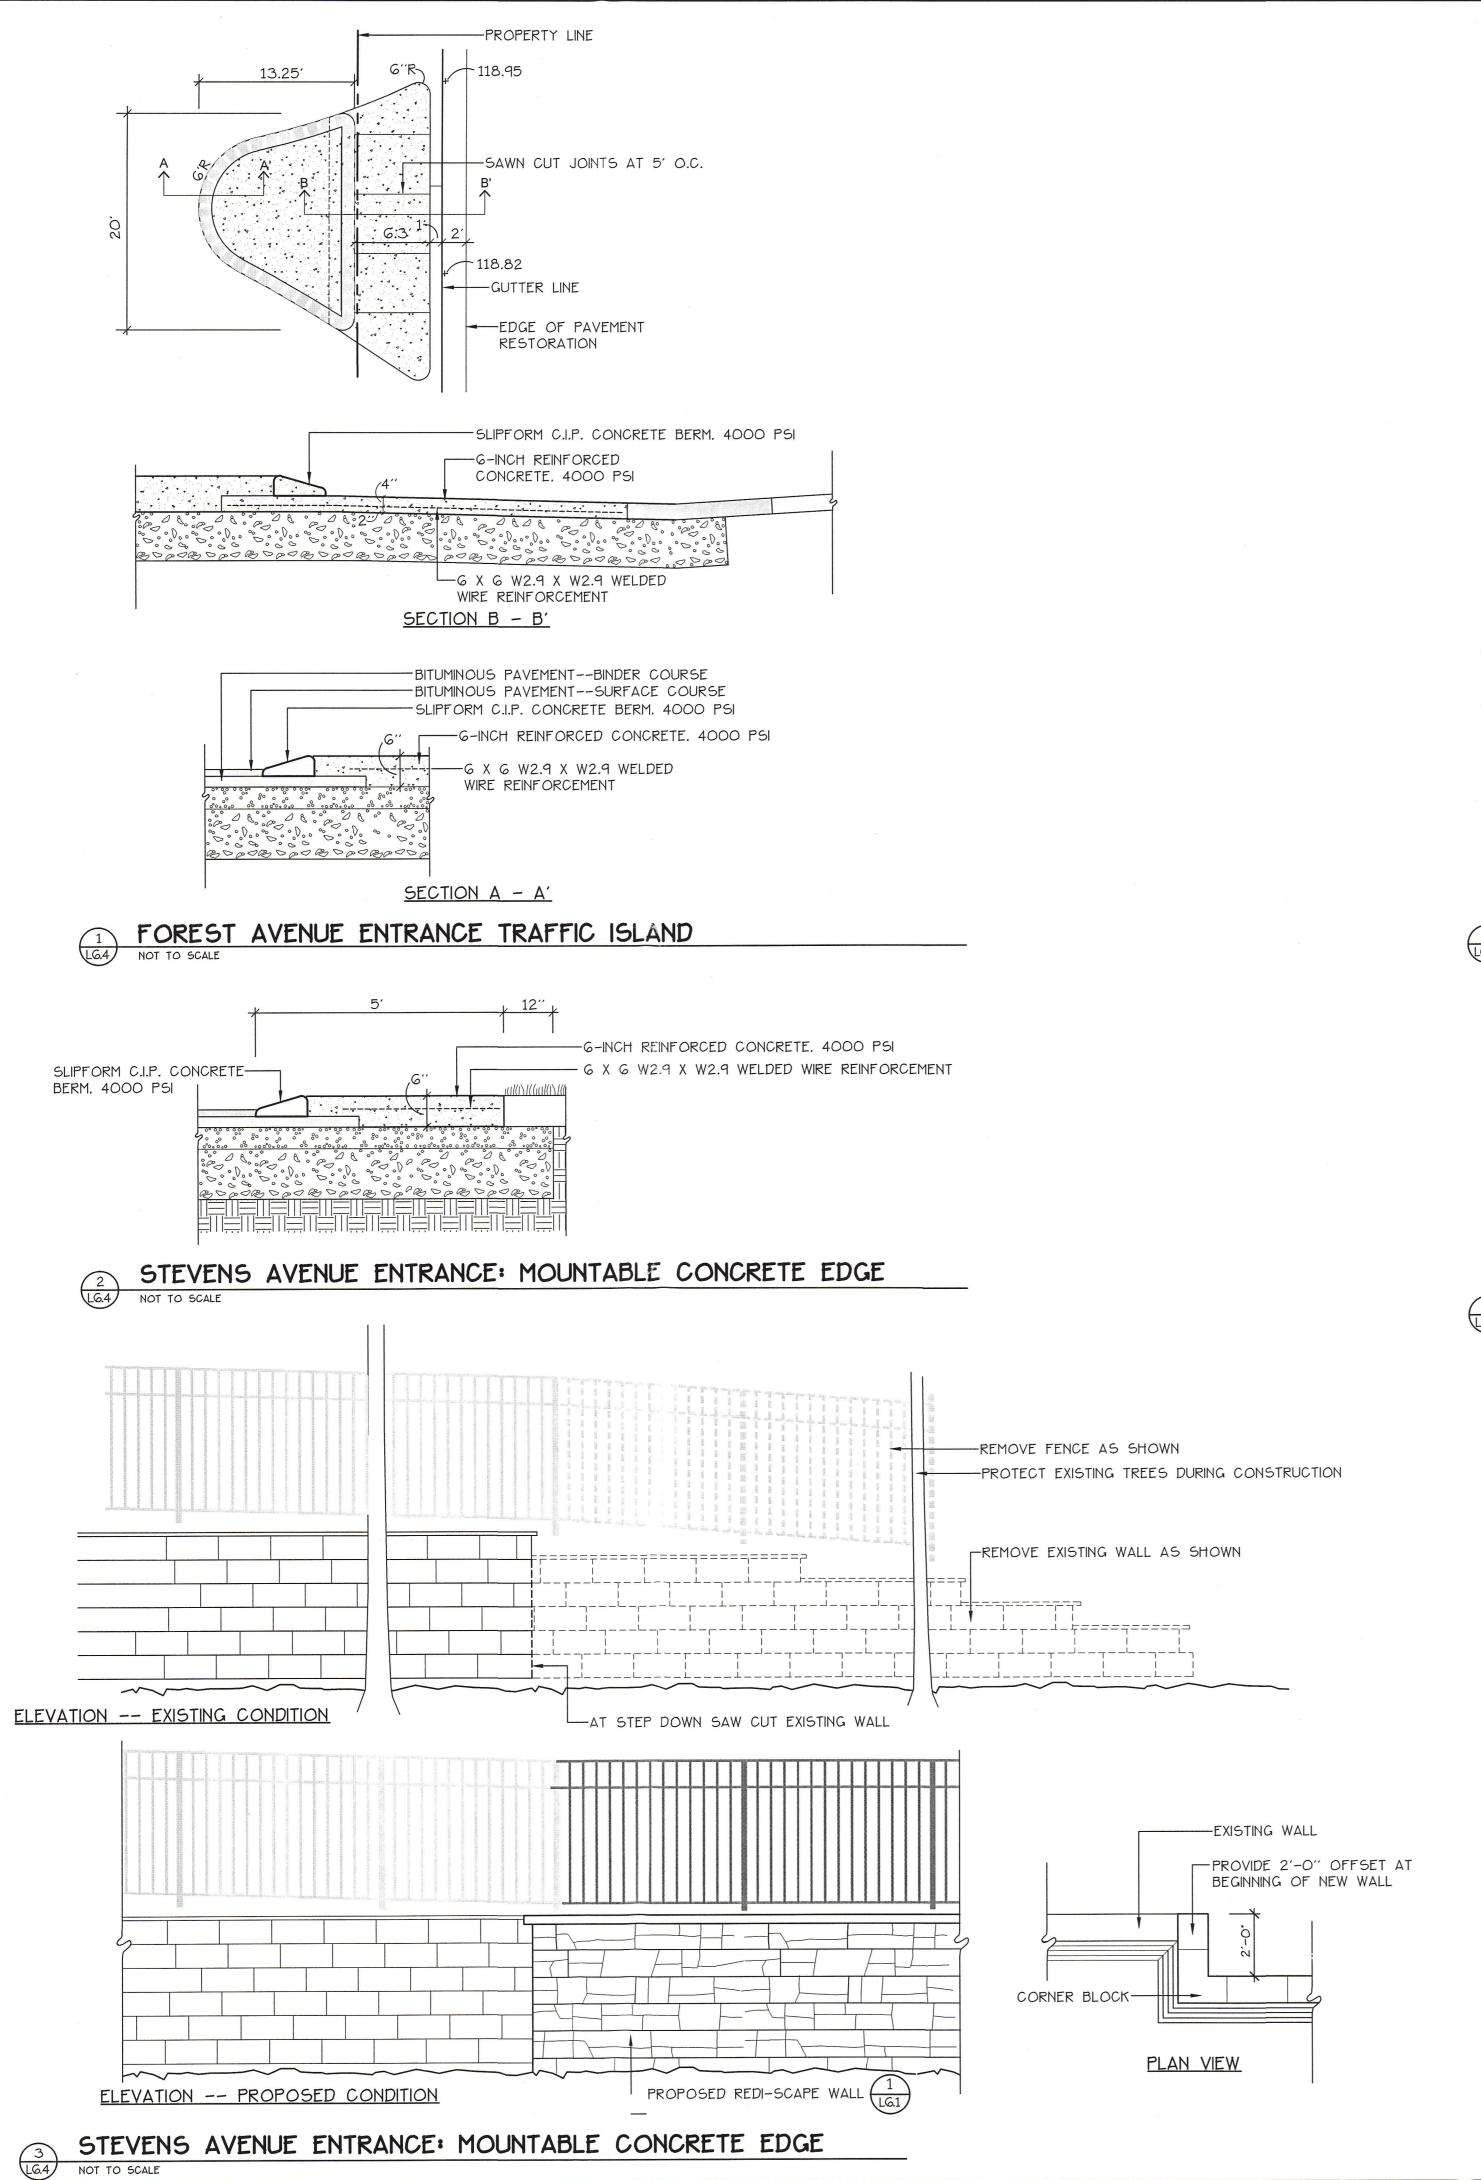

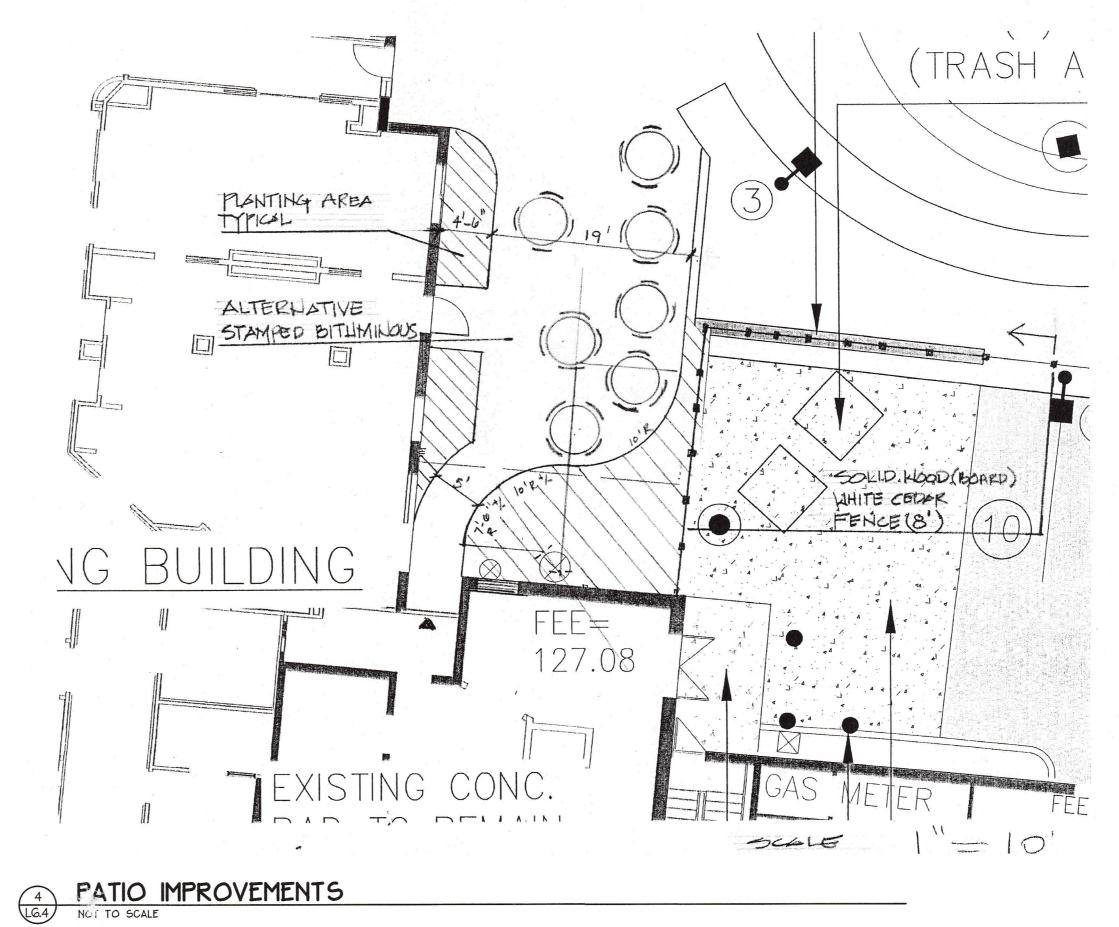

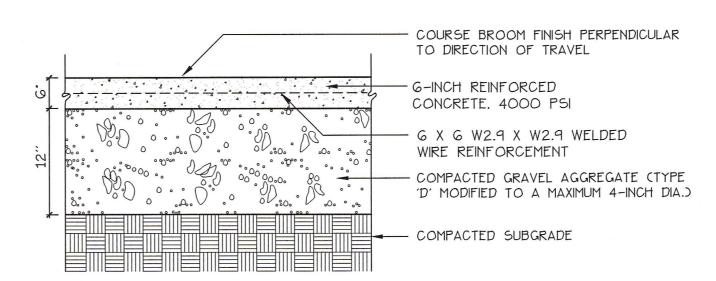

CONCRETE PAD (DUMPSTER AND GENERATOR)

Q

Prepared For:

Home For The Aged 777 Stevens Avenue Portland, Maine 04103 Tel.: 207-797-7710

The Park Danforth 777 Stevens Avenue Portland, Maine 04103 Tel.: 207-797-7710

Owner:

Applicant:

Prepared By:

Landscape Architects

The Staples School 70 Center Street Portland, Maine 04101

Tel.: 207-774-4427

MITCHELL & ASSOCIATES

ortla

venue

Stev

Date: OCTOBER 17, 2014

Revisions:

Issued For:

NOV. 25, 2014: Per City of Portland Staff Review Comments JAN. 5, 2015: Per City of Portland

PERMITTING

Staff Review Comments APR. 10, 2015: Amended Site Plan and Subdivision Plan

Reproduction or reuse of this document without the expressed written consent of Mitchell & Associates is prohibited. © 2015

SITE DETAILS

ROBERT B. METCALF No. 1815

Scale: AS SHOWN North: Sheet No.:

Label	Avg	Max	Min	Avg/Min	Max/Min
Courtyard	0.46	3.4	0.0	N.A.	N.A.
FULL SITE	0.86	3.9	0.0	N.A.	N.A.
OFF PROPERTY	0.05	2.9	0.0	N.A.	N.A.
Parking Lot	1.16	3.4	0.2	5.80	17.00
PROPERTY LINE	0.16	2.6	0.0	N.A.	N.A.

Type	Symbol	Qty	Lum. Lum	ens LLF	Lum. Watts	Description
1		3	7615	0.850	90	VPS-30NB-90-T5W
2A		5	5580	0.850	90	VPS-30NB-90-BLC
3	+	5	933	0.850	20.6	PKWS-18LED-BW
4	+	12	324	0.850	8.2	PKWB-6LED-BW
E	\odot	7	773	0.900	14.6	1020-B1-10-LRTD4-9014-M2-30KS-80-NCSM
ED	\odot	7	773	0.600	14.6	dim 60 1020-B1-10-LRTD4-9014-M2-30KS-80
2L		2	6422	0.850	70	30NB-70-T3-4K
2AL		13	4852	0.850	70	VP-S/30NB-70/BLC/4K
BA	•	23	161	0.900	4.1	ME-3LED-WW
D	+	15	87	0.900	4.4	MSLHL30K8 WH
FL	0	2	3713	0.900	58	cdt/24nb/55/3k/2x2/unv

NOTES:
1) EXACT MOUNTING DETAILS TO BE DETERMINED AT JOBSITE BY OTHERS.
2) CALCULATIONS MAY SHOW THE EFFECT OF SHADOWING CAUSED BY BUILDINGS AN
OBJECTS WITHIN THE CALCULATED SPACE OR IN THE SITE AREA.

OBJECTS WITHIN THE CALCULATED SPACE OR IN THE SITE AREA.


3) READINGS SHOWN ARE INITIAL HORIZONTAL FOOTCANDLES TAKEN AS SHOWN IN CALCULATION SUMMARY UNLESS OTHERWISE INDICATED.

4) THIS CALCULATION IS BASED ON LIMITED INFORMATION SUPPLIED BY OTHERS TO SWANEY LIGHTING ASSOCIATES AND STANDARD ASSUMPTIONS OF THE SPACE AND/OR SITE.
5) CONFORMANCE TO CODES AND OTHER LOCAL REQUIREMENTS AS DETERMINED BY THE AHJ ARE THE RESPONSIBILITY OF THE OWNER AND/OR THE OWNER'S REPRESENTATIVE.

ARE THE RESPONSIBILITY OF THE OWNER AND/OR THE OWNER'S REPRESENTATION THIS LAYOUT DRAWING MUST BE COORDINATED WITH THE SITE LOCATION FOR CORRECT FIXTURE ORIENTATION.

7) CHECK GRAPHIC SCALE. DOCUMENTS PRINTED OR PLOTTED FROM ELECTRONIC FILES MAY OCCUR AT OTHER THAN THE DESIRED OR ASSUMED GRAPHIC SCALES. IT IS THE RESPONSIBILITY OF THE RECIPIENT TO VERIFY THAT THE PRINTED OR PLOTTED-TO-SCALE DRAWING IS PRINTED TO SCALE.



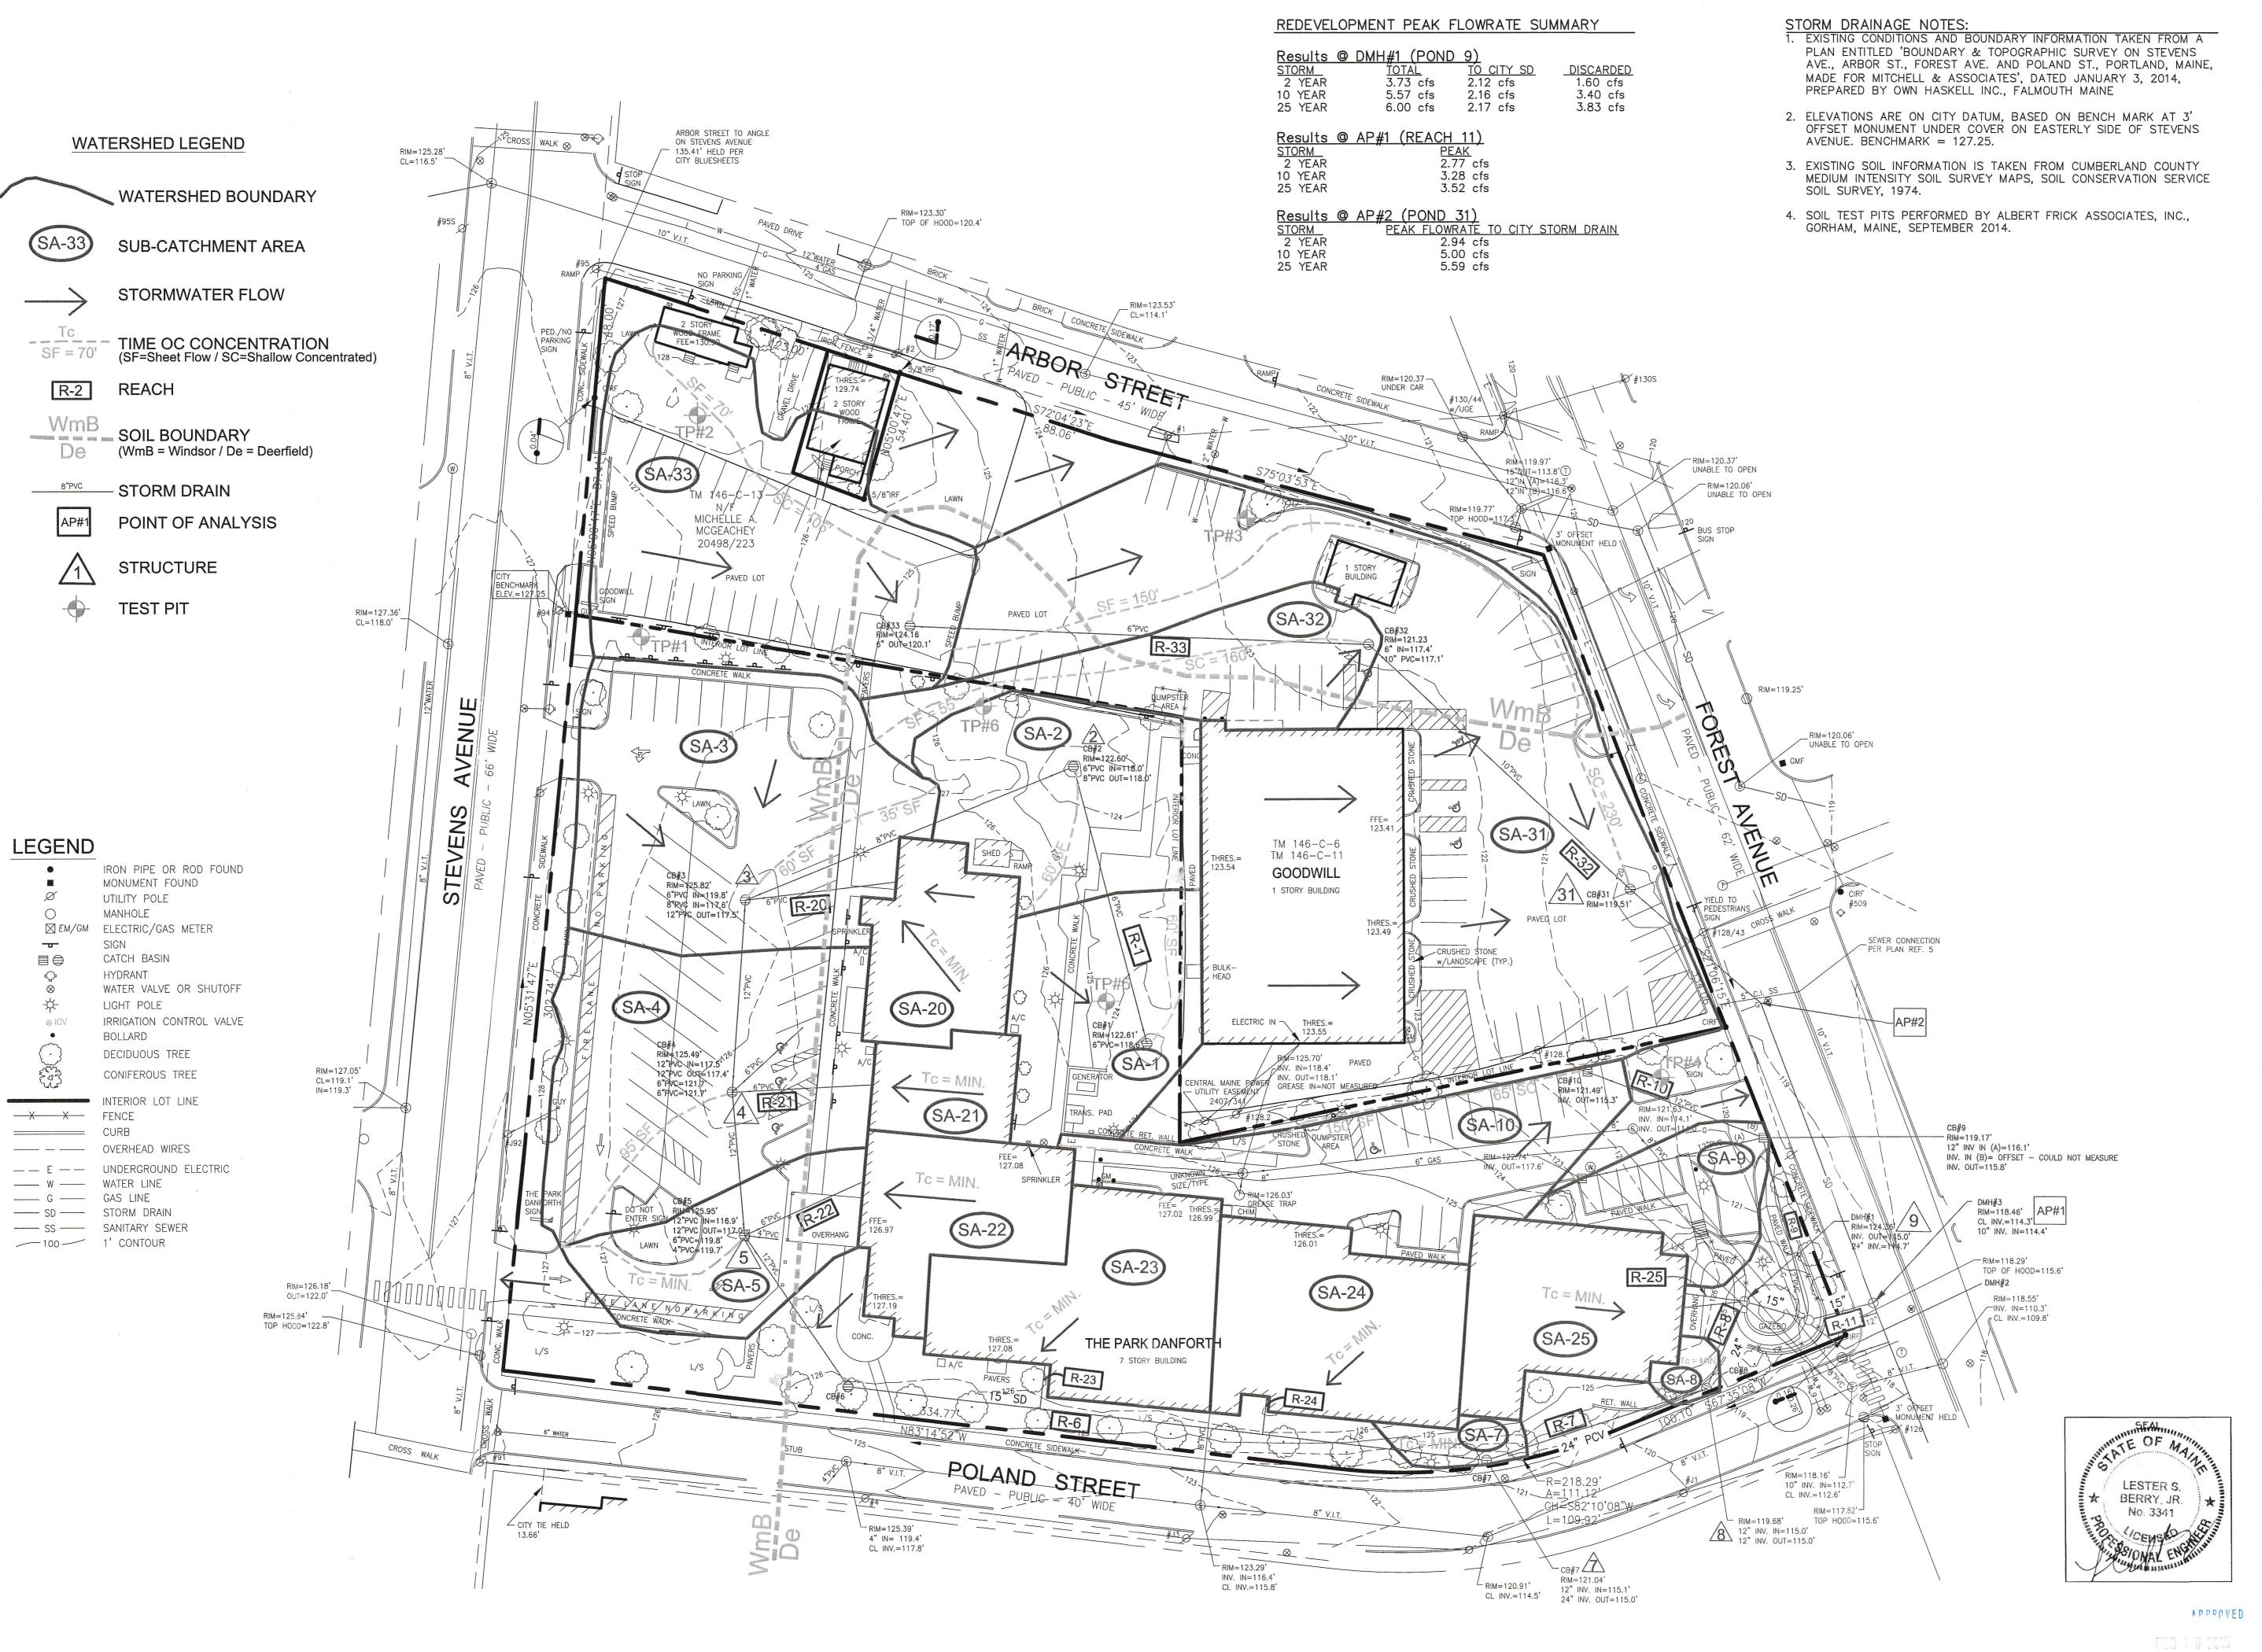

Prepared For:

Owner:

Home For The Aged 777 Stevens Avenue Portland, Maine 04103

Tel.: 207-797-7710

Tel.: 207-774-4427

anforth

a

Applicant: The Park Danforth 777 Stevens Avenue Portland, Maine 04103

Tel.: 207-797-7710 Prepared By:

MITCHELL & ASSOCIATES Landscape Architects The Staples School 70 Center Street Portland, Maine 04101

Ö

ortlan

Avenue

Date:

OCTOBER 17, 2014

Issued For:


Revisions:

Reproduction or reuse of this document without the expressed written consent of Mitchell & Associates is prohibited.


© 2014


PRE-DEVELOPMENT STORMWATER PLAN


Scale: 1"=30'

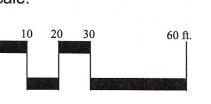

Sheet No.:

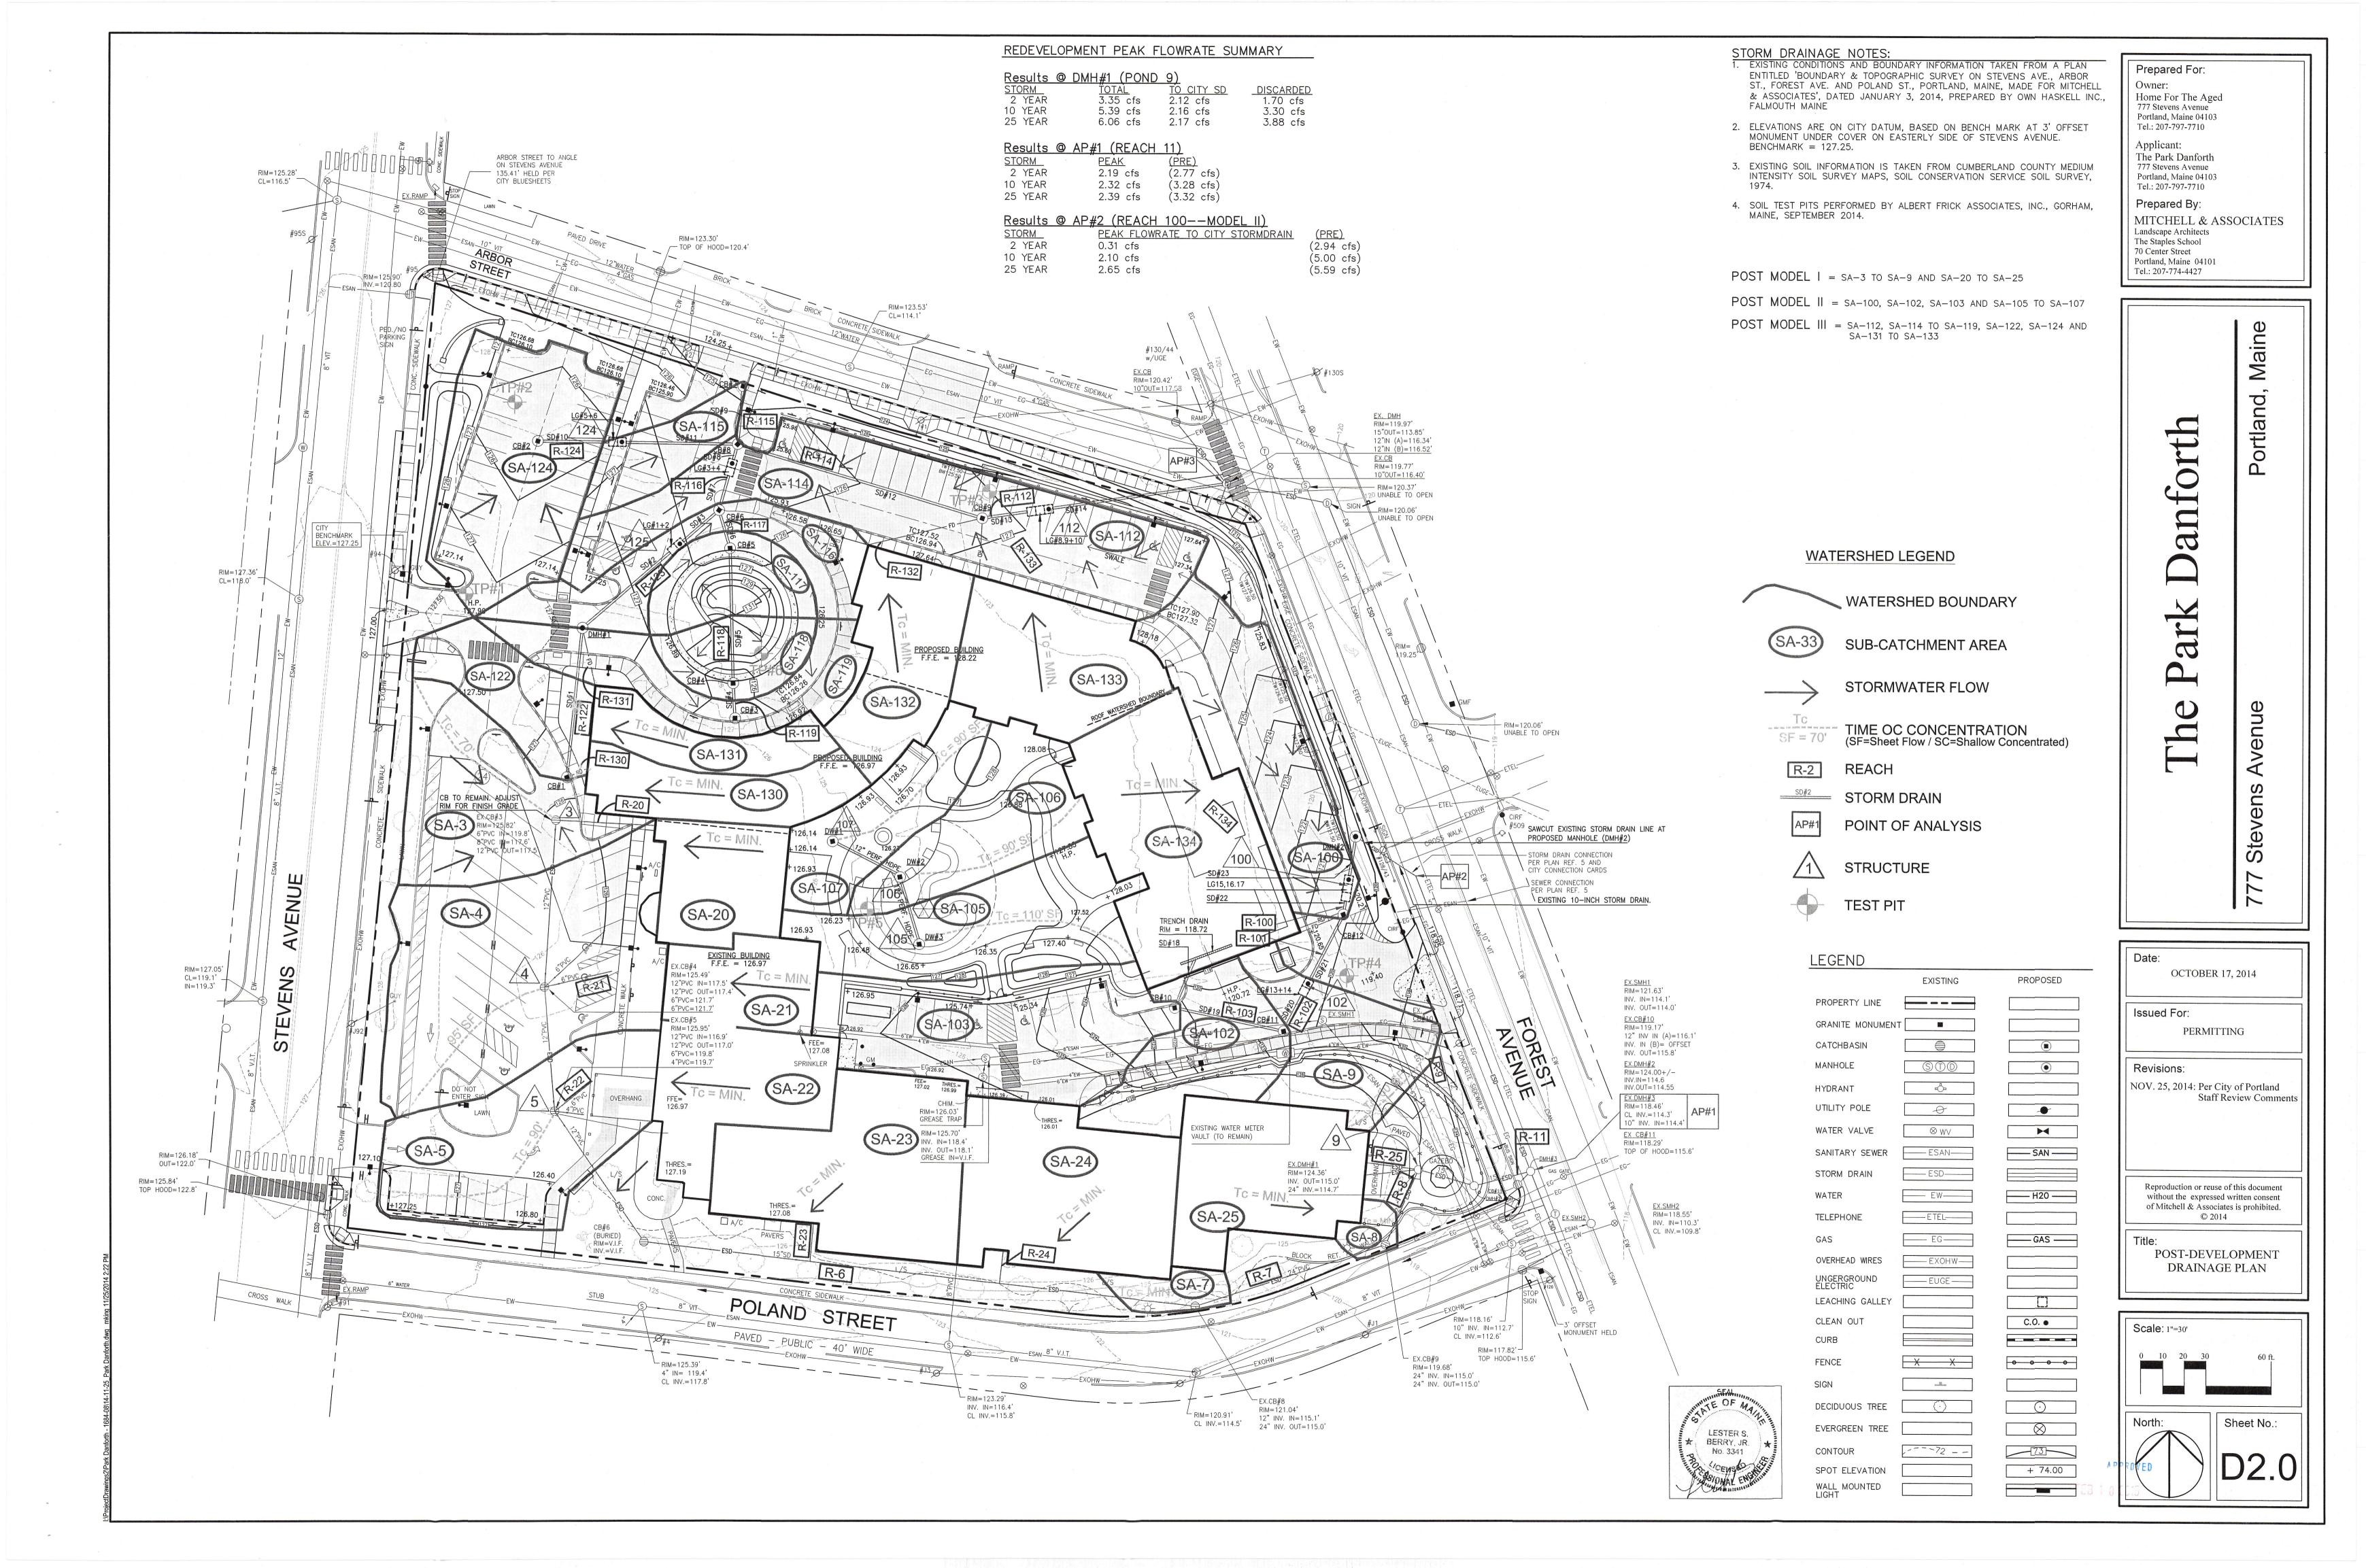

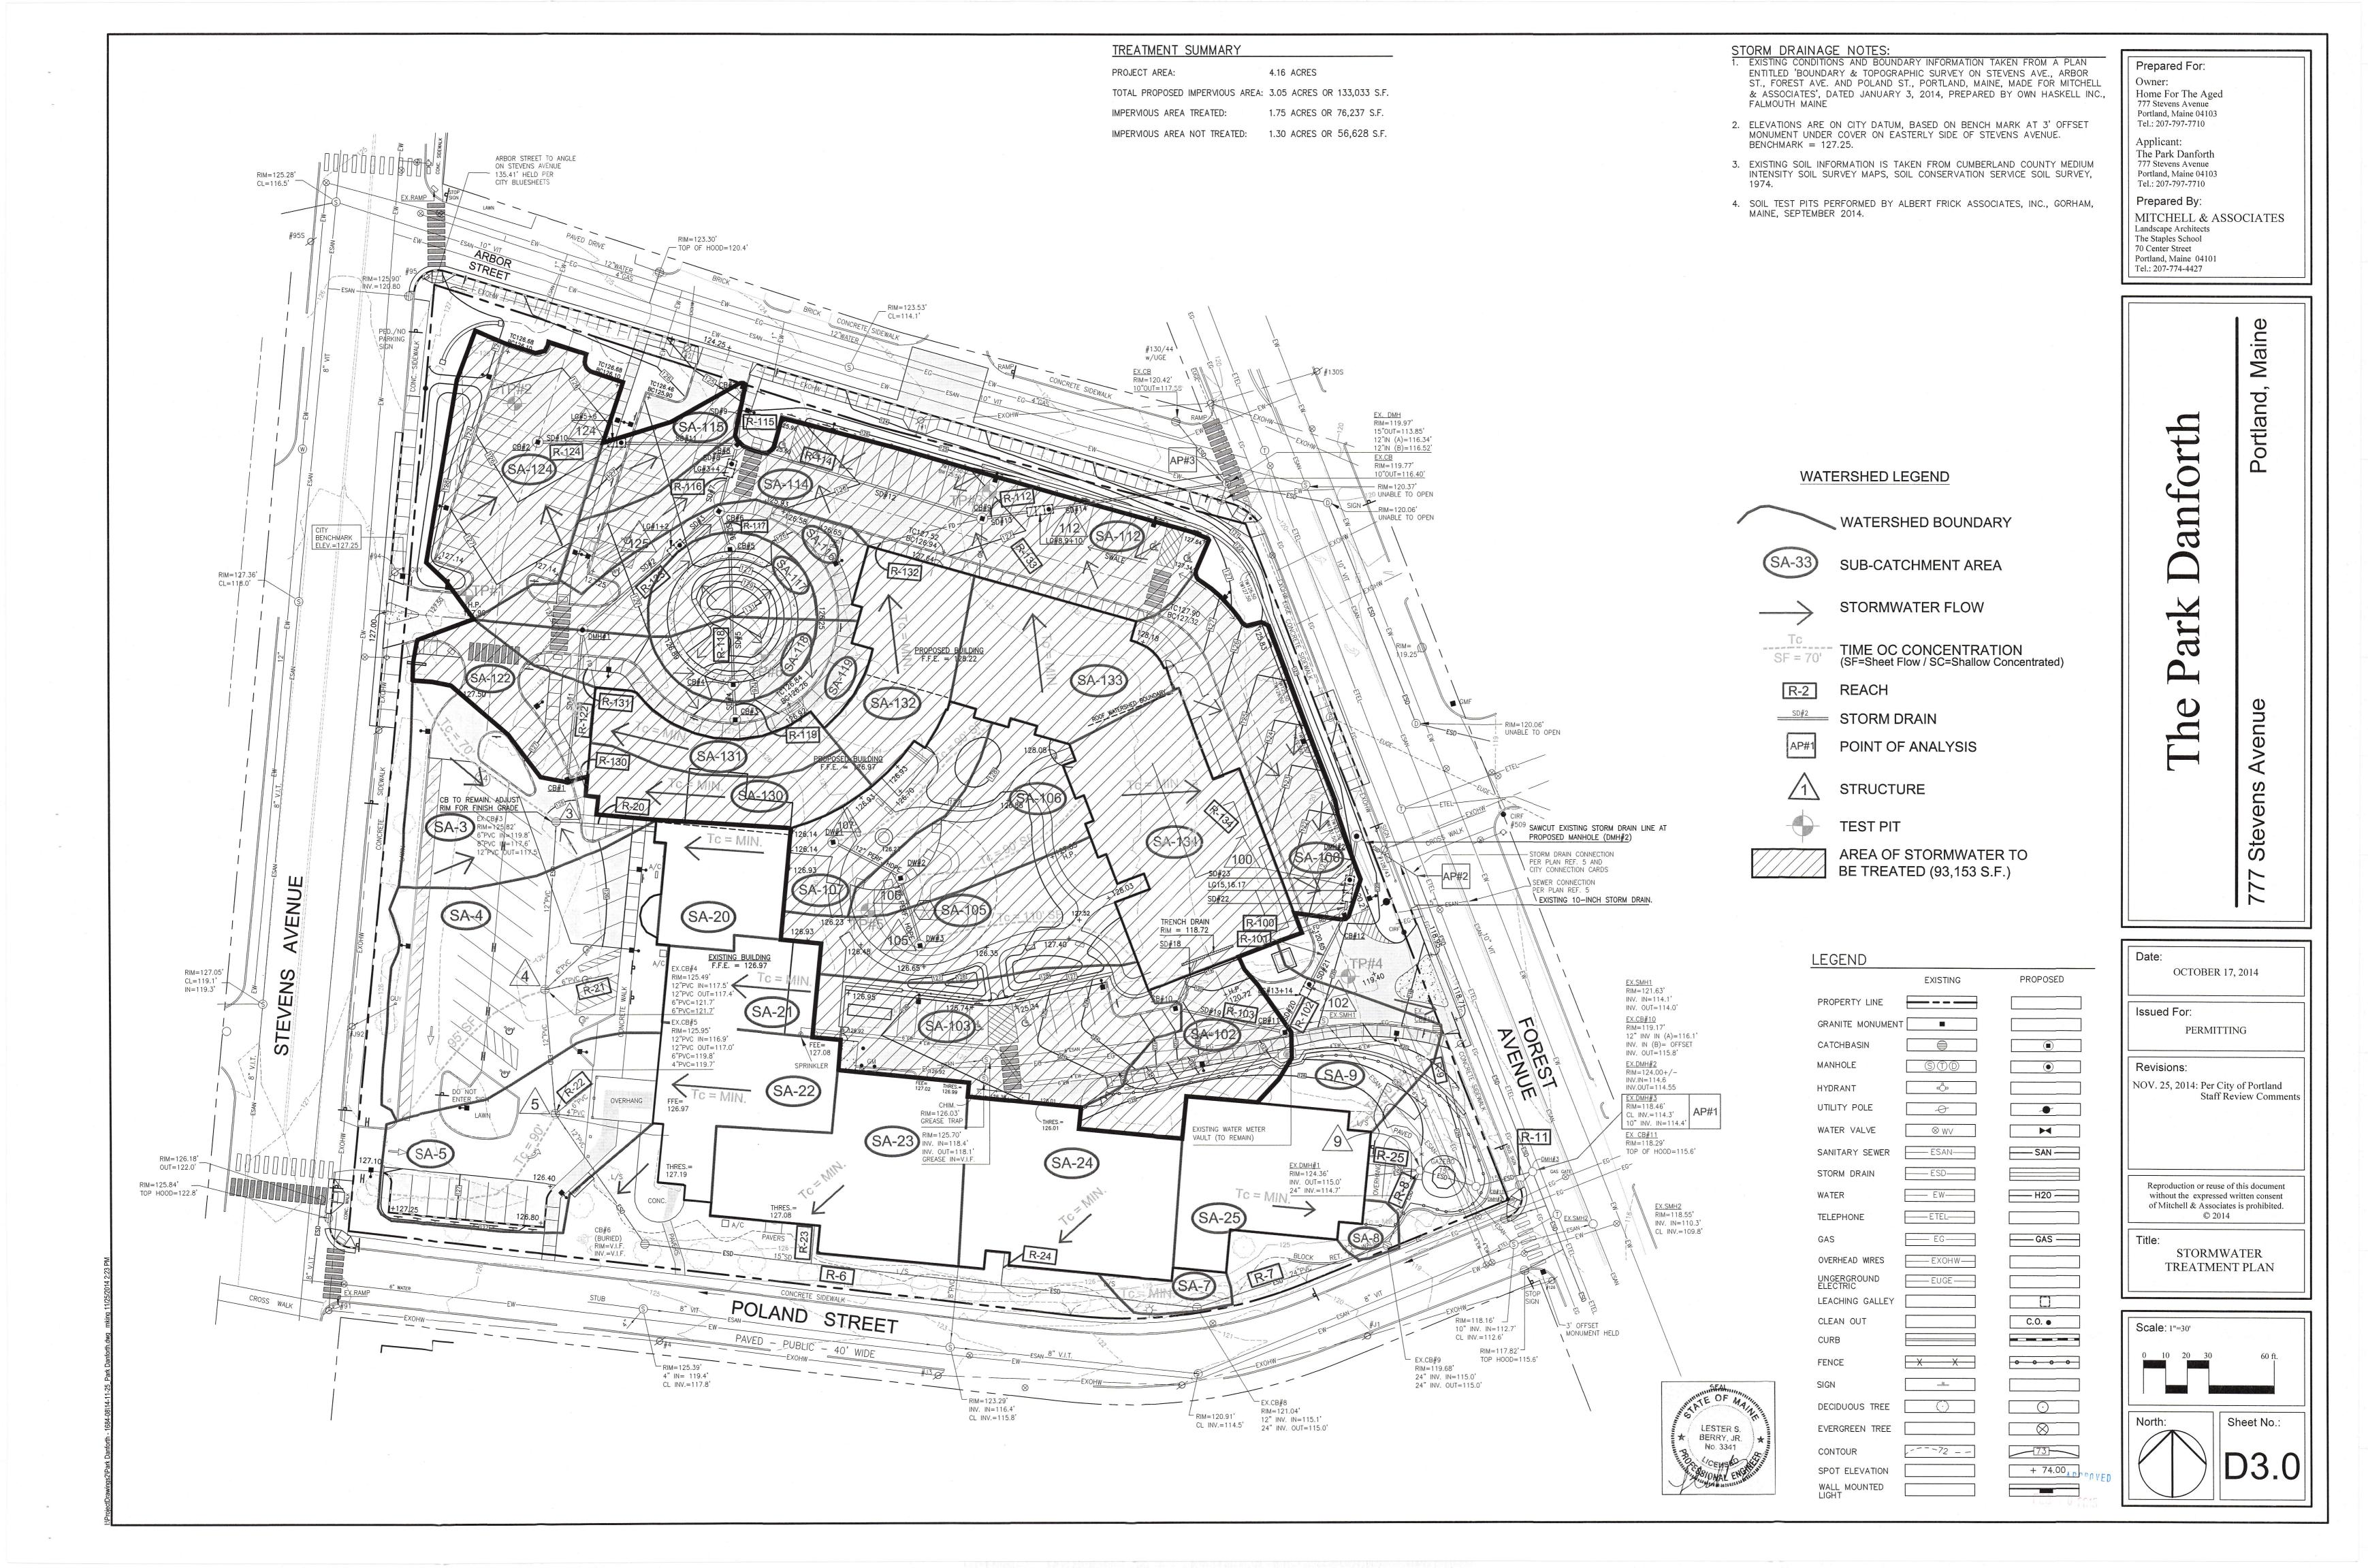

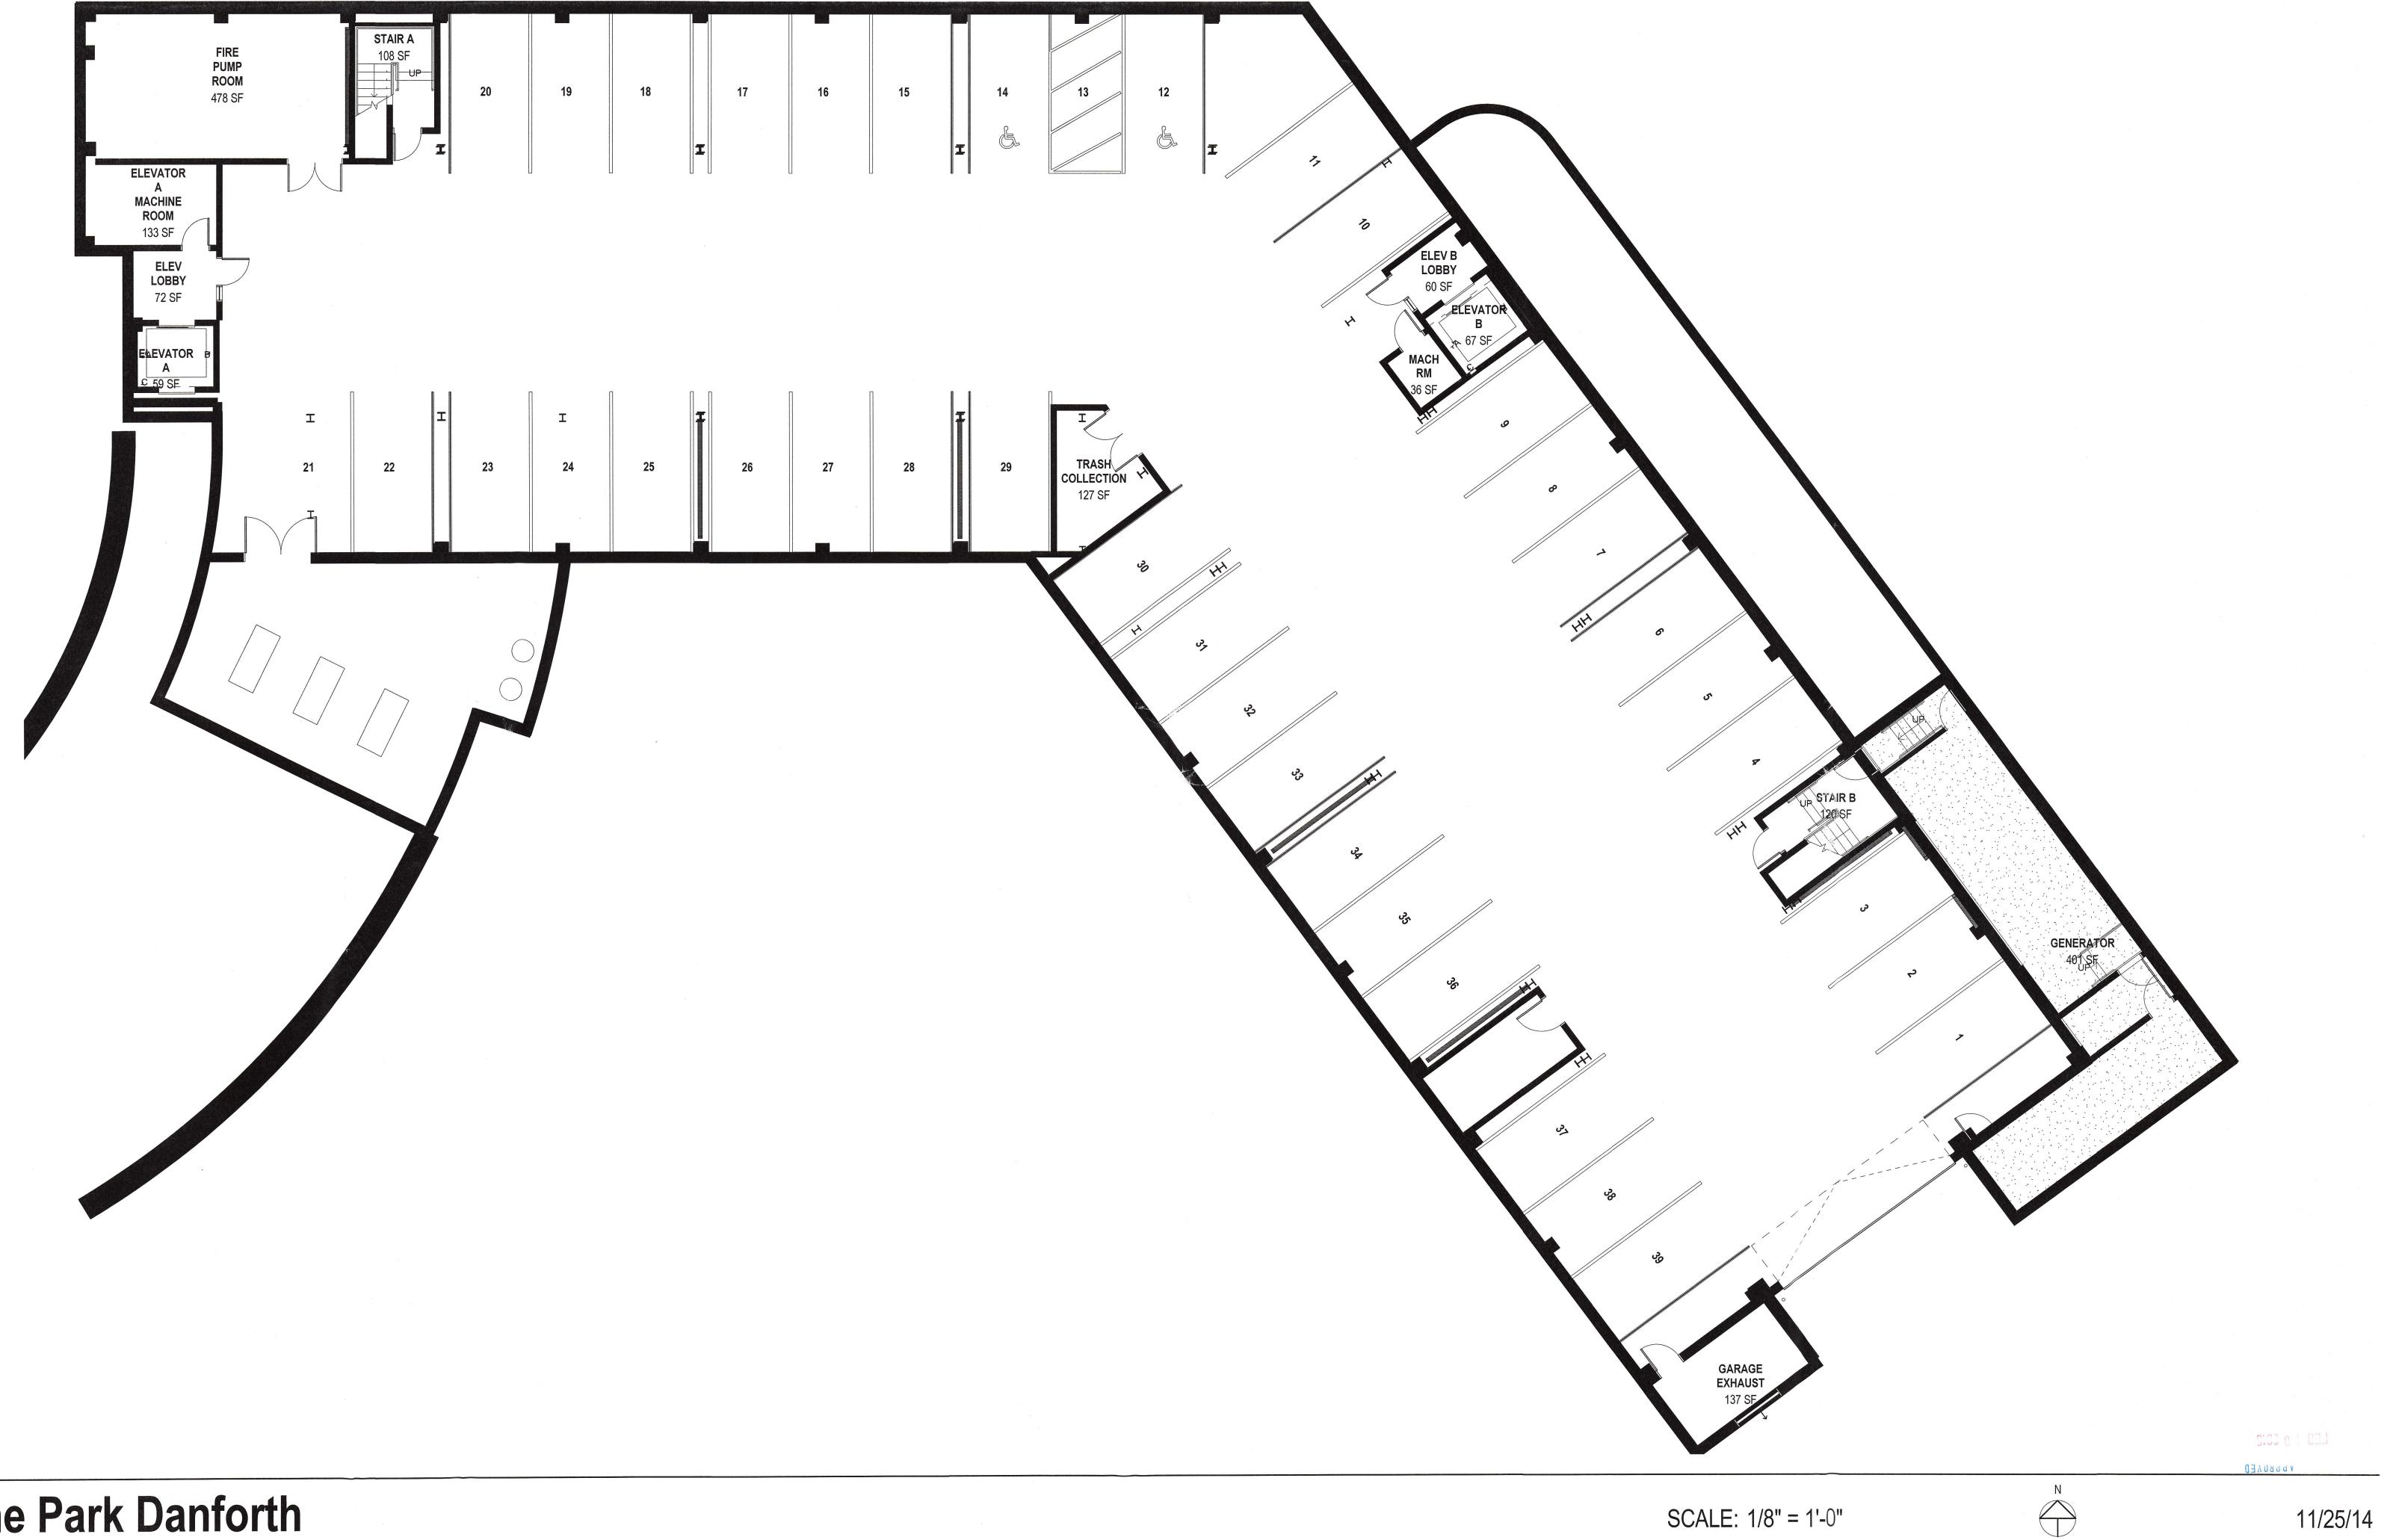

RENOVATIONS AND ADDITIONS

PROPOSED GARAGE LEVEL - NEW BUILDING

LAVALLEE BRENSINGER ARCHITECTS



RENOVATIONS AND ADDITIONS

PROPOSED LEVEL 1 - NEW BUILDING

SCALE: 1/8" = 1'-0"

N

11/25/14


LAVALLEE BRENSINGER ARCHITECTS



SCALE: 1/8" = 1'-0"


N


11/25/14

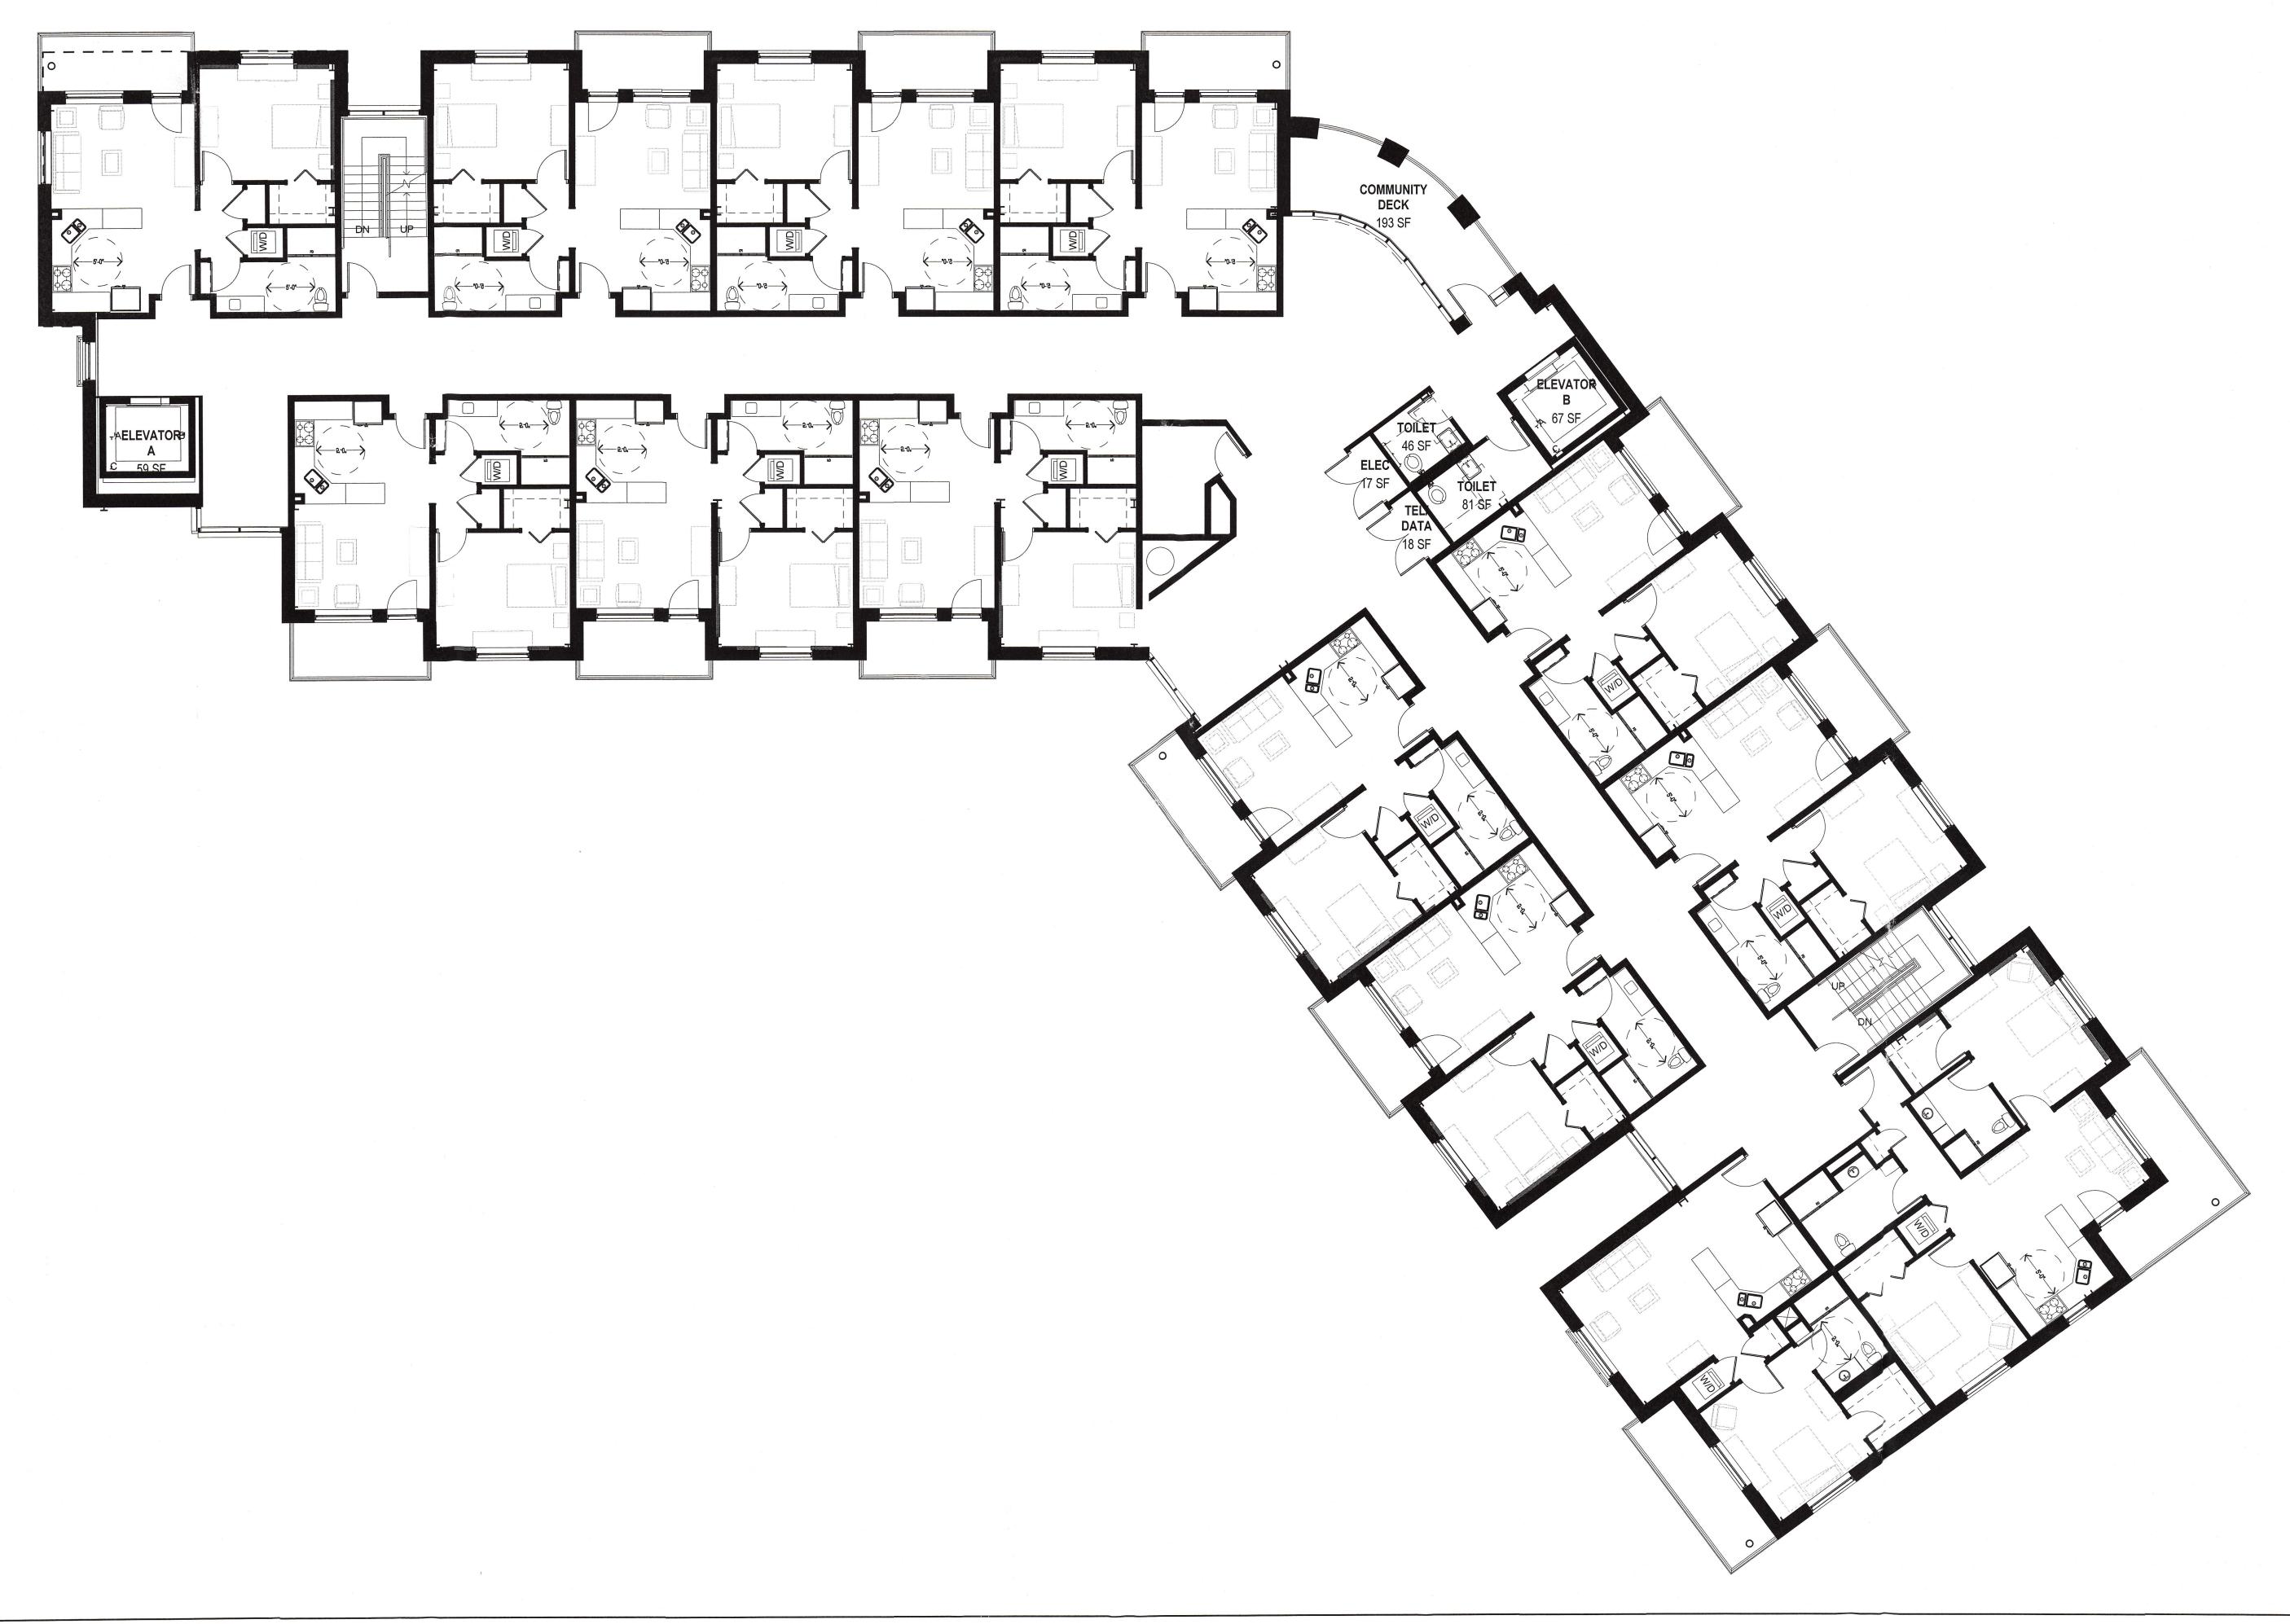

RENOVATIONS AND ADDITIONS

PROPOSED LEVEL 3 - NEW BUILDING

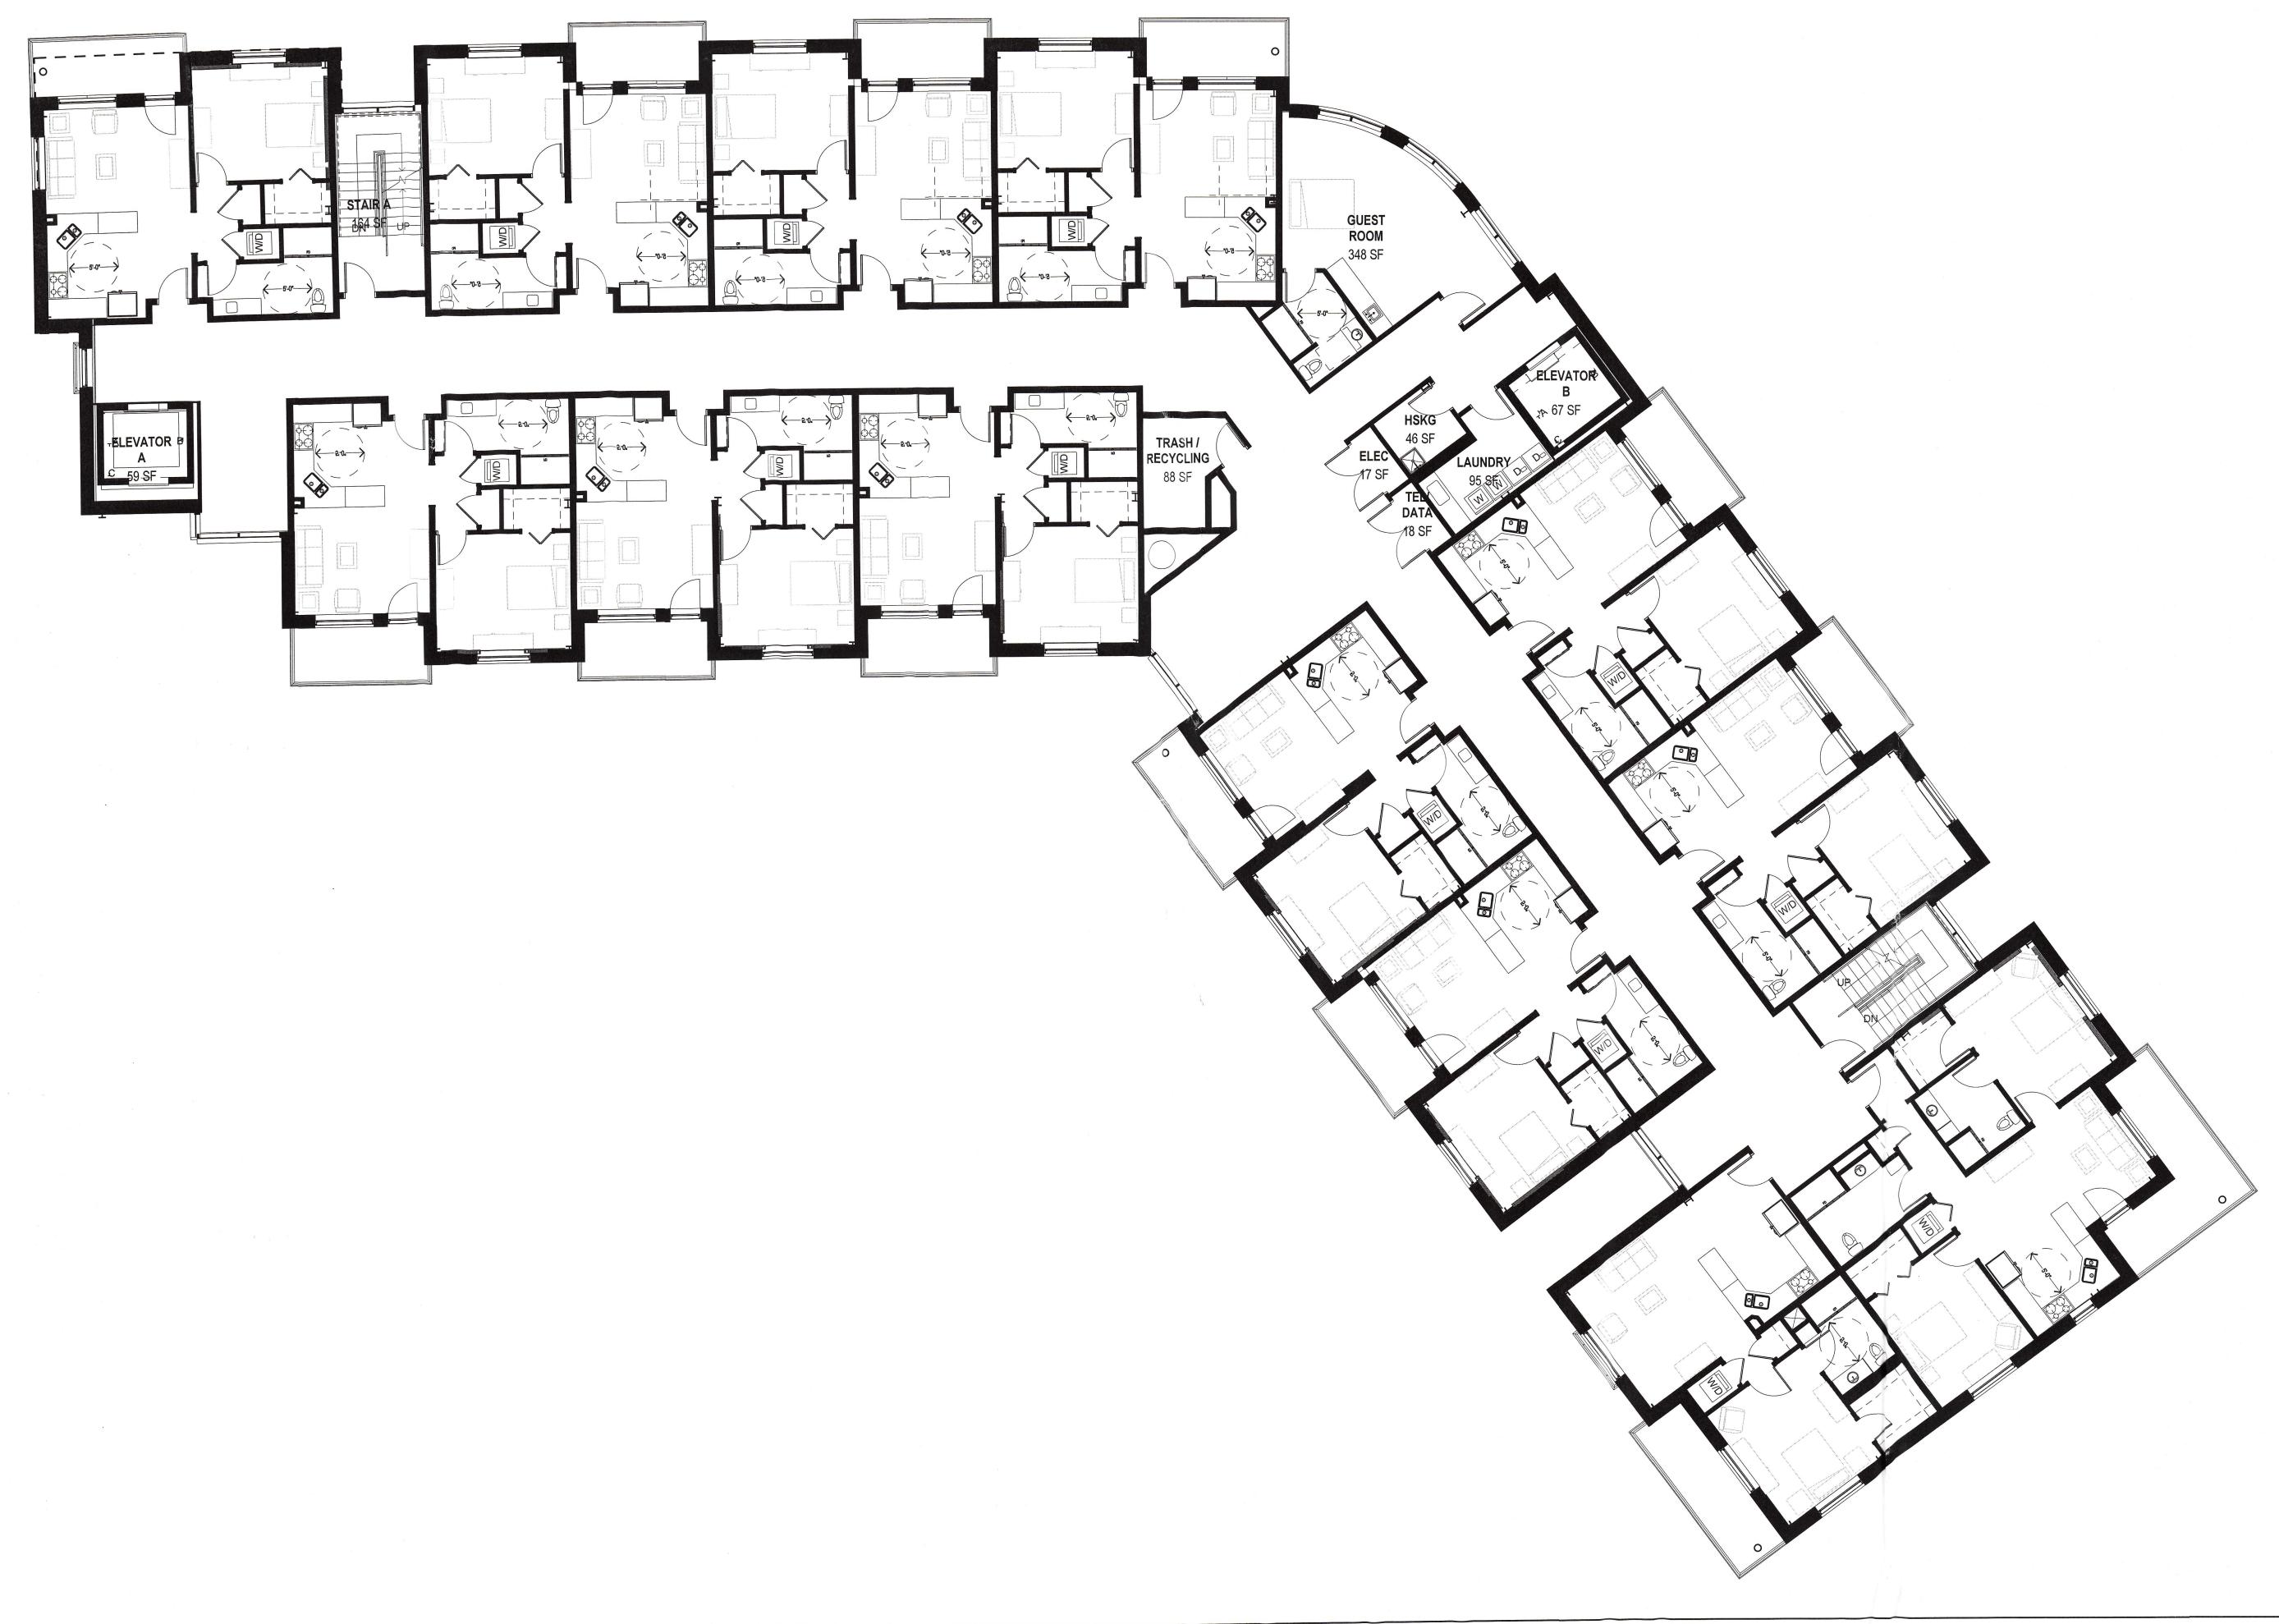


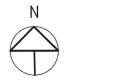





RENOVATIONS AND ADDITIONS

Proposed 5th Floor with (3) 1-Bedroom Apartment Units along Arbor Street

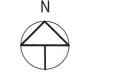

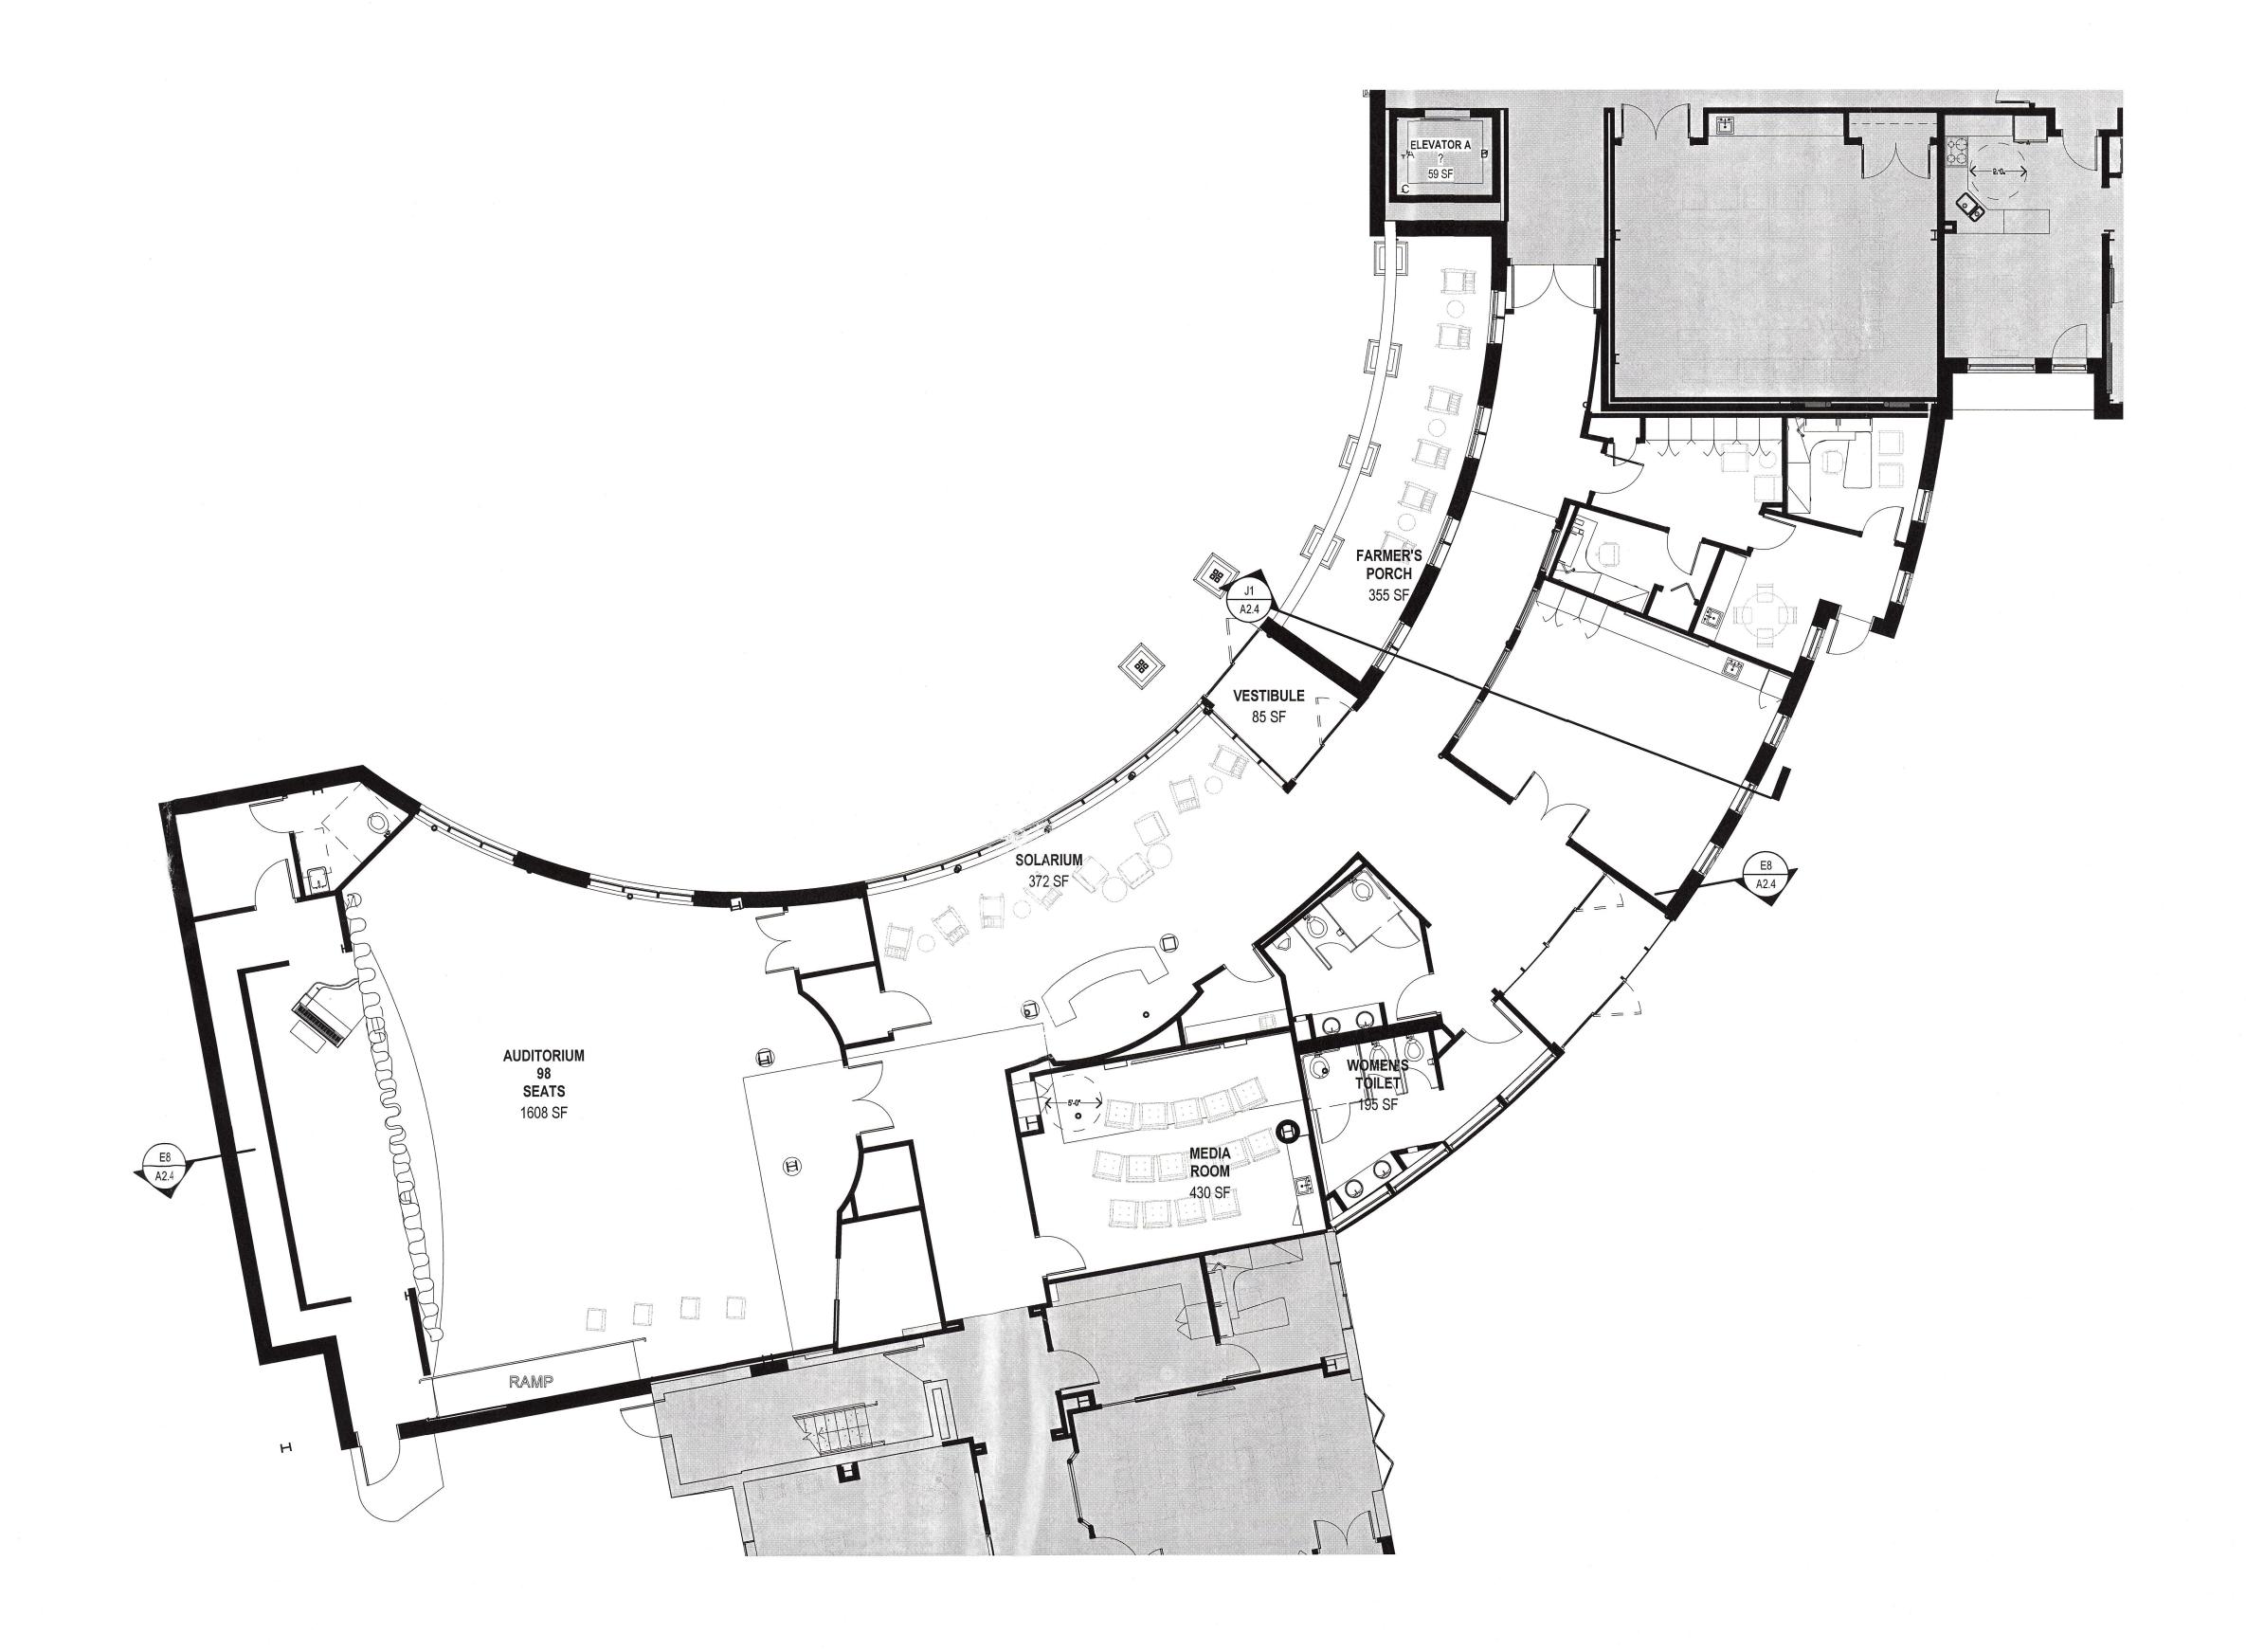

PROPOSED CONNECTOR & AUDITORIUM

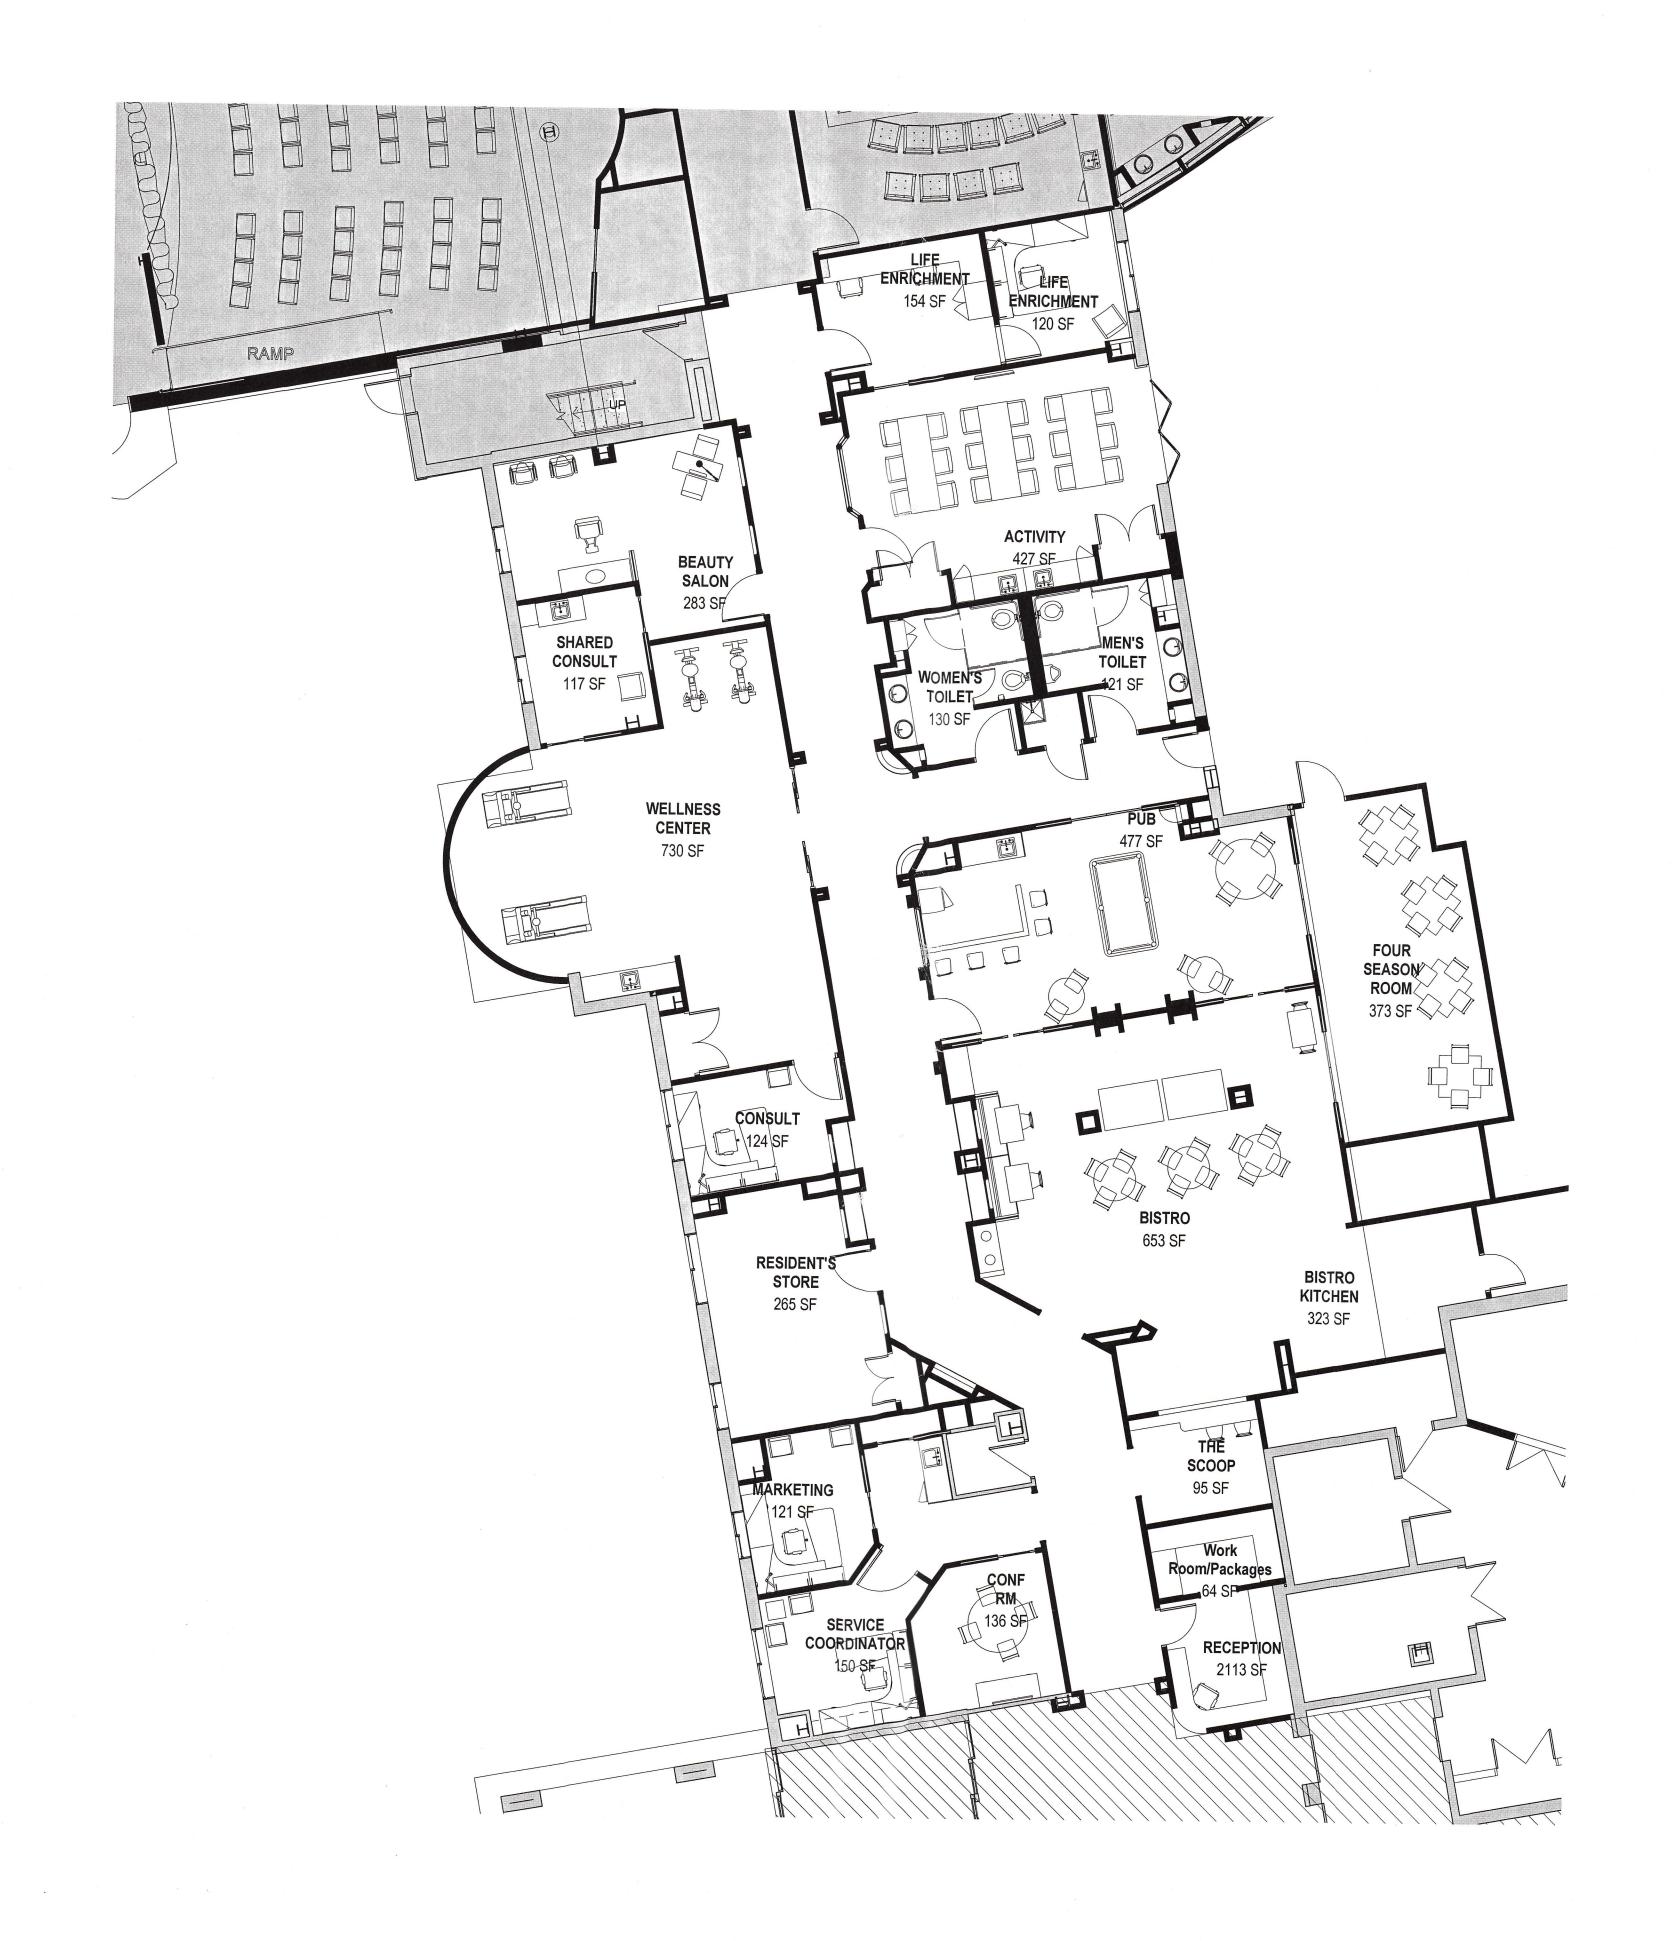

PROPOSED RENOVATIONS - MAIN STREET







PRES-11 1/8" = 1'-0"


The Park Danforth

RENOVATIONS AND ADDITIONS

SCALE: 1/8" = 1'-0"

04/08/15

LAVALLEE BRENSINGER ARCHITECTS

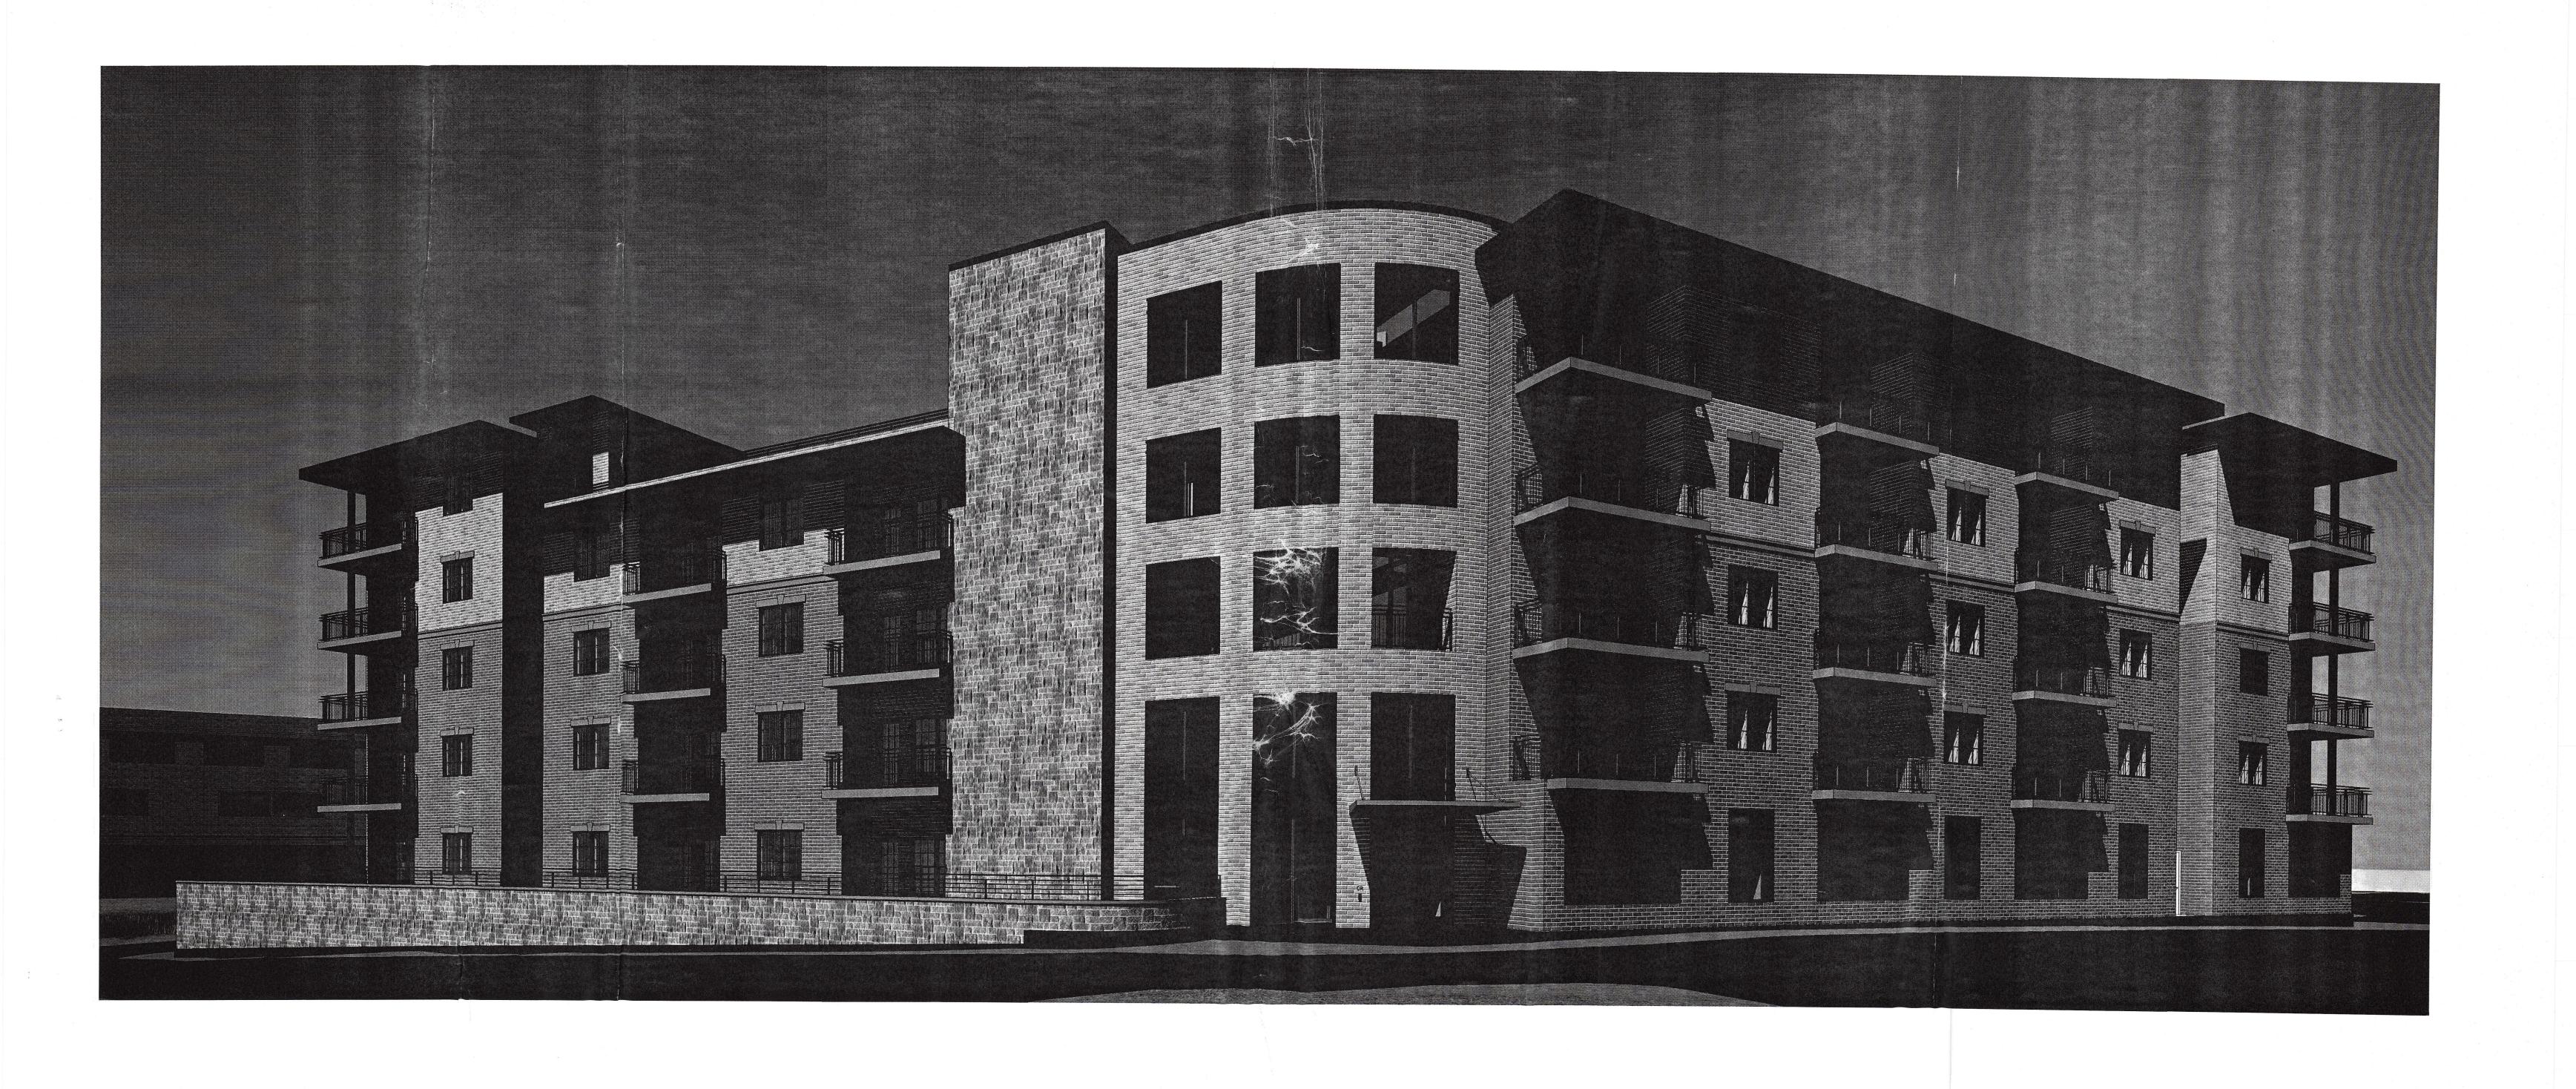

RENOVATIONS AND ADDITIONS

View From Corner of Arbor and Forest

SCALE:

04/08/15

LAVALLEE BRENSINGER ARCHITECTS