


BECKER
 STRUCTURAL ENGINEERS
 75 York Street, Portland, Maine 04101
 207.878.1838 • beckerstructural.com

Owner


The Park Danforth

77 Stevens Ave, Portland, ME 04103

NO.	DESCRIPTION	DATE
1	ADDENDUM #1	06-10-15

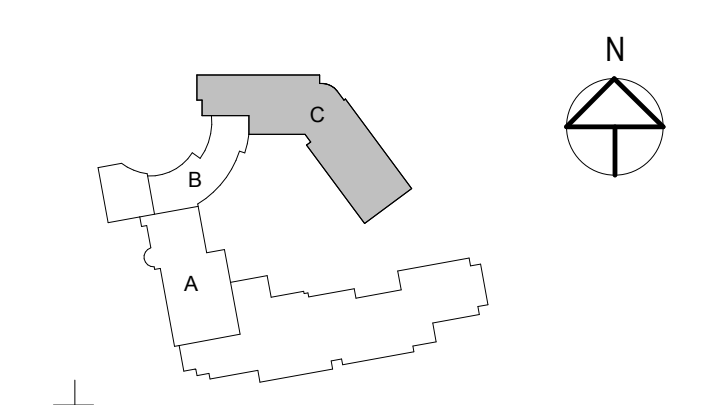

CONTENT: LEVEL 2-NEW BUILDING-FRAMING PLAN	
DRAWN BY:	A.P.P.
PROJECT NO:	3422
DATE:	05/27/15
REVISED:	10/16/15
SCALE:	As indicated
S1.2C	
Project Phase CONFORMANCE SET	
COPYRIGHT © 2014 BY LAVALLEEBRENSINGER PROFESSIONAL ASSOCIATION. ALL RIGHTS RESERVED. NO REPRODUCTION WITHOUT PERMISSION.	

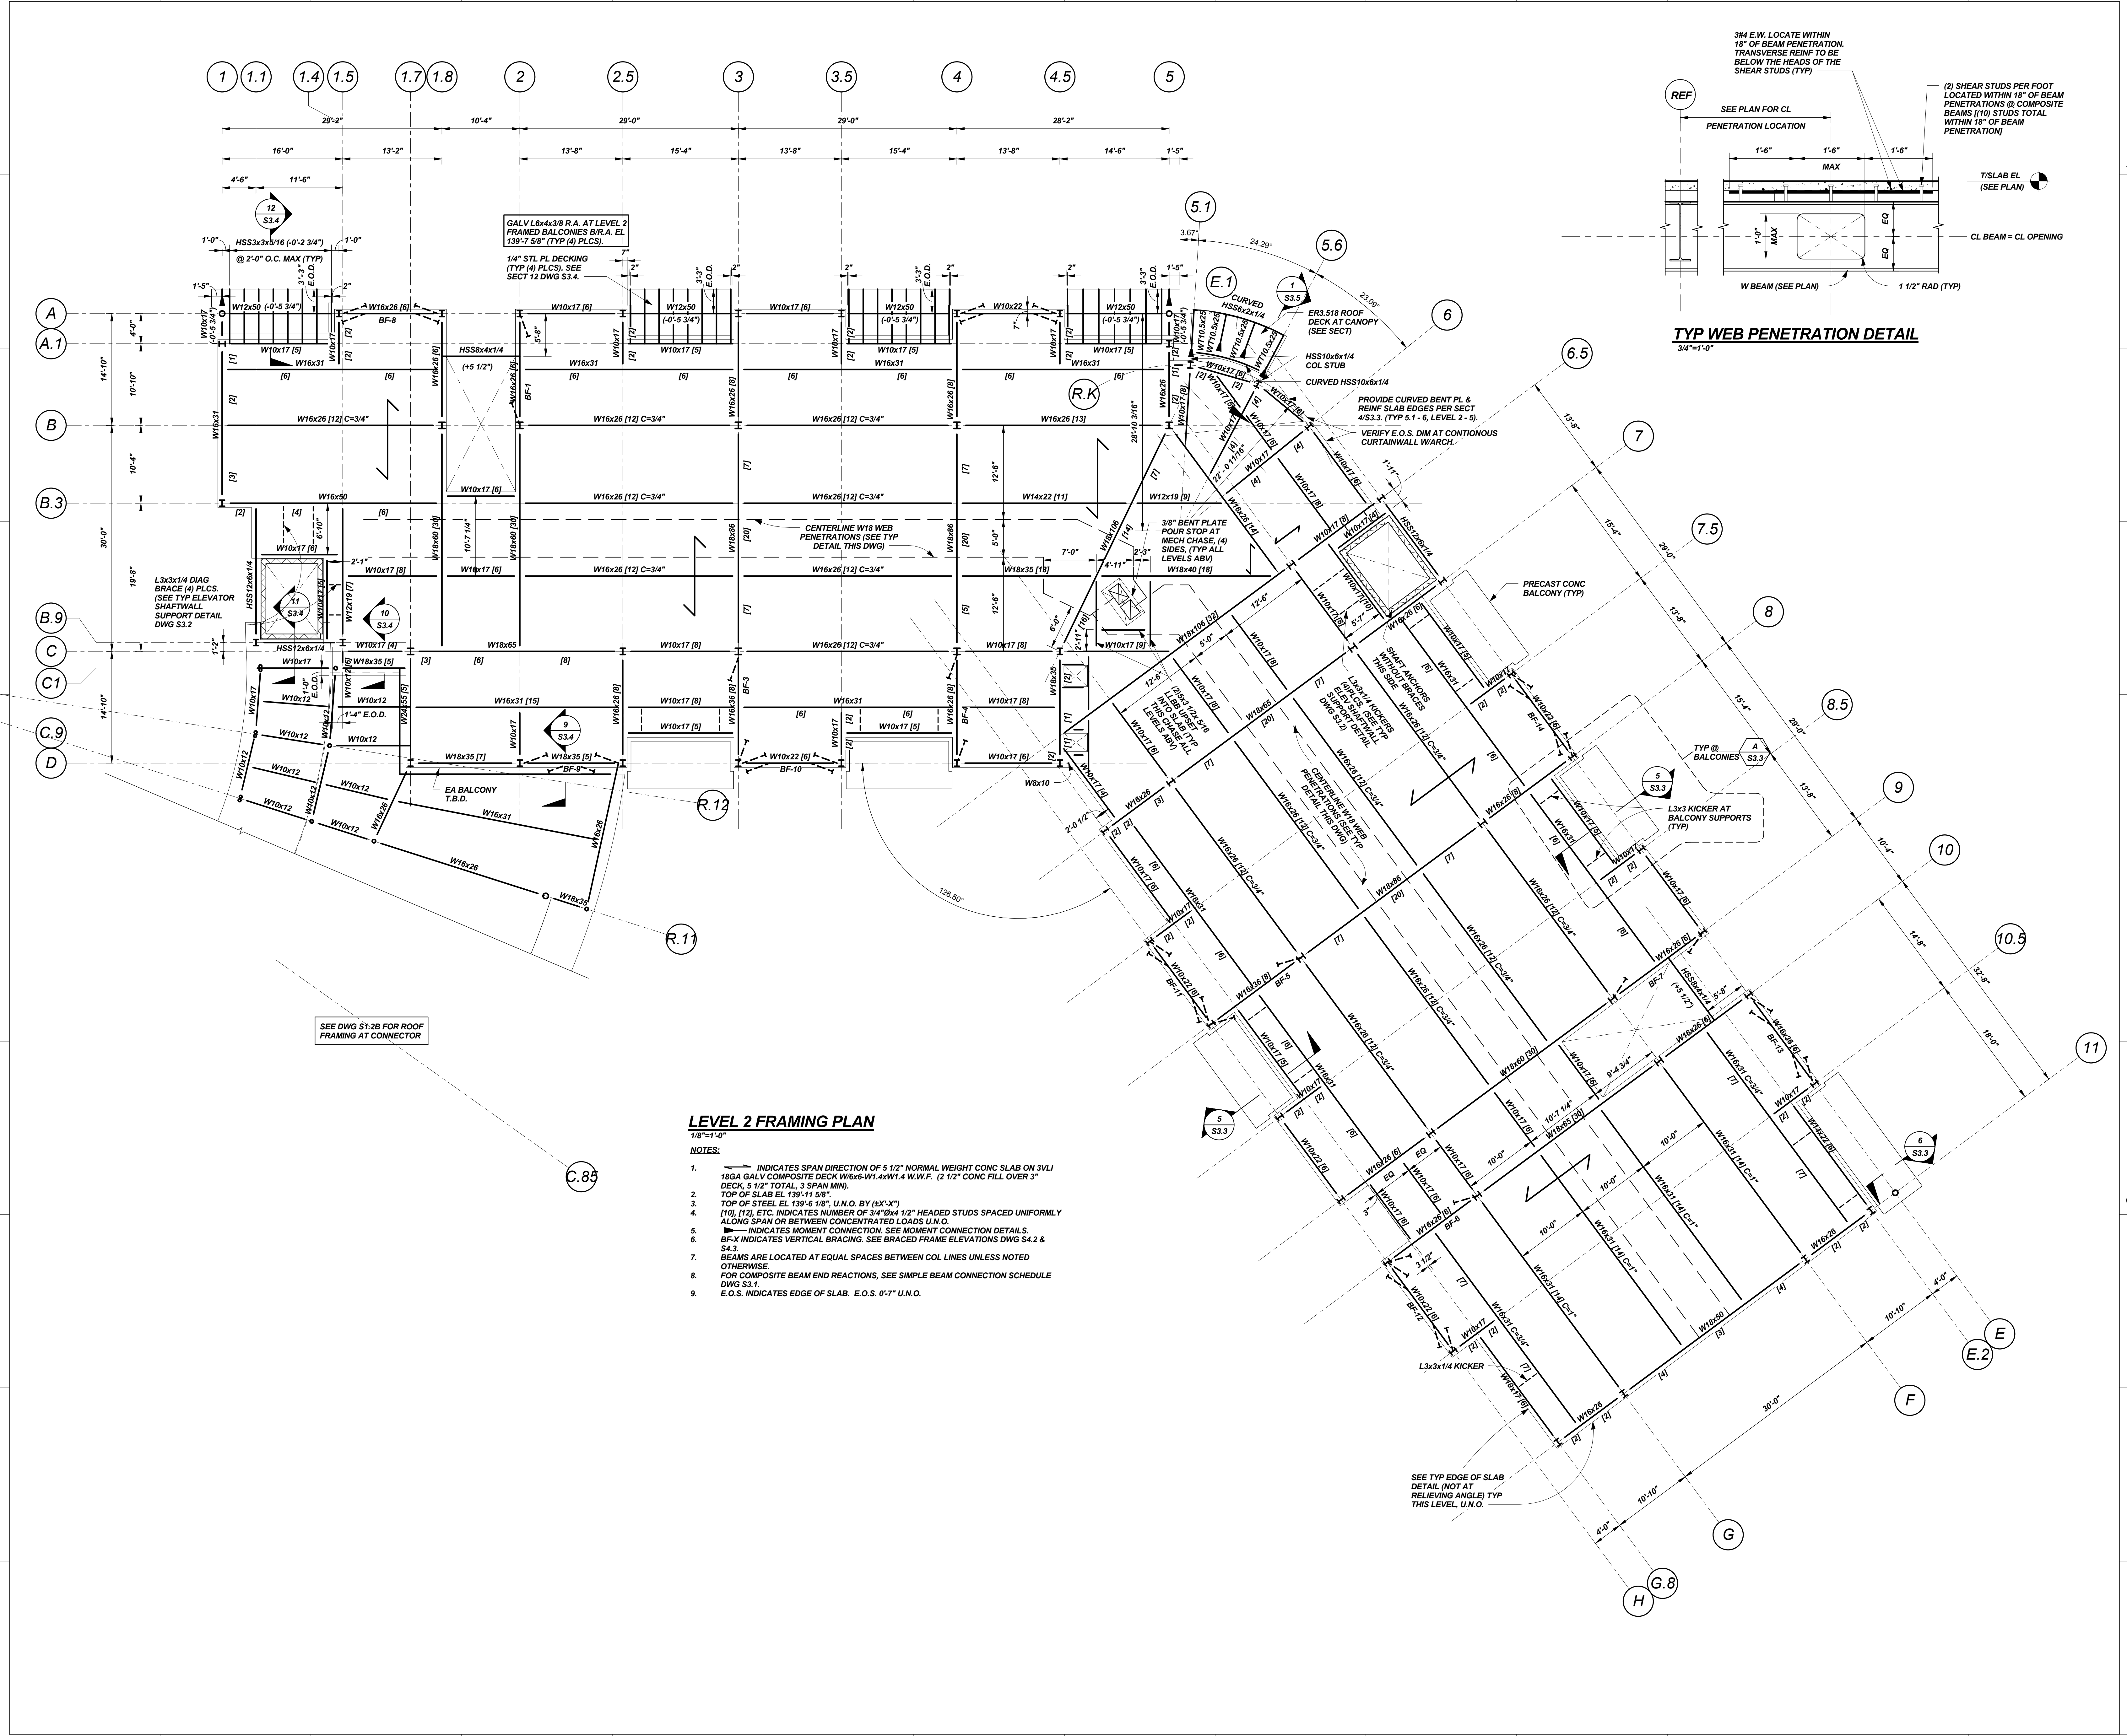

LEVEL 2 FRAMING PLAN
 1/8"=1'-0"

NOTES:

- INDICATES SPAN DIRECTION OF 5 1/2" NORMAL WEIGHT CONC SLAB ON 3/4" 18GA GALV COMPOSITE DECK W/6x6-W1.4W1.4 W.W.F. (2 1/2" CONC FILL OVER 3" DECK, 5 1/2" TOTAL, 3 SPAN MIN).
- TOP OF SLAB EL 139'-11 5/8"
- TOP OF STEEL EL 139'-8 1/8", U.N.O. BY (3X-X')
- (10), (12), ETC. INDICATES NUMBER OF 3/4"x1/4" 1/2" HEADED STUDS SPACED UNIFORMLY ALONG SPAN OR BETWEEN CONCENTRATED LOADS U.N.O.
- INDICATES MOMENT CONNECTION. SEE MOMENT CONNECTION DETAILS.
- BFX INDICATES VERTICAL BRACING. SEE BRACED FRAME ELEVATIONS DWG S4.2 & S4.3.
- BEAMS ARE LOCATED AT EQUAL SPACES BETWEEN COL LINES UNLESS NOTED OTHERWISE.
- FOR COMPOSITE BEAM END REACTIONS, SEE SIMPLE BEAM CONNECTION SCHEDULE DWG S3.1.
- E.O.S. INDICATES EDGE OF SLAB. E.O.S. 0'-7" U.N.O.

