


Owner

The Park Danforth

77 Stevens Ave, Portland, ME 04103


NO.	DESCRIPTION	DATE
1	ADDENDUM #1	06-10-15
2	ADDENDUM #2	06-25-15

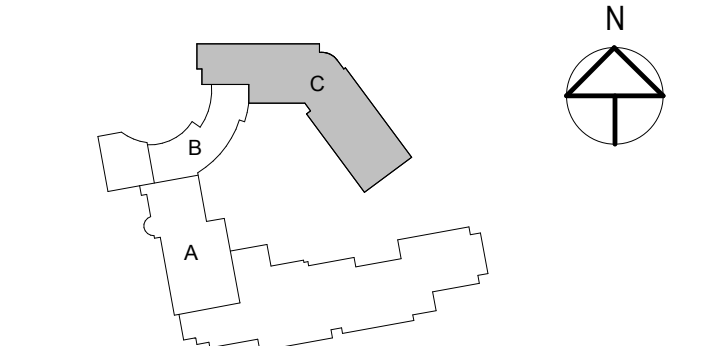

CONTENT:	
LEVEL 1-NEW BUILDING-FRAMING PLAN	
DRAWN BY:	A.P.P.
PROJECT NO:	3422
DATE:	05/27/15
REVISED:	10/16/15
SCALE:	As indicated

S1.1C

Project Phase
CONFORMANCE SET
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LEVEL 1 FRAMING PLAN
1/8"=1'-0"

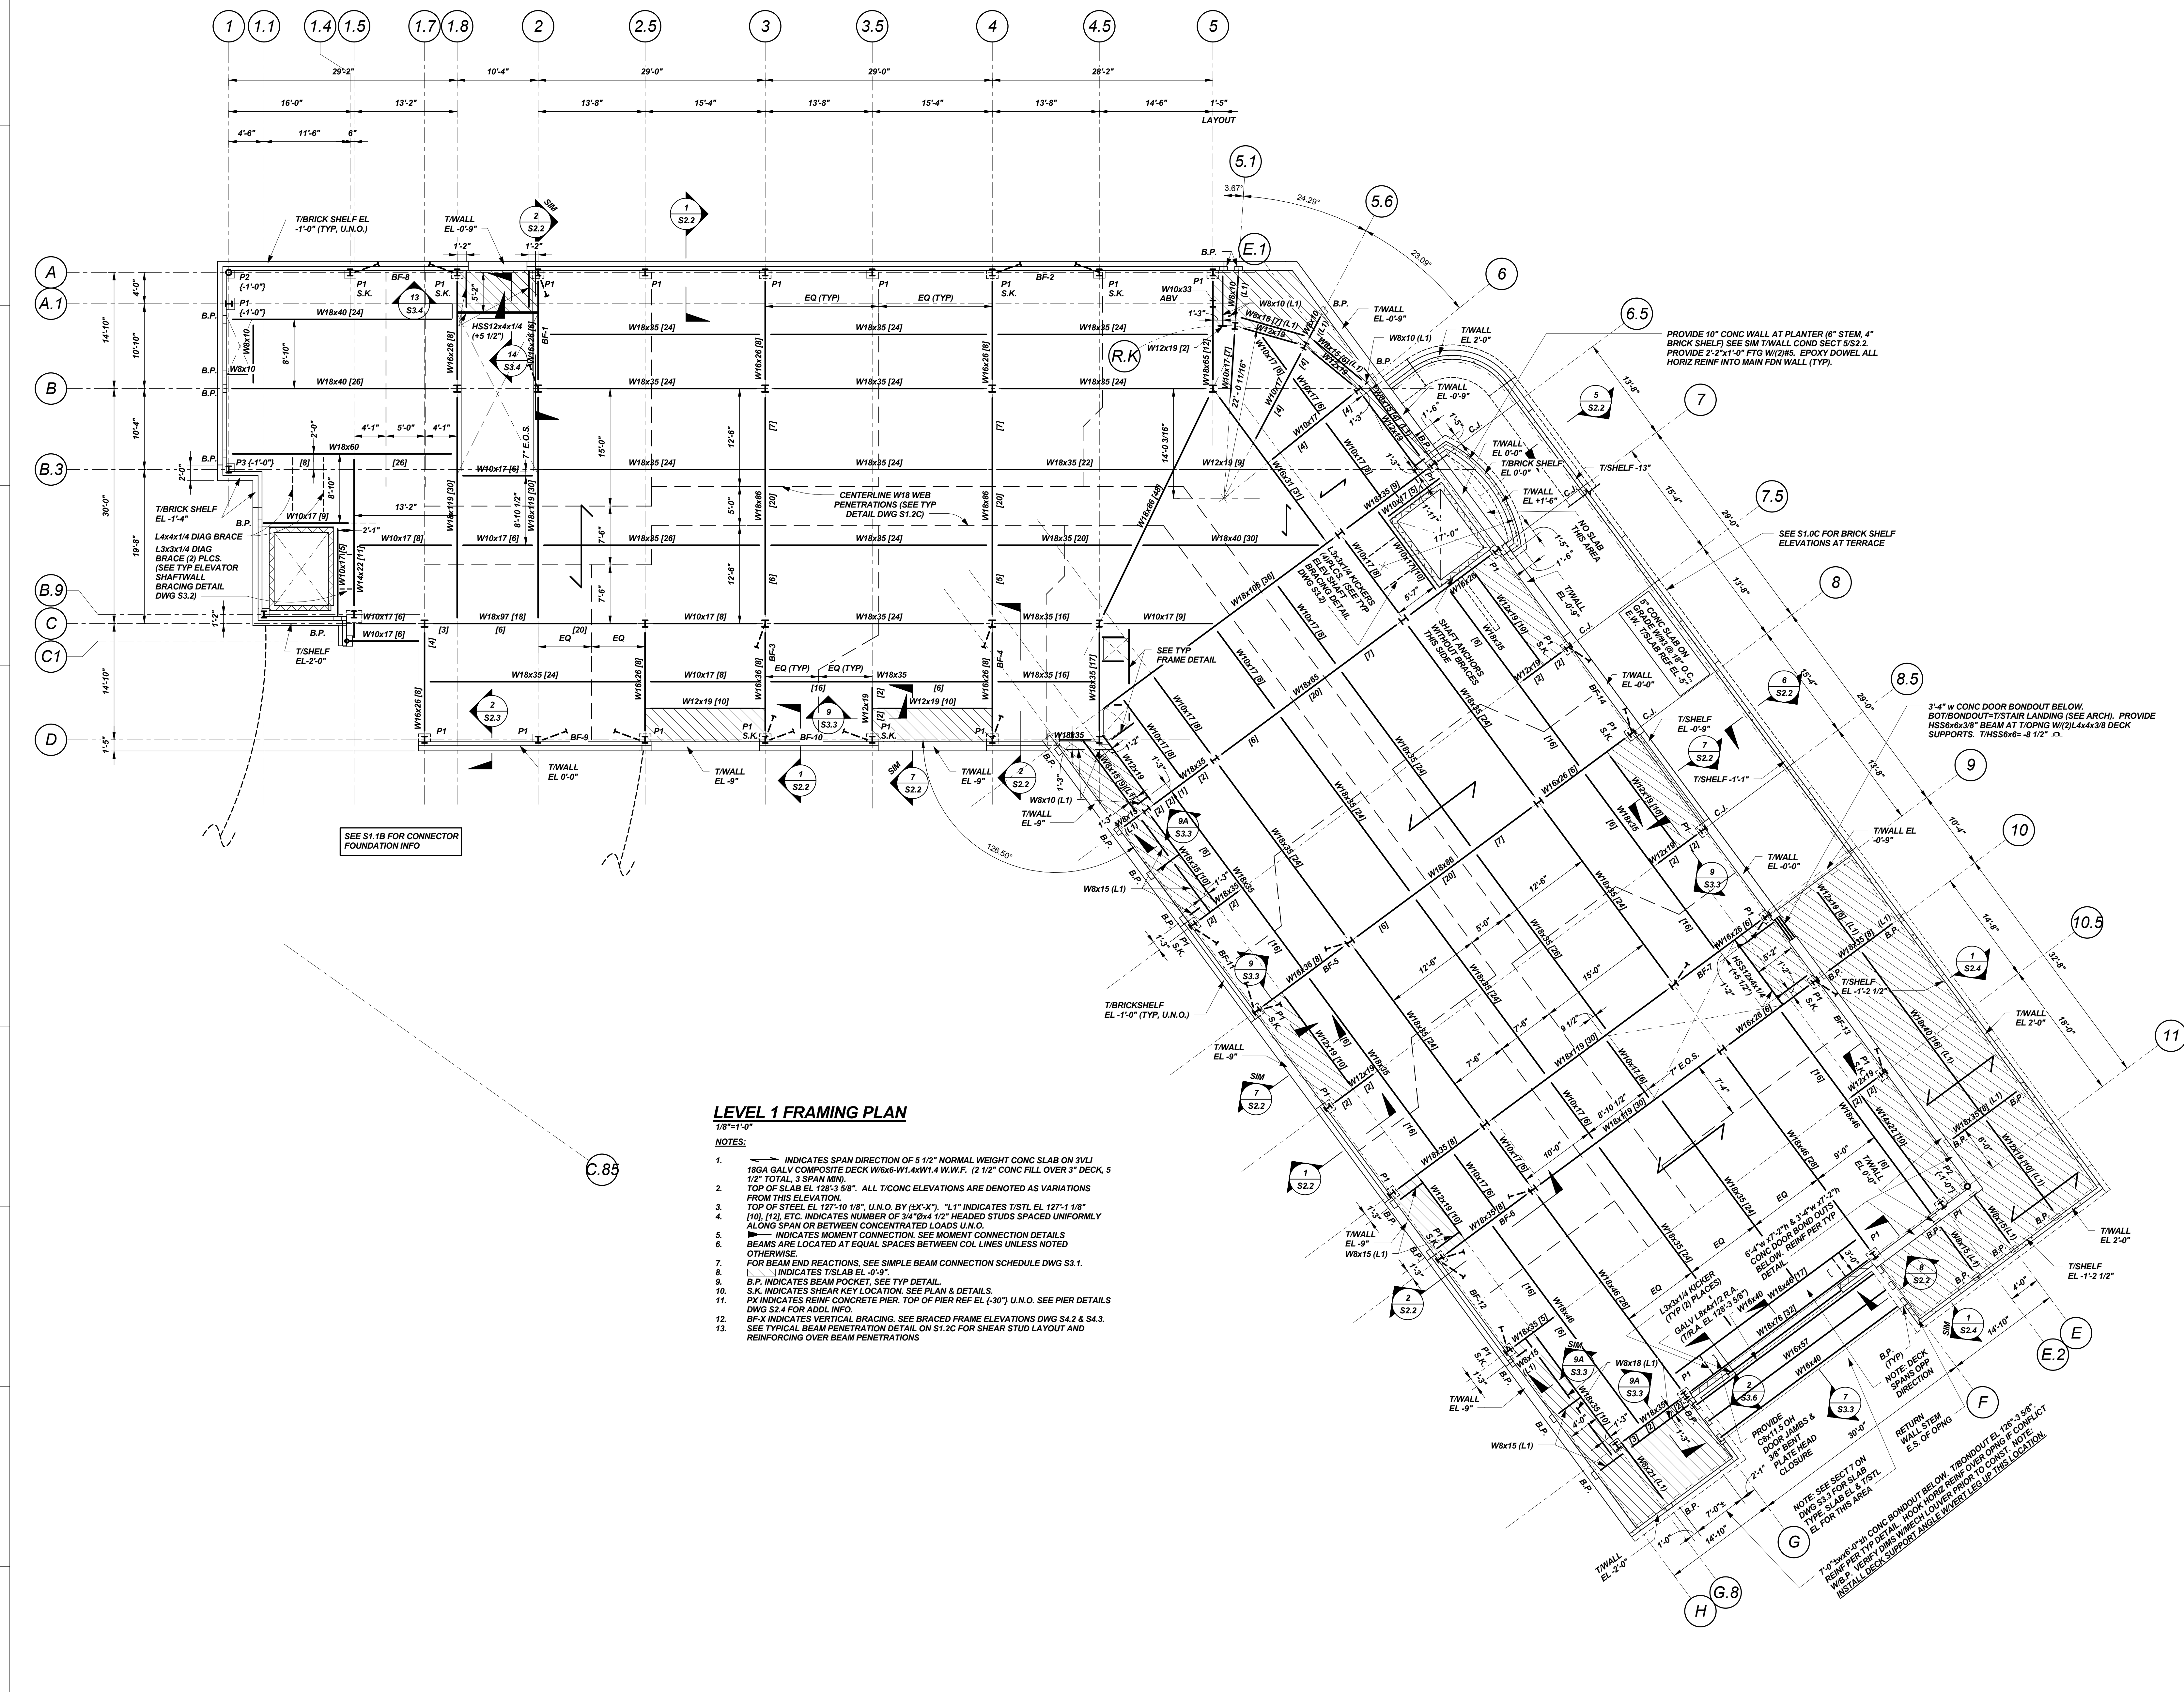- NOTES:**
- INDICATES SPAN DIRECTION OF 5 1/2" NORMAL WEIGHT CONC. SLAB ON 3/4" 18GA GALV COMPOSITE DECK W/6x6-W1.4xW1.4 W.W.F. (2 1/2" CONC FILL OVER 3" DECK, 5 1/2" TOTAL, 3 SPAN MIN).
 - TOP OF SLAB EL 127'-3 5/8". ALL T/CONC ELEVATIONS ARE DENOTED AS VARIATIONS FROM THIS ELEVATION.
 - TOP OF STEEL EL 127'-10 1/8", U.N.O. BY (X-X)". "L1" INDICATES T/STL EL 127'-1 1/8" (10), (15), ETC. INDICATES NUMBER OF 3/4"x9x4 1/2" HEADED STUDS SPACED UNIFORMLY ALONG SPAN OR BETWEEN CONCENTRATED LOADS U.N.O.
 - INDICATES MOMENT CONNECTION. SEE MOMENT CONNECTION DETAILS.
 - BEAMS ARE LOCATED AT EQUAL SPACES BETWEEN COL LINES UNLESS NOTED OTHERWISE.
 - FOR BEAM END REACTIONS, SEE SIMPLE BEAM CONNECTION SCHEDULE DWG S3.1.
 - INDICATES T/SLAB EL -0'-9".
 - B.P. INDICATES BEAM POCKET, SEE TYP DETAIL.
 - S.K. INDICATES SHEAR KEY LOCATION, SEE PLAN & DETAILS.
 - PX INDICATES REINF CONCRETE PIER, TOP OF PIER REF EL (-30") U.N.O. SEE PIER DETAILS DWG S2.4 FOR ADDL INFO.
 - BF-X INDICATES VERTICAL BRACING, SEE BRACED FRAME ELEVATIONS DWG S4.2 & S4.3.
 - SEE TYPICAL BEAM PENETRATION DETAIL ON S1.2C FOR SHEAR STUD LAYOUT AND REINFORCING OVER BEAM PENETRATIONS.

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