


Owner

The Park Danforth

77 Stevens Ave, Portland, ME 04103


NO.	DESCRIPTION	DATE
1	GENERAL REVISIONS	06-10-15
2	GENERAL REVISIONS	06-25-15

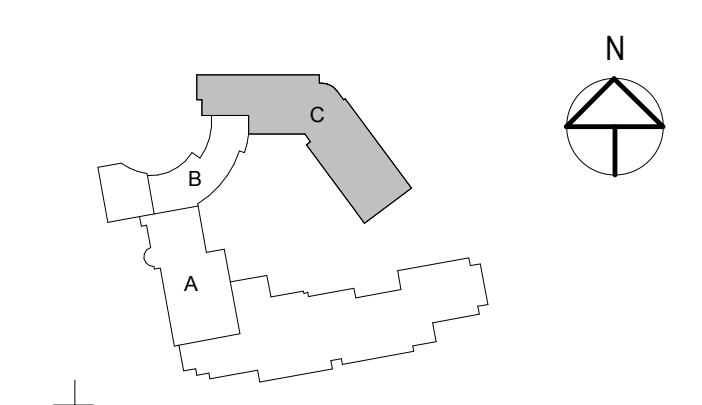

CONTENT:	
LEVEL 1-NEW BUILDING-FRAMING PLAN	
DRAWN BY:	A.P.P.
PROJECT NO:	3422
DATE:	05/27/15
REVISED:	
SCALE:	As indicated

S1.1C

Project Phase
Package 2 - Foundations and Structural Steel
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LEVEL 1 FRAMING PLAN
1/8"=1'-0"

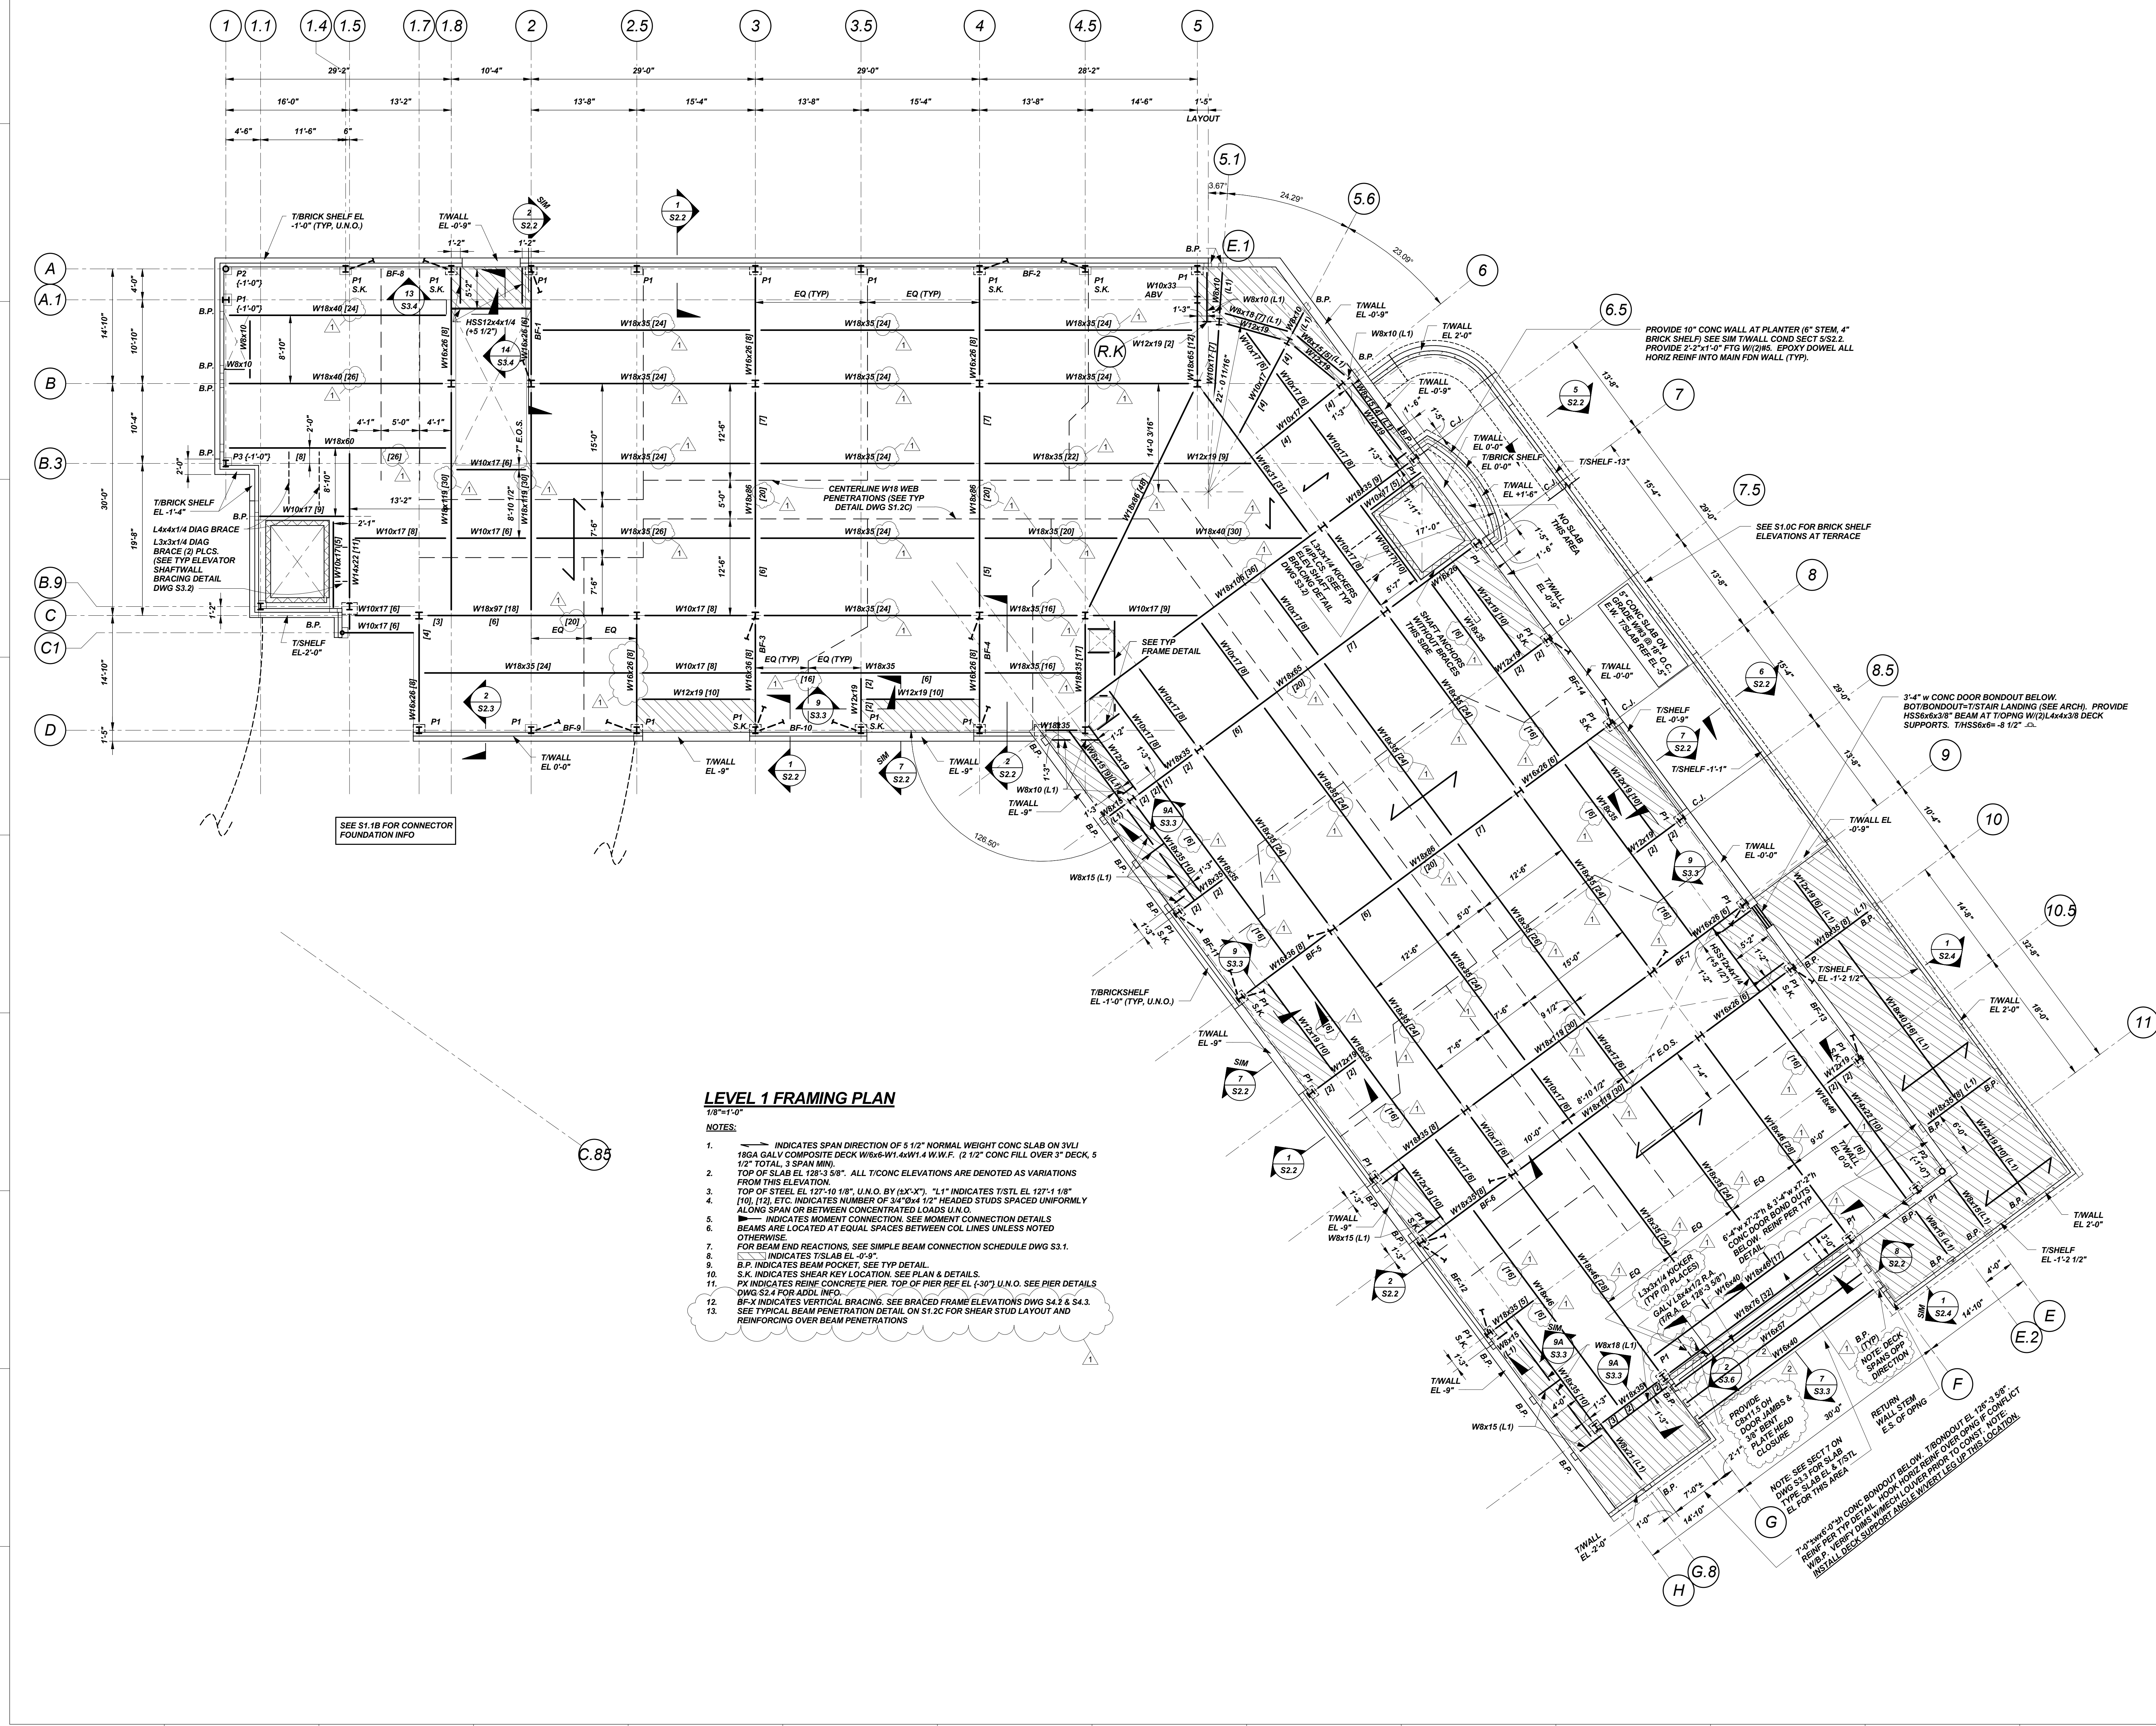NOTES:

- INDICATES SPAN DIRECTION OF 5 1/2" NORMAL WEIGHT CONC SLAB ON 3W/L 18GA GALV COMPOSITE DECK W/6x6-W1.4xW1.4 W.W.F. (2 1/2" CONC FILL OVER 3" DECK, 5 1/2" TOTAL, 3 SPAN MIN).
- TOP OF SLAB EL 128'-3 5/8". ALL T/CONC ELEVATIONS ARE DENOTED AS VARIATIONS FROM THIS ELEVATION.
- TOP OF STEEL EL 127'-10 1/8". U.N.O. BY (X-X"). "L1" INDICATES T/STL EL 127'-1 1/8" (10), (11), ETC. INDICATES NUMBER OF 3/4"x9/16" 1/2" HEADED STUDS SPACED UNIFORMLY ALONG SPAN OR BETWEEN CONCENTRATED LOADS U.N.O.
- INDICATES MOMENT CONNECTION. SEE MOMENT CONNECTION DETAILS.
- BEAMS ARE LOCATED AT EQUAL SPACES BETWEEN COL LINES UNLESS NOTED OTHERWISE.
- FOR BEAM END REACTIONS, SEE SIMPLE BEAM CONNECTION SCHEDULE DWG S3.1.
- INDICATES T/SLAB EL -0'-0".
- B.P. INDICATES BEAM POCKET, SEE TYP DETAIL.
- S.K. INDICATES SHEAR KEY LOCATION, SEE PLAN & DETAILS.
- PX INDICATES REIN CONCRETE PIER, TOP OF PIER SEE EL (-30") U.N.O. SEE PIER DETAILS DWG S2.4 FOR ADDL INFO.
- BF-X INDICATES VERTICAL BRACING, SEE BRACED FRAME ELEVATIONS DWG S4.3 & S4.3.
- SEE TYPICAL BEAM PENETRATION DETAIL ON S1.2C FOR SHEAR STUD LAYOUT AND REINFORCING OVER BEAM PENETRATIONS

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