




75 York Street, Portland, Maine 04101
207.879.1838 • beckerstructural.com

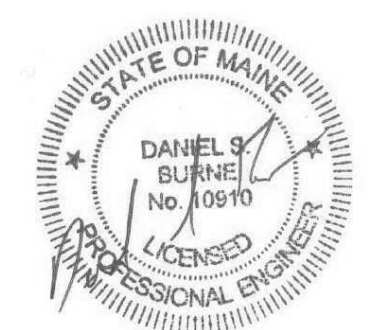


ROOF FRAMING PLAN

1/8"=1'-0"

NOTES:

1. 3N18 INDICATES SPAN DIRECTION OF 3N18 GALV ROOF DECK (3 SPAN MIN).
2. 1.5B20 INDICATES SPAN DIRECTION OF 1.5B20 GALV ROOF DECK (3 SPAN MIN).
3. TOP OF STEEL EL 181'-11 5/8" U.N.O. BY 154'-3"
4. BEAMS ARE LOCATED AT EQUAL SPACES BETWEEN COL LINES UNLESS NOTED OTHERWISE.
5. E.O.D. INDICATES EDGE OF DECK. SEE PLAN.

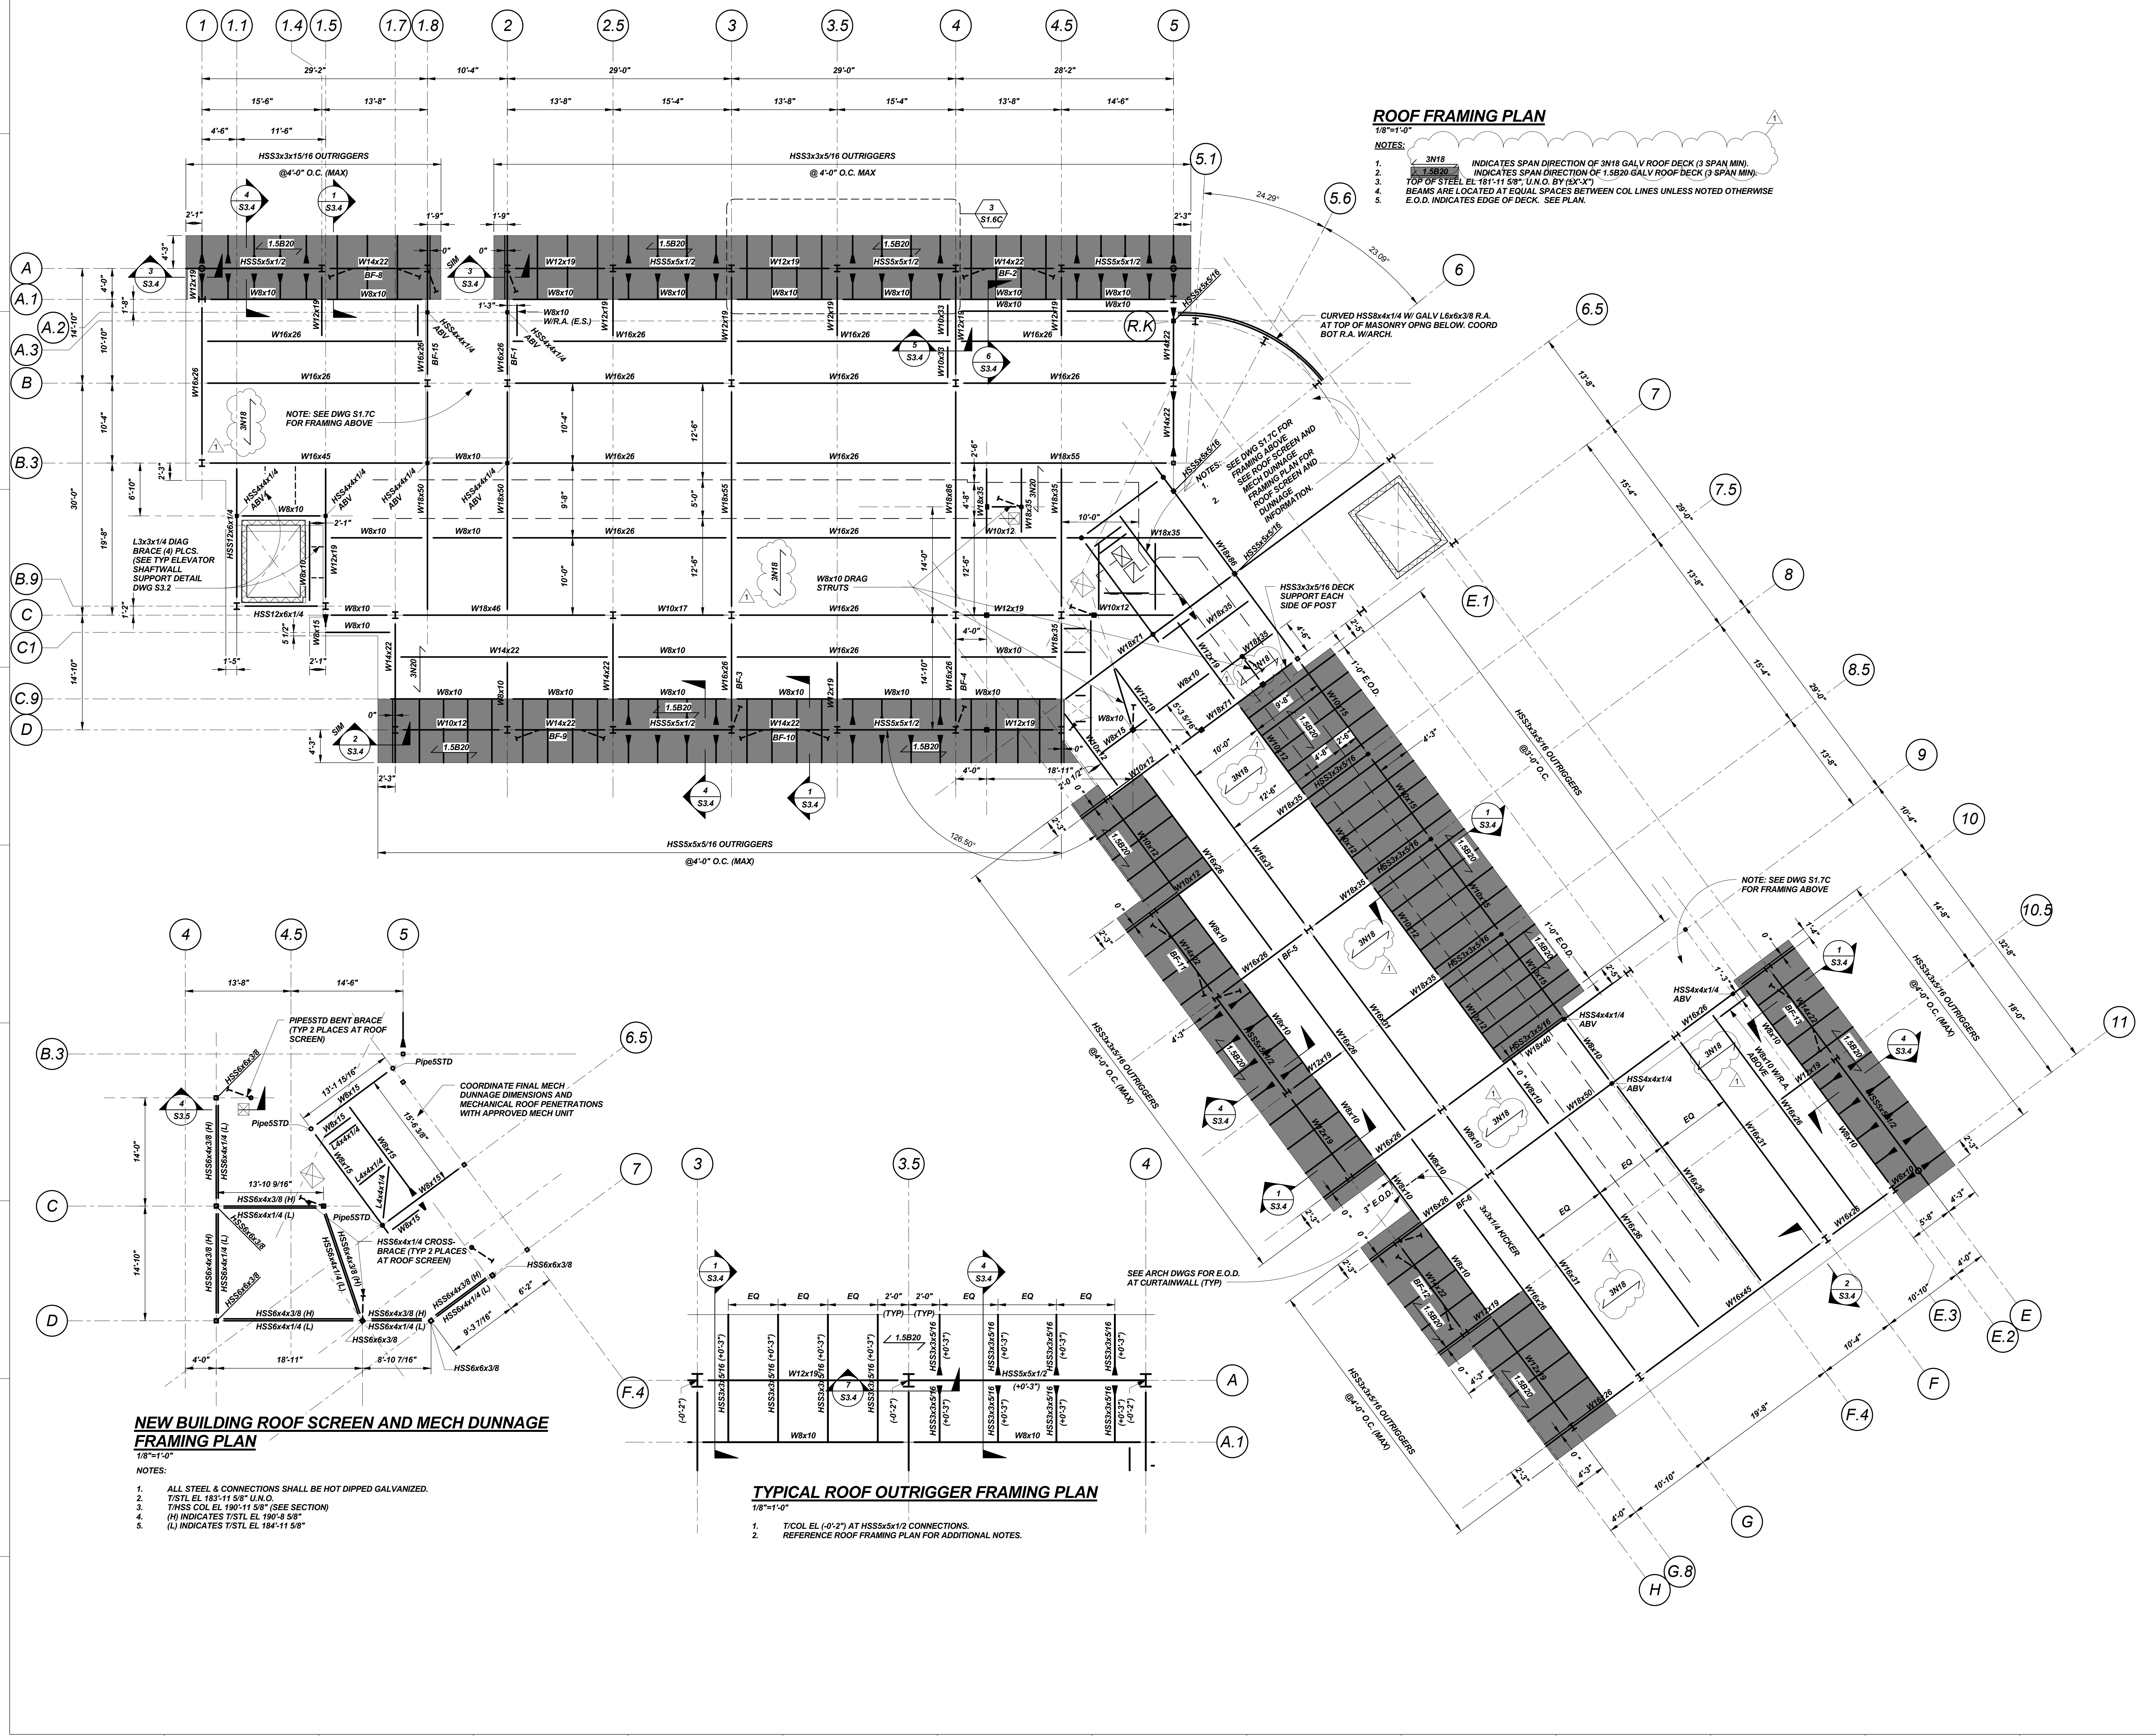

NEW BUILDING ROOF SCREEN AND MECH DUNNAGE FRAMING PLAN

1/8"=1'-0"

- NOTES:**
1. ALL STEEL & CONNECTIONS SHALL BE HOT DIPPED GALVANIZED.
 2. T/STL EL 183'-11 5/8" U.N.O.
 3. T/MS COL EL 190'-11 5/8" (SEE SECTION)
 4. (H) INDICATES T/STL EL 180'-8 3/8"
 5. (L) INDICATES T/STL EL 184'-11 5/8"

TYPICAL ROOF OUTRIGGER FRAMING PLAN

1/8"=1'-0"


1. T/COL EL (-0'-2") AT HSS5x5x1/2 CONNECTIONS.
2. REFERENCE ROOF FRAMING PLAN FOR ADDITIONAL NOTES.

Owner

The Park Danforth

77 Stevens Ave, Portland, ME 04103

NO.	DESCRIPTION	DATE
1	GENERAL REVISIONS	06-10-15

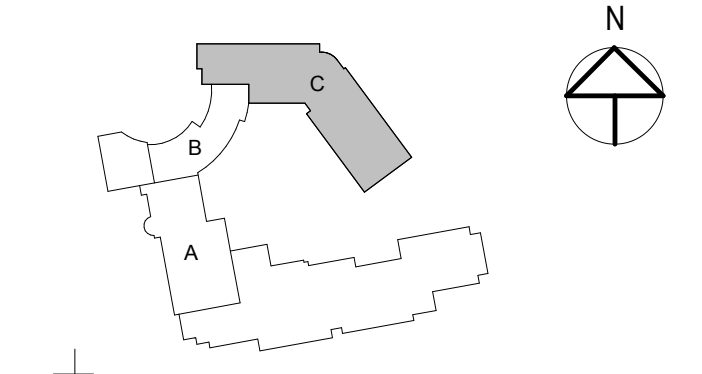

CONTENT:	
ROOF-NEW BUILDING-FRAMING PLAN	
DRAWN BY:	A.P.P.
PROJECT NO:	3422
DATE:	05/27/15
REVISED:	
SCALE:	As indicated
S1.6C	
Project Phase	
Package 2 - Foundations and Structural Steel	
Copyright © 2014 by Lavallee Brensing Professional Association. All rights reserved. No reproduction without permission.	