
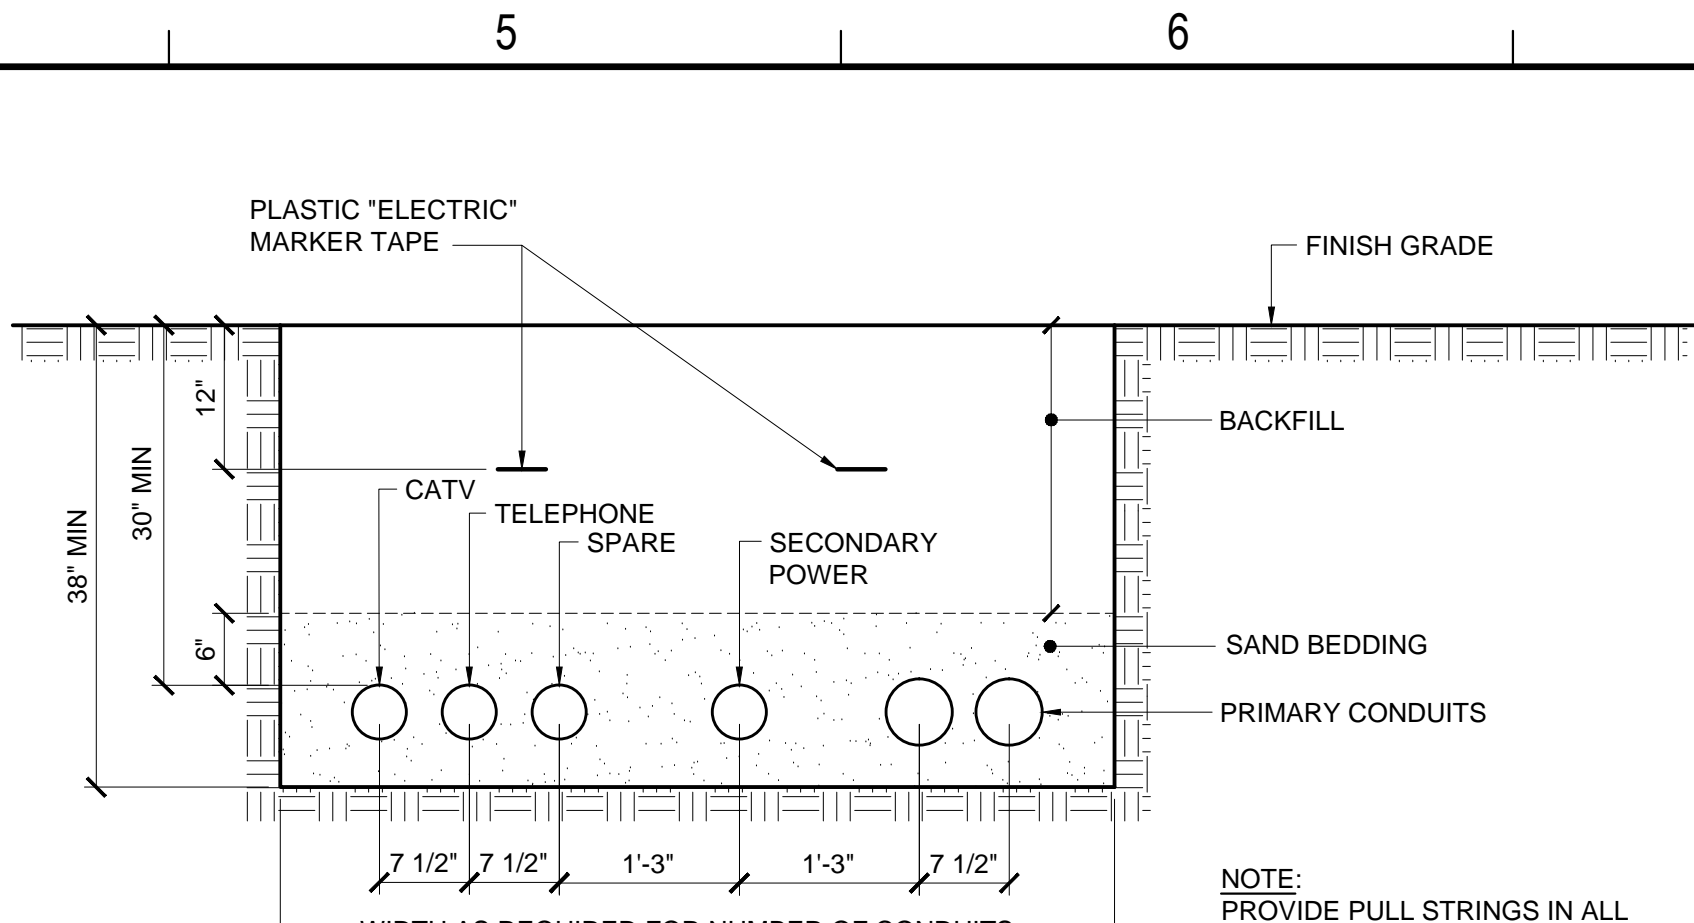


DETAIL INDICATES TYPICAL SPACING BETWEEN CONDUITS OF VARIOUS SYSTEMS, REFER TO SITE PLAN FOR SIZES AND NUMBER OF CONDUITS

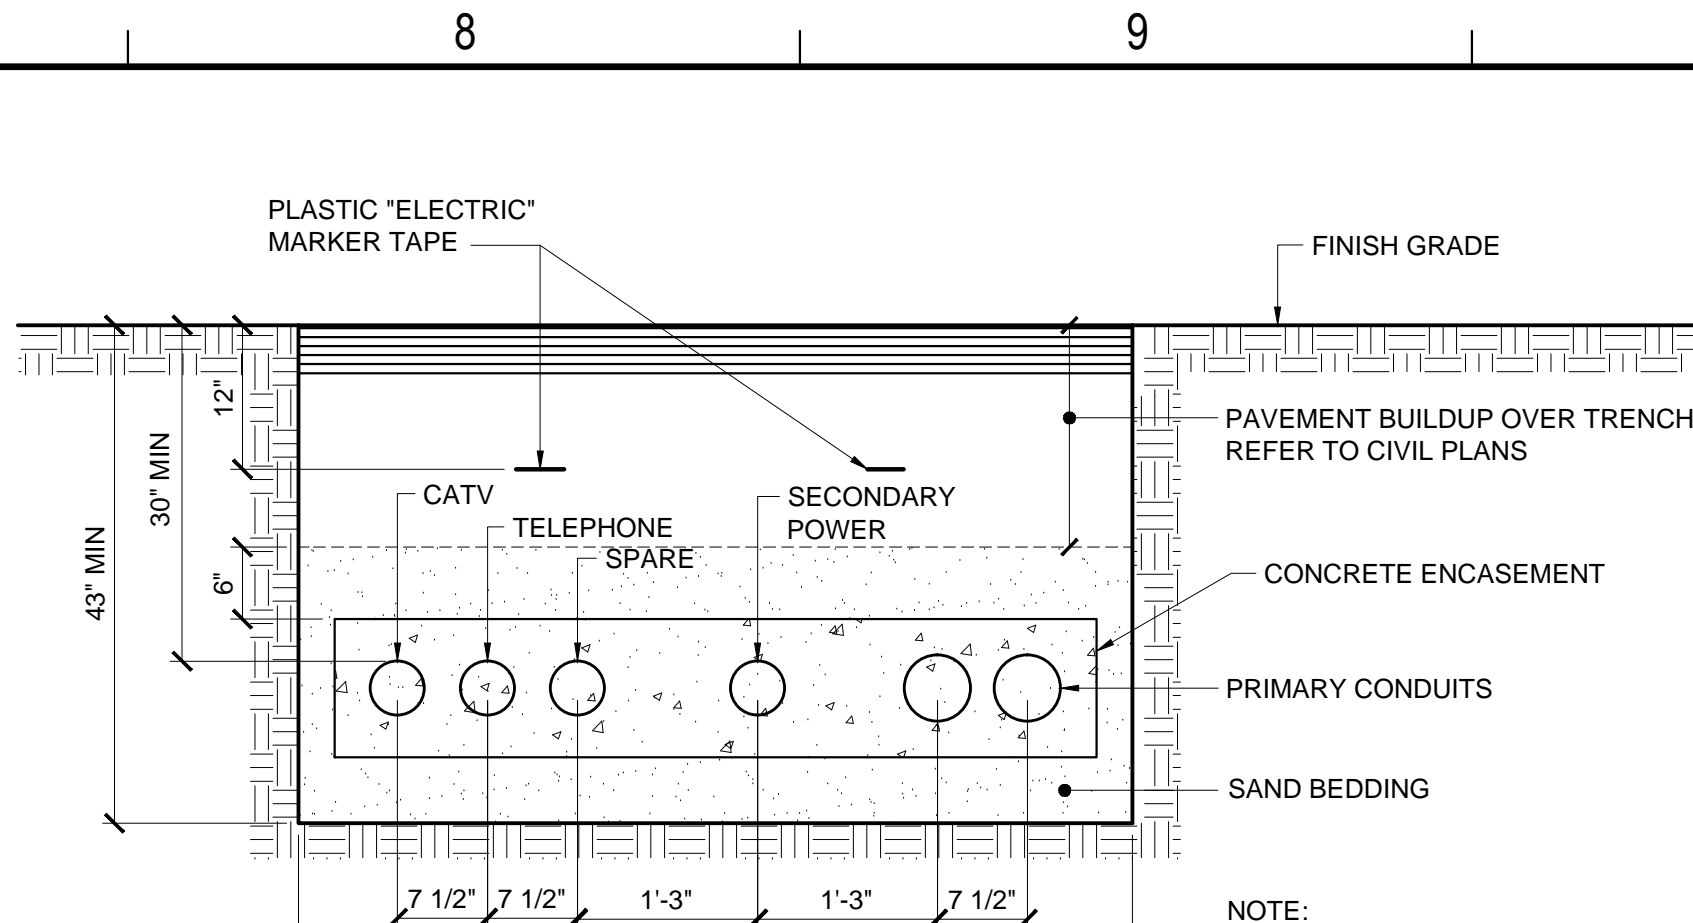

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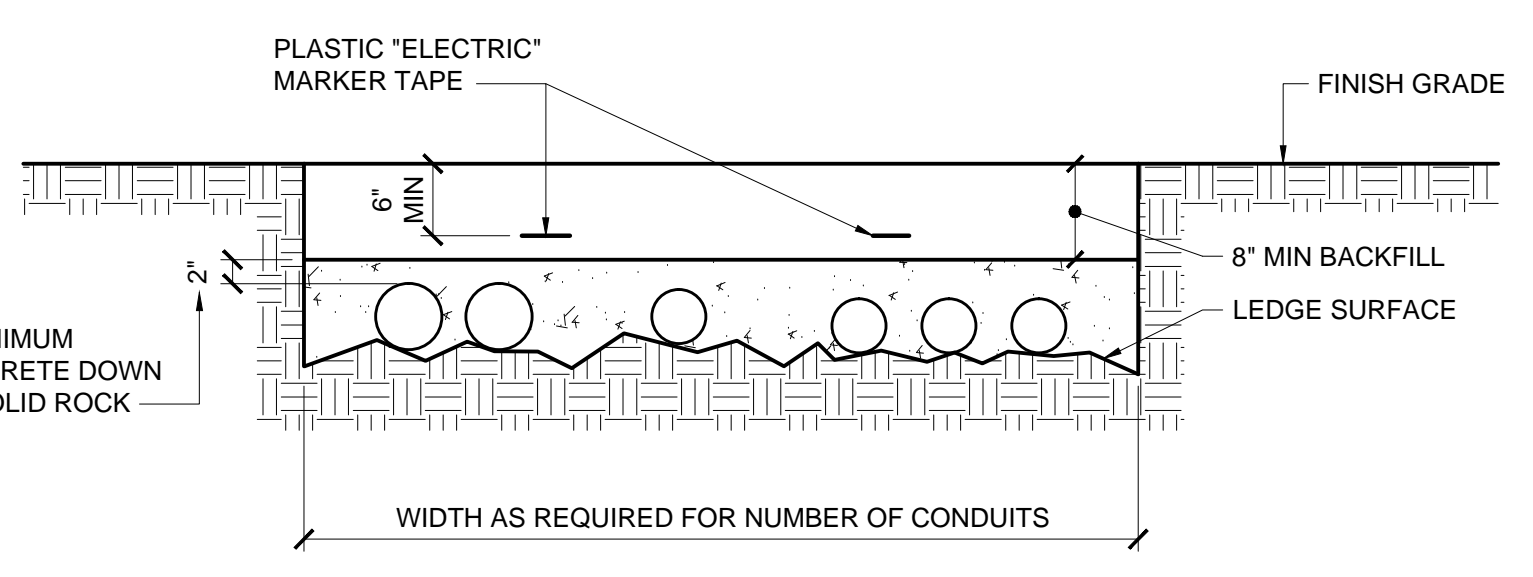


DETAIL INDICATES TYPICAL SPACING BETWEEN CONDUITS OF VARIOUS SYSTEMS, REFER TO SITE PLAN FOR SIZES AND NUMBER OF CONDUITS


G1 TYPICAL SEPARATION OF NORMAL POWER SYSTEMS  
NO SCALE

G5 TYPICAL SEPARATION OF UTILITY SYSTEMS  
NO SCALE


G7 TYPICAL SEPARATION OF UTILITY SYSTEMS UNDER PAVEMENT  
NO SCALE




E1 MINIMUM CONDUIT COVER FOR CONDUITS ON LEDGE  
NO SCALE

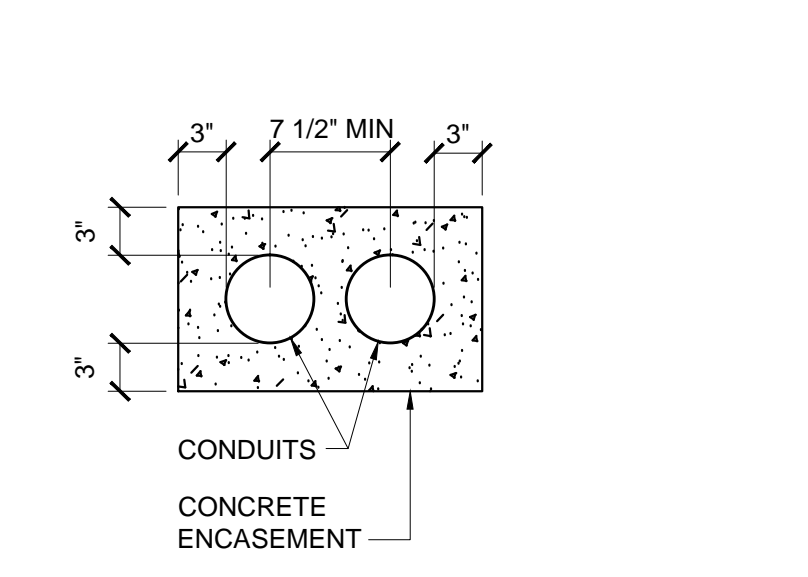


E5 TYPICAL CONCRETE ENCASEMENT DIMENSIONS  
NO SCALE

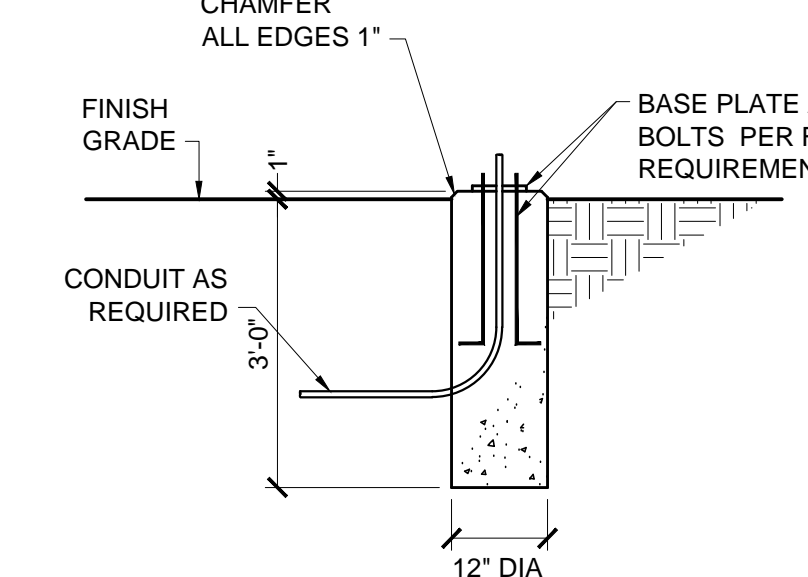

E6 BOLLARD LIGHT BASE DETAIL  
NO SCALE

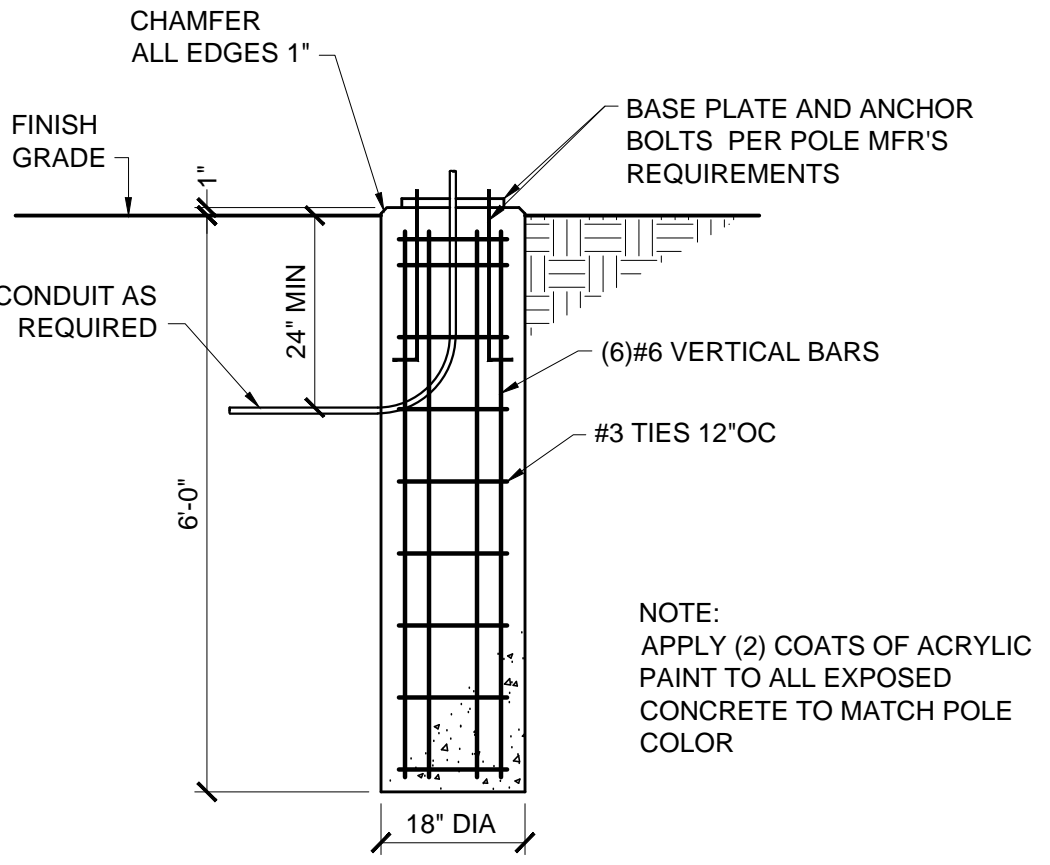

C1 PEDESTRIAN POLE BASE DETAIL  
NO SCALE

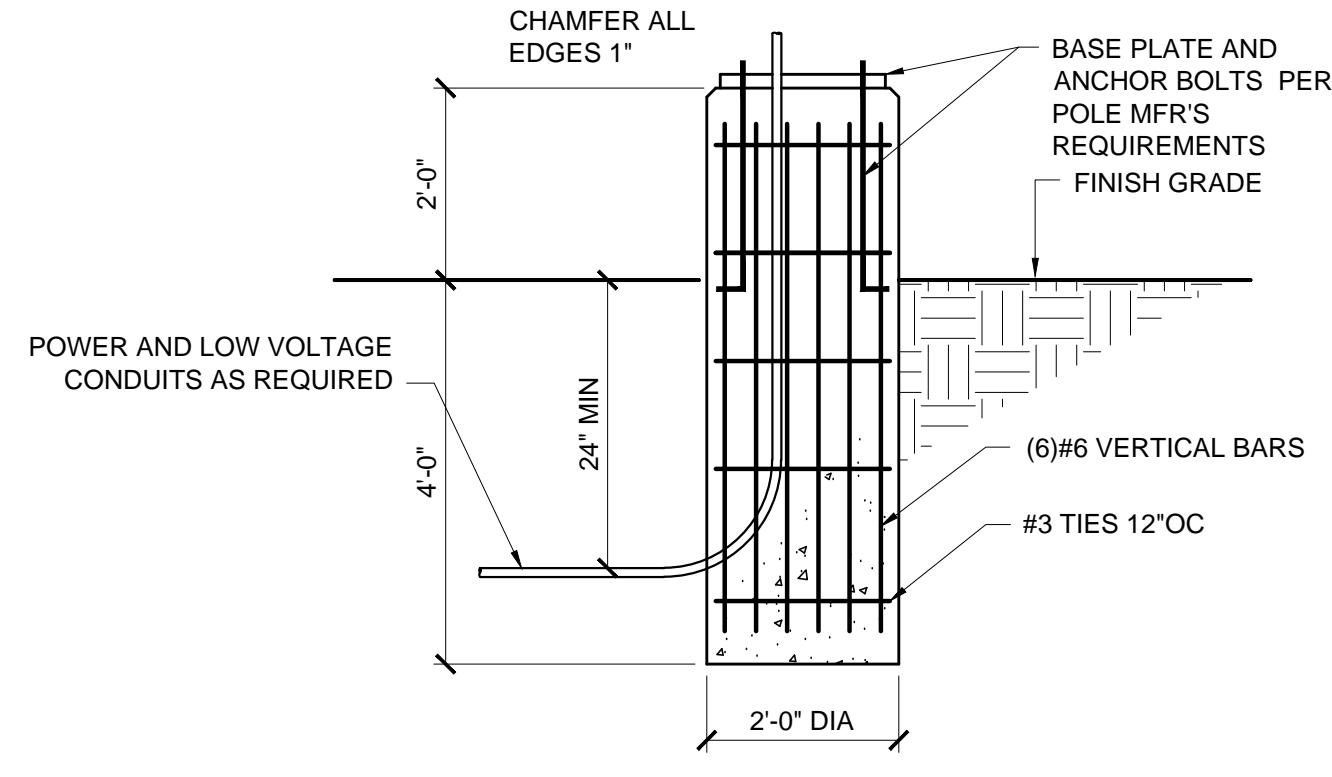


C5 POLE BASE DETAIL  
NO SCALE


NOTE:  
POLE BASES SHALL BE FURNISHED UNDER DIVISION 26. EXCAVATION, BACKFILL AND SETTING THE BASES IN PLACE SHALL BE BY DIVISION 32.

LUMINAIRE SCHEDULE									
TYPE	DESCRIPTION	MFR	CATALOG SERIES NUMBER SEE NOTE 1	MOUNTING	VOLTS	LAMP			KEY NOTES
						QTY PER FIXTURE	WATTS	TYPE	
B1	BOLLARD	AAL	PKWB-6LED-BW--DSSH	BOLLARD	208V	1	8.2W	LED ARRAY-5000K	
G1	OUTDOOR UPLIGHT	HUBBELL	INCANDESCENT LAMPHOLDER SERIES 309	GROUND SURFACE	208V	1	15W	LED ARRAY	
G2	OUTDOOR UPLIGHT	LUMIERE	3002-N-RD--WFL-DIF-BZ	GROUND RECESSED	208V	1	18W	LED ARRAY	
S1A	LED POLE LIGHT	BEACON	VPS-30NB-90-5K	SEE PLAN	208V	1	90W	LED ARRAY-5000K	3
S1B	LED POLE LIGHT WITH HOUSE SIDE SHIELD	BEACON	VPS-30NB-90-5K-HSS-90	SEE PLAN	208V	1	90W	LED ARRAY-5000K	3
S1C	LED POLE LIGHT, MOUNTED BACK TO BACK	BEACON	VPS-30NB-90-5K	16' AFG	208V	2	90W	LED ARRAY-5000K	
S2	LED PEDESTRIAN POLE LIGHT	AAL	PKWS--T3-18LED-BW--*	10' AFG	208V	1	20.6W	LED ARRAY-5000K	
<b>NOTES</b>									
1	NOTE THAT THESE NUMBERS ARE NOT COMPLETE CATALOG NUMBERS. PROVIDE ALL REQUIREMENTS ON SCHEDULE, NOTES, SPECS, AND DRAWINGS COMBINED.								
2	CATALOG SERIES NUMBERS ARE USED TO ESTABLISH A LEVEL OF QUALITY AND NOT INTENDED TO LIMIT COMPETITION. SERIES NUMBERS ARE NOT COMPLETE CATALOG NUMBERS. COMPLY WITH ADDITIONAL REQUIREMENTS IN SPECIFICATIONS AND DRAWINGS.								
3	SEE PLAN FOR MOUNTING HEIGHT.								

A7 LUMINAIRE SCHEDULE

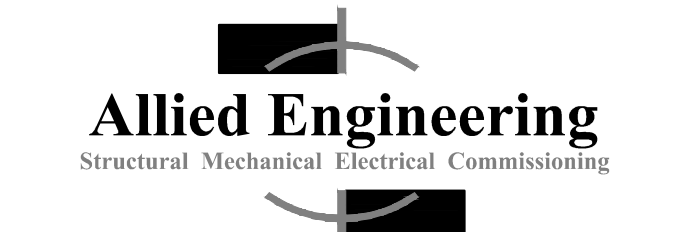

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Web: www.allied-eng.com

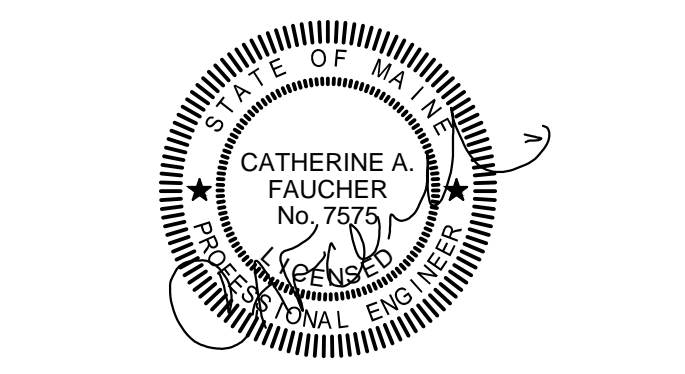

Graphic Scale: 1" = 12' 0" 1"

The Park Danforth

777 Stevens Ave, Portland, ME, 04103

NO.	DESCRIPTION	DATE
1	Addendum No 2	2015-06-25



CONTENT:  
ELECTRICAL SITE DETAILS

DRAWN BY: DRW

PROJECT NO: 12-056-00

DATE: 6/5/2015

REVISED:

SCALE: AS SHOWN

**ES1.2**

Project Phase  
**100% CONSTRUCTION DRAWINGS**

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