



E1 CODE PLAN - LEVEL 2

A0.2B 1/16" = 1'-0"

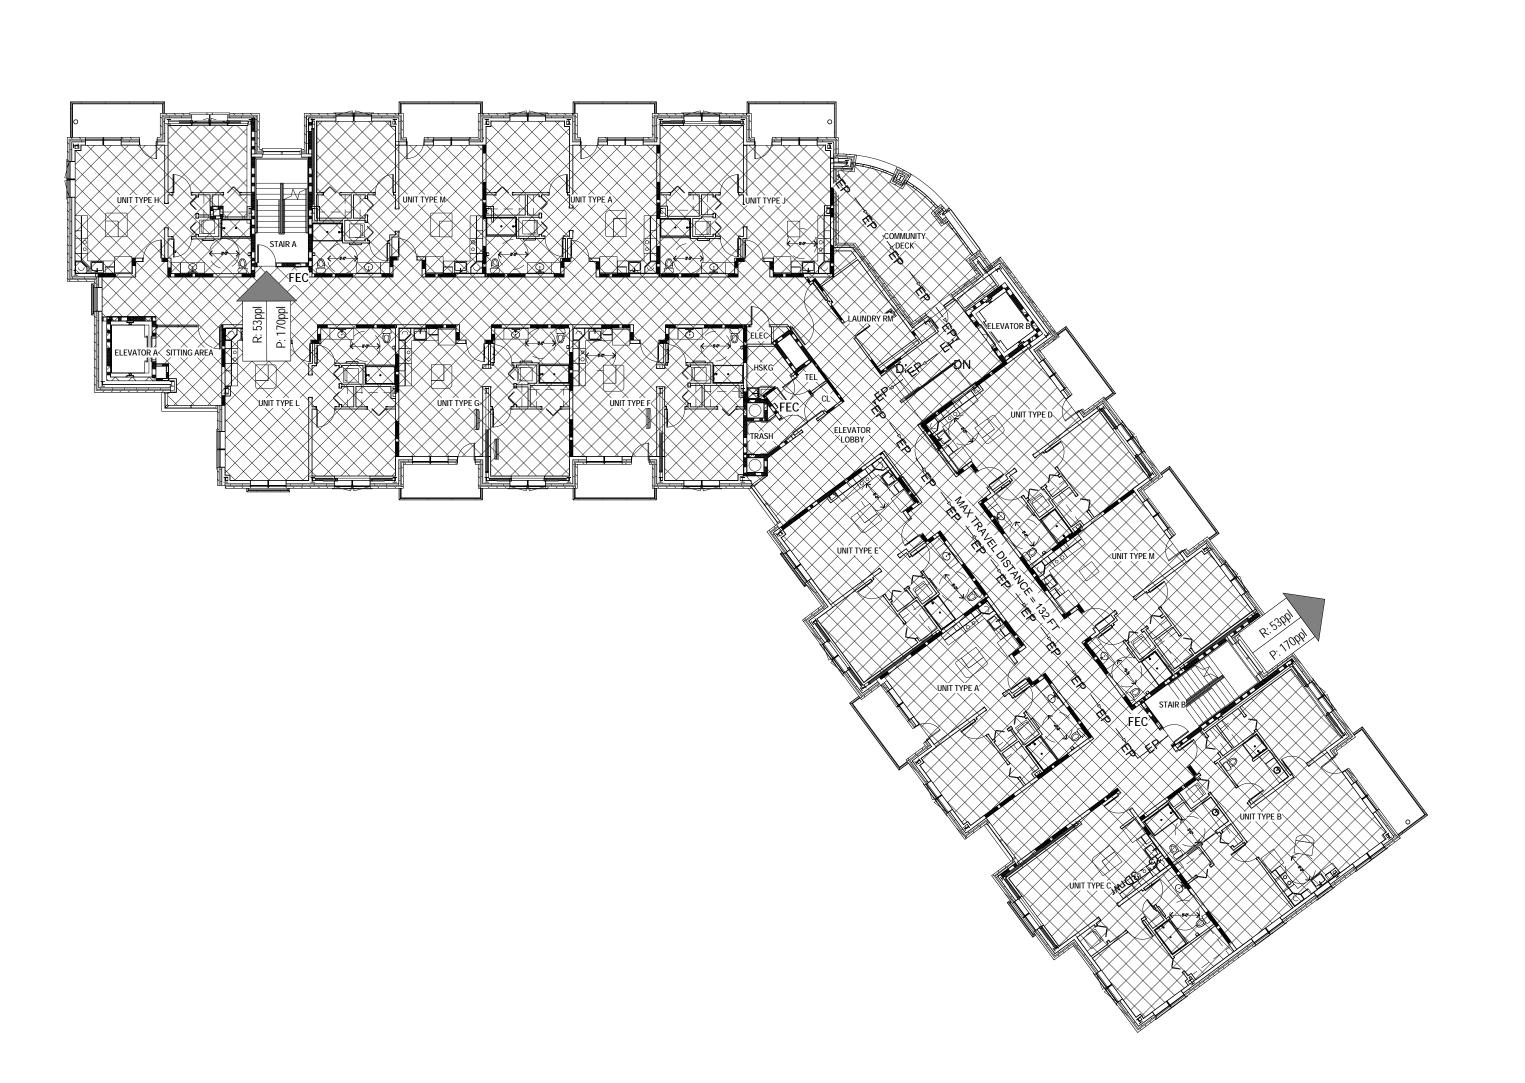

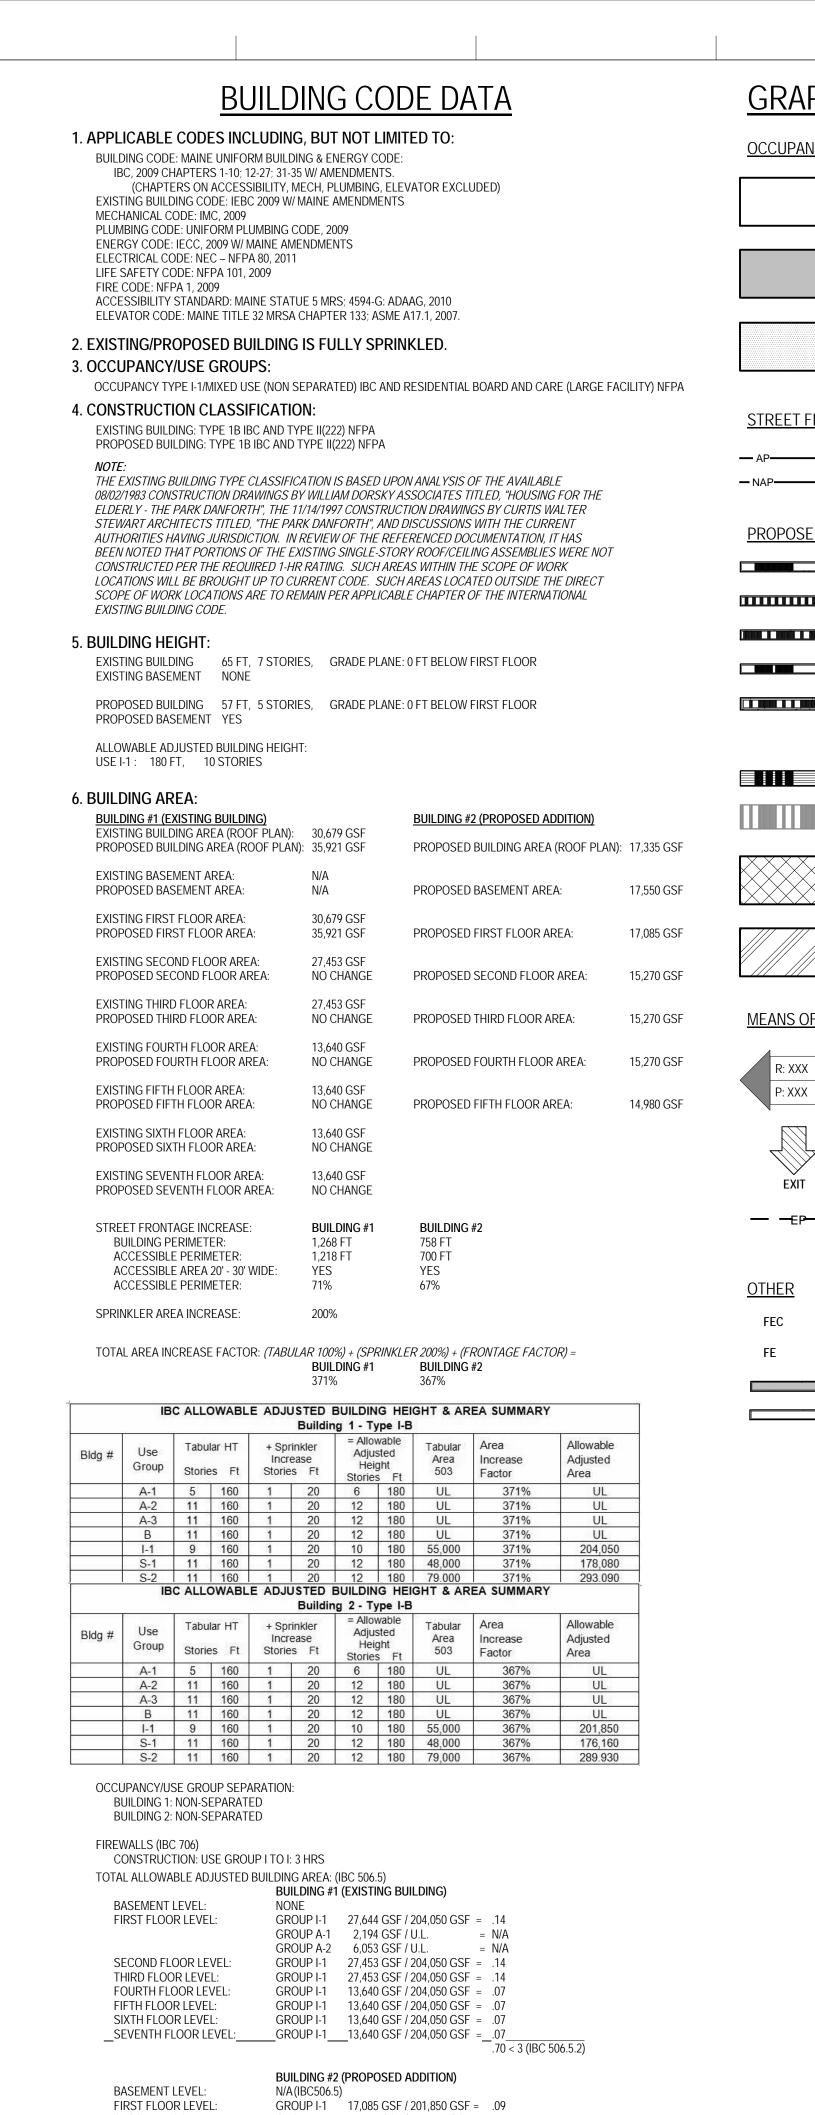

SECOND FLOOR LEVEL: GROUP I-1 15,270 GSF / 201,850 GSF = .08 GROUP I-1 15,270 GSF / 201,850 GSF = .08 THIRD FLOOR LEVEL: FOURTH FLOOR LEVEL: GROUP I-1 15,270 GSF / 201,850 GSF = .08 FIFTH FLOOR LEVEL: GROUP I-1 11,722 GSF / 201,850 GSF = .06 GROUP A-3 3,258 GSF / U.L. = N/A 7. SEE DOOR SCHEDULE FOR DOOR ASSEMBLY FIRE-RATINGS. 8. BUILDING ELEMENT FIRE RESISTIVE RATING REQUIREMENTS PRIMARY STRUCTURAL FRAME 2 HRS (1 HR SUPPORTING ROOF ONLY) BEARING WALLS, EXTERIOR 2 HRS (1 HR SUPPORTING ROOF ONLY) BEARING WALLS, INTERIOR 2 HRS (1 HR SUPPORTING ROOF ONLY) NON-BEARING WALLS &

NON-BEARING WALLS & PARTITIONS, INTERIOR FLOOR CONSTRUCTION &

SECONDARY MEMBERS **ROOF CONSTRUCTION &**

SECONDARY MEMBERS

LAVALLEE BRENSINGER ARCHITECTS **GRAPHICS LEGEND** 155 Dow Street, Suite 400, Manchester, NH 03101 40 Cambridge Street, Charlestown, MA 02129 <u>OCCUPANCY</u> NH: 603.622.5450 MA: 617.398.2035 www.LBPA.com USE GROUP I-1 USE GROUP B INCIDENTIAL ACCESSORY OCCUPANCY STREET FRONTAGE — AP—— AP—— ACCESSIBLE PERIMETER NAP—NAP—NAP—NON-ACCESSIBLE PERIMETER PROPOSED FIRE RATED CONSTRUCTION NON-RATED SMOKE PARTITION 1 HR SMOKE BARRIER 1 HR FIRE BARRIER 1 HR FIRE PARTITION 2 HR FIRE BARRIER 3 HR FIRE WALL EXISTING 2 HR FIRE BARRIER 2 HOUR FLOOR / CEILING ASSEMBLY 1 HOUR CEILING / ROOF ASSEMBLY **MEANS OF EGRESS** R: XXX REQUIRED EGRESS CAPACITY P: XXX PROVIDED EGRESS CAPACITY The Park Danforth — — EXIT ACCESS / EGRESS PATH
(ARROWS INDICATE DIRECTION OF TRAVEL) FIRE EXTINGUISHER CABINET FIRE EXTINGUISHER EXISTING CONSTRUCTION **RENOVATIONS AND** NEW CONSTRUCTION **ADDITIONS**

> 777 Stevens Ave Portland, ME 04103

DESCRIPTION

LEVEL 2 & LEVEL 3 CODE ANALYSIS PLAN DRAWN BY: PROJECT NO: 13-059-00 DATE: 06/05/2015 REVISED: SCALE: As indicated

100% CONSTRUCTION DOCUMENTS

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CODE PLAN - LEVEL 3 9 12 13