


**AUDITORIUM & CONNECTOR FOUNDATION PLAN**

1/8"=1'-0"

**NOTES:**

- ALL ELEVATIONS ARE DENOTED AS VARIATIONS FROM NEW BUILDING LEVEL 1, REFERENCE ELEVATION OF 128'-3.50", U.N.O.
- INDICATES SPAN DIRECTION OF 5 1/2" NORMAL WEIGHT CONC SLAB ON 3/4" 18GA GALV COMPOSITE DECK W/8x6-W2.1W2.1 W.W.F. (2 1/2" CONC FILL OVER 3" DECK, 5 1/2" TOTAL, 3 SPAN MIN). T/SLAB EL 128'-3.50" U.N.O. T/STEEL EL 127'-10 1/8" U.N.O. \*1 INDICATES T/STEEL EL 128'-6 1/8" \*1M\* INDICATES T/STEEL EL 127'-3 1/8"
- PI INDICATES CONC PIER. SEE PIER DETAILS. TYPICAL EL 2'-0", U.N.O. BY (X'-X")
- SEE TYP DETAILS FOR EQUIPMENT PAD INFO (COORD W/ MEP).
- FOUNDATION CURVE TO BE FORMED W/MAX SEGMENT LENGTH OF 2'-0".

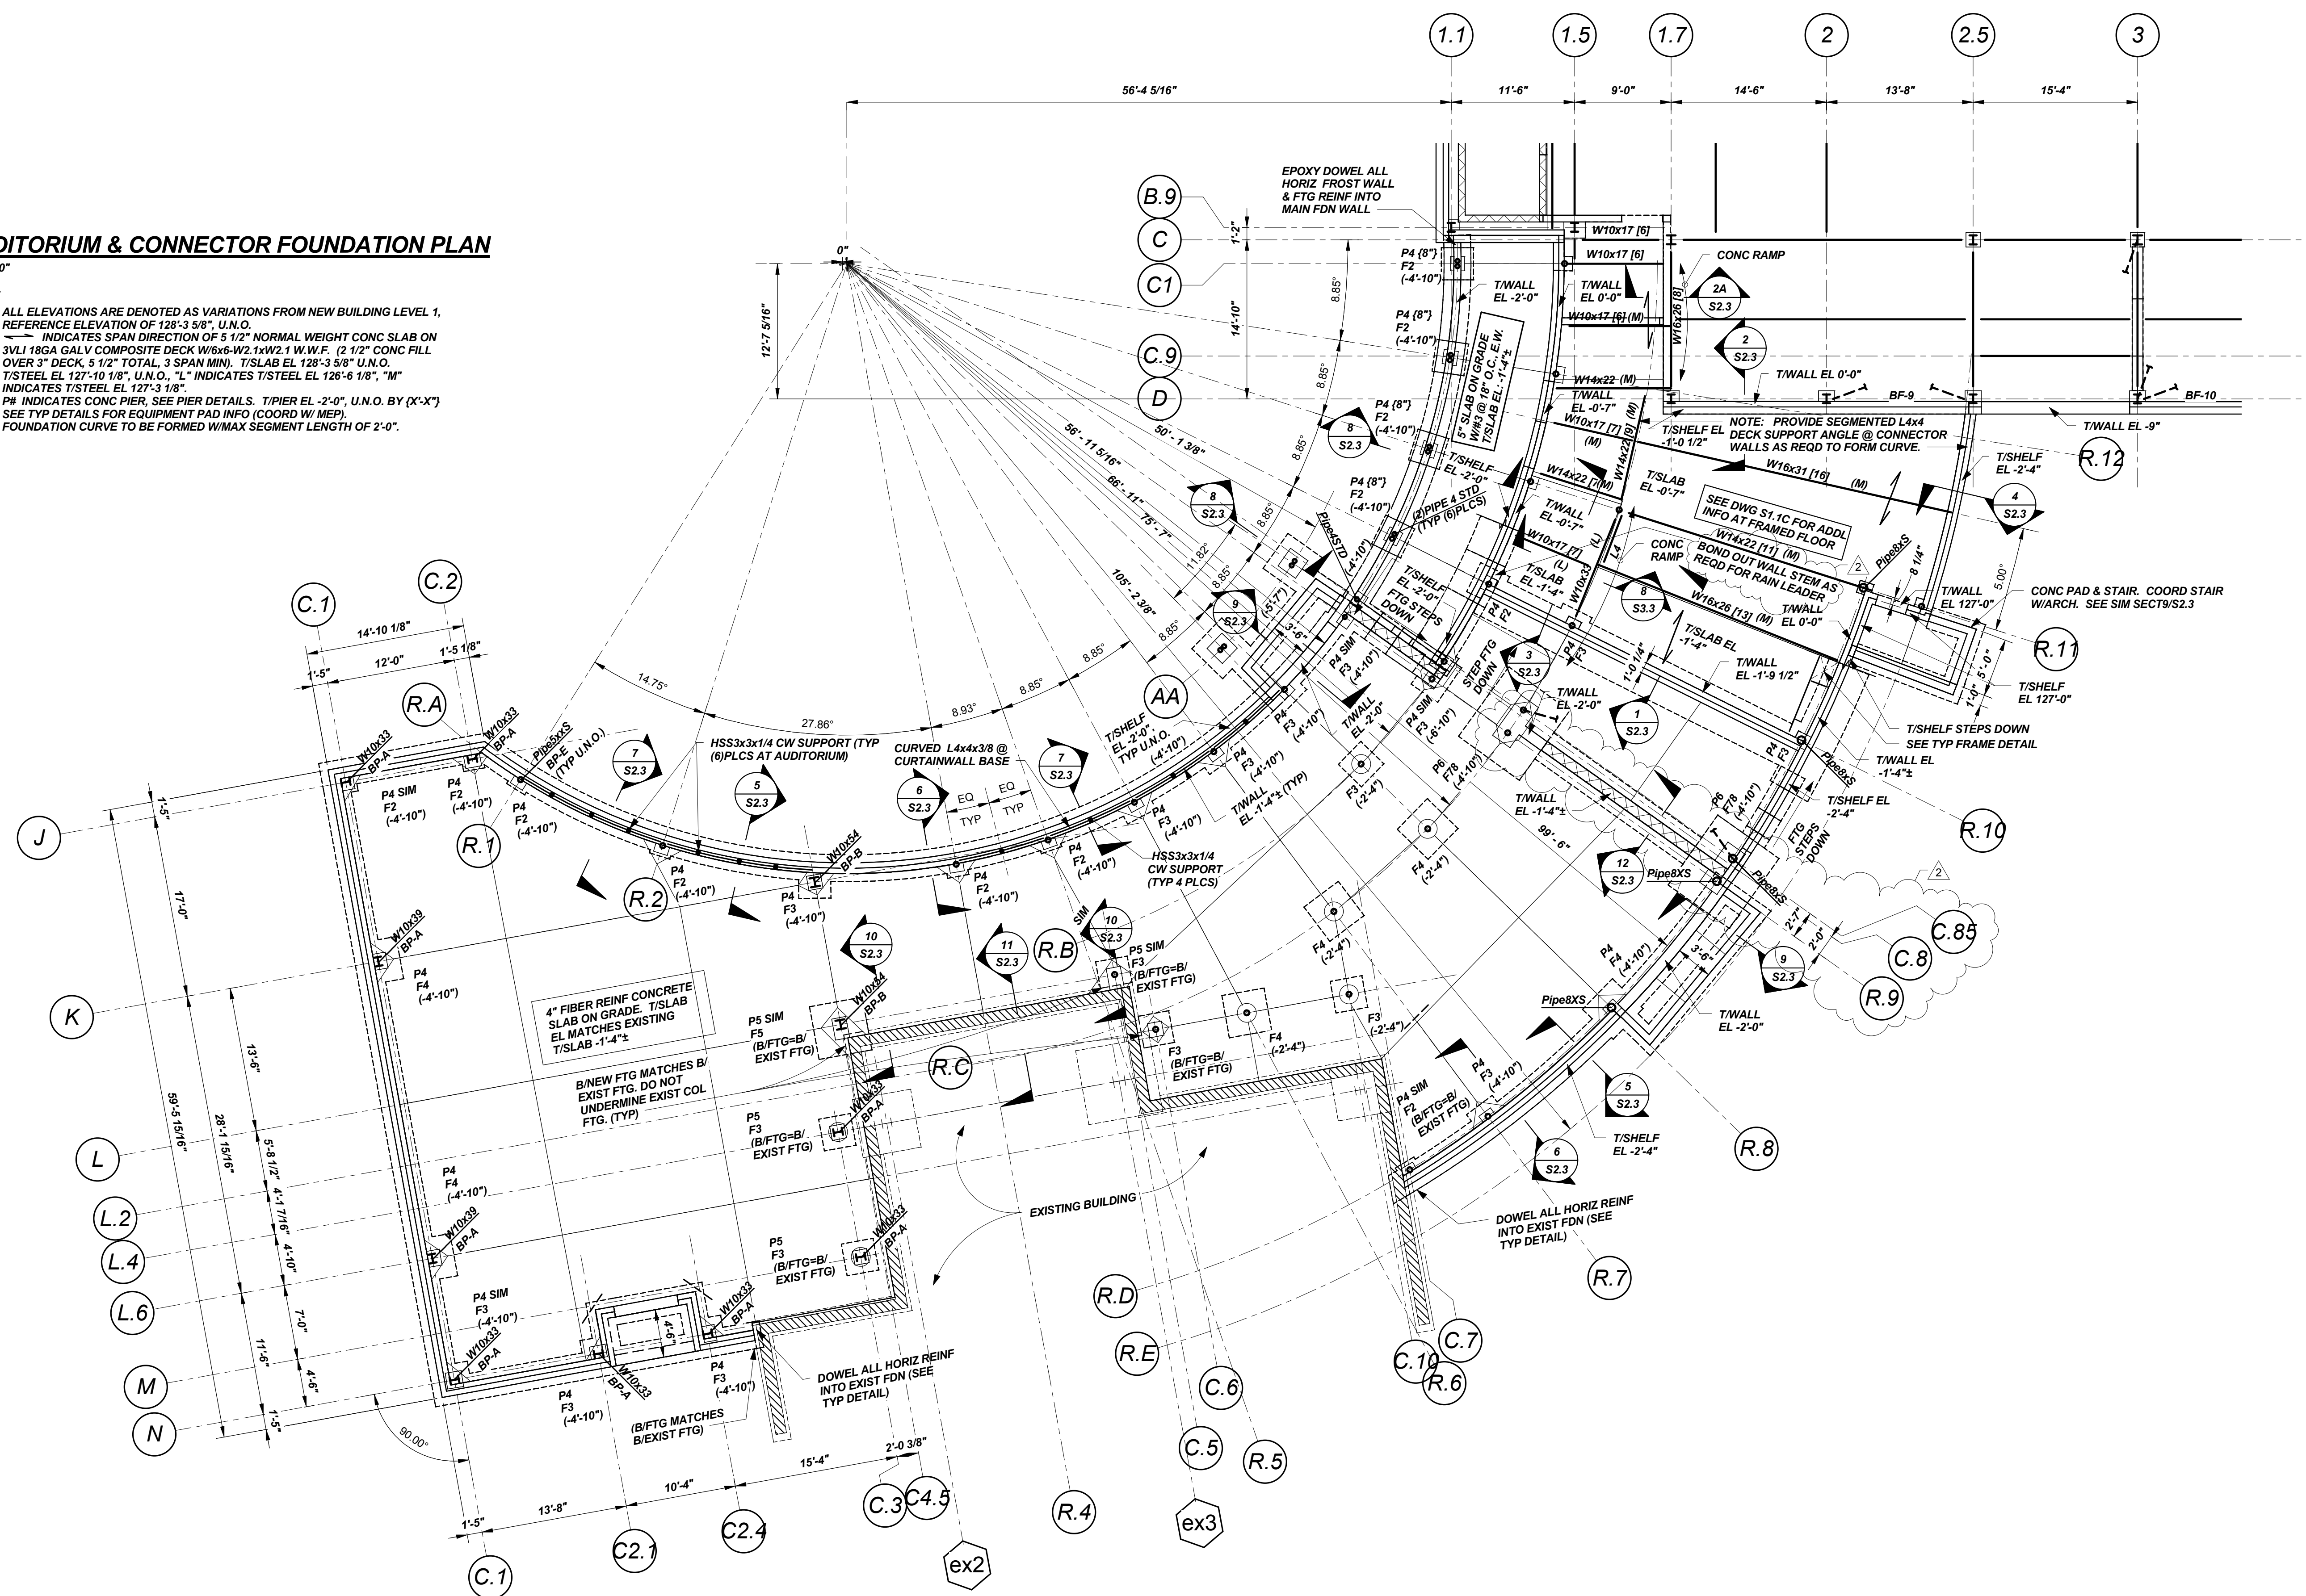

FOOTING SCHEDULE		
FOOTING MARK	FOOTING SIZE	REINF EACH WAY BOT U.N.O.
F2	2'-0"x2'-0"x1'-0"	3#4
F3	3'-0"x3'-0"x1'-0"	4#4
F4	4'-0"x4'-0"x1'-0"	5#4
F5	5'-0"x5'-0"x1'-6"	5#5
F6	6'-0"x6'-0"x1'-6"	8#5
F7	7'-0"x7'-0"x2'-0"	7#6
F8	8'-0"x8'-0"x2'-0"	9#6
F9	9'-0"x9'-0"x2'-6"	11#6
F10	10'-0"x10'-0"x2'-6"	8#8
F11	11'-0"x11'-0"x2'-6"	10#8
F12	12'-0"x12'-0"x2'-6"	11#8
F78	7'-0"x8'-0"x2'-0"	7#6 L.W. T&B 9#6 S.W. T&B


\* INDICATES 3'-0" THICK FOOTING

Owner

**The Park Danforth**

77 Stevens Ave, Portland, ME 04103

NO.	DESCRIPTION	DATE
2	GENERAL REVISIONS	06-25-15

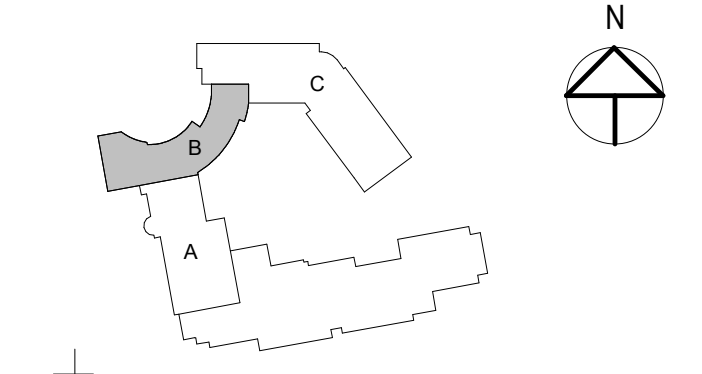

CONTENT:  
 LEVEL 1-AUDITORIUM & CONNECTOR FOUNDATION PLAN

DRAWN BY: A.P.P.  
 PROJECT NO: 3422  
 DATE: 05/27/15  
 REVISED:  
 SCALE: As indicated

**S1.1B**

Project Phase  
**Package 2 - Foundations and Structural Steel**

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